PENSACOLA INTERNATIONAL AIRPORT PENSACOLA GA FACILITY

4121 MAYGARDEN ROAD PENSACOLA, FL 32504

BID DOCUMENTS

03/03/2020

AEC PROJECT NUMBER 201-0052-002

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10748 Deerwood Park Blvd. South Jacksonville, Florida 32256-0597 904-256-2500 Fax 904-256-2503

EB0005620 * LCC000210 * GB238

IN COLLABORATION WITH:


GM()

720 Bayfront Parkway, Suite 200
Pensacola, FL 32502
T 850.432.0706
F 850.433.0508
G M C N E T W O R K . C O M

REVISIONS

NO. DESCRIPTION DATE

NOT ISSUED FOR CONSTRUCTION

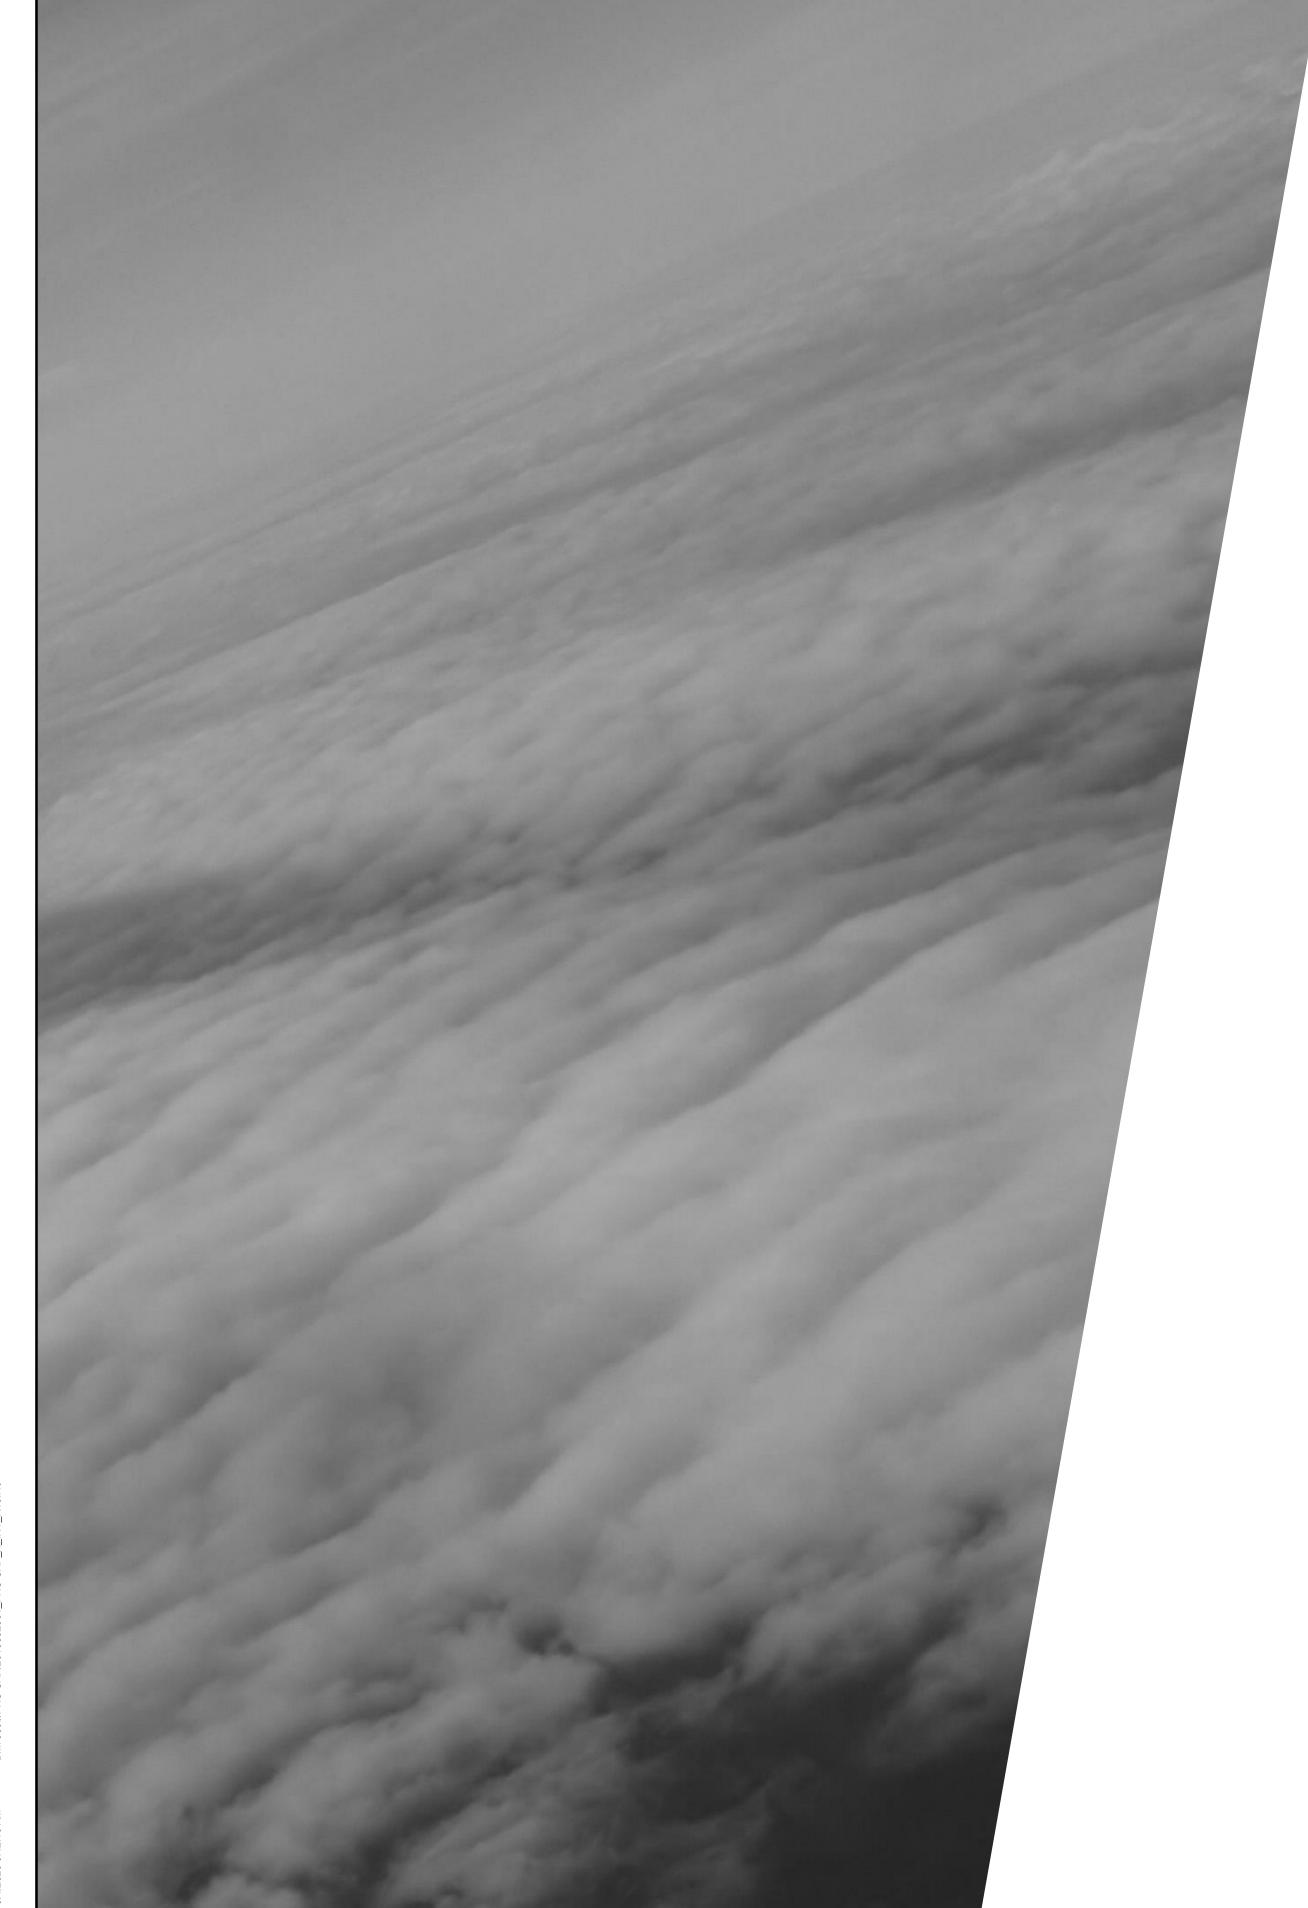

PROJECT SCOPE:

THIS PROJECT IS FOR THE DESIGN OF THE NEW GENERAL AVIATION PROCESSING FACILITY. THE PROJECT INCLUDES A NEW PROCESSING BUILDING, THE REQUIRED EQUIPMENT AND FURNISHINGS, PARKING LOT, FENCING, GATES, AND UTILITY EXTENSIONS TO THE SITE FOR A FULLY-FUNCTIONING FACILITY.

THE FACILITY EXTERIOR SHELL WILL CONSIST OF A MONOLITHIC CONCRETE SLAB WITH INTEGRAL COLUMN FOOTINGS, PRE-ENGINEERED METAL BUILDING FRAME, 8" SPLIT-FACE CMU WAINSCOT APPROXIMATELY 48"HIGH, UNINSULATED METAL WALL PANELS ABOVE WAINSCOT, STANDING-SEAM PREFAB METAL ROOF BY PEMB, HOLLOW METAL DOORS AND FRAMES AND ALUMINUM FRAMED STOREFRONT WITH IMPACT RESISTANT GLAZING. THE ROOF SHAPE IS A GABLE AT EACH END AND WILL BE INSULATED WITH A VINYL-FACED FIBERGLASS BATT SYSTEM. THEIR WILL BE A PREFAB GUTTER AND DOWNSPOUT SYSTEM ALONG EACH EAVE OF THE BUILDING.

EXTERIOR WALLS R=13

ROOF R=19






EXISTING TERMINAL

SITE LOCATION

LOCATION

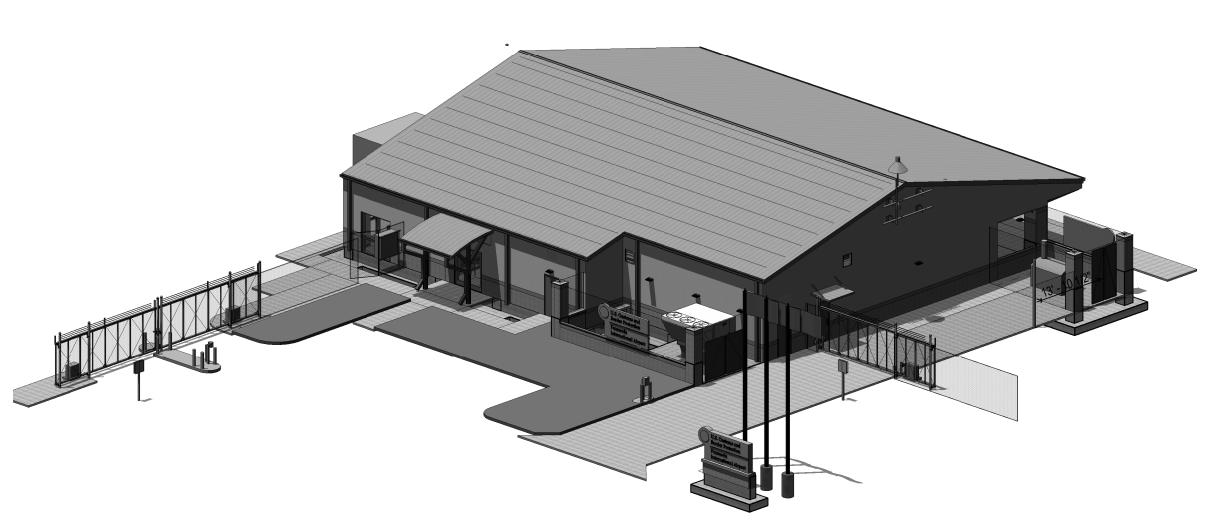

AXONOMETRIC VIEW-NE CORNER, FRONT



SHEET INDEX

EXISTING CONDITIONS, DEMOLITIONS & EROSION CONTROL PLAN

EXISTING CONDITIONS, DEMOLITIONS & EROSION CONTROL PLAN

C102 EXISTING CONDITIONS, DEMOLITIONS & EROSION CONTROL PLAN

SHEET NUMBER

00. GENERAL

C100

G001 SHEET INDEX

CONTROL PLAN

OVERALL SITE PLAN

LIFE SAFETY PLAN & CODE ANALYSIS

GENERAL NOTES, LEGEND & SITE DATA

SHEET NAME

DEET MILIABER	SHEET INDEX	
HEET NUMBER . FIRE PROTECT	SHEET NAME	
F100	FIRE PROTECTION FLOOR PLAN	
1. PLUMBING	THE THOTEOHORT EOORT DAY	
P001	PLUMBING GENERAL NOTES, SYMBOLS AND ABBREVIATIONS	
P100	OVERALL PLUMBING FLOOR PLAN	
P400	PLUMBING ENLARGED PLANS	
P500	PLUMBING DETAILS	
P501	PLUMBING DETAILS	
P600	PLUMBING SCHEDULES	
P800	PLUMBING RISER DIAGRAM - DWV	
P801 B. MECHANICAL	PLUMBING RISER DIAGRAM - WATER	
	MECHANICAL CENEDAL NOTES SYMPOLS AND ADDDEVIATIONS	
M001 M101	MECHANICAL GENERAL NOTES, SYMBOLS AND ABBREVIATIONS MECHANICAL FLOOR PLAN	
M401	MECHANICAL ENLARGED PLANS	
M501	MECHANICAL DETAILS	
M502	MECHANICAL DETAILS	
M503	MECHANICAL DETAILS	
M504	MECHANICAL DETAILS	
M601	MECHANICAL SCHEDULES	
M602	MECHANICAL SCHEDULES	
M801	MECHANICAL CONTROLS SCHEMATICS	
M802	MECHANICAL CONTROLS SCHEMATICS	
4. ELECTRICAL		
E001	ELECTRICAL GENERAL NOTES, SYMBOLS AND ABBREVIATIONS	
E002	LUMINAIRE SCHEDULE	
ES101	SITE PLAN - ELECTRICAL	
EL101	FIRST FLOOR - LIGHTING PLAN LIGHTING CALCULATIONS	
EL102 EL103	LIGHTING CALCULATIONS LIGHTING STATISTICS	
EL103 EP101	FIRST FLOOR PLAN - POWER	
ELP101	LIGHTNING PROTECTION	
ELP102	GROUNDING PLAN	
E501	ELECTRICAL DETAILS	
E502	ELECTRICAL DETAILS	
E503	ELECTRICAL DETAILS	
E601	ELECTRICAL PANEL SCHEDULES	
E701	ELECTRICAL ONE LINE DIAGRAM	
E702	GROUNDING ONE LINE	
FA101	FIRST FLOOR PLAN - FIRE ALARM	
FA701	FIRE ALARM RISER DIAGRAM	
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T001	TELECOM GENERAL NOTES, SYMBOLS AND ABBREVIATIONS	
T100	TELECOM SITE PLAN	
T101	TELECOM PLAN	
T401	ENLARGED TELECOM PLAN AND DETAILS TELECOM ELEVATIONS	
T402 T403	CBP RADIO ANTENNA INSTALLATION	
T501	TELECOM DETAILS	
T502	TELECOM DETAILS	
T502	TELECOM DETAILS	
T601	TELECOM CABLE SCHEDULE	
T602	TELECOM CABLE SCHEDULE	
T701	TELECOM BLOCK DIAGRAMS	
T701	TELECOM INTERCONNECT DIAGRAM	
T703	TELECOM RISER DIAGRAM	
7. SECURITY	>	
TY100	SECURITY SITE PLAN	
TY101	FIRST FLOOR PARTIAL PLAN - SECURITY PLAN	
TY102	ENLARGED PLAN - CBP GATE	
TY103	ENLARGED PLAN - DETENTION GATE	
TY501	SECURITY DOOR DETAILS	
TY502	SECURITY DOOR DETAILS	
TY503	SECURITY DOOR DETAILS	
TY504	SECURITY DOOR DETAILS	
TY505	SECURITY DEVICE DETAILS	
TY506	SECURITY DEVICE DETAILS	
TY507	SECURITY CAMERA DETAILS	
TY508	SECURITY CAMERA DETAILS	
TY509	VEHICLE GATE DETAILS	
TY510	VEHICLE GATE DETAILS	
TY511	VEHICLE GATE DETAILS	
TY601	SECURITY CAMERA SCHEDULE	
TY602	SECURITY CAMERA SCHEDULE	
TY603	SECURITY DOOR SCHEDULE	
TY701	SECURITY BLOCK DIAGRAMS	
TY702	SECURITY INTERCONNECT DIAGRAM	
TY703	SECURITY DOOR RISER DIAGRAM	
TY704		



3D IMAGE - NW CORNER, MAIN ENTRY & PASSENGER WAITING PORCH

SCALE

RS&H

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PENSACOLA INTERNATIONAL

PENSACOLA, FLORIDA

AIRPORT

PENSACOLA
GENERAL
AVIATION
FACILITY (GAF)



PROFESSIONAL SEAL



REVISIONS				
NO.	DESCRIPTION	DATE		
		·		

DATE ISSUED: 03/03/2020

REVIEWED BY: SG

DRAWN BY: JKS

DESIGNED BY: MWR

PROJECT NUMBER:

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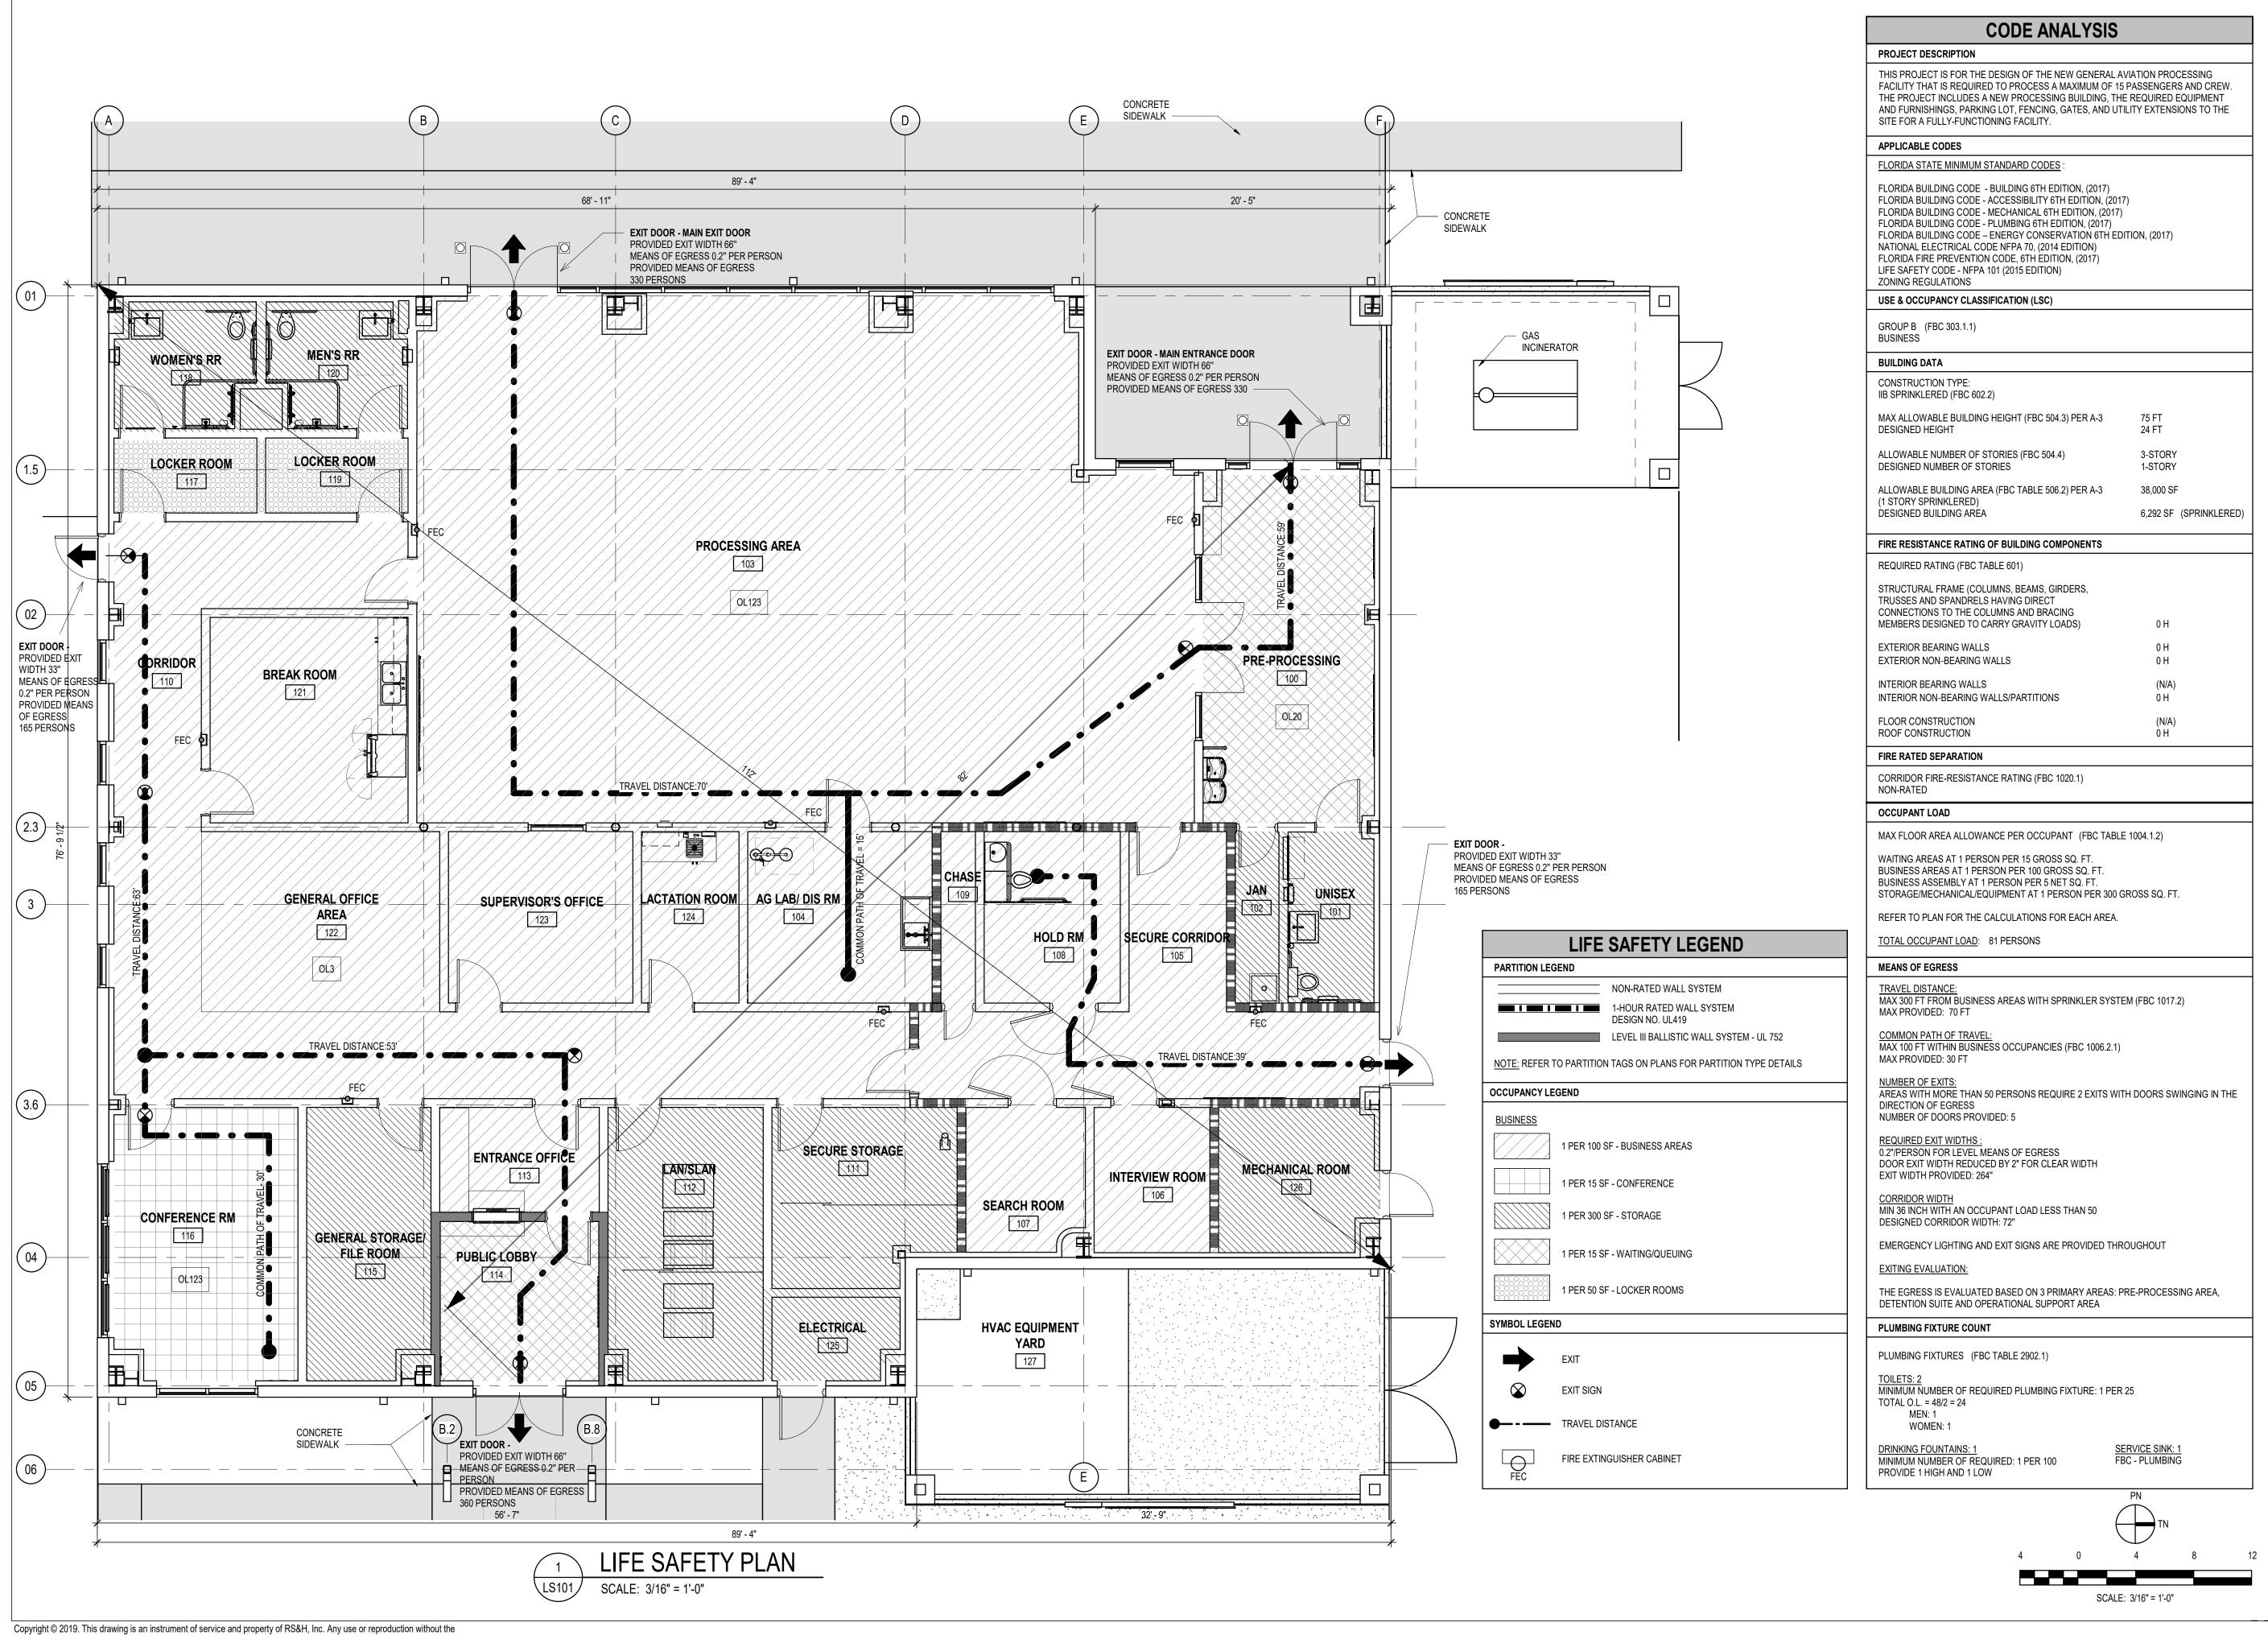
SHEET TITLE

SHEET INDEX

SHEET NUMBER

G001

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INTERNATIONAL AIRPORT

PENSACOLA

PENSACOLA, FLORIDA

PENSACOLA GENERAL AVIATION FACILITY (GAF)

> Pensacola, FL 32502 T 850.432.0706 F 850.433.0508 G M C N E T W O R K . C O M

PROFESSIONAL SEAL



DATE ISSUED: 03/03/2020 REVIEWED BY: JKS DRAWN BY: MWR

NO. DESCRIPTION DATE

REVISIONS

DESIGNED BY:

PROJECT NUMBER: 201-0052-002 © 2020 RS&H, INC.

SHEET TITLE

LIFE SAFETY PLAN & CODE **ANALYSIS**

SHEET NUMBER

LS101

MAX. BUILDING HEIGHT = 45'
MAXIMUM IMPERVIOUS LOT COVERAGE = 75%

EXISTING LOT COVERAGE

IMPERVIOUS AREA = 18,731 SF (0.43 AC)

PERVIOUS AREA = 196,020 SF (4.50 AC)


PROPOSED LOT COVERAGE

IMPERVIOUS AREA = 19,602 SF (0.45 AC)

PERVIOUS AREA = 195,149 SF (4.48 AC)

WETLANDS: NO WETLANDS ON SITE

LEGEND

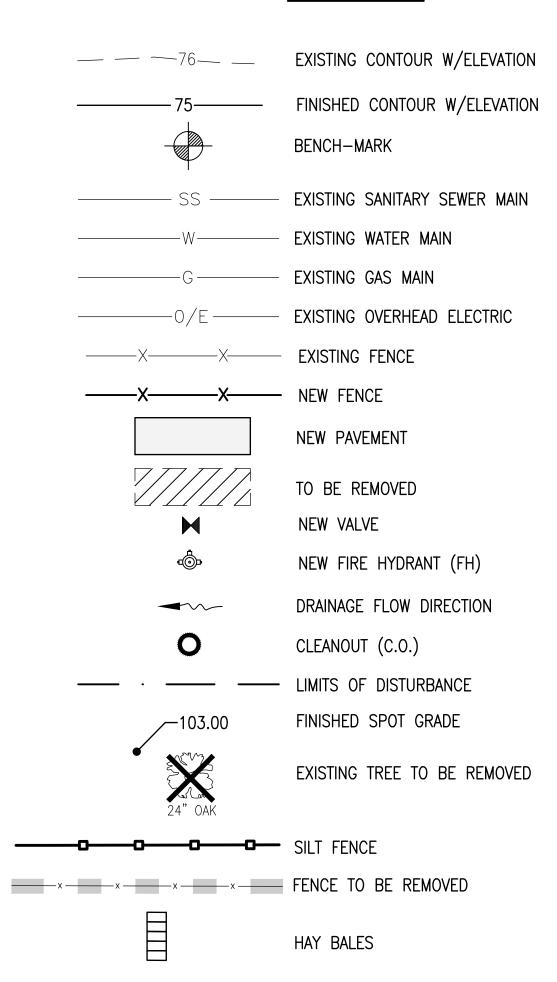

GENERAL NOTES:

- 1. THE CONTRACTOR IS CAUTIONED TO VISIT THE SITE AND FAMILIARIZE HIMSELF WITH THE PROJECT PRIOR TO BIDDING.
- 2. ELEVATIONS SHOWN ARE RELATIVE TO N.G.V.D. 88
- 3. THE CONTRACTOR IS RESPONSIBLE TO DETERMINE THE EXACT LOCATIONS AND DEPTHS OF ALL UTILITIES INCLUDING, BUT NOT LIMITED TO, WATER LINES, BURIED TELEPHONE LINES, BURIED ELECTRICAL LINES AND GAS MAINS PRIOR TO COMMENCEMENT OF CONSTRUCTION. CONTRACTOR IS TO COORDINATE WITH UTILITY COMPANIES FOR REMOVAL AND/OR RELOCATION OF EXISTING UTILITY POLES, AERIAL LINES, BURIED CABLE AND OTHER UTILITIES.
- 4. THE CONTRACTOR SHALL NOTIFY THE ENGINEER IMMEDIATELY OF ANY CONFLICTS BETWEEN CONTRACT DOCUMENTS AND EXISTING CONDITIONS. THESE DRAWINGS REPRESENT KNOWN STRUCTURES AND UTILITIES LOCATED IN THE PROJECT AREA. THE CONTRACTOR IS CAUTIONED THAT OTHER STRUCTURES AND UTILITIES, ABOVE OR BELOW GROUND, MAY BE ENCOUNTERED DURING THE COURSE OF THE PROJECT. THE CONTRACTOR SHOULD NOTIFY THE UTILITY, THEN THE ENGINEER, IMMEDIATELY UPON ENCOUNTERING ANY UNEXPECTED STRUCTURE, UTILITY LINE, OR OTHER UNUSUAL CONDITION. EXISTING CONDITIONS ARE BASED ON SURVEYS BY BASKERVILLE—DONOVAN, INC.
- 5. CONTRACTOR SHALL SAFETY-BARRICADE ALL EXCAVATIONS AND OTHER HAZARDS.
- 6. CONTRACTOR SHALL PROVIDE ACCESS TO PROPERTIES ADJACENT TO THE CONSTRUCTION AREAS. ADEQUATE BARRICADES, CONSTRUCTION SIGNAGE AND OTHER TRAFFIC CONTROL DEVICES SHALL BE PROVIDED IN ACCORDANCE WITH FDOT CONSTRUCTION STANDARDS.
- 7. THE CONTRACTOR SHALL EMPLOY THE USE OF SILT FENCES, HAY BALES, DITCHES OR WHATEVER MEANS NECESSARY TO CONTROL EROSION AND SEDIMENTATION AT ALL TIMES. WATERS OF THE STATE, ADJACENT PROPERTIES, AND ANY NEW DRAINAGE CONSTRUCTION SHALL BE PROTECTED DURING THE CONSTRUCTION PERIOD. EROSION CONTROL MEASURES SHALL BE INSTALLED PRIOR TO THE START OF CONSTRUCTION AND SHALL REMAIN UNTIL THE COMPLETION OF CONSTRUCTION AND ACCEPTANCE BY THE OWNER.
- 8. ADEQUATE PROVISIONS SHALL BE MADE FOR THE FLOW OF SEWERS, DRAINS, WATER COURSES AND OTHER UTILITIES ENCOUNTERED DURING CONSTRUCTION.
- 9. ALL PAVEMENT CUTS SHALL BE SAW CUT.
- 10. ALL TREES IN THE PROJECT AREA ARE TO REMAIN UNDAMAGED UNLESS NOTED FOR REMOVAL OR APPROVED BY THE ENGINEER.
- 11. THE CONTRACTOR IS TO REPLACE TO EXISTING CONDITIONS OR BETTER ANY FENCES, SPRINKLER SYSTEMS, TREES AND SHRUBS, MAINTAINED FLOWER BEDS, OR OTHER EXISTING IMPROVEMENTS IMPACTED DURING
- CONSTRUCTION, WHETHER DEPICTED IN THE PLANS OR NOT.

 12. ALL NEW CONCRETE FOR SITE WORK SHALL ACHIEVE A 28 DAY STRENGTH
- OF 3000 PSI (MIN.), UNLESS OTHERWISE SPECIFIED.

 13. ALL TRAFFIC CONTROL SIGNS AND MARKINGS SHALL CONFORM WITH THE MANUAL ON UNIFORM TRAFFIC CONTROL DEVICES (MUTCD), FHWA, LATEST EDITION
- 14. DAMAGE TO EXISTING ROADS DURING CONSTRUCTION WILL BE REPAIRED BY THE DEVELOPER PRIOR TO FINAL "AS-BUILT" SIGN-OFF FROM THE CITY.
- 15. PARTIAL SCREENING SHALL BE PROVIDED AT THE MULTI-TENANT SERVICE CORRIDORS.16. ALL NEW BUILDING ROOF DRAINS. DOWN SPOUTS. OR GUTTERS SHALL
- 16. ALL NEW BUILDING ROOF DRAINS, DOWN SPOUTS, OR GUTTERS SHALL BE ROUTED TO CARRY ALL STORMWATER TO RETENTION/DETENTION AREAS
- 17. THE CONTRACTOR SHALL NOTIFY FDOT 48 HOURS IN ADVANCE PRIOR TO INITIATING ANY WORK IN THE STATE RIGHT-OF-WAY.
- 18. THE SUBJECT PARCEL FALLS WITHIN TIME TRAVEL CONTOURS OF A PROTECTED (POTABLE) WELLHEAD. CONTRACTORS SHALL BE RESPONSIBLE FOR REPORTING SPILLS OF POTENTIALLY HAZARDOUS SUBSTANCES (I.E. GASOLINE, DIESEL FUEL, HYDRAULIC FLUID, CLEANING PRODUCTS, CHEMICALS, ETC.) TO THE APPROPRIATE STATE (FDEP STATE WARNING POINT 1–800–320–0519) AND LOCAL (ESCAMBIA COUNTY HEALTH DEPARTMENT/ENVIRONMENTAL HEALTH 595–6712) AGENCIES.
- 19. NO SITE WORK ACTIVITIES SHALL TAKE PLACE WITHOUT CITY SITE REVIEW AND APPROVAL OF PROPOSED EROSION CONTROL MEASURES AND ADVANCED NOTIFICATION OF THE REQUESTED INSPECTION IS REQUIRED.



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PENSACOLA INTERNATIONAL AIRPORT

PENSACOLA, FLORIDA

PENSACOLA
GENERAL
AVIATION
FACILITY (GAF)

IN COLLABORATION WITH:



BASKERVILLE-DONOVAN, INC.

Haskerville-Donovan, II Innevative Infrastructure Seluti 449 W. MAIN ST. PENSACOLA, FLORIDA 32502 (850)438-9661 Engineering Business: EB-0000340

PROFESSIONAL SEAL

JASON J. FRICK P.E. FL Reg. Engineer #86469

DEVISIONS

REVISIONS			
NO.	DESCRIPTION	DATE	

 DATE ISSUED:
 03/03/2020

 REVIEWED BY:
 MDL

 DRAWN BY:
 RGG

 DESIGNED BY:
 JJF

PROJECT NUMBER:

201-0052-002


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SHEET TITLE

GENERAL NOTES, LEGEND & SITE DATA

SHEET NUMBER

C001

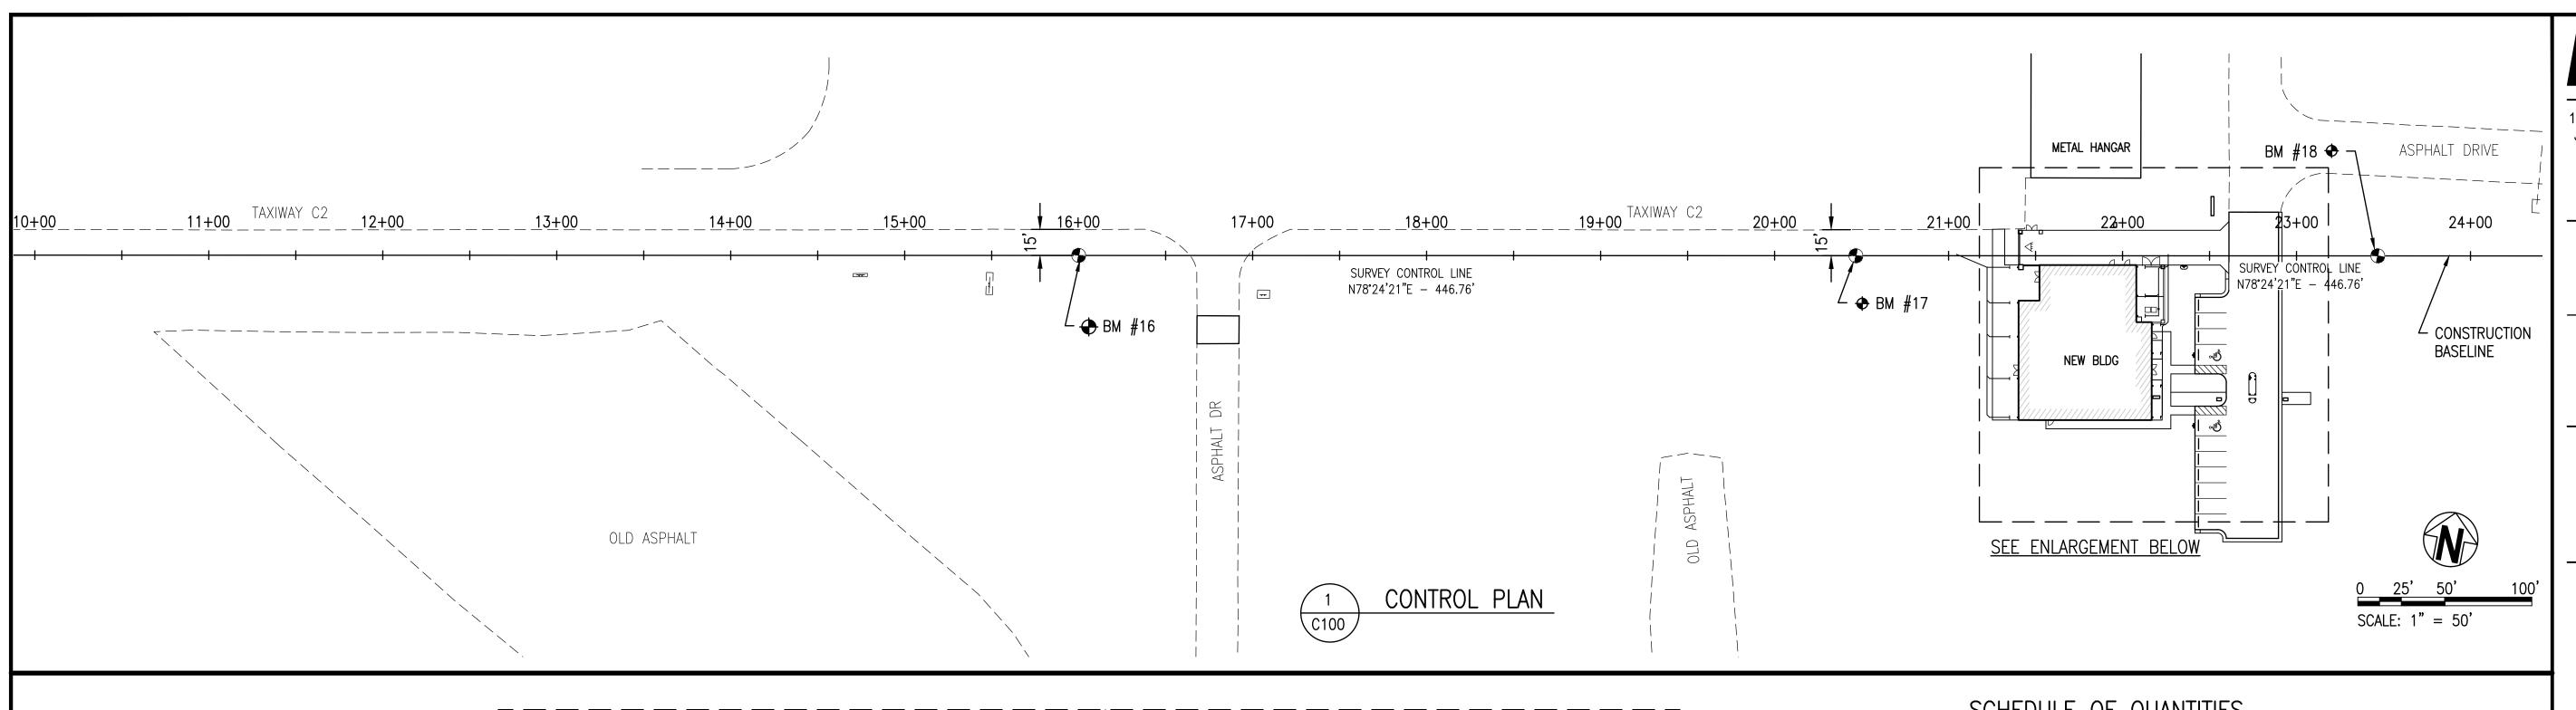


BENCH MARK DATA

CAPPED IRON ROD No. 0340 STA 16+00, 0' LT/RT ELEVATION= 102.76

CAPPED IRON ROD No. 0340 STA 20+46.76, 0' LT/RT ELEVATION= 103.91

BM #18 CAPPED IRON ROD No. 0340 STA 23+46.69, 0' LT/RT ELEVATION= 102.02

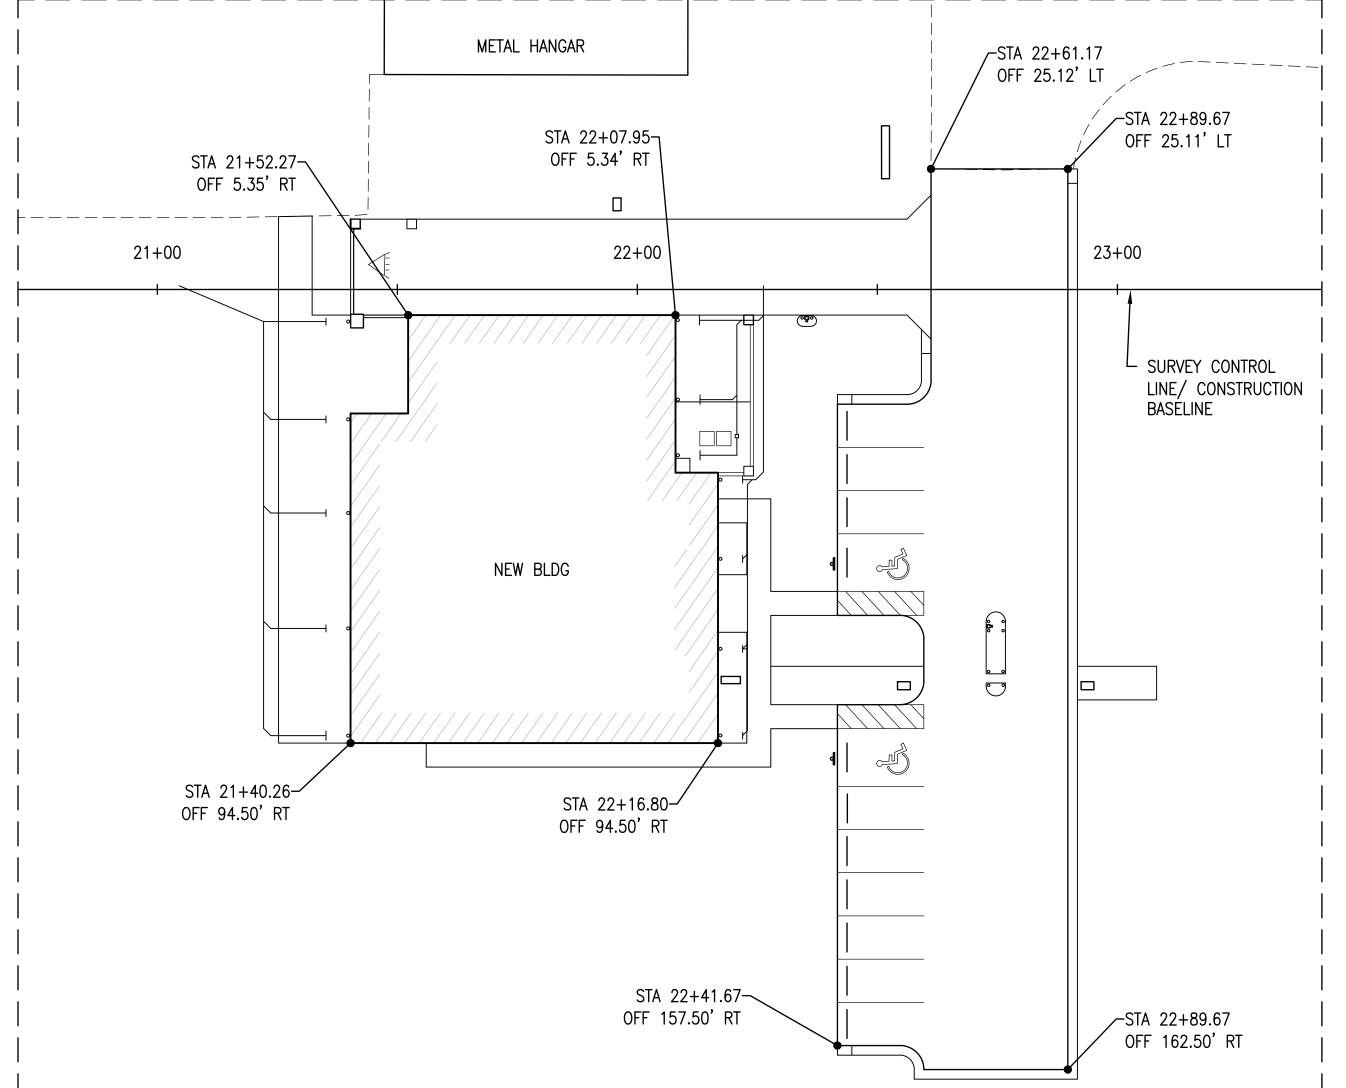


ENLARGEMENT

SCHEDULE OF QUANTITIES

DESCRIPTION	QUANTITY	UNIT
Mobilization	1	LS
Maintenance of Traffic	1	LS
Clearing and Grubbing	5.00	AC
Asphalt Sawcutting	1,114	LF
Asphalt Removal (6" average depth)	2,130	SY
Erosion Control	1	LS
Fence Removal	355	LF
Temporary Perimeter Fence	281	LF
Pipe Removal	95	LF
MES Removal	2	EA
Tree Removal	6	EA
Embankment	2,322	CY
Excavation	4,337	CY
Concrete Pavement (6" Thick)	640	SY
12" Stabilized Subgrade	905	SY
6" Graded Aggregate Base	877	SY
Lateral Pavement Patch	111	SY
1.5" Type SP 9.5 Asphalt	70	TN
Gravel Area (6"depth)	27	SY
18" RCP	478	LF
30" RCP	937	LF
Junction Boxes	5	EA
30" MES	1	EA
FDOT Type C Inlet	1	EA
FDOT Type D Inlet	1	EA
Parking Stops	11	EA
Pavement Markings	500	LF
Security Fence	280	LF
Bollards	8	EA
Curb and Gutter	273	LF
Handicap Parking Signs	2	EA
Meter Box	1	EA
Meter Vault	1	EA
Staked Sod	13,651	SY
*PVC for Drainage and Utilities Inc. DI,MJ, Fittings/Valves	13,031	LS
4" Sanitary Sewer Connection	32	LF
•	1.0	
Fire Department Connection		EA
Check Valves	3	EA
Service Taps Peak Flow Proporter with Franza Protection (PDZ)		EA
Back Flow Preventer with Freeze Protection (RPZ)	2	EA
Back Flow Preventer with Freeze Protection (DBL CK Valve)		EA
Riprap to Include Geotextile Fire Hydrant	51 1	TN EA

*CONCRETE AREAS INCLUDE ALL HATCHED AREAS SHOWN ON C-104.
*IRRIGATION, SECURITY, & COMMUNICATION CONDUIT PIPE HAS BEEN EXCLUDED.

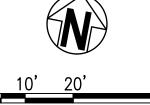

SCALE: 1" = 20'

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PENSACOLA INTERNATIONAL AIRPORT

PENSACOLA, FLORIDA

PENSACOLA GENERAL AVIATION FACILITY (GAF)

IN COLLABORATION WITH:



BASKERVILLE-DONOVAN, INC.

449 W. MAIN ST. PENSACOLA, FLORIDA 32502 (850)438-9661 Engineering Business: EB-0000340 PROFESSIONAL SEAL

JASON J. FRICK P.E. FL Reg. Engineer #86469

REVISIONS					
NO.	DESCRIPTION	DATE			
DATE ISSUED: 03/03/20					

REVIEWED BY: DRAWN BY: **DESIGNED BY:** JJF PROJECT NUMBER:

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SHEET TITLE


CONTROL PLAN

SHEET NUMBER

C100

BID DOCUMENTS

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PENSACOLA, FLORIDA

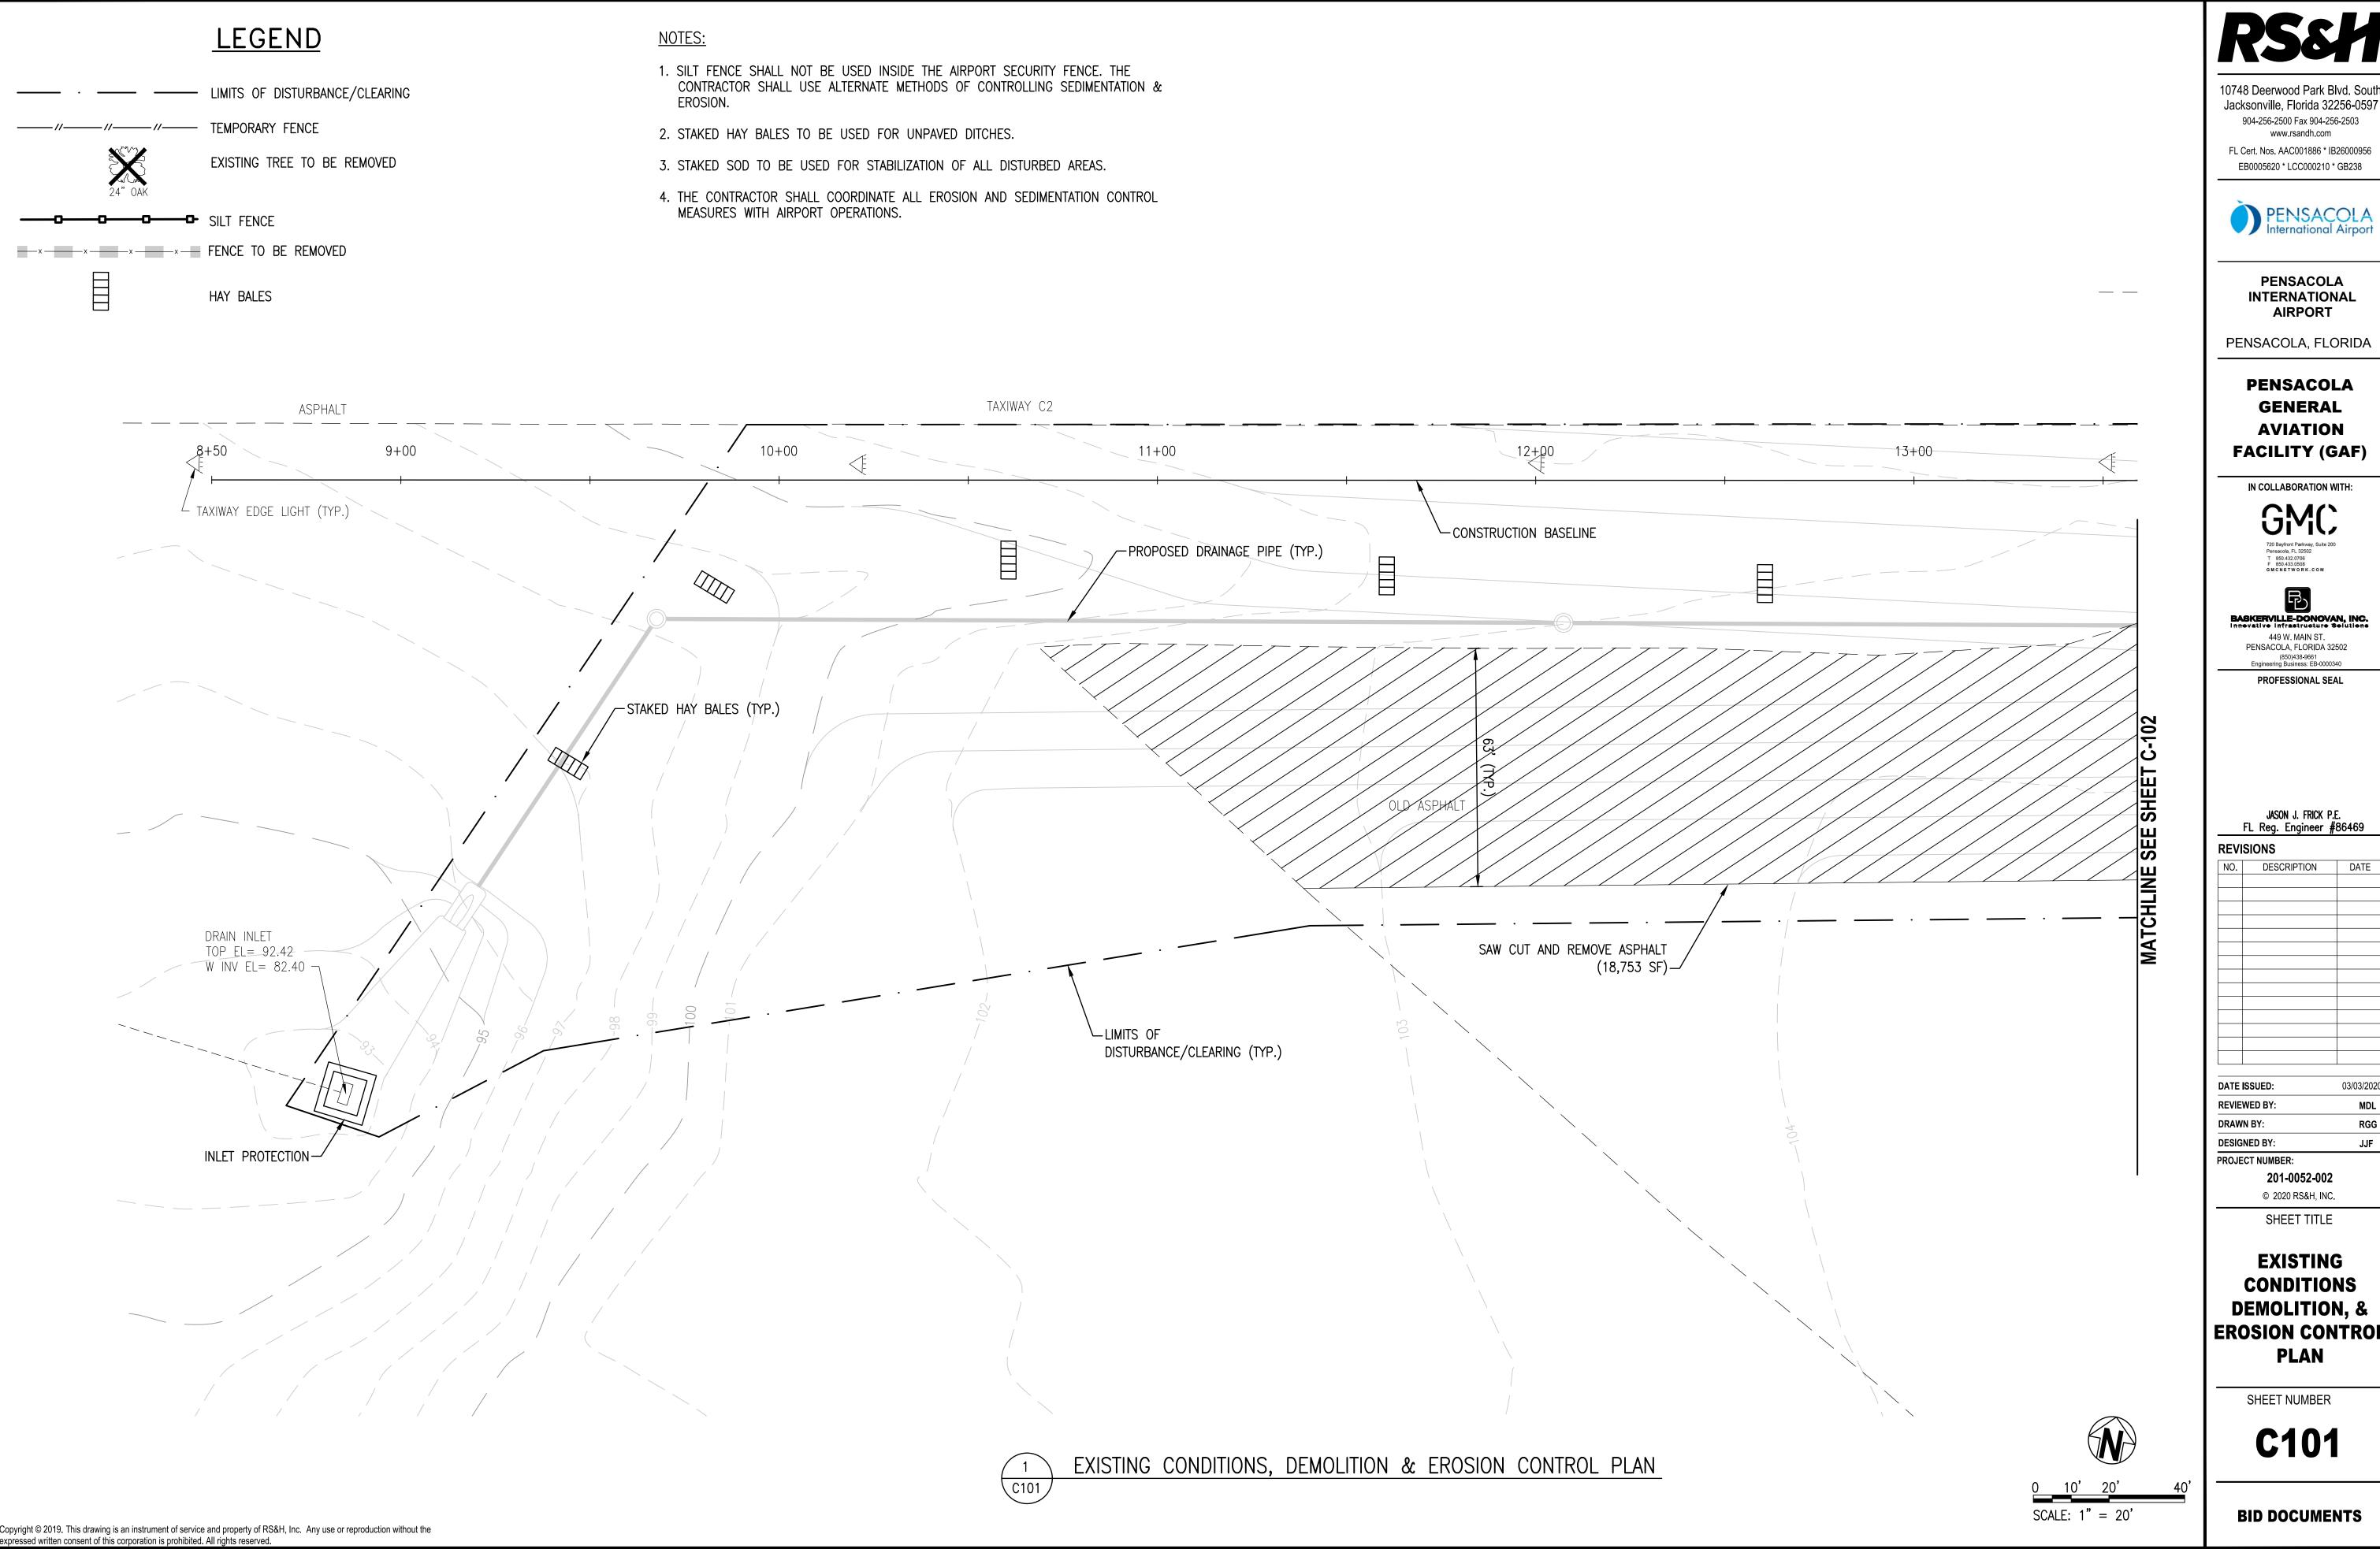PENSACOLA GENERAL AVIATION FACILITY (GAF)




BASKERVILLE-DONOVAN, INC.

449 W. MAIN ST. PENSACOLA, FLORIDA 32502 (850)438-9661 Engineering Business: EB-0000340

NO.	DESCRIPTION	DATE
DATE ISSUED: 03/03/20		

CONDITIONS DEMOLITION, & **EROSION CONTROL**

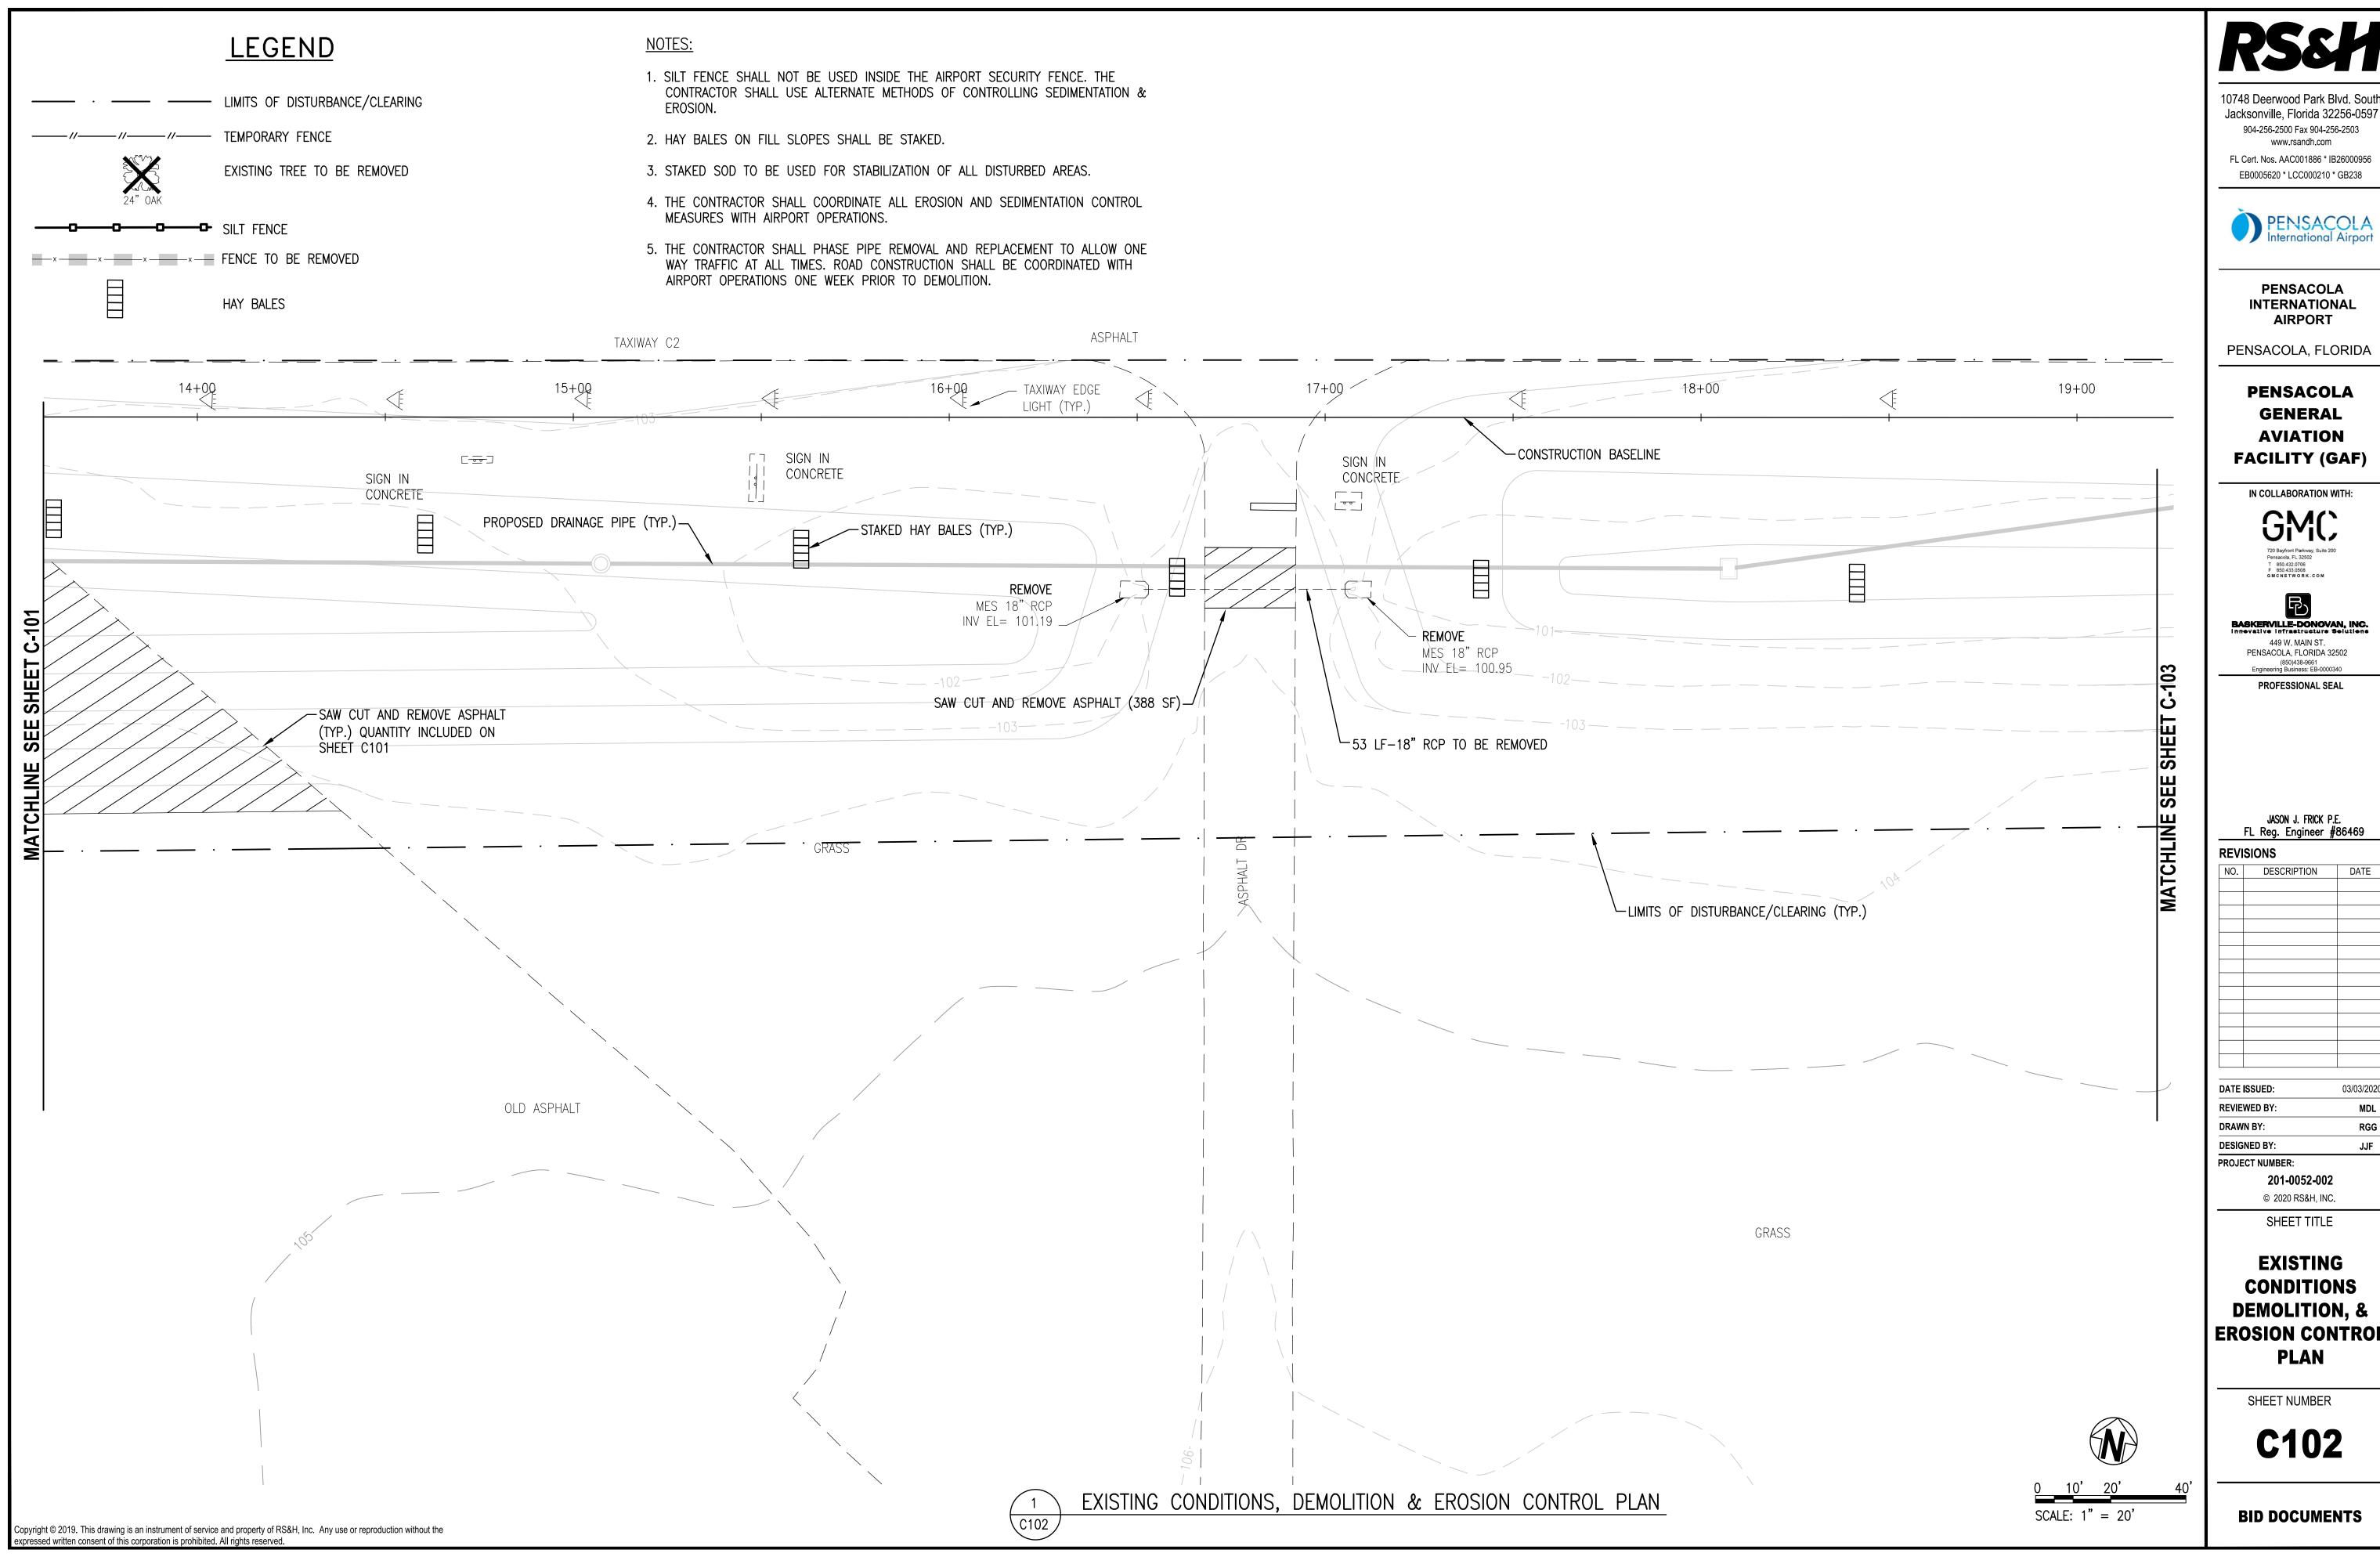

Jacksonville, Florida 32256-0597 904-256-2500 Fax 904-256-2503

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PENSACOLA GENERAL AVIATION FACILITY (GAF)



BASKERVILLE-DONOVAN, INC.


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REVIEWED B	Y:		MDL
DATE ISSUE) :	03/0	3/2020
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NO. D	ESCRIPTION	D/	AIE_

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CONDITIONS DEMOLITION, & **EROSION CONTROL**

C102



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PENSACOLA INTERNATIONAL AIRPORT

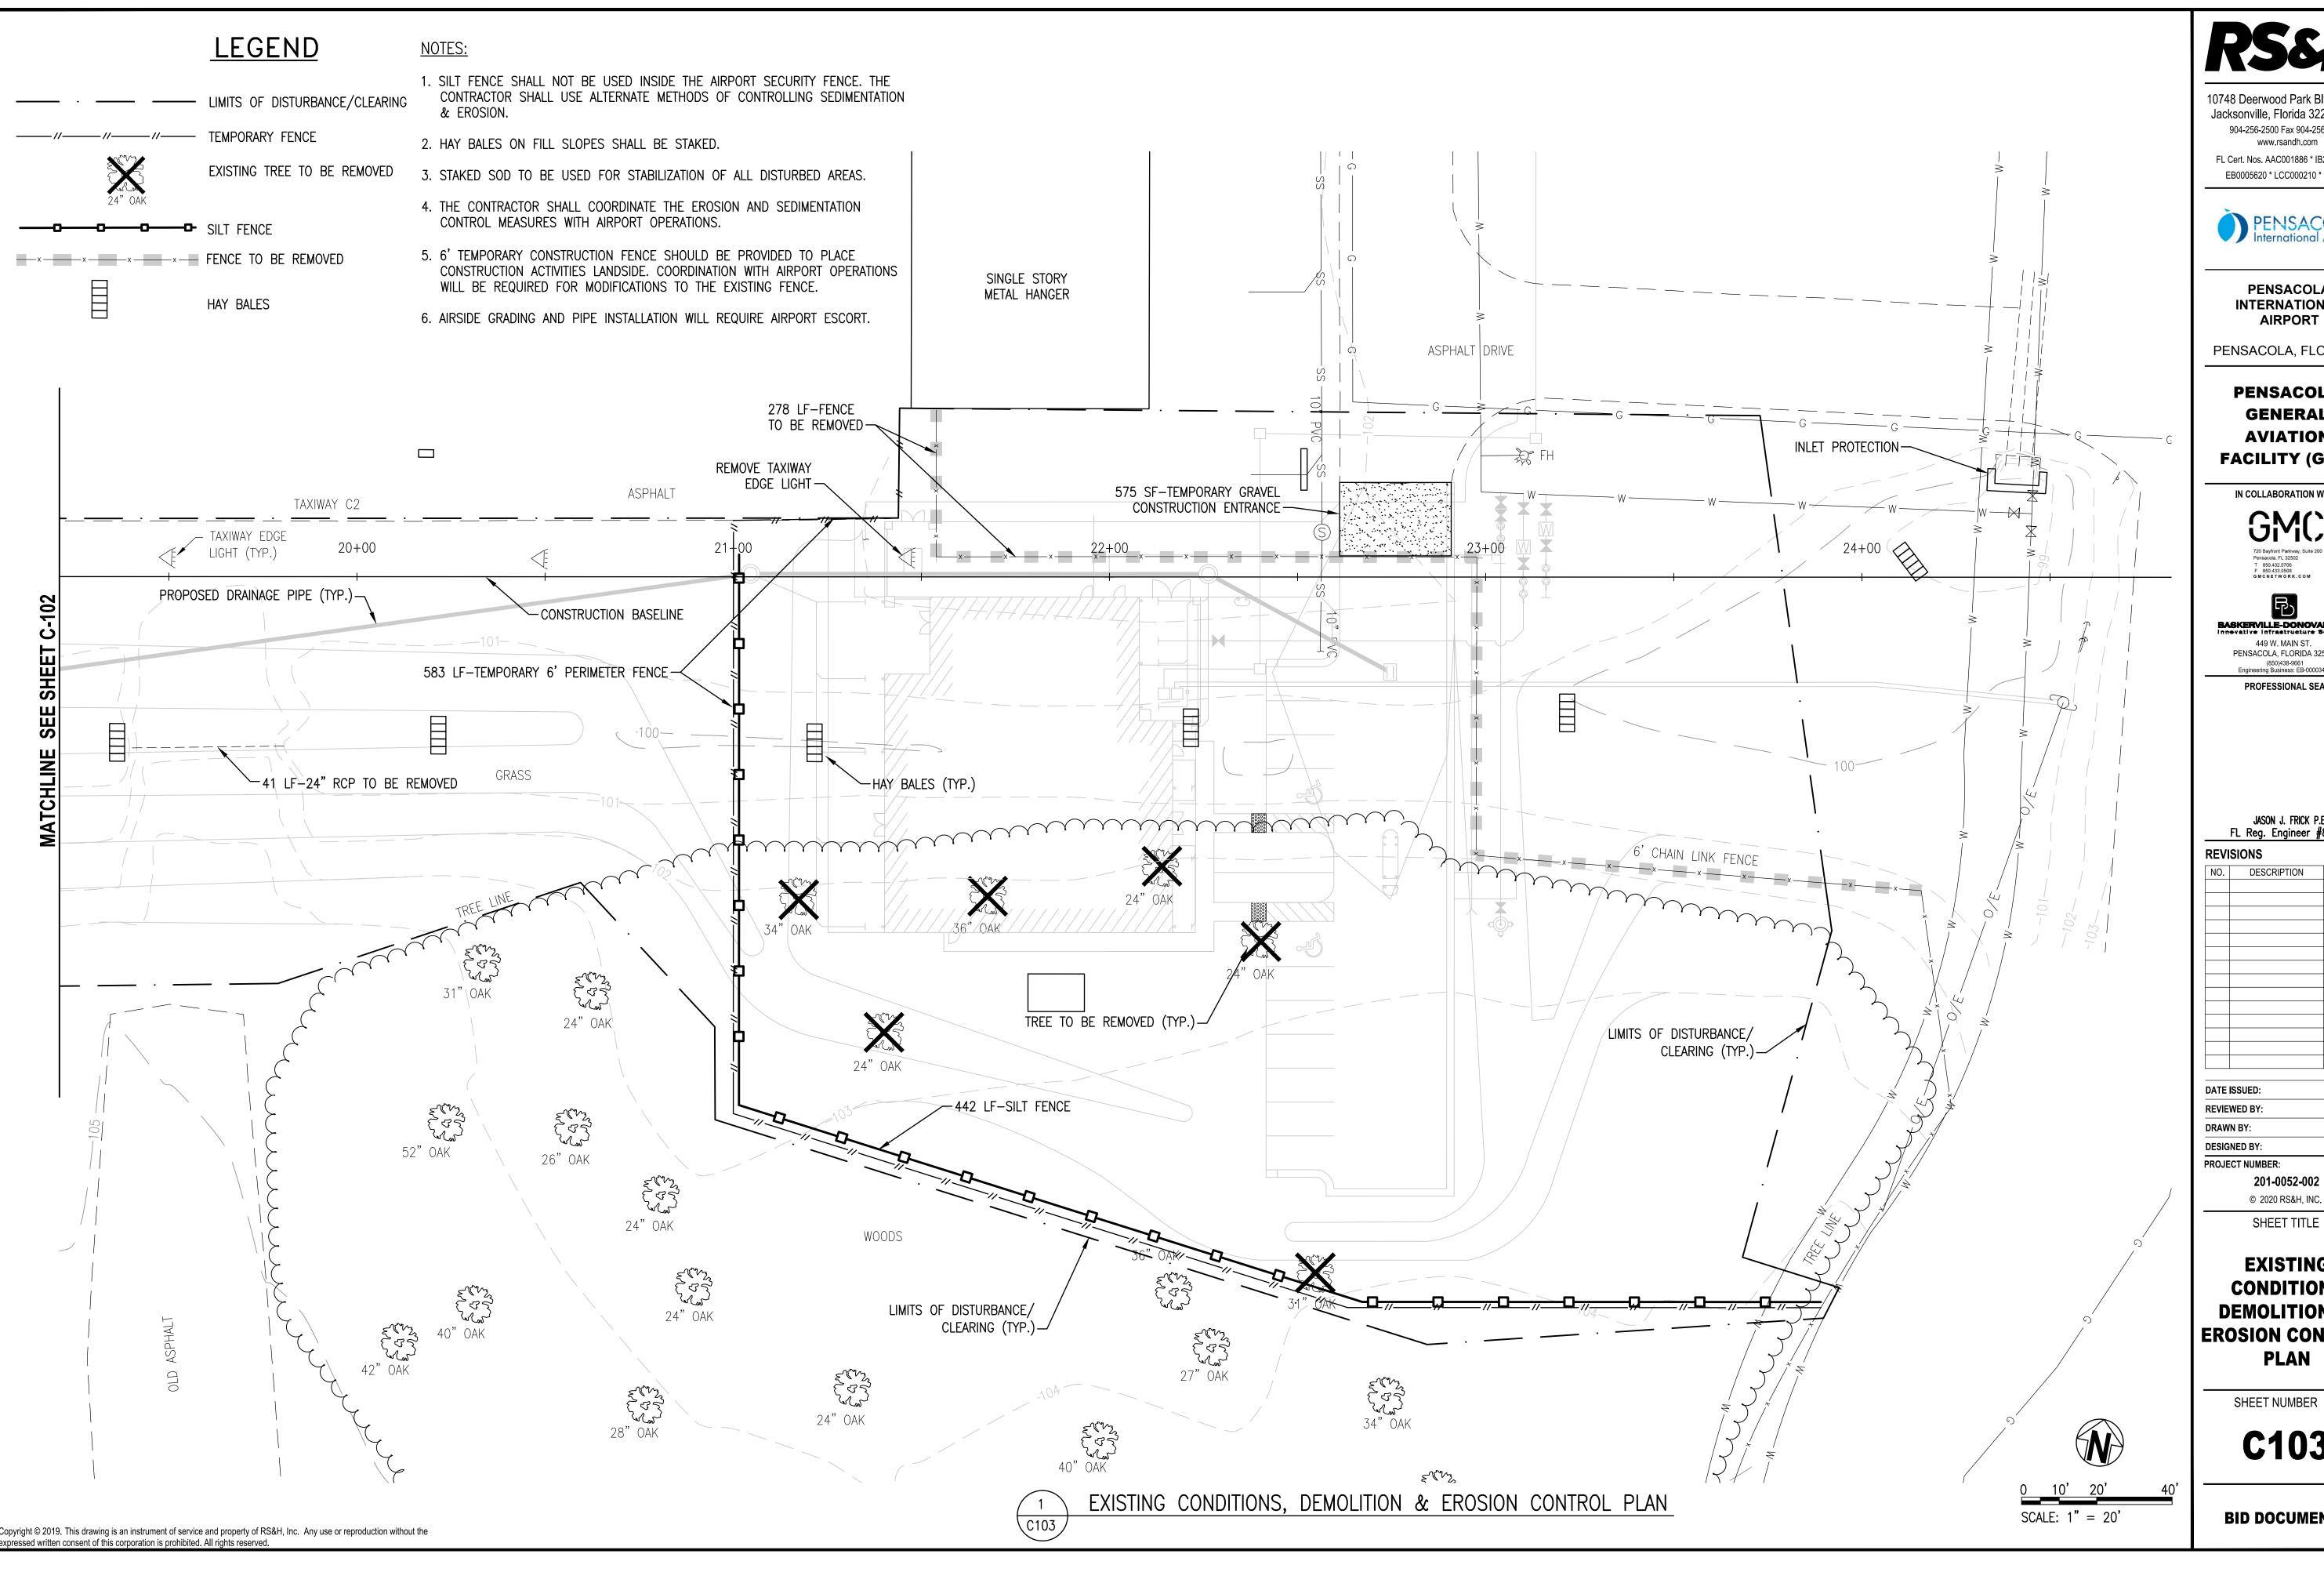PENSACOLA, FLORIDA

PENSACOLA GENERAL AVIATION FACILITY (GAF)

IN COLLABORATION WITH:



BASKERVILLE-DONOVAN, INC. Innevative infrastructure Solutions

449 W. MAIN ST. PENSACOLA, FLORIDA 32502 (850)438-9661 Engineering Business: EB-0000340 PROFESSIONAL SEAL

JASON J. FRICK P.E. FL Reg. Engineer #86469

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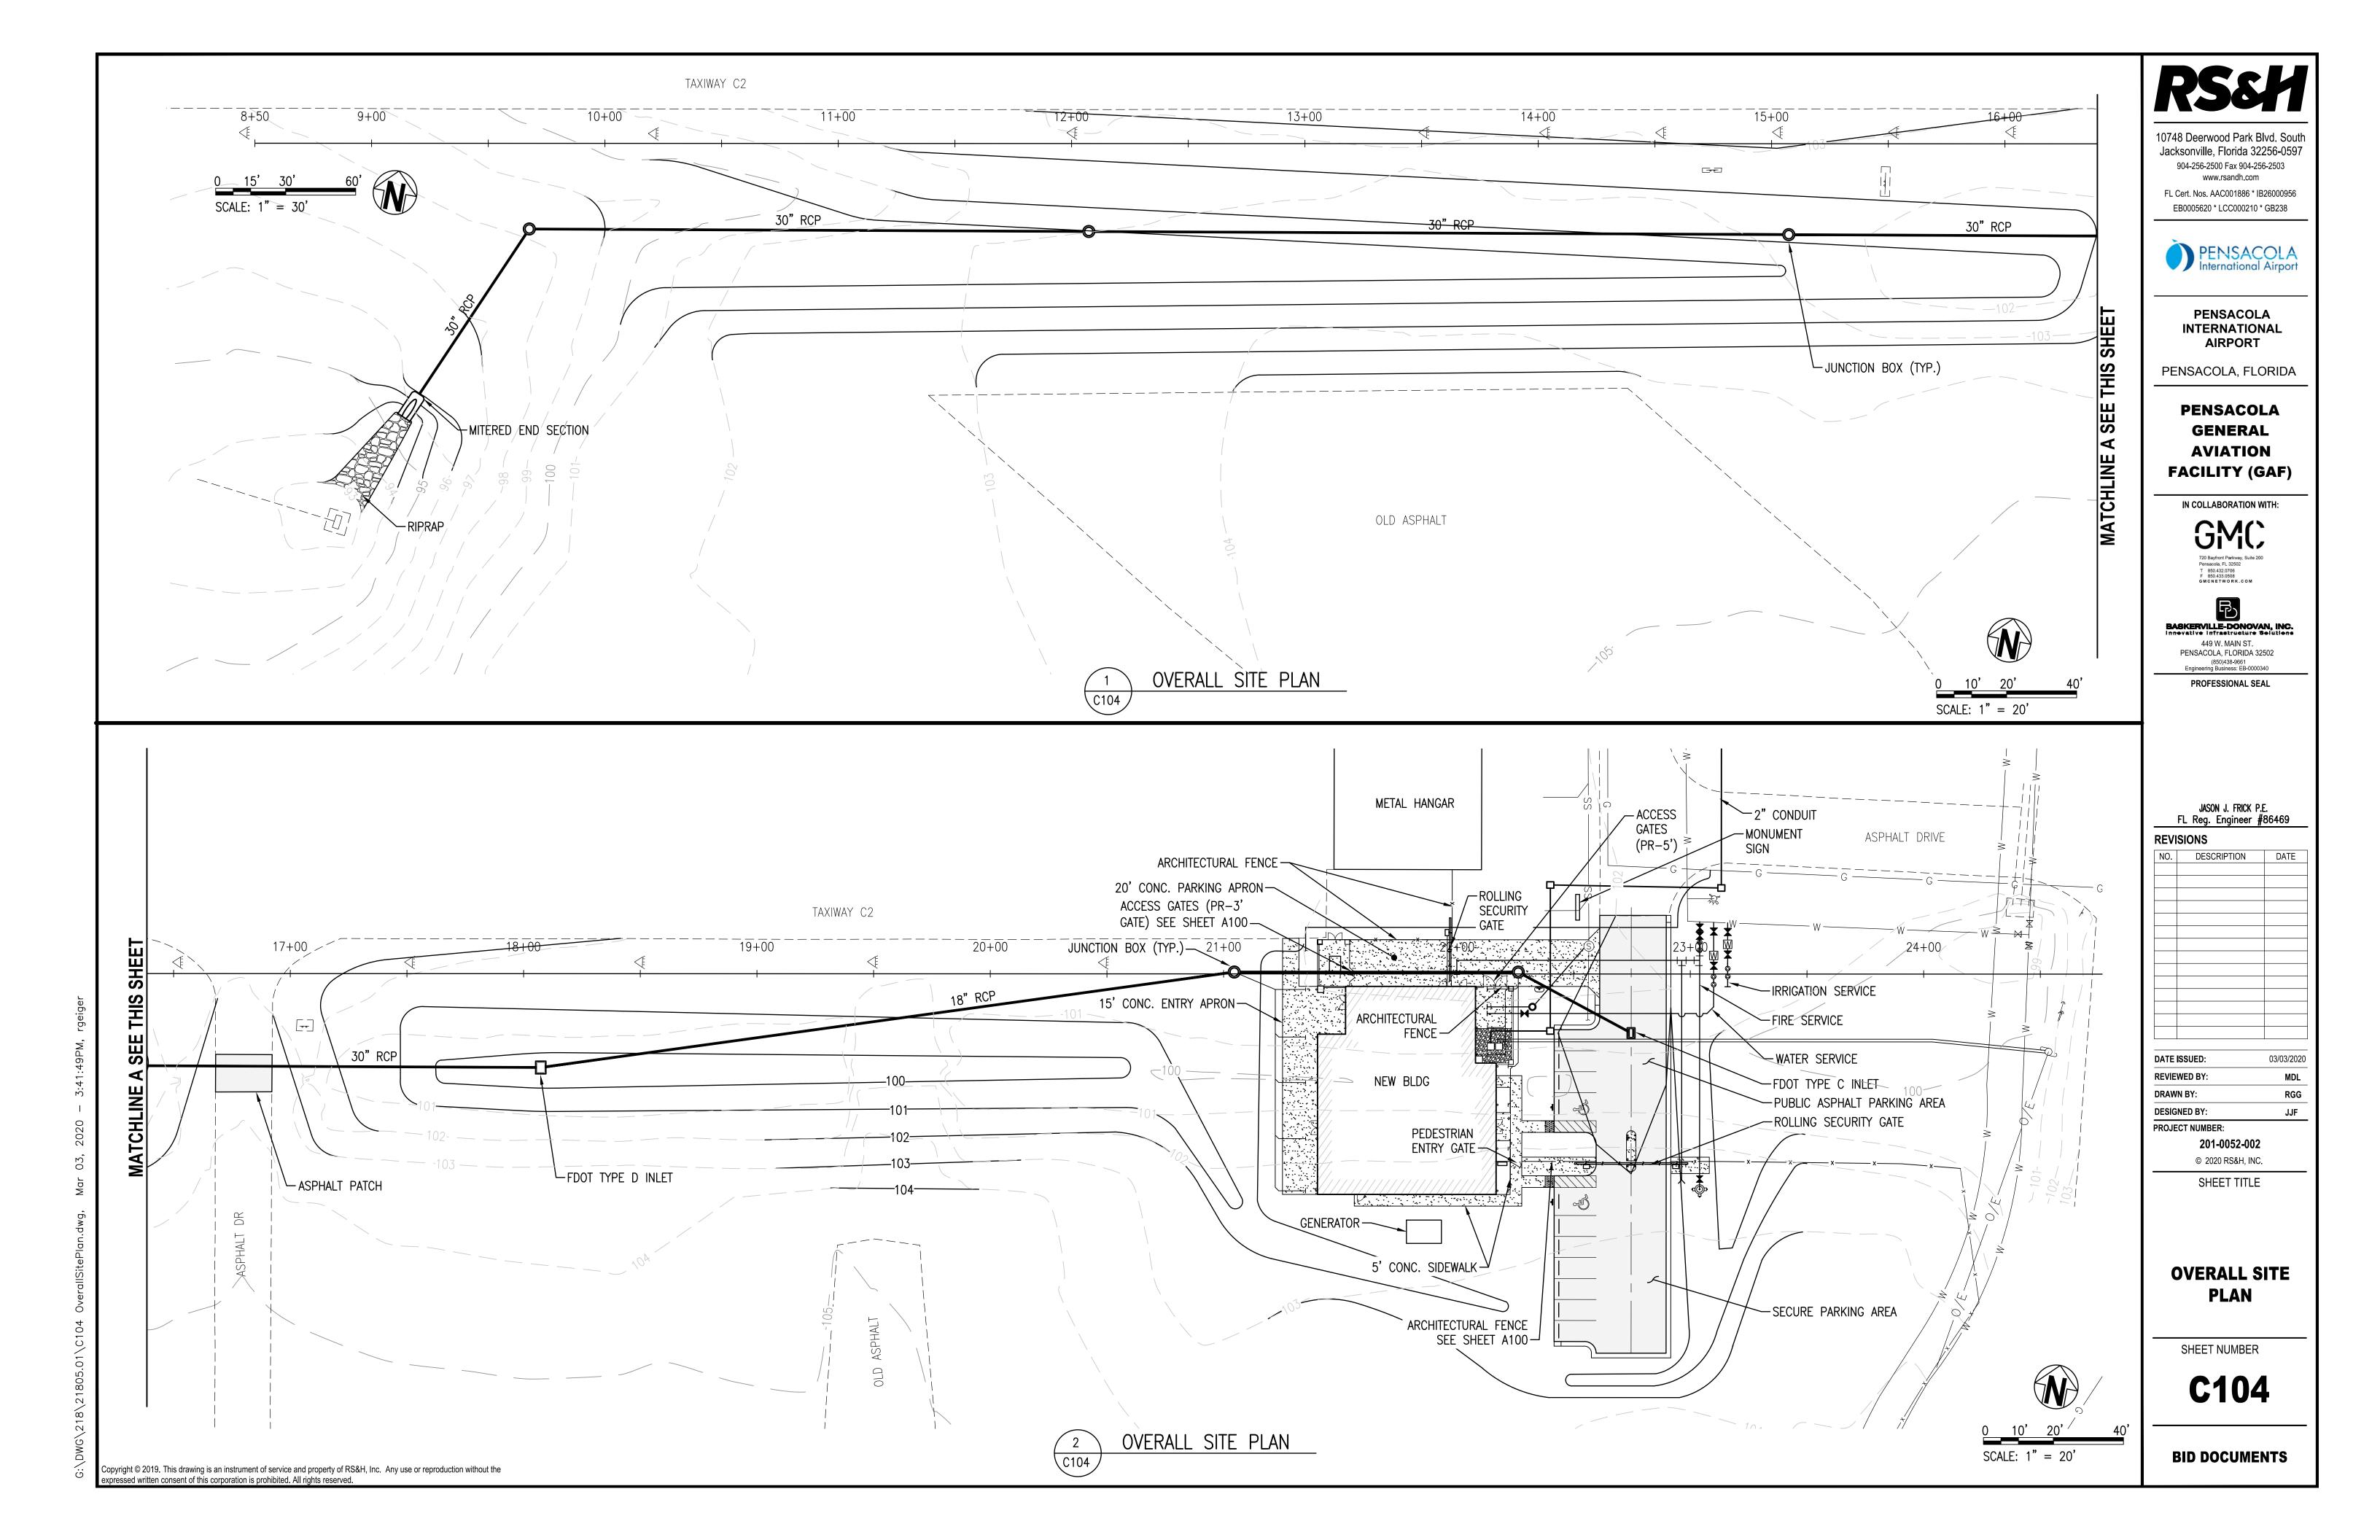
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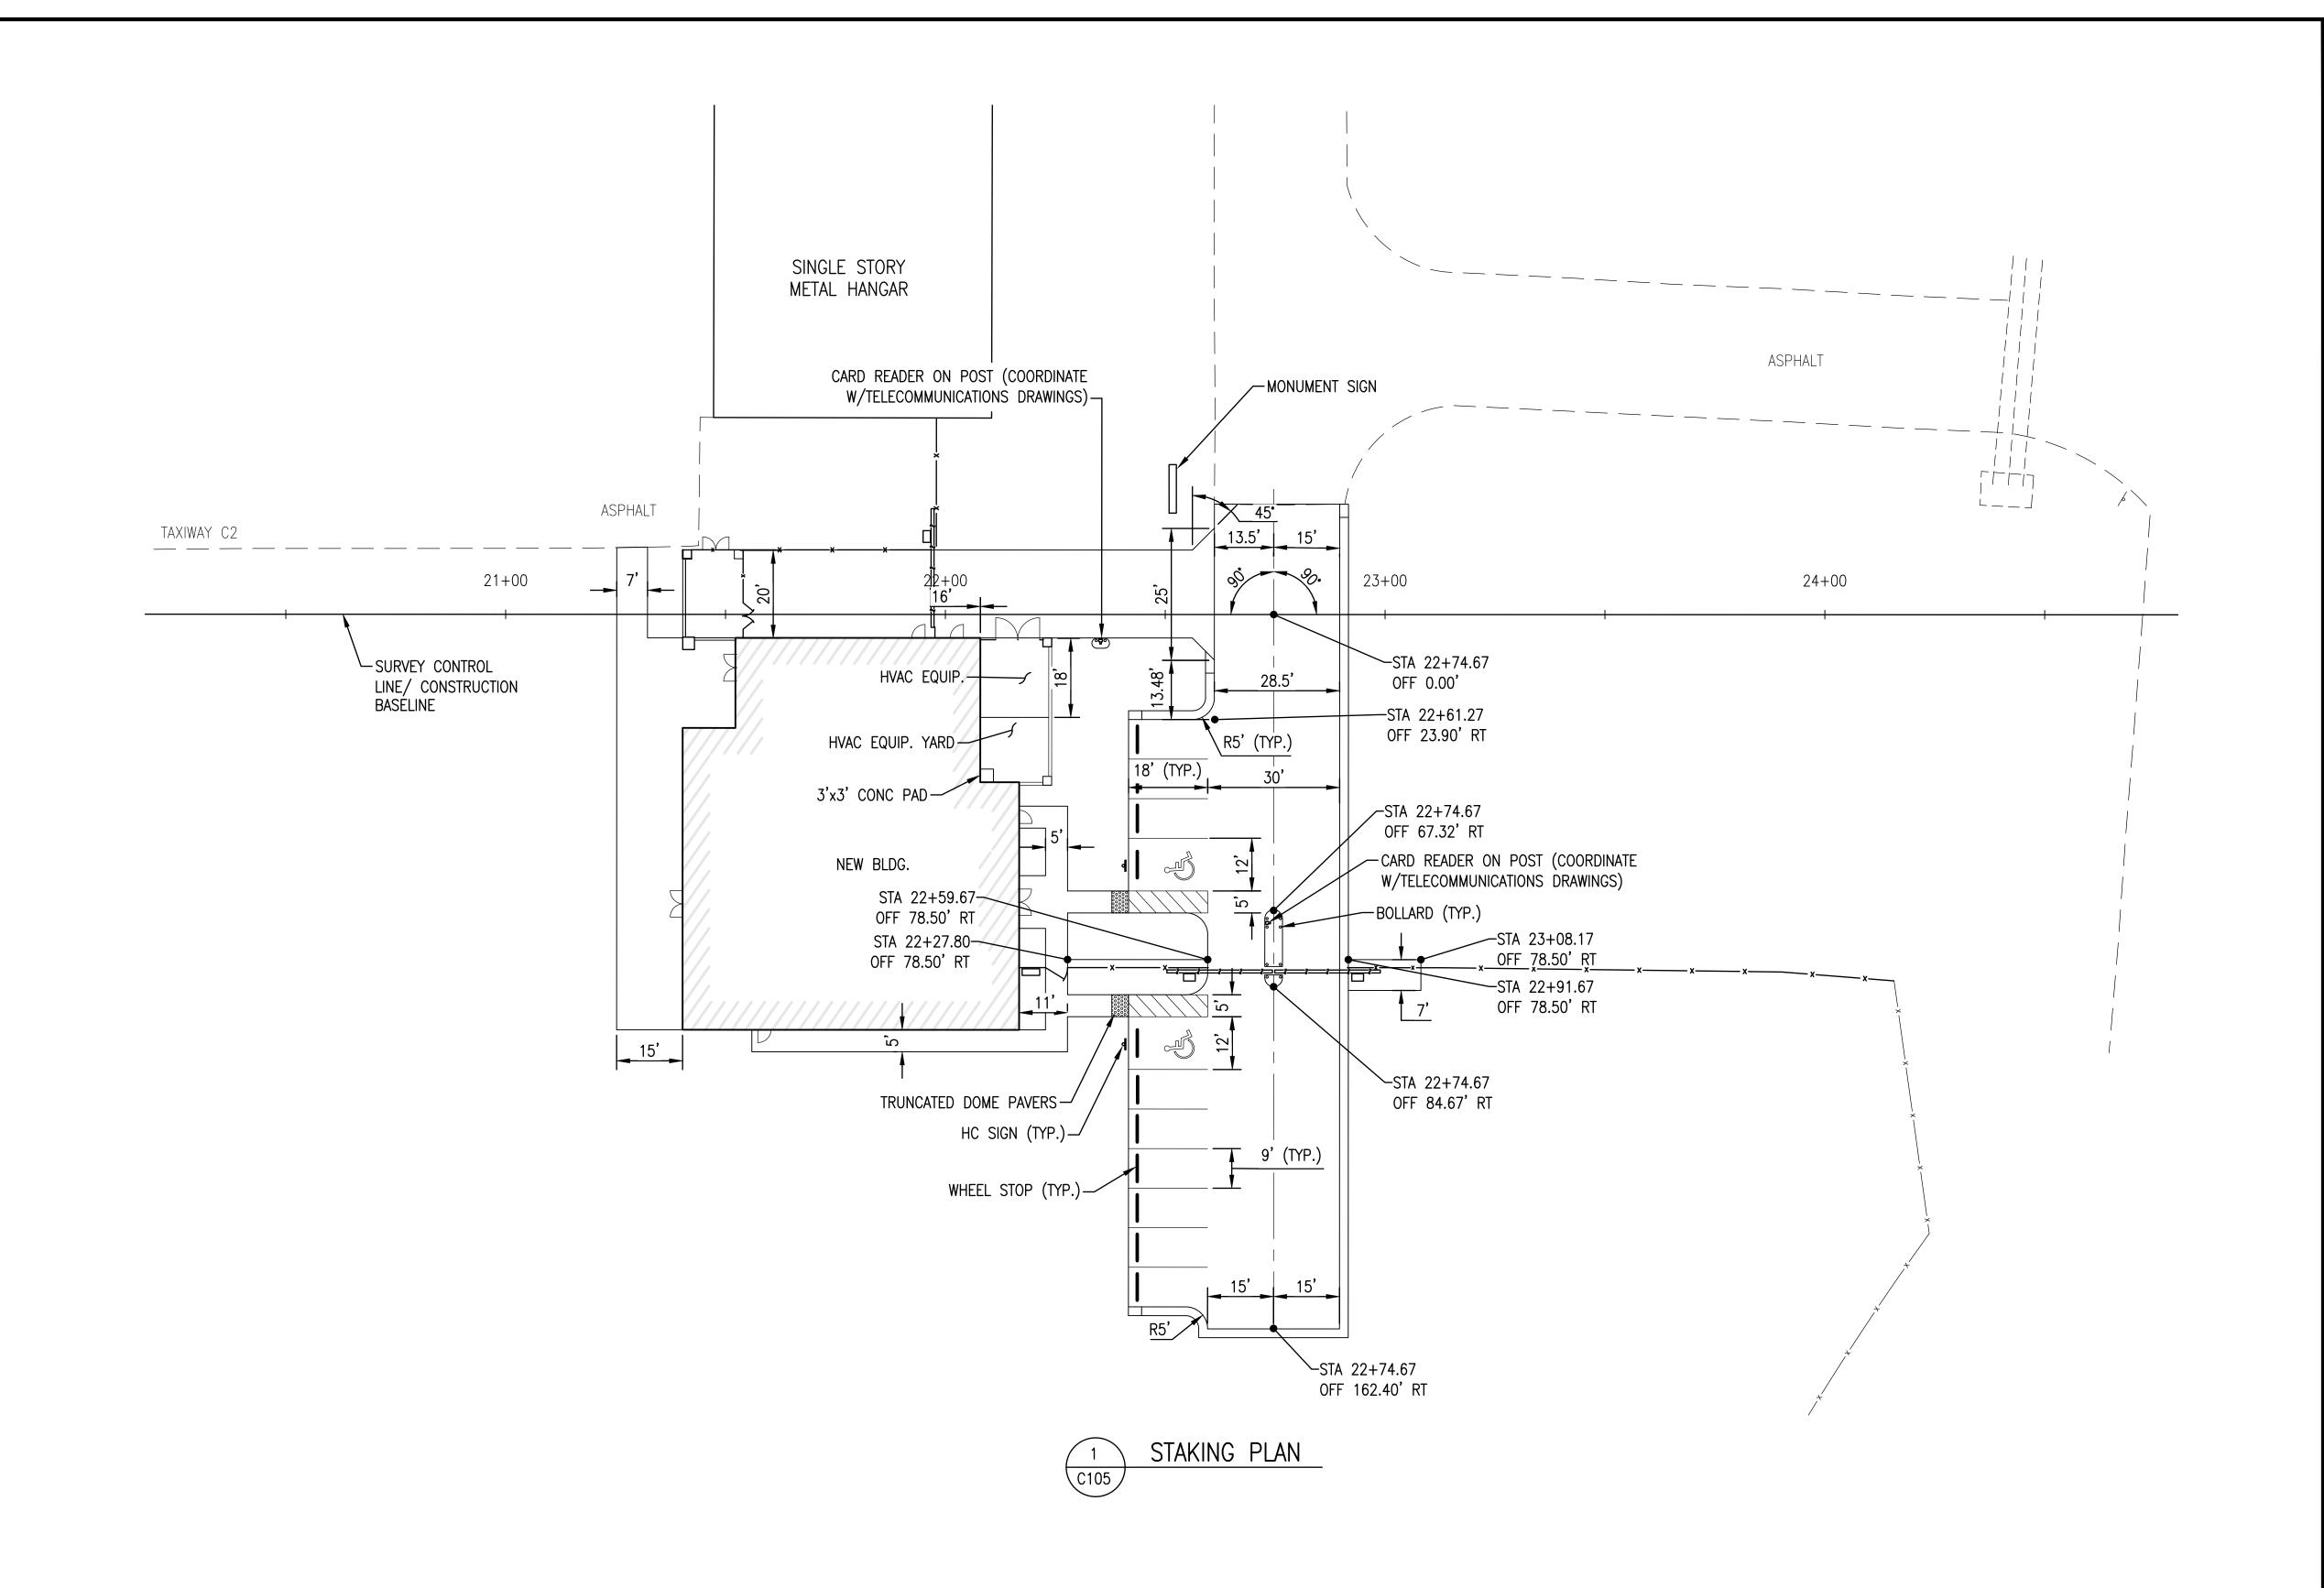
SHEET TITLE


EXISTING CONDITIONS DEMOLITION, & EROSION CONTROL PLAN

SHEET NUMBER

C103





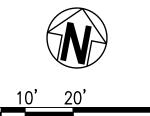

SCALE: 1" = 20'

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PENSACOLA International Airport

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AIRPORT

PENSACOLA, FLORIDA

PENSACOLA GENERAL AVIATION FACILITY (GAF)

IN COLLABORATION WITH:



BASKERVILLE-DONOVAN, INC.

449 W. MAIN ST. PENSACOLA, FLORIDA 32502 (850)438-9661 Engineering Business: EB-0000340 PROFESSIONAL SEAL

JASON J. FRICK P.E. FL Reg. Engineer #86469

REVISIONS

NO.	DESCRIPTION	DATE
		-
		1

DATE ISSUED: 03/03/2020 REVIEWED BY: MDL RGG DRAWN BY: **DESIGNED BY:** JJF PROJECT NUMBER:

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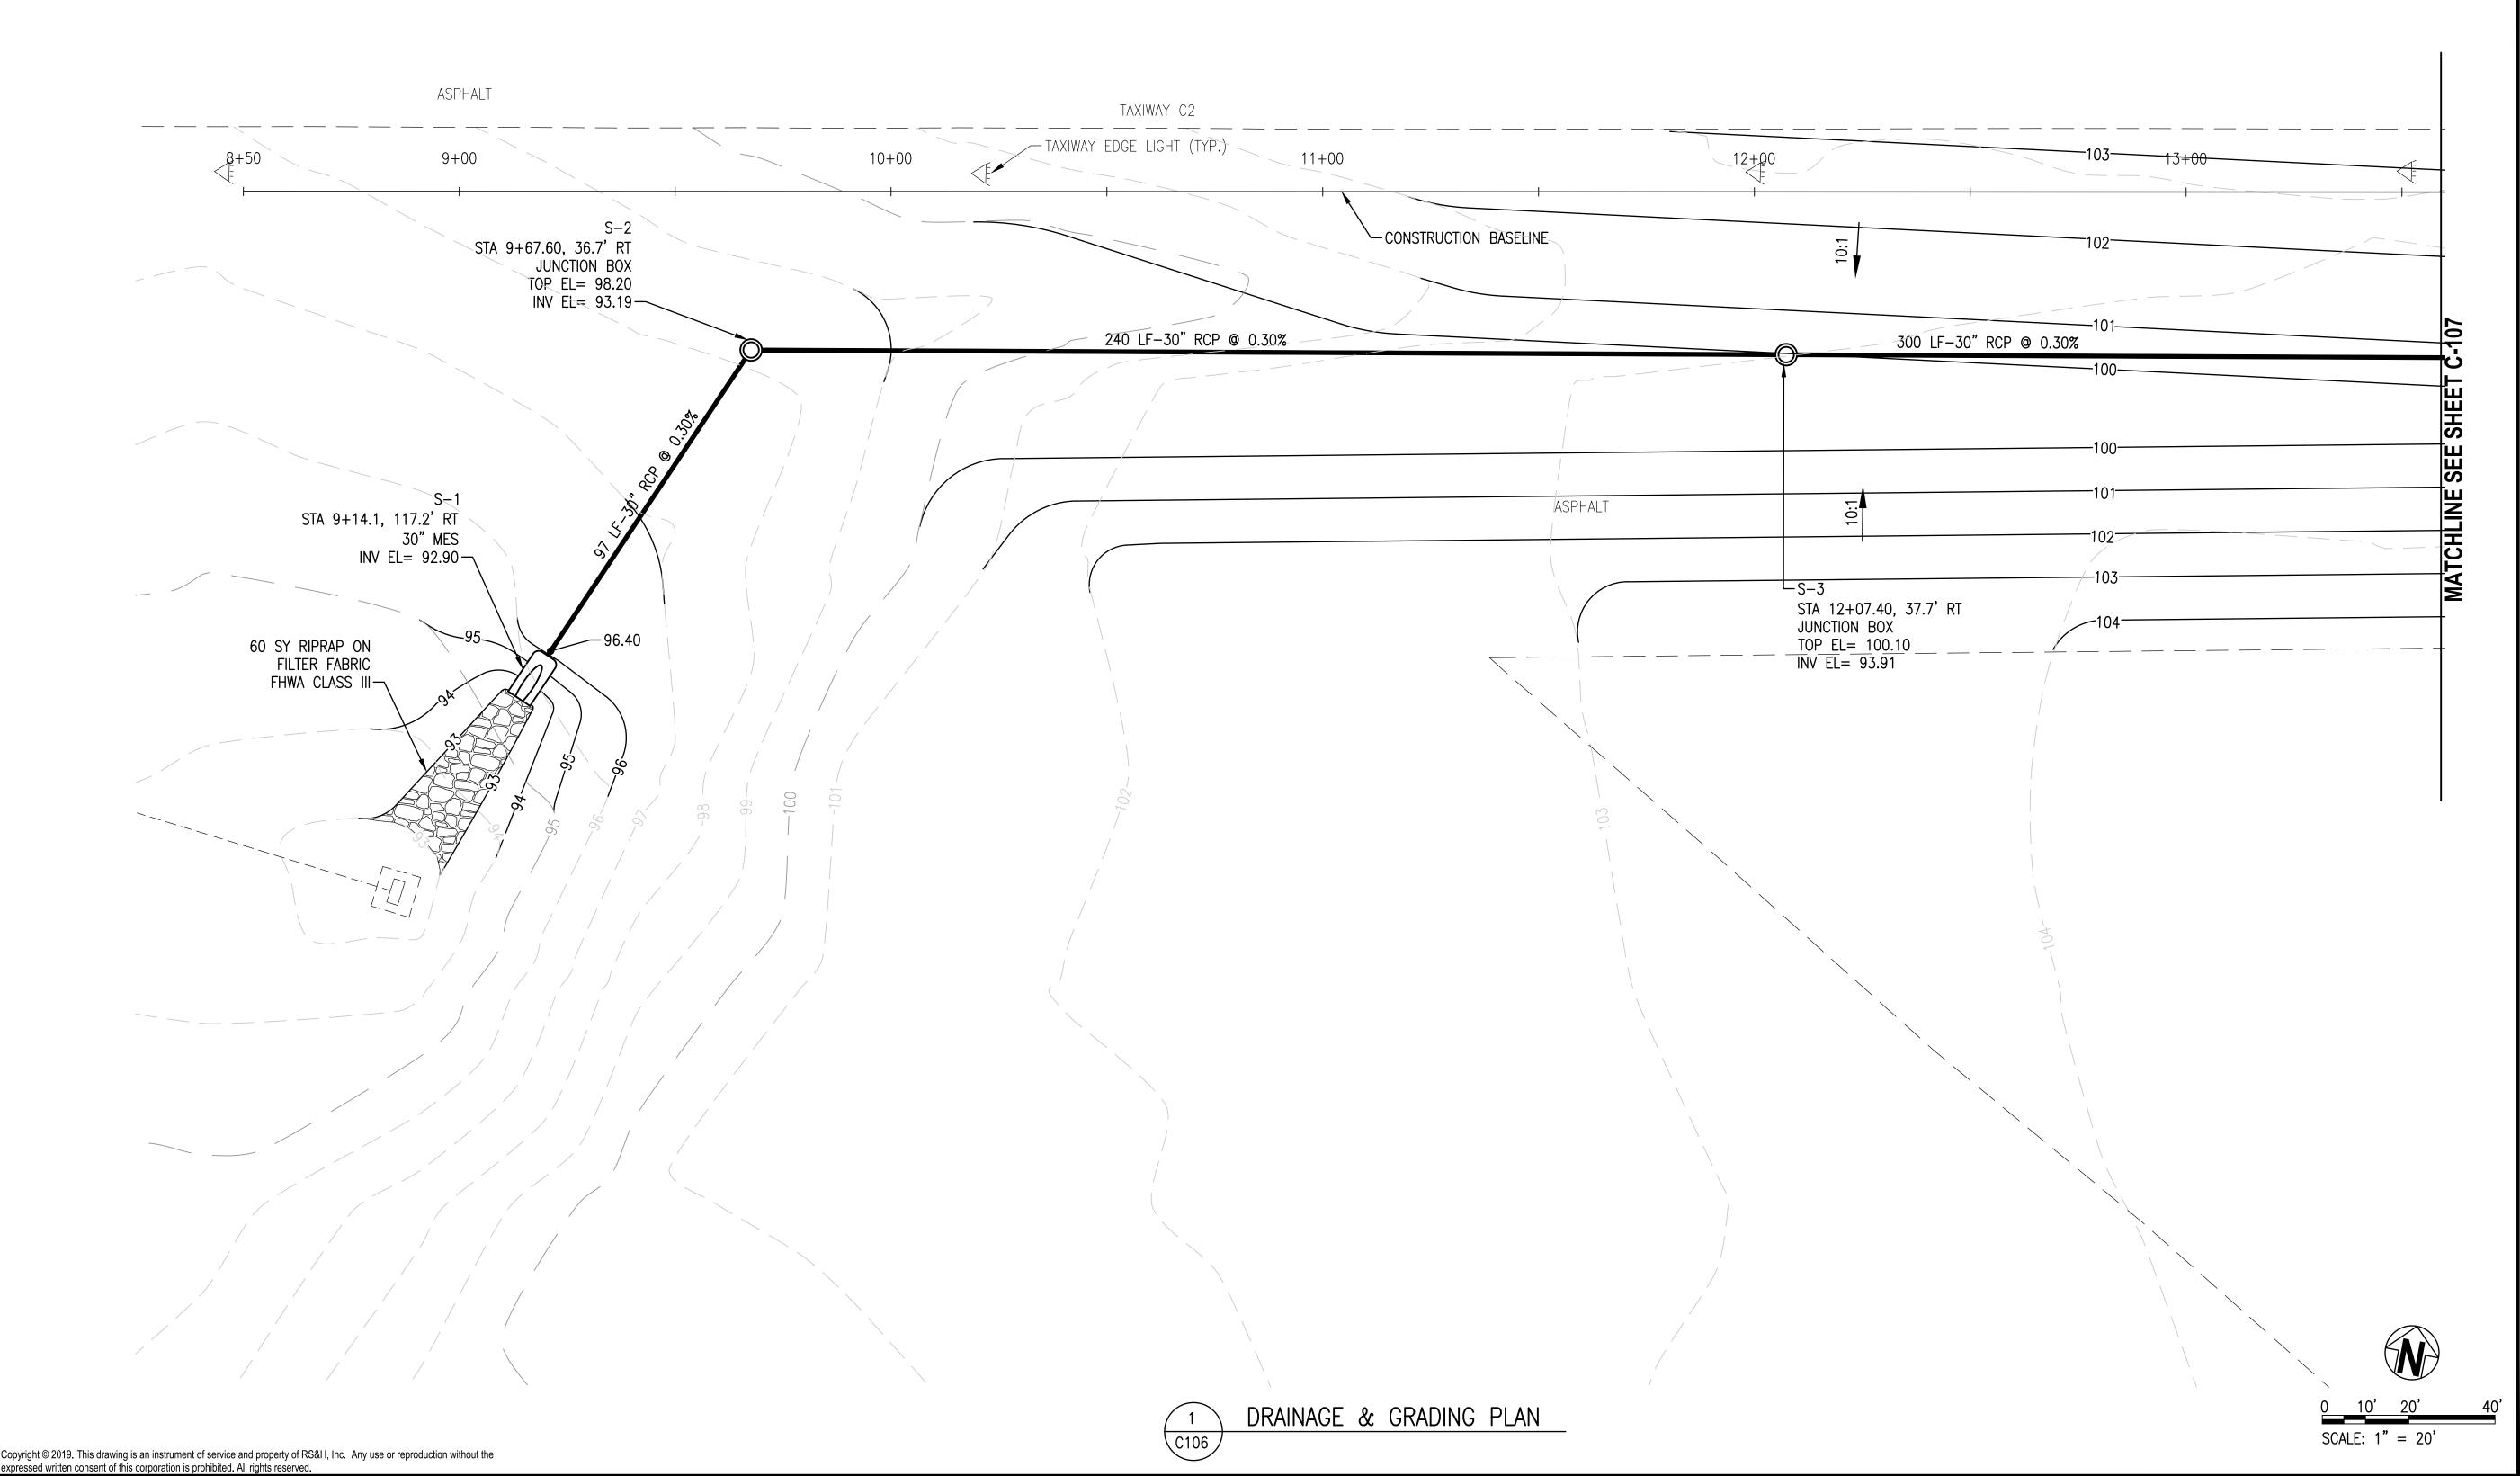
SHEET TITLE

STAKING PLAN

SHEET NUMBER

C105

1. STABILIZATION OF TAXIWAY DITCHES SHALL OCCUR IMMEDIATELY AFTER FINAL GRADE. THE CONTRACTOR SHOULD PHASE THESE EFFORTS TO MINIMIZE ANY UNSTABILIZED AREAS NEAR THE TAXIWAY.



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PENSACOLA, FLORIDA

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GENERAL
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FACILITY (GAF)

IN COLLABORATION WITH:



BASKERVILLE-DONOVAN, INC.

449 W. MAIN ST.
PENSACOLA, FLORIDA 32502
(850)438-9661
Engineering Business: EB-0000340
PROFESSIONAL SEAL

JASON J. FRICK P.E. FL Reg. Engineer #86469

REVISIONS

NO.	DESCRIPTION	DATE
		-
		-

DATE ISSUED: 03/03/202

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DRAWN BY: RGG

DESIGNED BY: JJF

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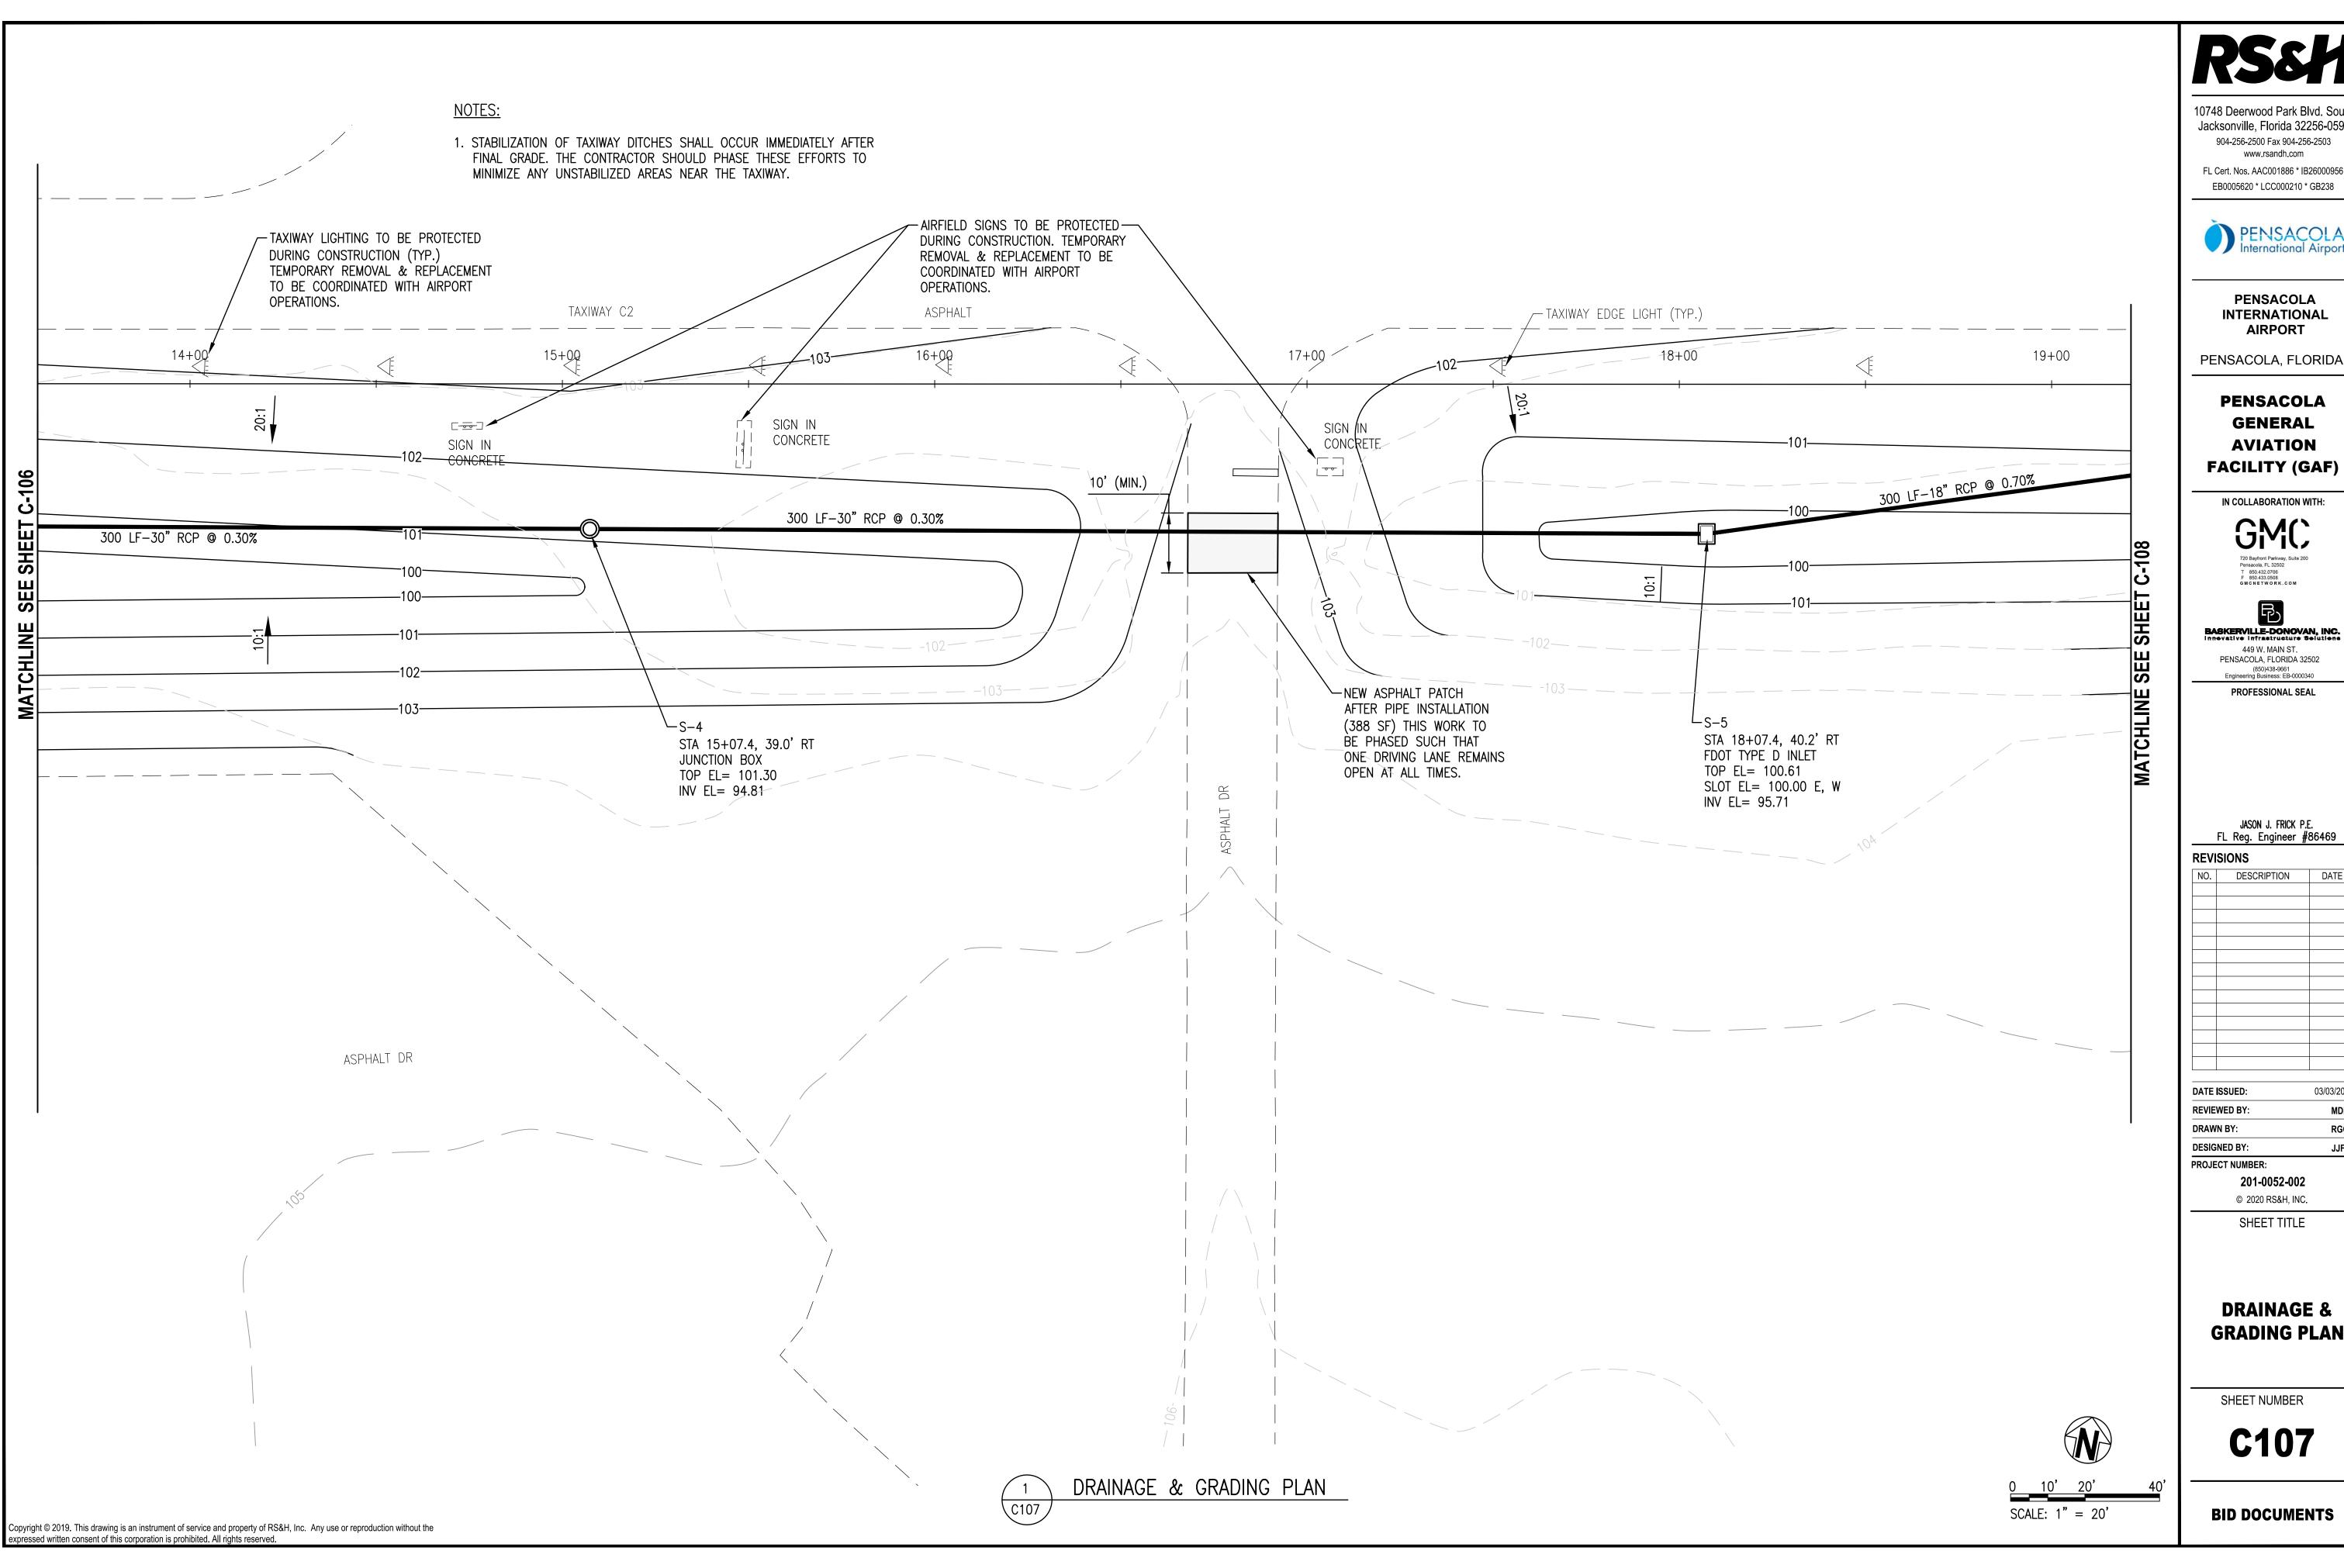
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SHEET TITLE

DRAINAGE & GRADING PLAN

SHEET NUMBER

C106



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PENSACOLA INTERNATIONAL AIRPORT

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BASKERVILLE-DONOVAN, INC.

449 W. MAIN ST. PENSACOLA, FLORIDA 32502 (850)438-9661 Engineering Business: EB-0000340 PROFESSIONAL SEAL

JASON J. FRICK P.E. FL Reg. Engineer #86469


NO.	DESCRIPTION	DATE

201-0052-002

SHEET TITLE

DRAINAGE & GRADING PLAN

C107

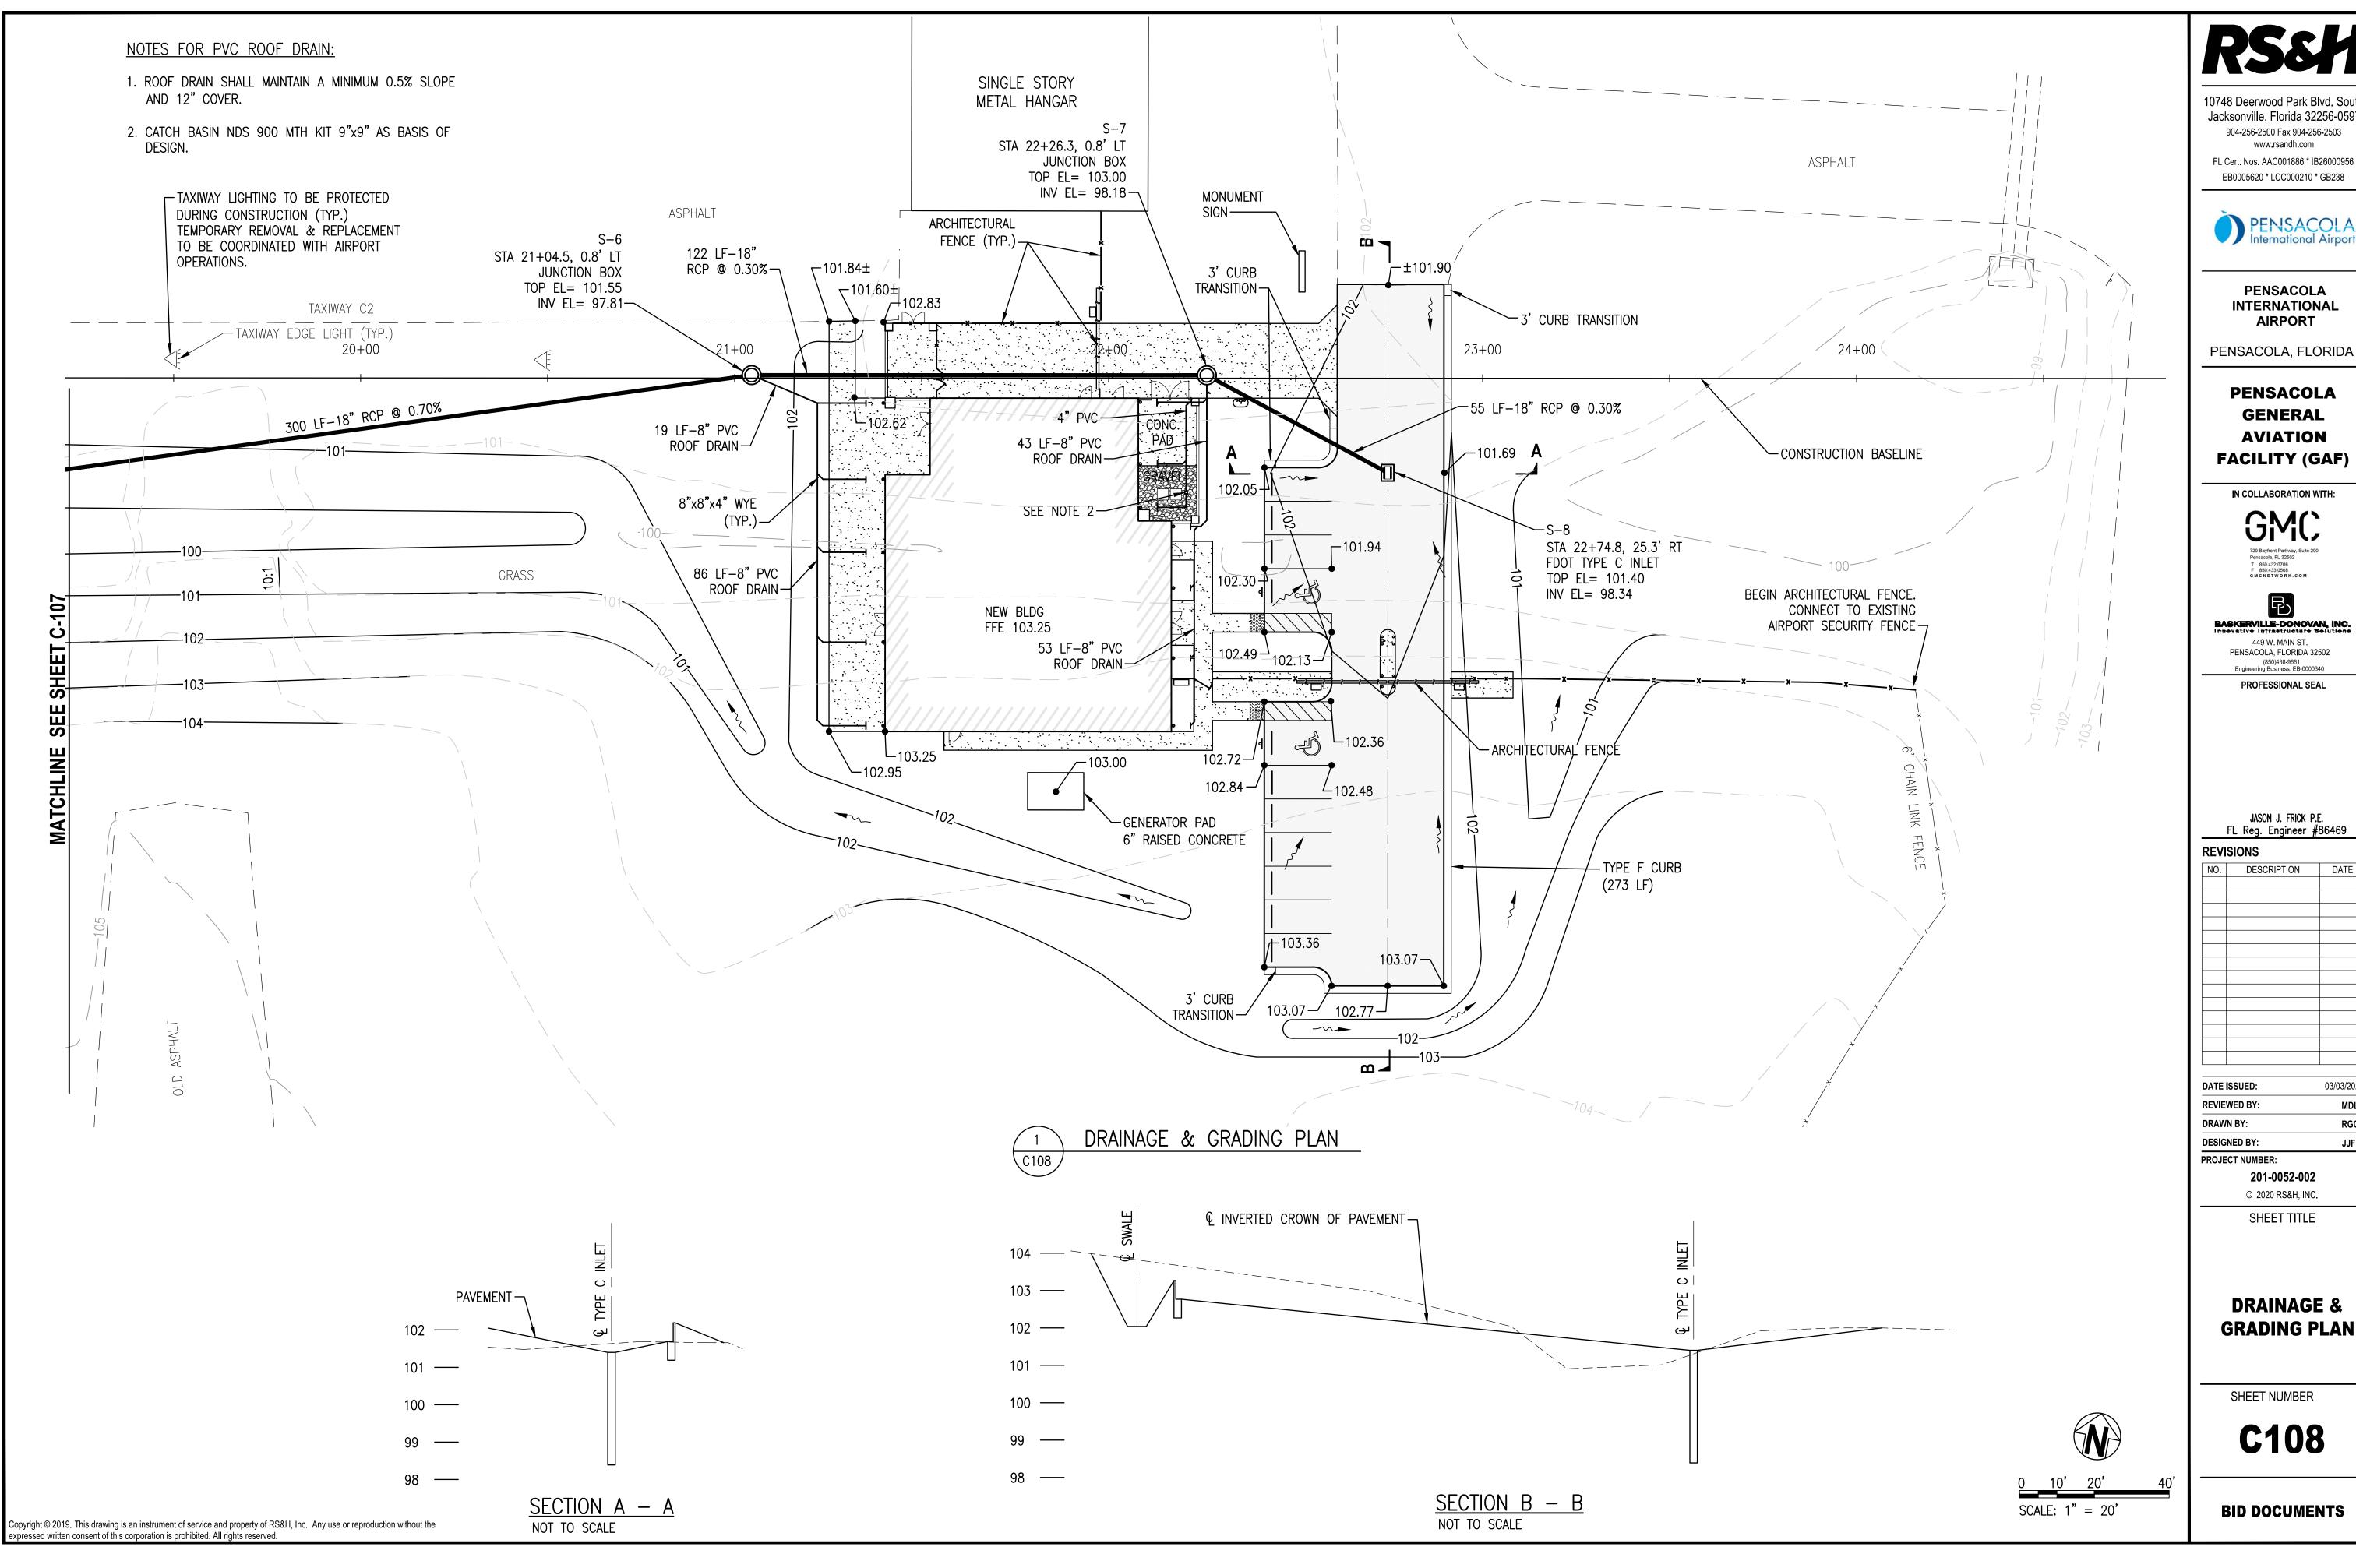

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PENSACOLA INTERNATIONAL

PENSACOLA GENERAL AVIATION FACILITY (GAF)


BASKERVILLE-DONOVAN, INC.

PENSACOLA, FLORIDA 32502 (850)438-9661 Engineering Business: EB-0000340

JASON J. FRICK P.E. FL Reg. Engineer #86469

RGG JJF

GRADING PLAN

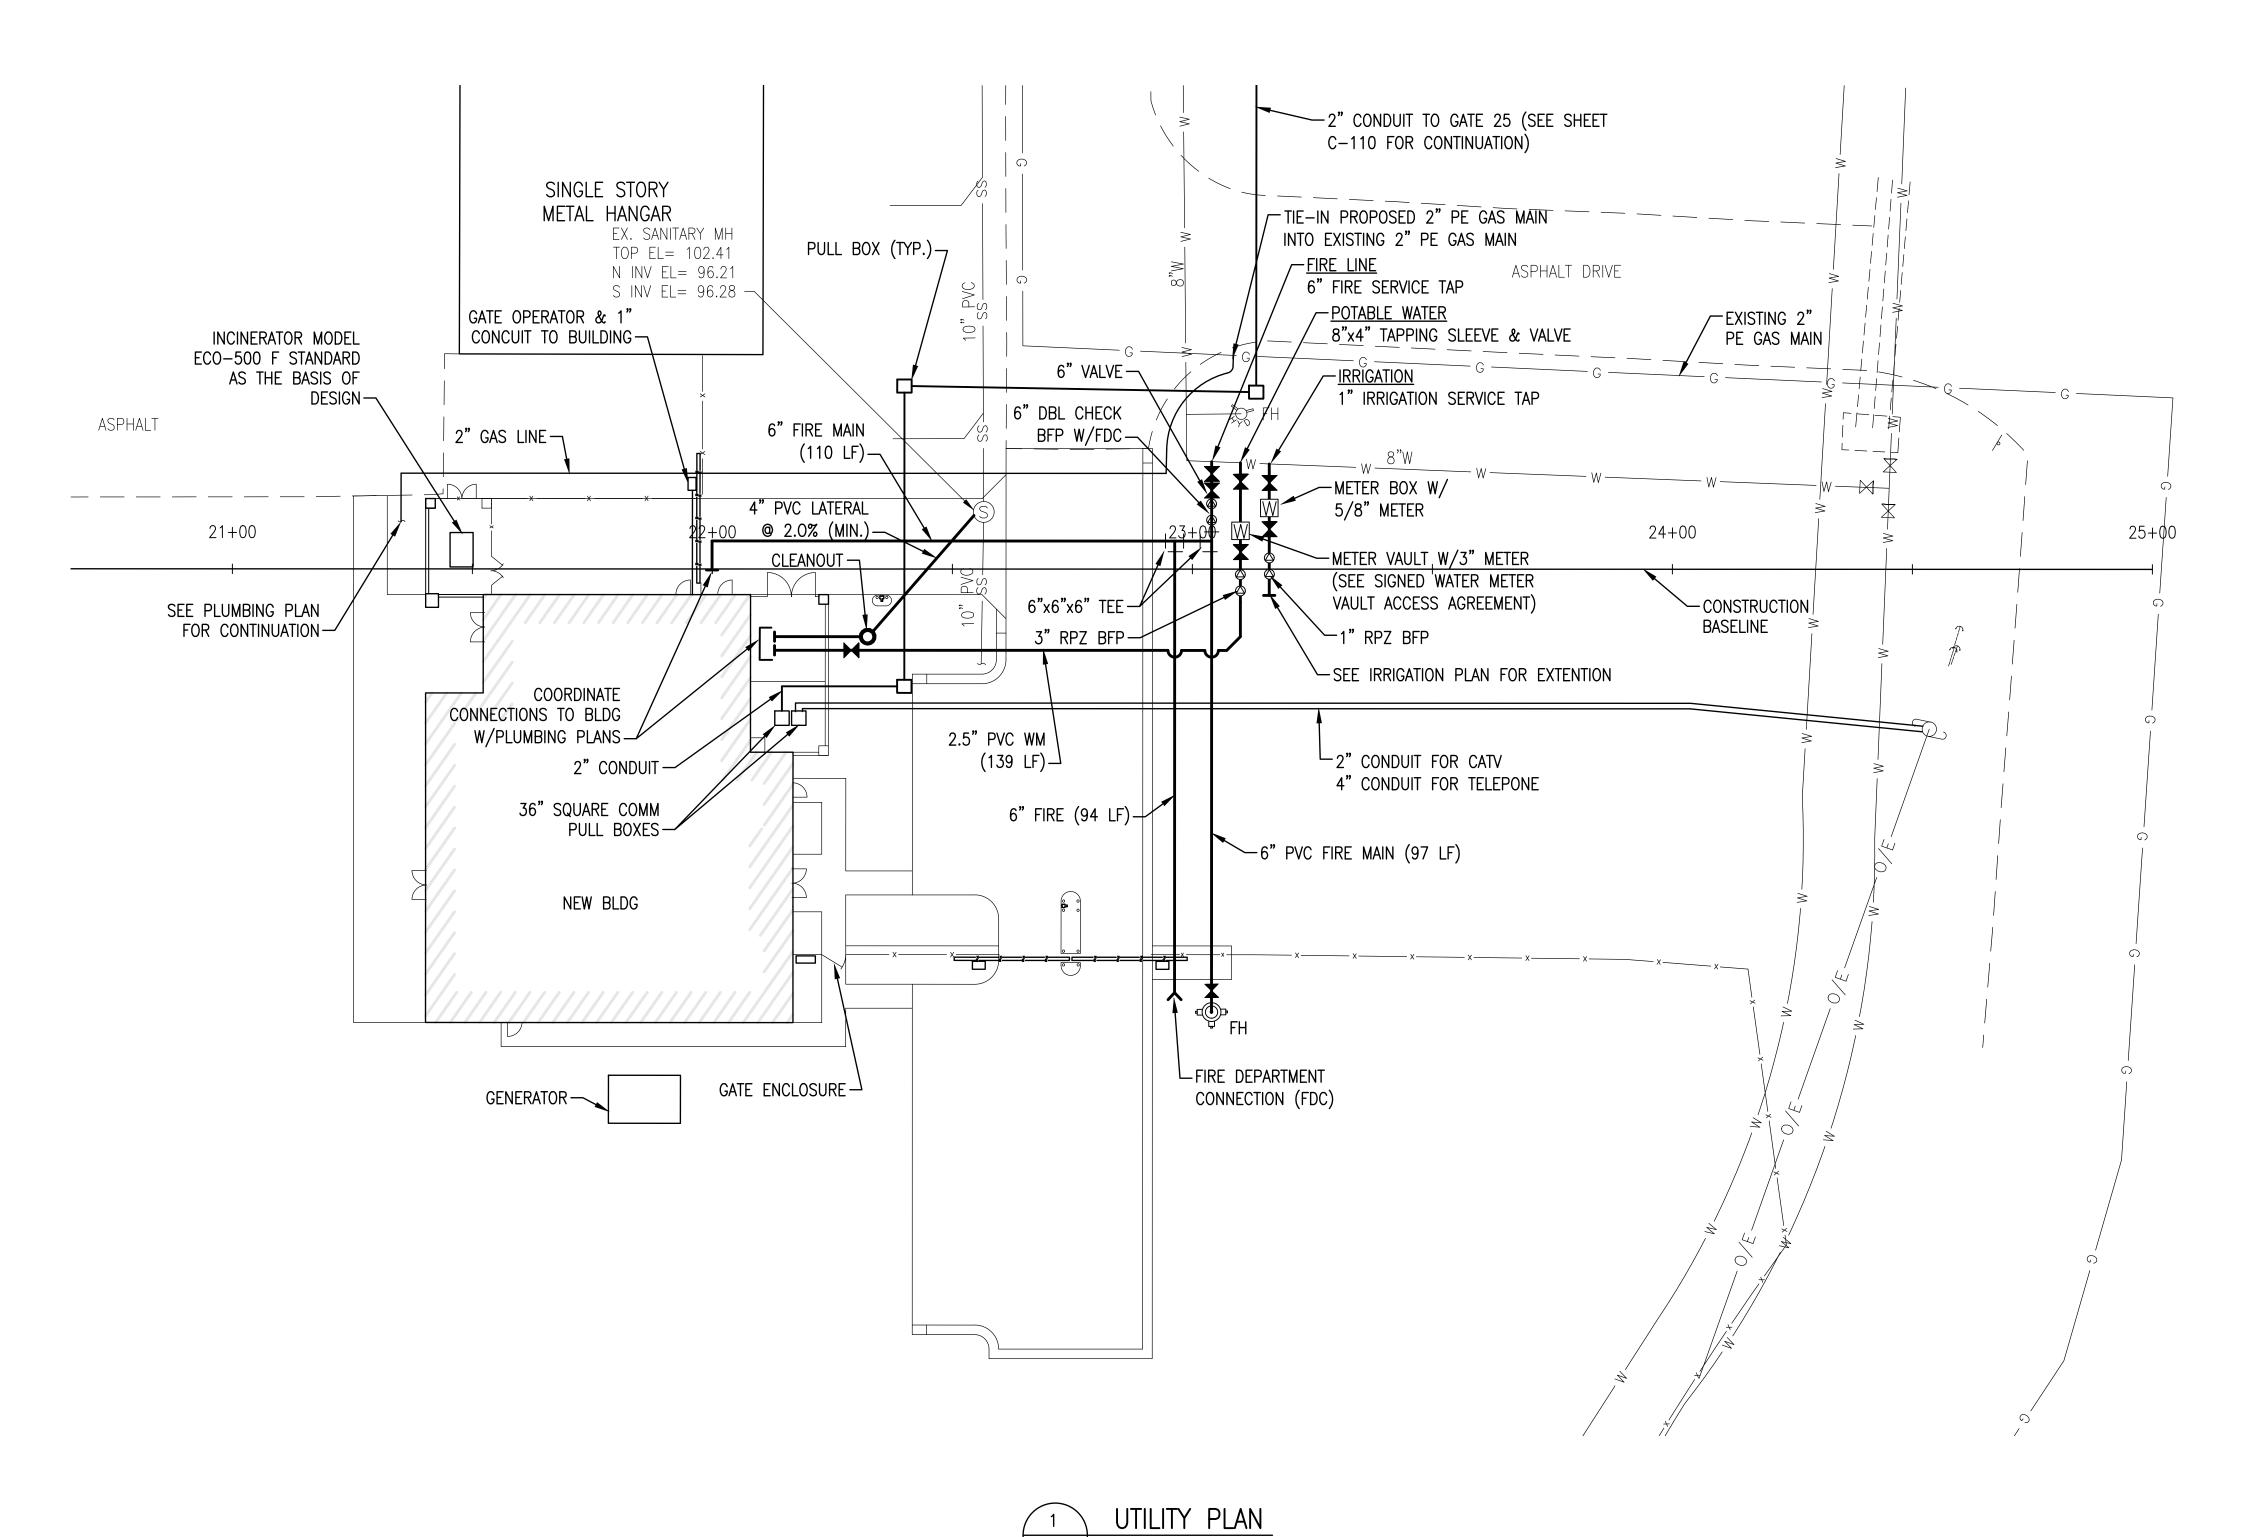



NOTES:

- CONTRACTOR SHALL BE RESPONSIBLE FOR TESTING OF BACKFLOW ASSEMBLY IN ACCORDANCE WITH ECUA AND MANUFACTURERS SPECIFICATIONS.
- 2. COORDINATE IRRIGATION TERMINATION WITH THE LANDSCAPE ARCHITECT.
- 3. THE CONTRACTOR SHALL COORDINATE SERVICE CONNECTIONS TO THE PROPOSED BUILDING WITH THE PLUMBING PLAN.
- 4. BACKFLOW DEVICES SHALL BE FREEZE PROTECTED.
- 5. COORDINATE INSTALLATION AND CONNECTION OF THE INCINERATOR WITH THE PLUMBING PLANS.
- 6. FINAL NATURAL GAS CONNECTION CORRIDOR TO BE DETERMINED BY THE UTILITY PROVIDER AT COMMENCEMENT OF CONSTRUCTION.

RS&H

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PENSACOLA, FLORIDA

PENSACOLA
GENERAL
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IN COLLABORATION WITH:



BASKERVILLE-DONOVAN, INC.

449 W. MAIN ST.
PENSACOLA, FLORIDA 32502
(850)438-9661
Engineering Business: EB-0000340

PROFESSIONAL SEAL

JASON J. FRICK P.E. FL Reg. Engineer #86469

REVISIONS

NO.	DESCRIPTION	DATE
	·	

DATE ISSUED: 03/03/2020
REVIEWED BY: MDL
DRAWN BY: RGG
DESIGNED BY: JJF

PROJECT NUMBER: 201-0052-002
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SHEET TITLE


UTILITY PLAN

SHEET NUMBER

C109

BID DOCUMENTS

0 10' 20' SCALE: 1" = 20'

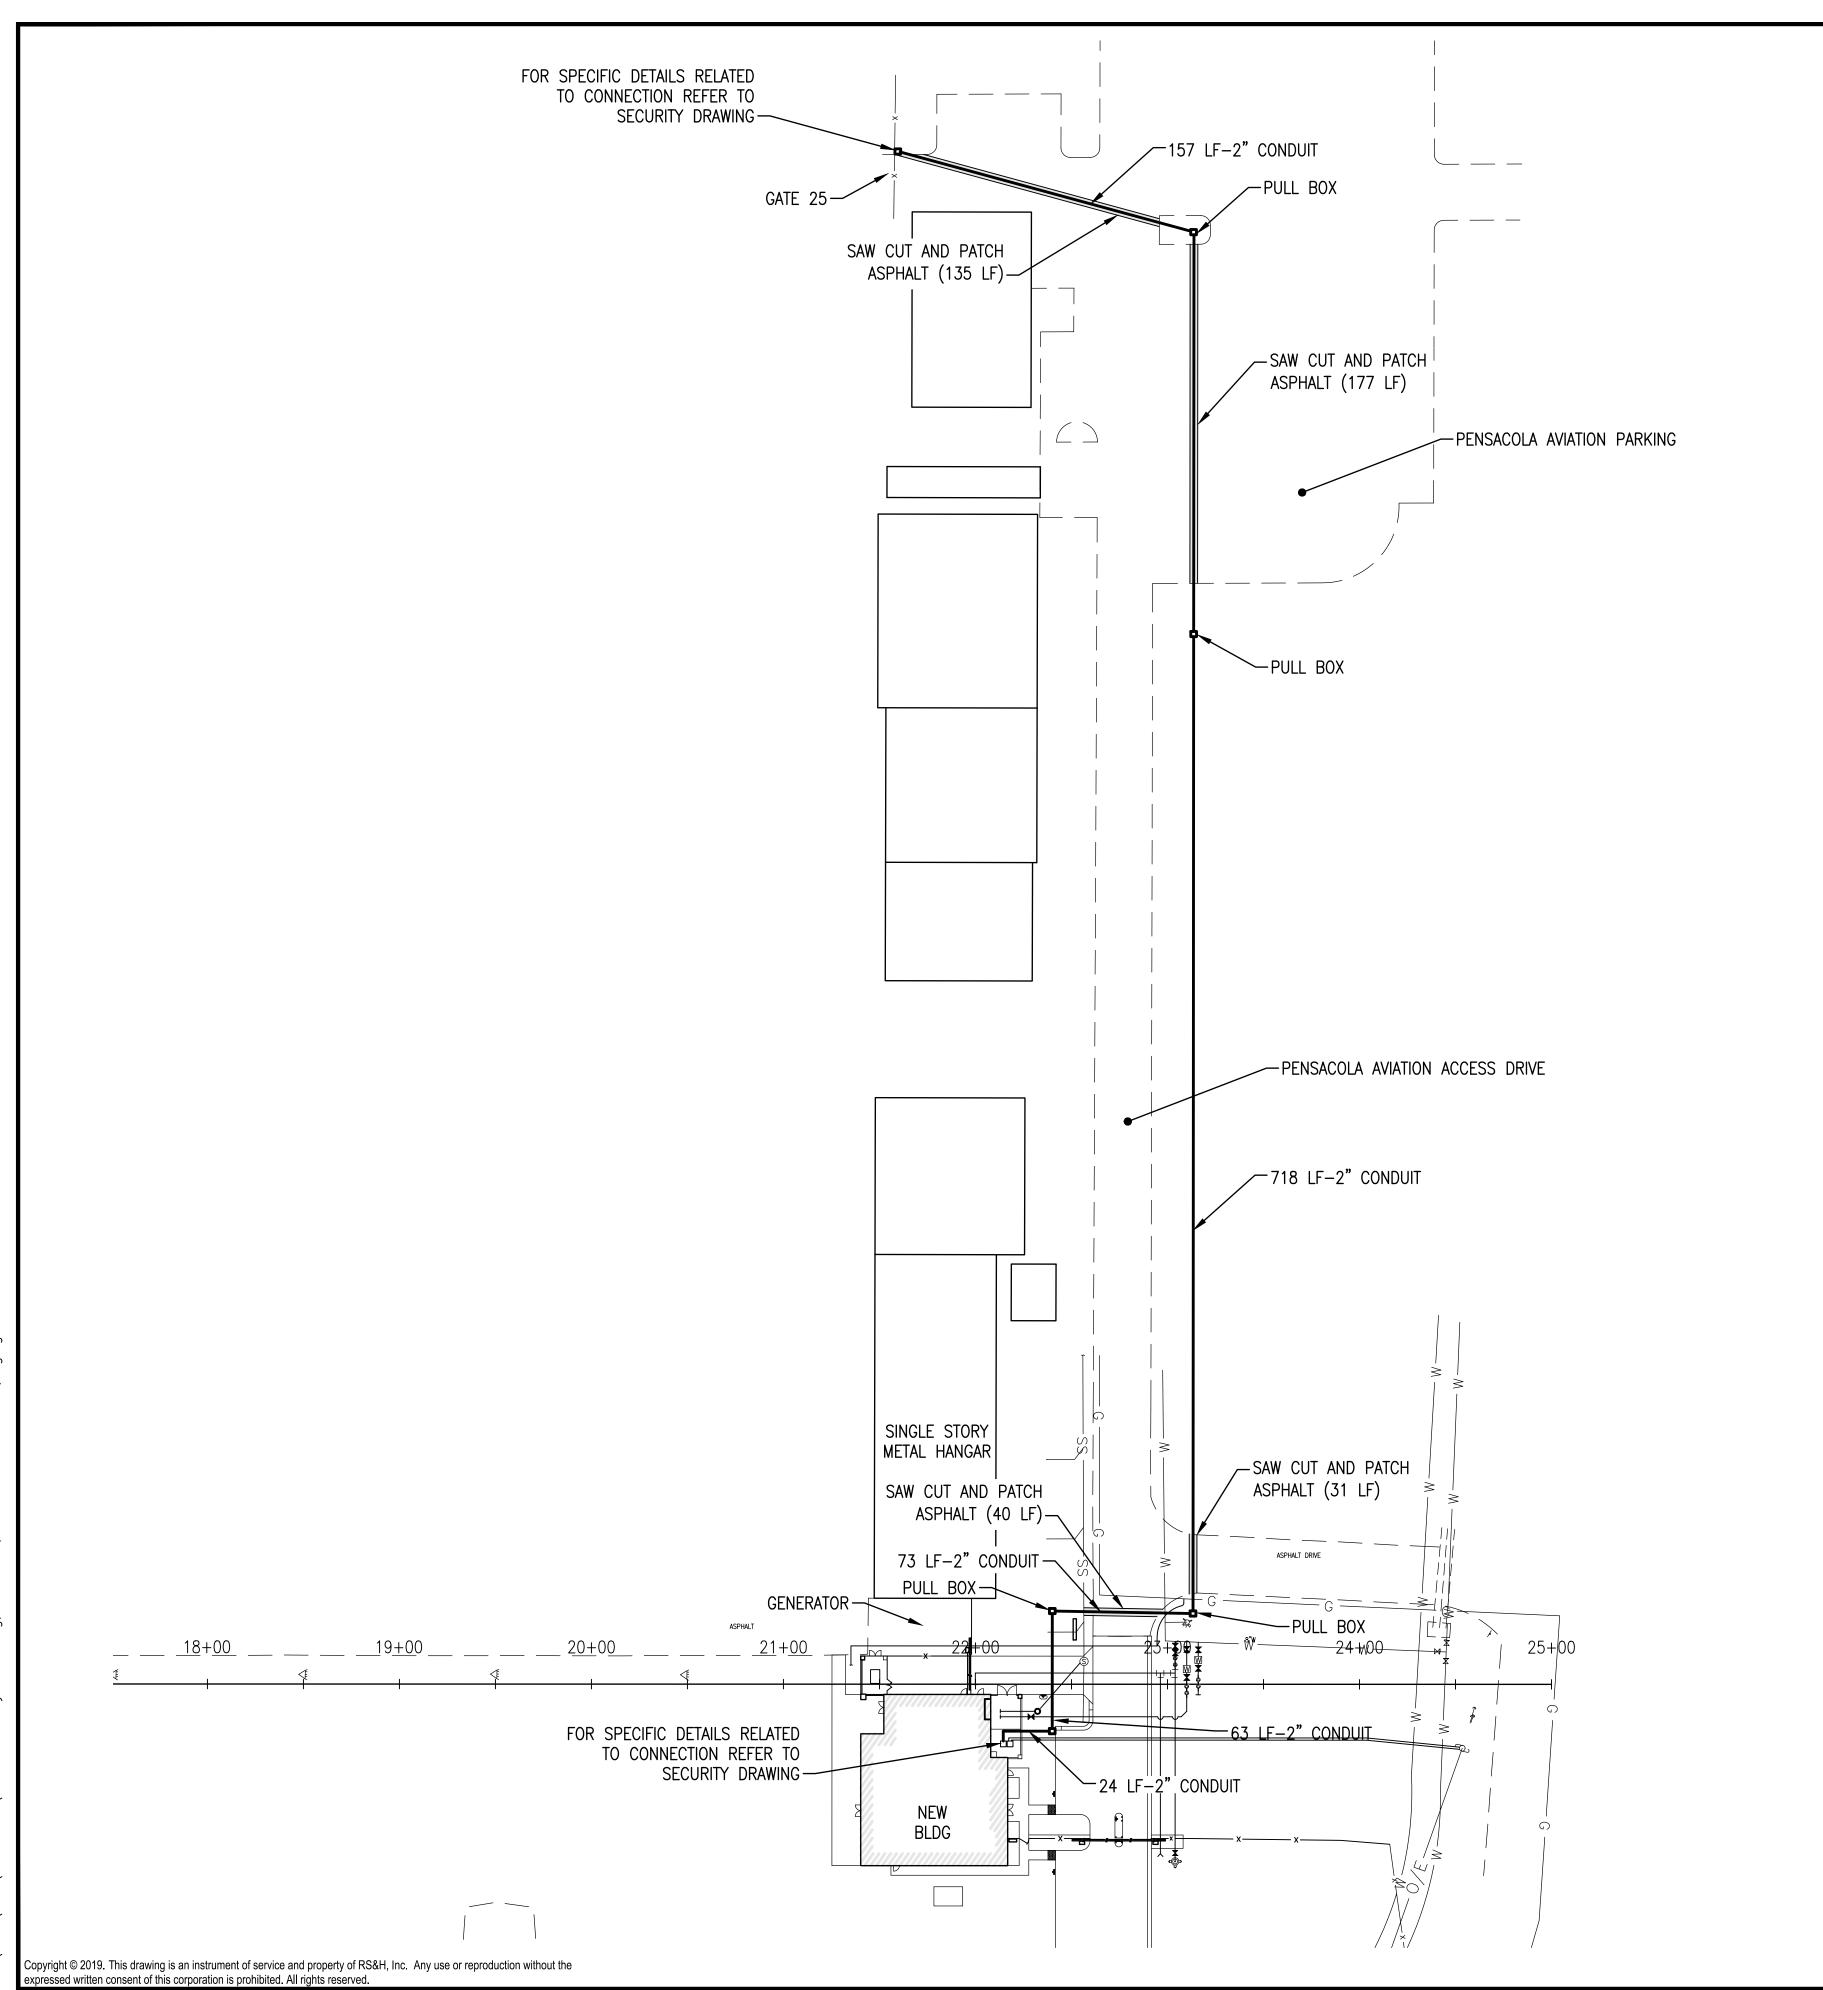



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SECURITY COORDINATION

SHEET NUMBER

C110

BID DOCUMENTS

0 25' 50' SCALE: 1" = 50'

\21805.01\C110 SecurityCoord.dwg, Mar 03, 202C

PLAN PLAN

NOTES:

PHOTOGRAPHY.


1. THIS DRAWING IS NOT TO SCALE TAKEN FROM AERIAL

2. CONTRACTOR TO LOCATE ALL UTILITIES ALONG THE PROPOSED CORRIDOR.


3. CONTRACTOR TO COORDINATE THE MAINTENANCE OF TRAFFIC FOR THE CONDUIT INSTALLATION WITH THE

4. STABILIZE ALL DISTURBED AREAS WITH SOD.


PENSACOLA AVIATION CENTER.

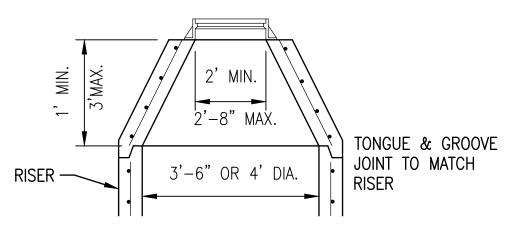

PRECAST CONCENTRIC CONE

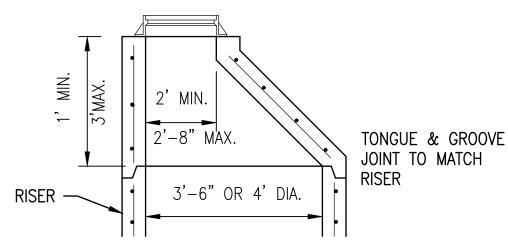


PRECAST ECCENTRIC CONE

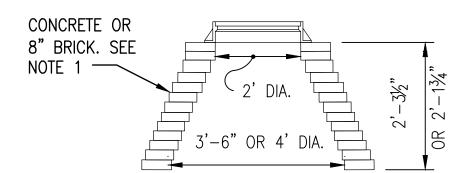

BRICK OR CONCRETE TYPE 8 MANHOLES


- MANHOLE TOP TYPE 8 MAY BE OF CAST-IN-PLACE OR PRECAST CONCRETE CONSTRUCTION OR BRICK CONSTRUCTION. FOR CONCRETE CONSTRUCTION, THE CONCRETE AND STEEL REINFORCEMENT SHALL BE THE SAME AS THE SUPPORTING WALL UNIT. AN ECCENTRIC CONE MAY
- 2. MANHOLE TOPS SHALL BE SECURED TO STRUCTURES BY OPTIONAL CONSTRUCTION JOINTS AS SHOWN.


MANHOLE TOPS NOT TO SCALE

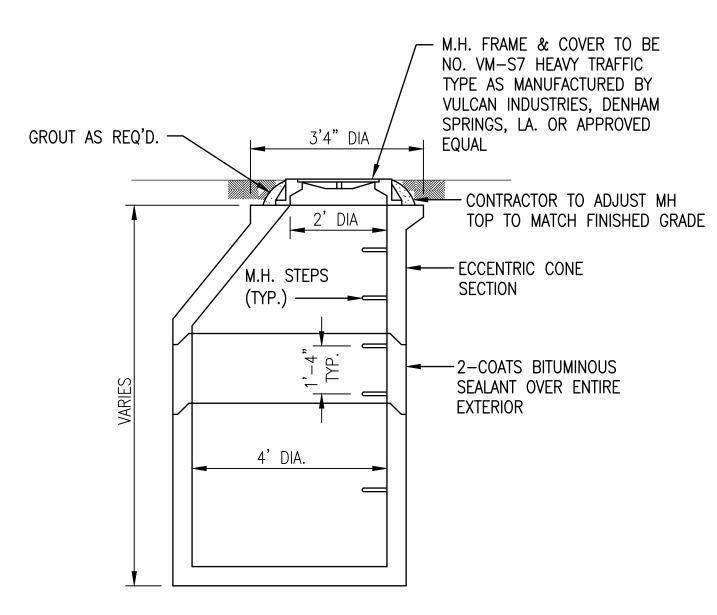



JUNCTION BOX NOT TO SCALE


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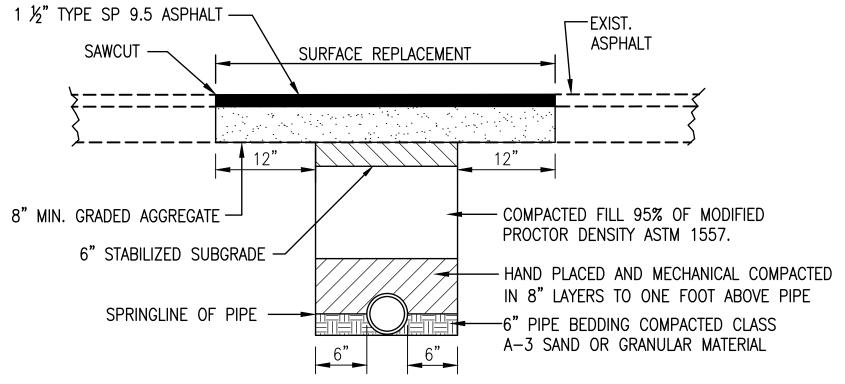


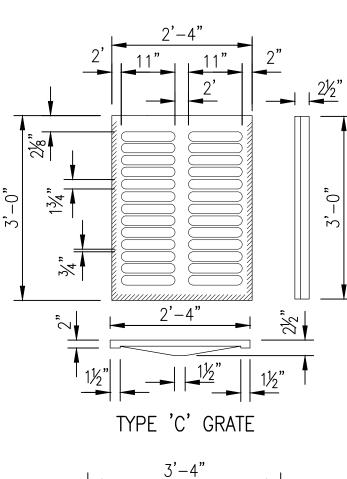

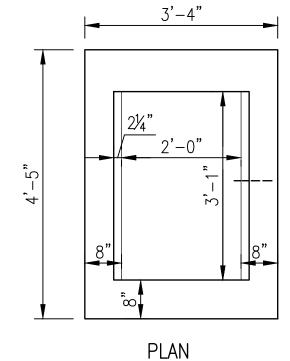

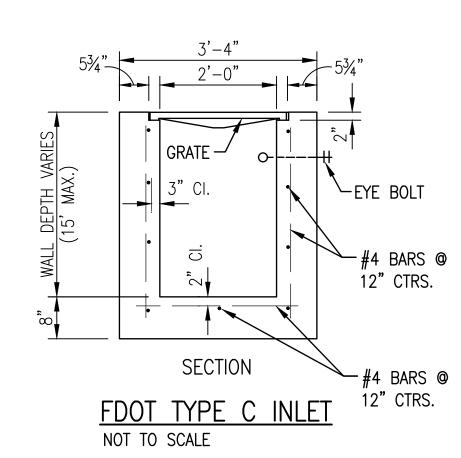


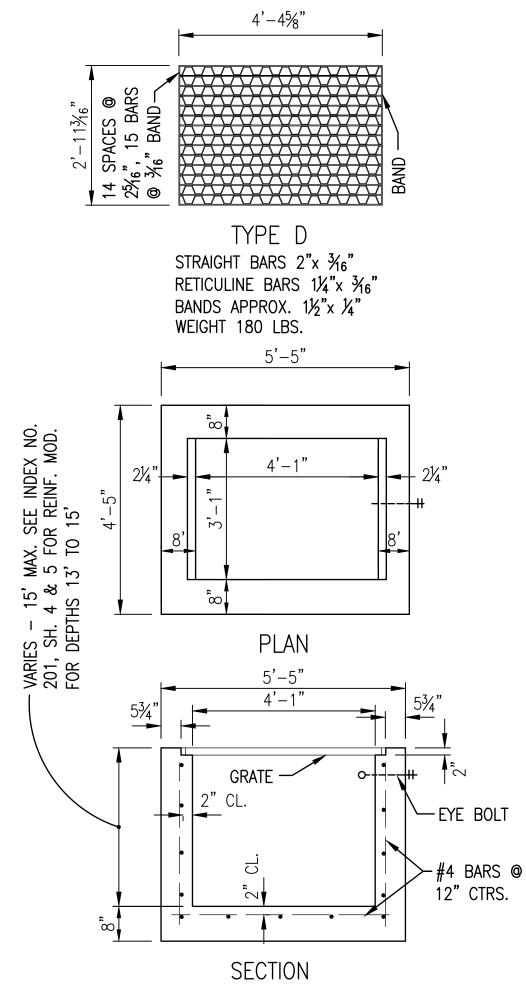

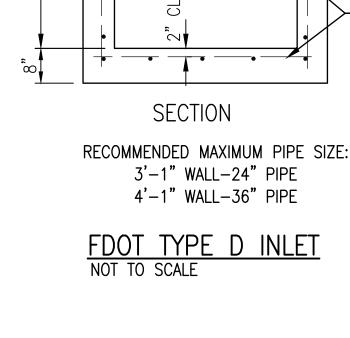


GRADED AGGREGATE BASE LAYER SHALL BE COMPACTED TO 100% MODIFIED PROCTOR DENSITY AASHTO T-180. BACKFILL BELOW BASE LAYER WILL BE PLACED IN MAXIMUM 8-INCH THICK LOOSE LIFTS.

LATERAL PAVEMENT PATCH DETAIL NOT TO SCALE

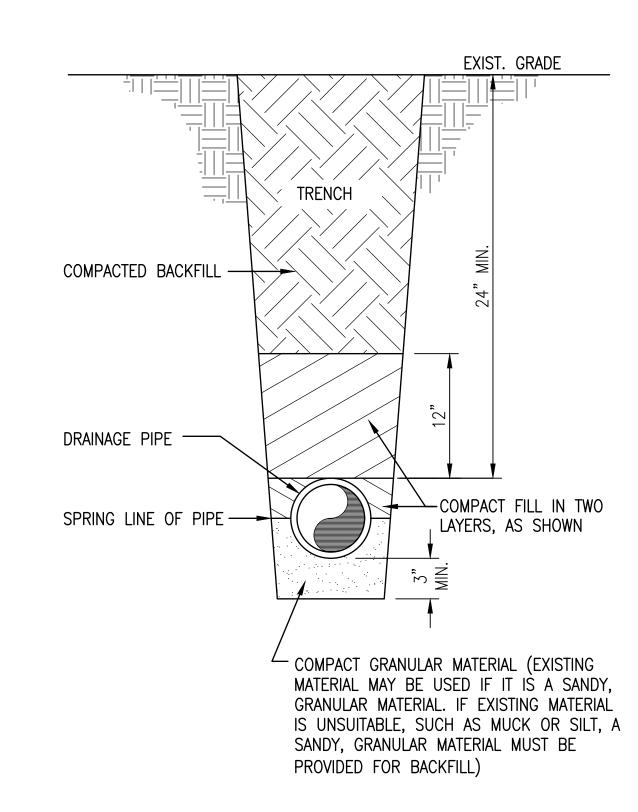


TYPICAL DRAINAGE PIPE BEDDING NOT TO SCALE

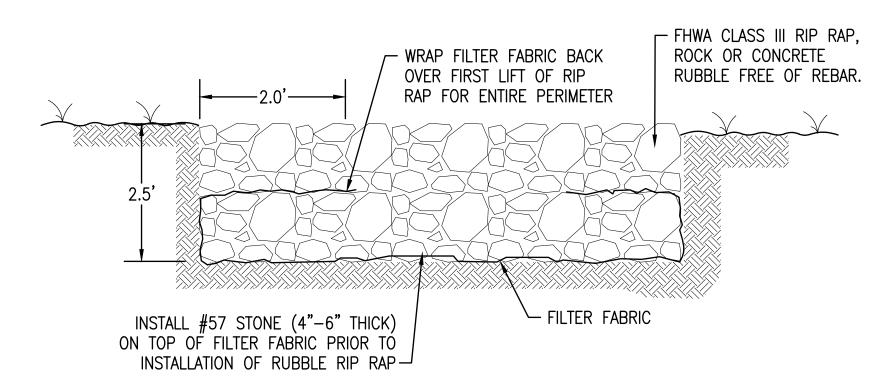

SEE PLANS FOR TOTAL AREA OF RIP RAP PLACEMENT

RIP RAP DETAIL NOT TO SCALE

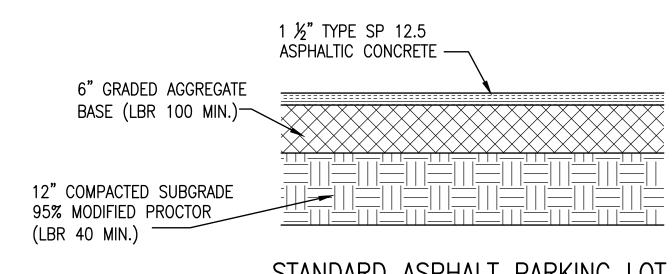

STANDARD ASPHALT PARKING LOT PAVEMENT SECTION NOT TO SCALE

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PENSACOLA, FLORIDA

PENSACOLA GENERAL AVIATION FACILITY (GAF)

IN COLLABORATION WITH:



BASKERVILLE-DONOVAN, INC. 449 W. MAIN ST. PENSACOLA, FLORIDA 32502

(850)438-9661 Engineering Business: EB-0000340 PROFESSIONAL SEAL

JASON J. FRICK P.E. FL Reg. Engineer #86469

REVISIONS DESCRIPTION DATE

DATE ISSUED: 03/03/2020


REVIEWED BY: MDL DRAWN BY: RGG **DESIGNED BY:** JJF PROJECT NUMBER: 201-0052-002


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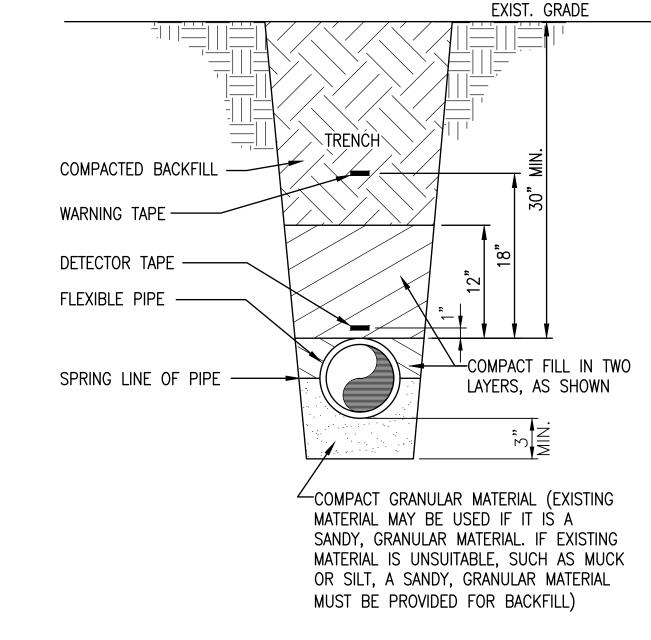
DETAILS

SHEET NUMBER

C900



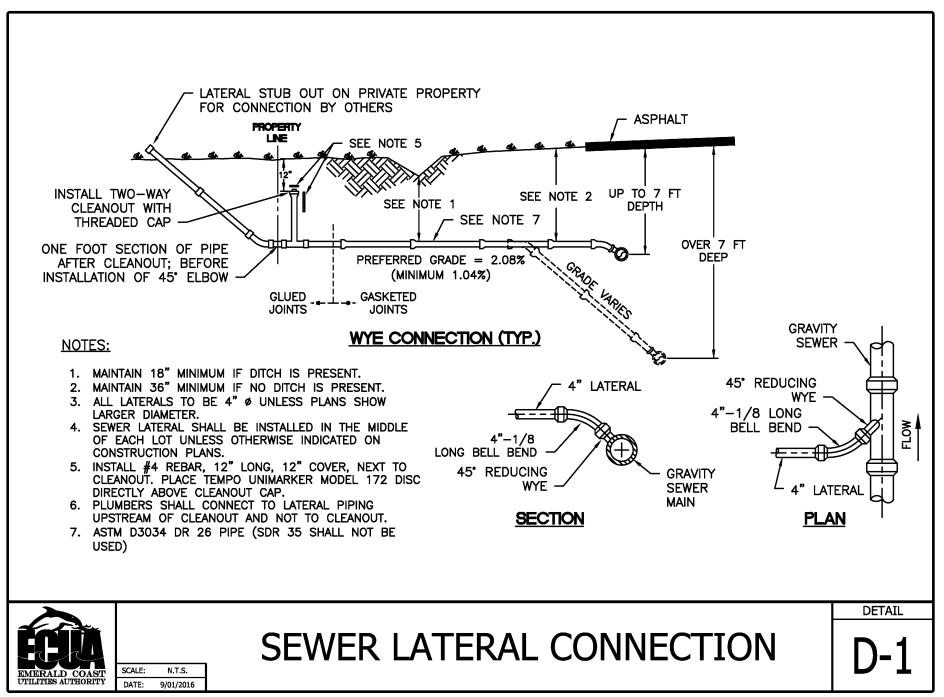

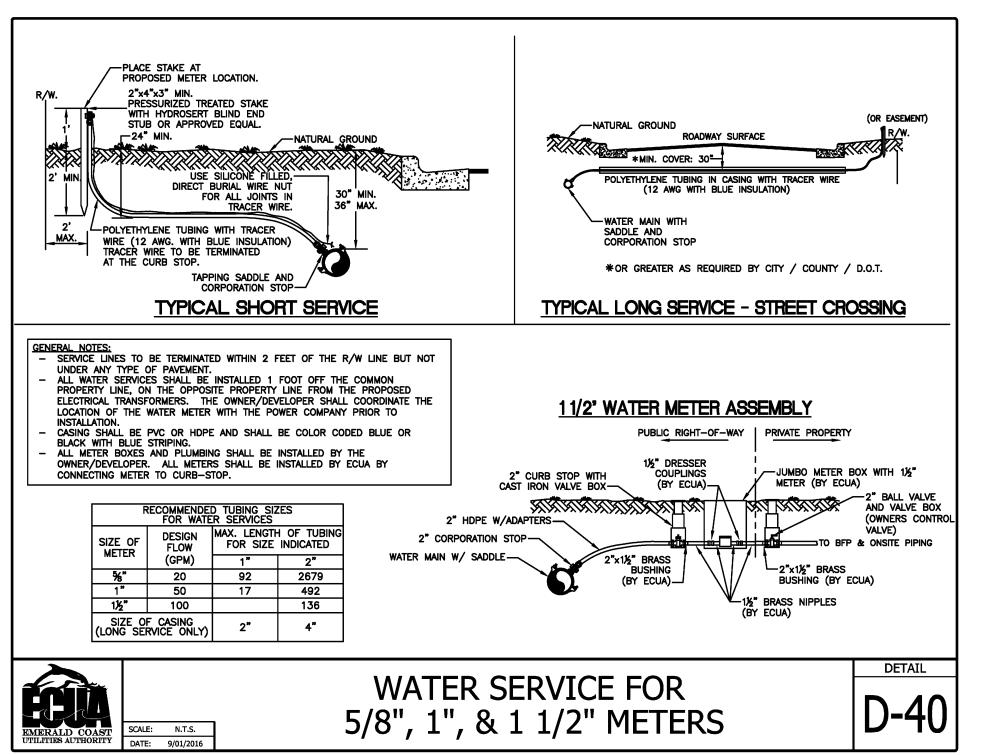

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TYPICAL UTILITY PIPE BEDDING



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IN COLLABORATION WITH:

720 Bayfront Parkway, Suite 200 Pensacola, FL 32502 T 850.432.0706 F 850.433.0508 GMCNETWORK.COM

BASKERVILLE-DONOVAN, INC.

449 W MAIN ST PENSACOLA, FLORIDA 32502 (850)438-9661 Engineering Business: EB-0000340 **PROFESSIONAL SEAL**

JASON J. FRICK P.E. FL Reg. Engineer #86469

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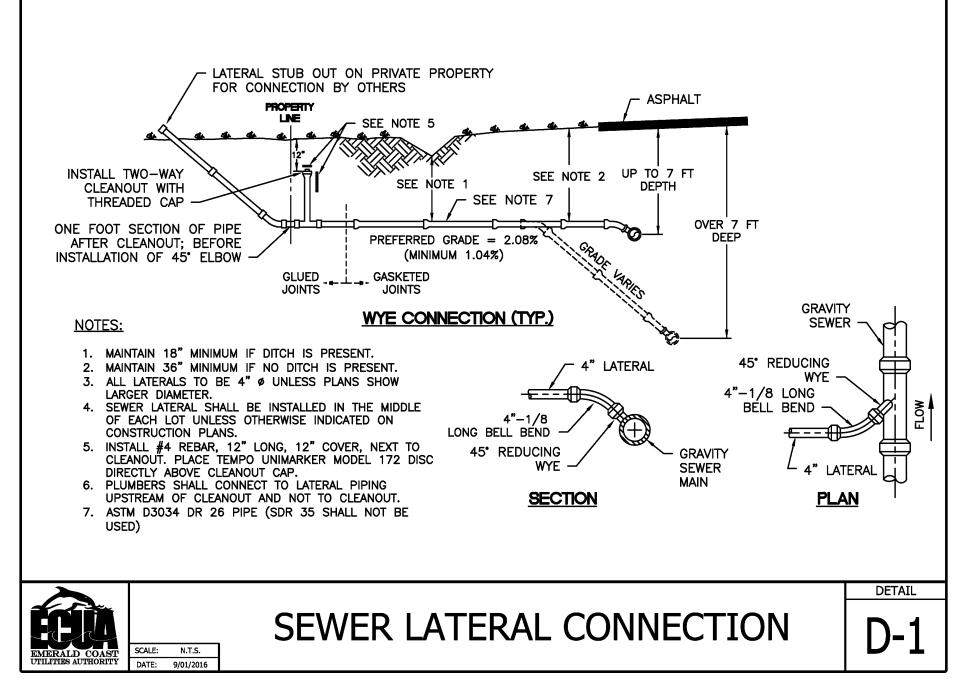
SHEET TITLE

DETAILS


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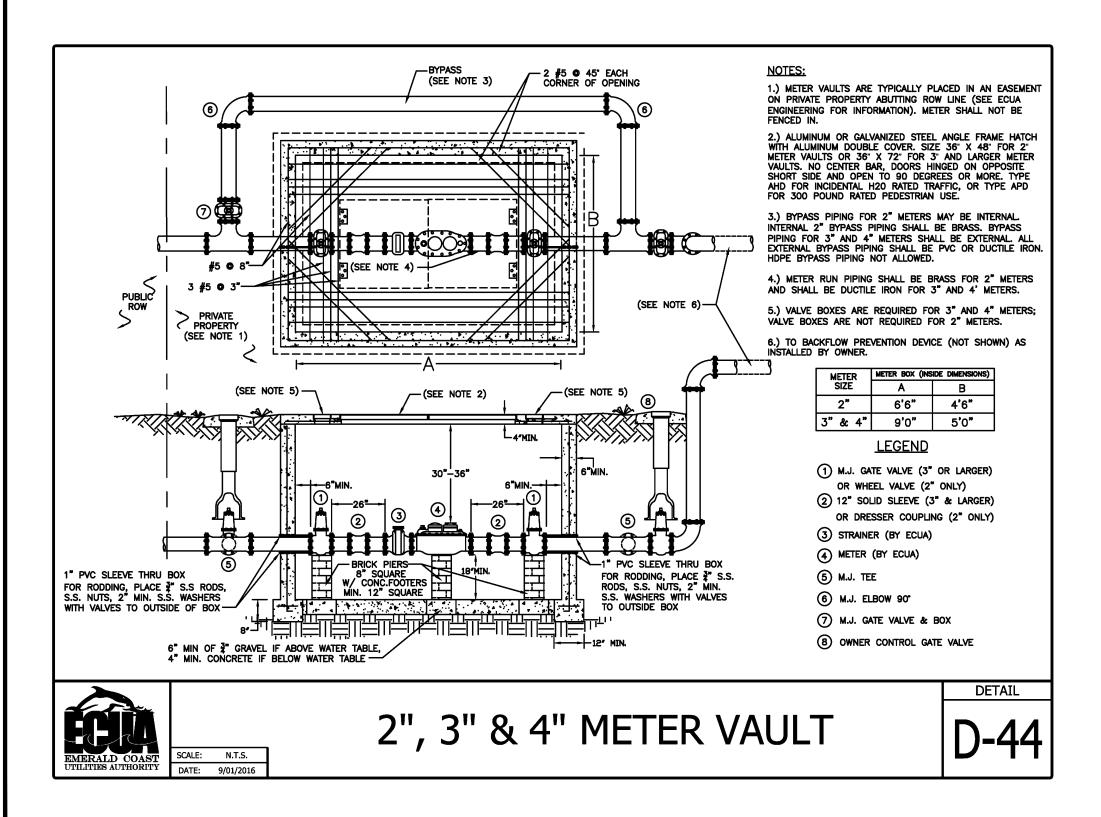
C901


BID DOCUMENTS




1. 2" METER VAULT TO BE CONNECTED USING THE APPROPRIATE APPURTENANCES.




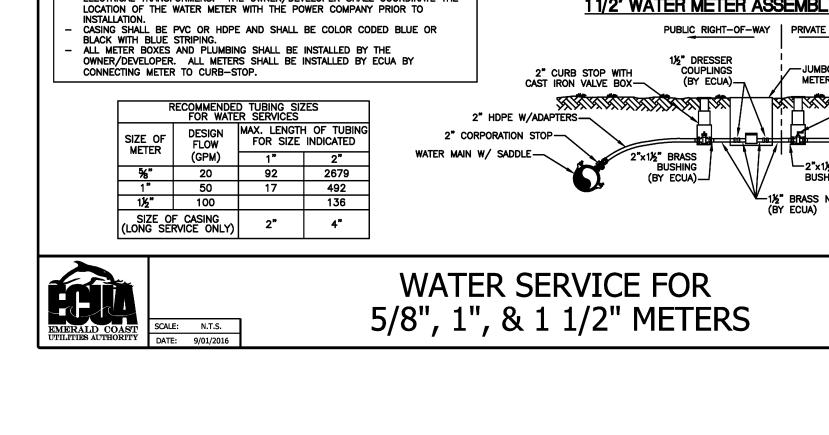


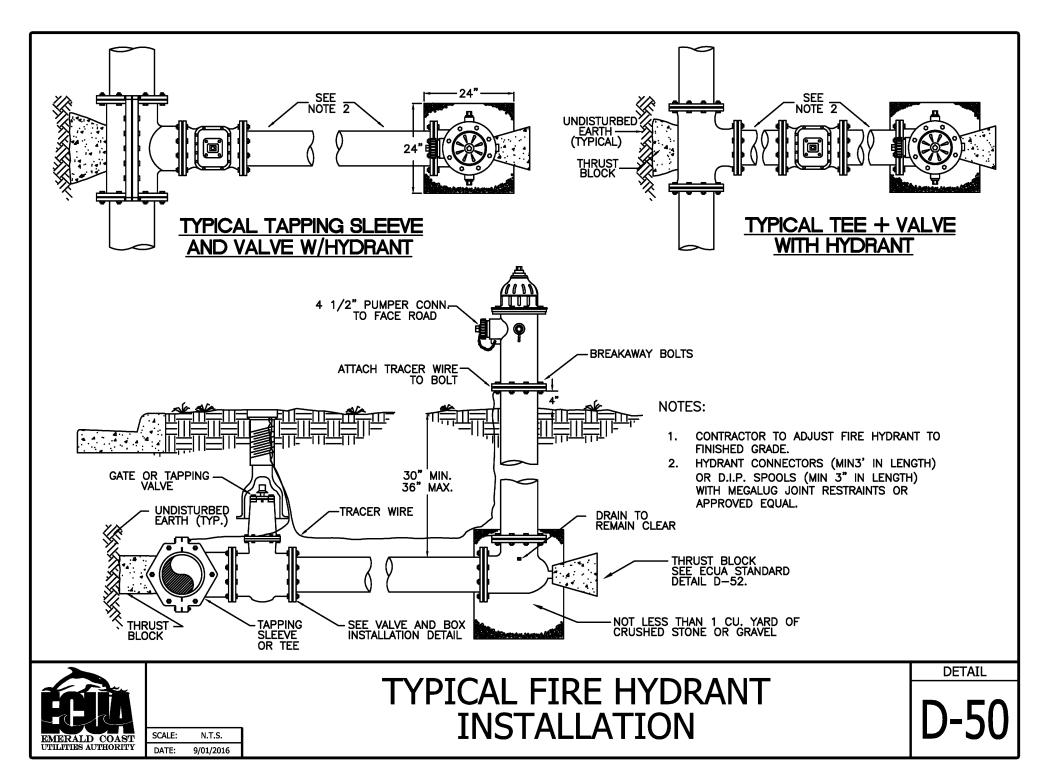

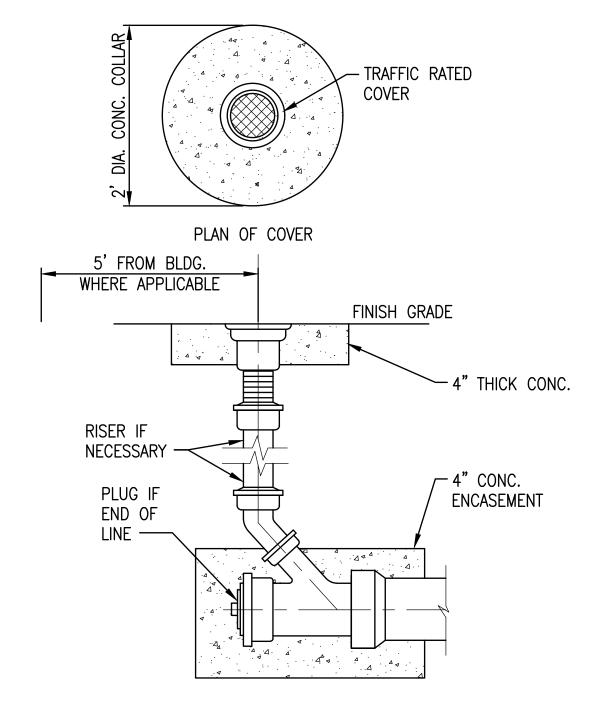

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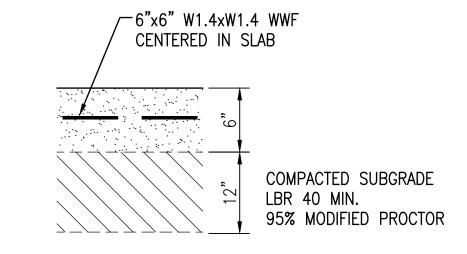


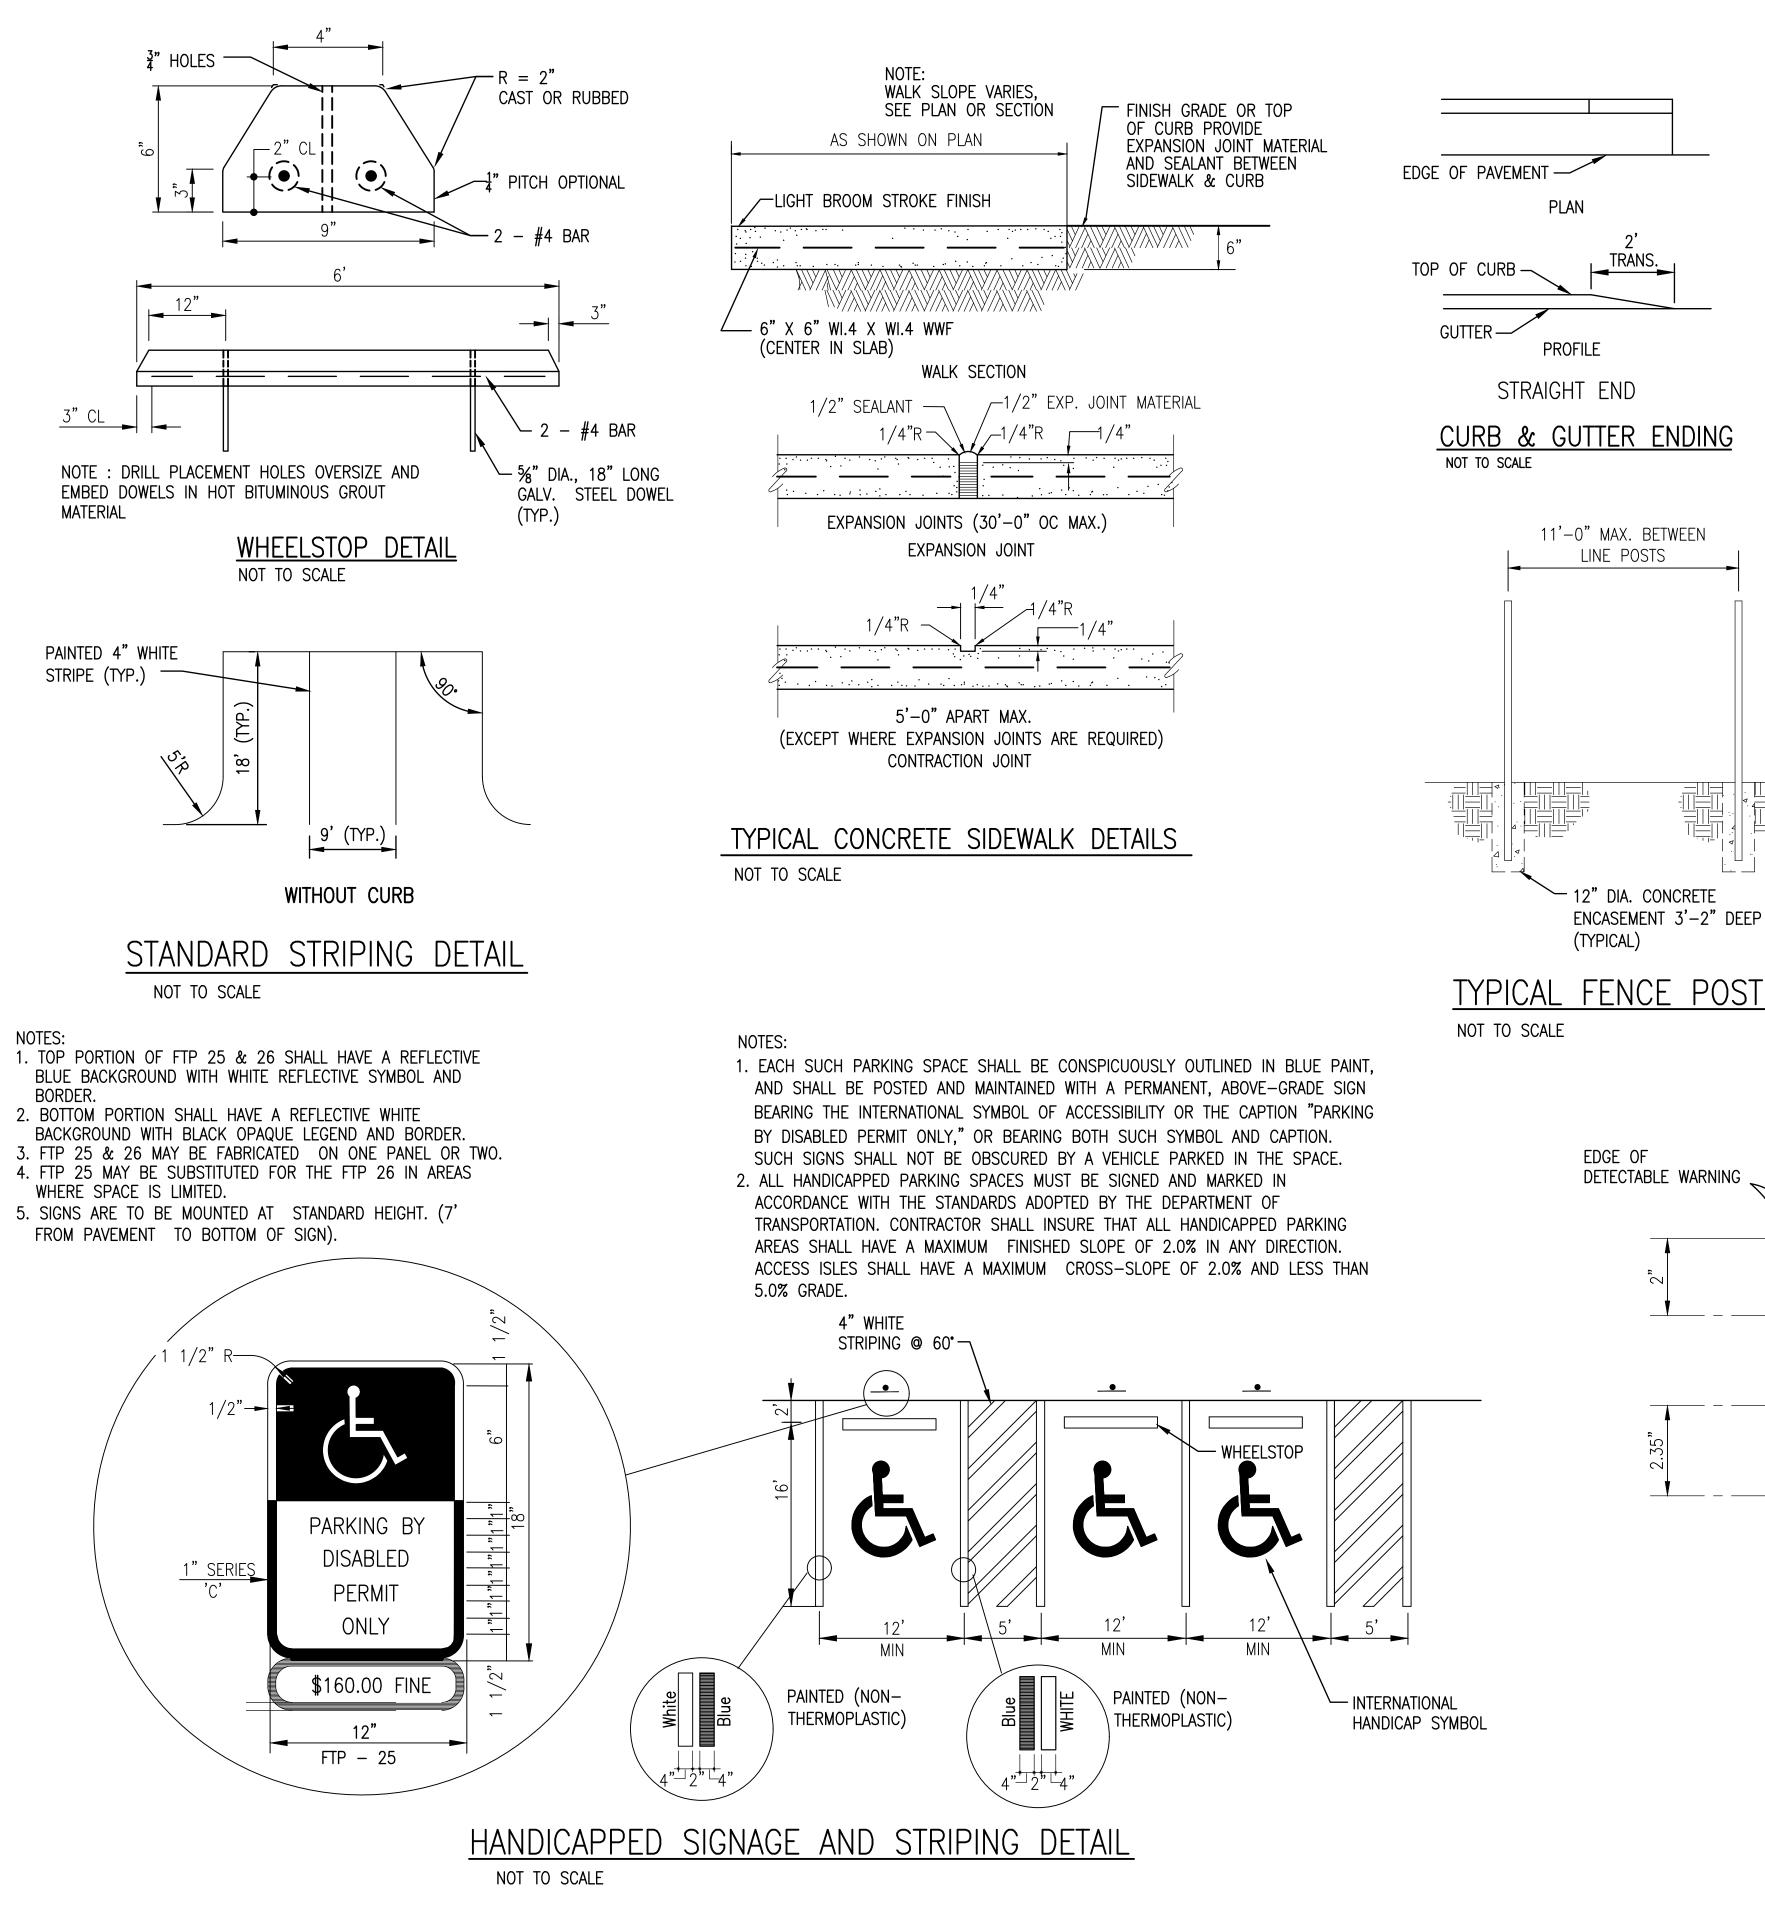

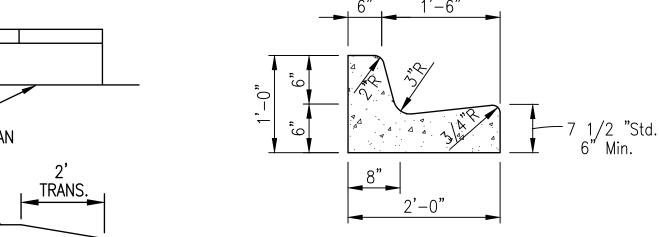(TYP.)

NOTE: WHEN USED ON HIGH SIDE OF ROADWAYS, THE CROSS SLOPE OF THE GUTTER SHALL MATCH THE CROSS SLOPE OF THE ADJACENT PAVEMENT AND THE THICKNESS OF THE LIP SHALL BE 6", UNLESS OTHERWISE SHOWN ON PLANS.

> FDOT TYPE F CURB NOT TO SCALE



TYPICAL CONCRETE SECTION NOT TO SCALE

∕[—]6"x6" W1.4xW1.4 WWF ASPHALT -CENTERED IN SLAB COMPACTED SUBGRADE LBR 49 95% STANDARD PROCTOR DETAIL - CONCRETE PAVEMENT

INTERFACE TO ASPHALT PAVEMENT NOT TO SCALE

TYPICAL FENCE POST DETAIL

DOME PATTERN SHALL BE IN-LINE | 2.35" | WITH DIRECTION OF TRAVEL DETECTABLE WARNING __INTEGRAL DOME TRUNCATED DOME -TRUNCATED DOME (SEE DETAIL)

> TRUNCATED DOME PAVERS NOT TO SCALE

PLAN VIEW

1. TRUNCATED DOME PAVER SURFACES SHALL EXTEND THE FULL WIDTH OF THE RAMP AND IN THE DIRECTION OF TRAVEL 24" FROM THE BACK OF CURB (OR EOP). DETECTABLE WARNING SURFACES SHALL BE CONSTRUCTED BY TEXTURING A TRUNCATED DOME PATTERN IN CONFORMANCE WITH U.S. DEPARTMENT OF JUSTICE A.D.A. STANDARDS FOR ACCESSIBLE DESIGN, A.D.A. ACCESSIBILITY GUIDELINES, SECTION 4.29.2, (DETAIL SHOWN). TRANSITION SLOPES ARE NOT TO HAVE DETECTABLE WARNINGS.

2. UNLESS OTHERWISE CALLED OUT IN THE PLANS, THE TRUNCATED DONE PAVER SURFACE SHALL BE COLORED IN ACCORDANCE WITH SECTION 351 OF THE STANDARD SPECIFICATIONS.

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PENSACOLA, FLORIDA

PENSACOLA GENERAL AVIATION FACILITY (GAF)

IN COLLABORATION WITH:



BASKERVILLE-DONGVAN, INC. innevative infrastructure Selutions 449 W. MAIN ST.

PENSACOLA, FLORIDA 32502 (850)438-9661 Engineering Business: EB-0000340 PROFESSIONAL SEAL

JASON J. FRICK P.E. FL Reg. Engineer #86469

N DAT

DATE ISSUED: 03/03/2020 **REVIEWED BY:** MDL RGG DRAWN BY: **DESIGNED BY:** JJF PROJECT NUMBER:

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DETAILS

SHEET NUMBER

C902

- & DETAILS FOR SOIL EROSION AND SEDIMENT CONTROL 1. ALL EROSION AND SEDIMENT CONTROL PRACTICES TO BE INSTALLED PRIOR TO ANY MAJOR SOIL DISTURBANCE, OR IN THEIR PROPER SEQUENCE, AND MAINTAINED UNTIL PERMANENT PROTECTION IS
- 2. ANY DISTURBED AREAS THAT WILL BE LEFT EXPOSED MORE THAN 30 DAYS, AND NOT SUBJECT TO CONSTRUCTION TRAFFIC, WILL IMMEDIATELY RECEIVE STAKED SOD.
- 3. PERMANENT VEGETATION TO BE SODDED ON ALL EXPOSED AREAS WITHIN TEN (10) DAYS AFTER
- 4. ALL WORK AND MATERIALS TO BE IN ACCORDANCE WITH THE FDOT "STANDARD SPECIFICATIONS FOR ROAD AND BRIDGE CONSTRUCTION", LATEST EDITION, SECTIONS 104, 570, 575 AND 980 TO 986.
- *5. IMMEDIATELY FOLLOWING INITIAL DISTURBANCE OR ROUGH GRADING, ALL AREAS SUBJECT TO EROSION WILL RECEIVE STAKED SOD.
- *6. ANY STEEP SLOPES RECEIVING PIPELINE INSTALLATION WILL BE BACKFILLED AND STABILIZED DAILY, AS THE INSTALLATION PROCEEDS.
- 7. AT THE TIME WHEN THE SITE PREPARATION FOR PERMANENT VEGETATIVE STABILIZATION IS GOING TO BE ACCOMPLISHED, ANY SOIL THAT WILL NOT PROVIDE A SUITABLE ENVIRONMENT TO SUPPORT ADEQUATE VEGETATIVE GROUND COVER, SHALL BE REMOVED OR TREATED IN SUCH A WAY THAT WILL PERMANENTLY ADJUST THE SOIL CONDITIONS AND RENDER IT SUITABLE FOR VEGETATIVE GROUND COVER. IF THE REMOVAL OR TREATMENT OF THE SOIL WILL NOT PROVIDE SUITABLE CONDITIONS, NON-VEGETATIVE MEANS OF PERMANENT GROUND STABILIZATION WILL HAVE TO BE EMPLOYED.
- *8. CONDUIT OUTLET PROTECTION MUST BE INSTALLED AT ALL REQUIRED OUTFALLS PRIOR TO THE DRAINAGE SYSTEM BECOMING OPERATIONAL.
- 9. UNFILTERED DEWATERING IS NOT PERMITTED. THE CONTRACTOR SHALL TAKE ALL NECESSARY PRECAUTIONS DURING ALL DEWATERING OPERATIONS TO MINIMIZE SEDIMENT TRANSFER.
- 10. SHOULD THE CONTROL OF DUST AT THE SITE BE NECESSARY, THE SITE WILL BE SPRINKLED UNTIL THE SURFACE IS WET, TEMPORARY VEGETATION COVER SHALL BE ESTABLISHED.
- 11. ALL SOIL WASHED, DROPPED, SPILLED OR TRACKED OUTSIDE THE LIMIT OF DISTURBANCE OR ONTO PUBLIC RIGHTS-OF-WAY WILL BE REMOVED IMMEDIATELY.
- 12. THE CONTRACTOR SHALL BE RESPONSIBLE FOR ANY EROSION OR SEDIMENTATION THAT MAY OCCUR BELOW STORMWATER OUTFALLS OR OFFSITE AS A RESULT OF CONSTRUCTION OF THE PROJECT.
- 13. ALL SOIL STOCKPILES ARE TO BE TEMPORARILY STABILIZED IN ACCORDANCE WITH SOIL EROSION AND SEDIMENT CONTROL NOTE NUMBER 2 (ABOVE).
- 14. THE SITE SHALL AT ALL TIMES BE GRADED AND MAINTAINED SUCH THAT ALL STORM WATER RUNOFF IS DIVERTED TO SOIL EROSION AND SEDIMENT CONTROL FACILITIES.
- 15. ALL SEDIMENTATION STRUCTURES SHALL BE INSPECTED AND MAINTAINED REGULARLY.
- 16. ALL CATCH BASIN INLETS SHALL BE PROTECTED WITH HAY BALES AS SHOWN ON DETAIL. 17. THE CONTRACTOR SHALL PREPARE A PLAN FOR THE PROPER DEWATERING AND DOWNSTREAM
- SILTATION PROTECTION.

18. ANY AREAS USED FOR THE CONTRACTOR'S STAGING, INCLUDING BUT NOT LIMITED TO, TEMPORARY STORAGE OF STOCKPILED MATERIALS (E.G. CRUSHED STONE, QUARRY PROCESS STONE, SELECT FILL, EXCAVATED MATERIALS, ETC.), SHALL BE ENTIRELY PROTECTED BY A SILT FENCE ALONG THE LOW ELEVATION SIDE TO CONTROL SEDIMENT RUNOFF.

19. THE CONTRACTOR'S MEANS AND METHODS OF GROUNDWATER DEWATERING SHALL COMPLY WITH ALL REGULATORY REQUIREMENTS FOR THE TEMPORARY DIVERSION OF GROUNDWATER AND ITS DISCHARGE, INCLUDING FDEP CHAPTER 62-621 "GENERAL PERMIT FOR THE DISCHARGE OF PRODUCED GROUNDWATER FROM ANY NON-CONTAMINATED SITE ACTIVITY".

* WHERE APPLICABLE

SOD SHALL BE WELL ROOT MATTED COMMERCIALLY CUT TO A MINIMUM DIMENSION OF 12" x 24" OR IN A ROLL A MAXIMUM OF 72 HOURS PRIOR TO PLACEMENT. SOD SHALL BE LIVE, FRESH AND UNINJURED, REASONABLY FREE OF WEEDS AND OTHER GRASSES, WITH A HEAVY SOIL MAT ADHERING TO THE ROOT SYSTEM. SOD SHALL BE GROWN, CUT, AND SUPPLIED BY A STATE CERTIFIED GROWER.

TREE PROTECTION


1. DAMAGED TRUNKS OR EXPOSED ROOTS WILL BE PAINTED IMMEDIATELY WITH A QUALITY GRADE OF "TREE PAINT".

2. TREE LIMB REMOVAL, WHERE NECESSARY, WILL BE DONE FLUSH TO TRUNK OR MAIN BRANCH AND THAT AREA PAINTED IMMEDIATELY WITH A QUALITY GRADE OF TREE PAINT.

DUST CONTROL

1. ALL AREAS OF CLEARING AND EMBANKMENT AS WELL AS CONSTRUCTION HAUL ROADS SHALL BE TREATED AND MAINTAINED IN SUCH A MANNER AS TO MINIMIZE ANY DUST


- 2. DISTURBED AREAS SHALL BE MAINTAINED IN A ROUGH GRADED CONDITION AND TEMPORARILY SEEDED AND/OR MULCHED UNTIL PROPER WEATHER CONDITIONS EXIST FOR THE ESTABLISHMENT OF PERMANENT VEGETATION COVER.
- 3. IN EVENT OF EMERGENCY CONDITIONS, TILLAGE WILL BE SATISFACTORY FREE BEFORE SOIL BLOWING STARTS.
- 4. CALCIUM CHLORIDE MAY BE APPLIED TO UNPAVED ROADWAY AREAS, ONLY, SUBJECT TO THE ENGINEER'S APPROVAL AND CONFORMANCE WITH FDOT STANDARD SPECIFICATIONS, SECTION 102-5, LATEST EDITION.

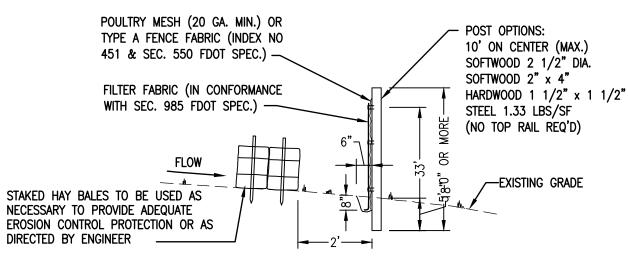


- SILT FENCE NOTES:
- 1. FABRIC TO BE PLACED FACING DRAINAGE FLOW
- 2. FABRIC TO BE PLACED IN A 6" WIDE x 8" DEEP CONTINUOUS TRENCH, THEN BACKFILLED 3. ALL LUMBER TO BE PRESSURE/PRESERVATIVE TREATED
- 4. SILT FENCE TO BE INSTALLED PRIOR TO COMMENCEMENT OF ANY CONSTRUCTION ACTIVITIES. SILT FENCE TO REMAIN UNTIL 100% PROJECT GRASSING (STABILIZATION) IS ACHIEVED
- 5. PREFABRICATED SILT FENCES ARE PERMITTED AS LONG AS THEY MEET OR EXCEED FDOT SPECIFICATIONS.

TYPE IV SILT FENCE DETAIL

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FILTER BAGS ARE CONSTRUCTED OF NON-WOVEN GEOTEXTILE FABRIC. A MAXIMUM OF ONE SIX INCH DISCHARGE HOSE WILL BE ALLOWED PER FILTER BAG. BAG CAPACITY WILL BE EXCEEDED BEYOND 2,000 GALLONS PER MINUTE. TYPICAL BAG DIMENSIONS ARE 15 FEET BY 13.25 FEET. TO HELP PREVENT PUNCTURES, GEOTEXTILE FABRIC WILL BE PLACED BENEATH THE FILTER BAG WHEN USED IN WOODED LOCATIONS. UNATTENDED FILTER BAGS WILL BE ENCIRCLED WITH A HAY BALE OR SILT FENCE CORRAL. HOSE CLAMPS WILL BE USED TO SECURE THE DISCHARGE HOSE, WIRE OR STRING WILL NOT BE USED.

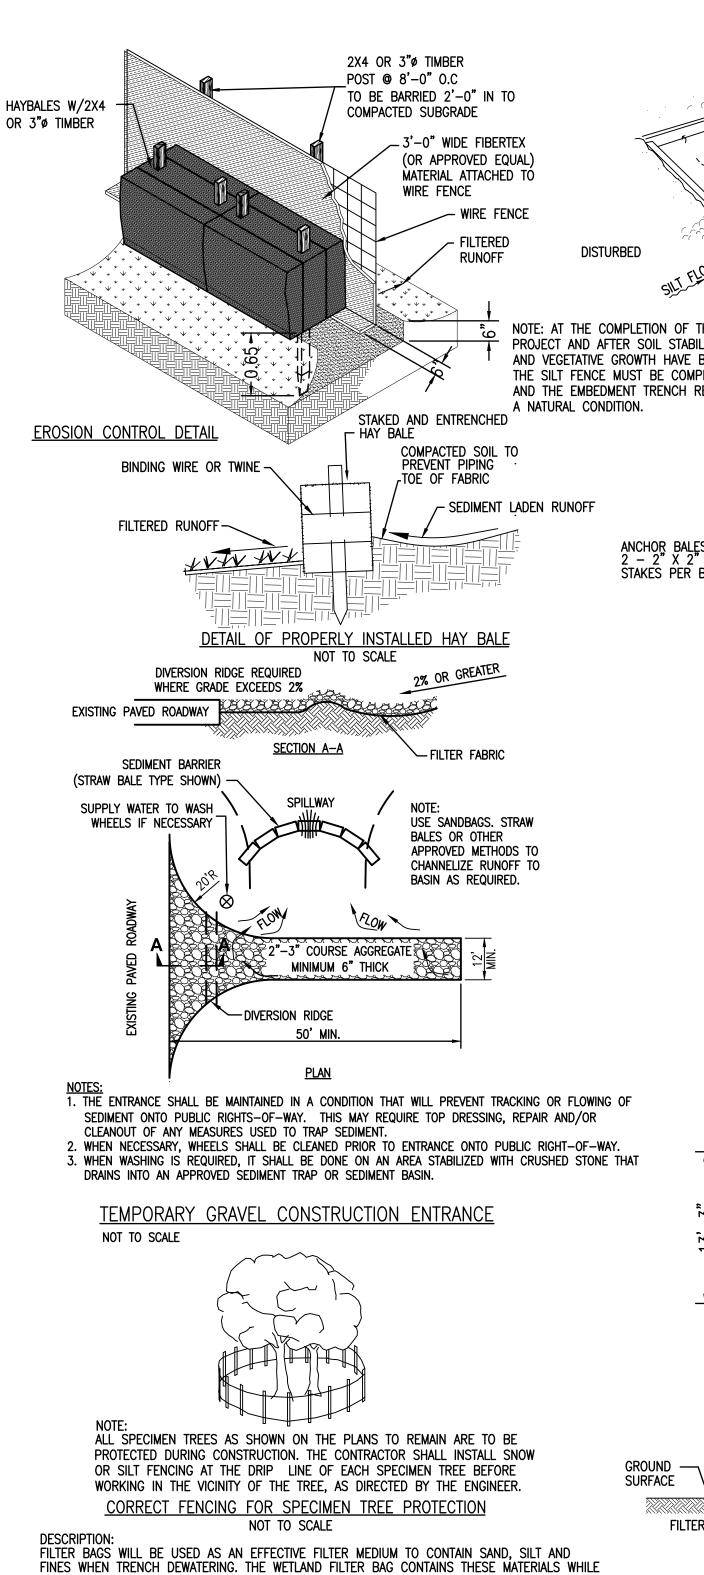

PROTECTION AROUND INLETS OR SIMILAR STRUCTURES
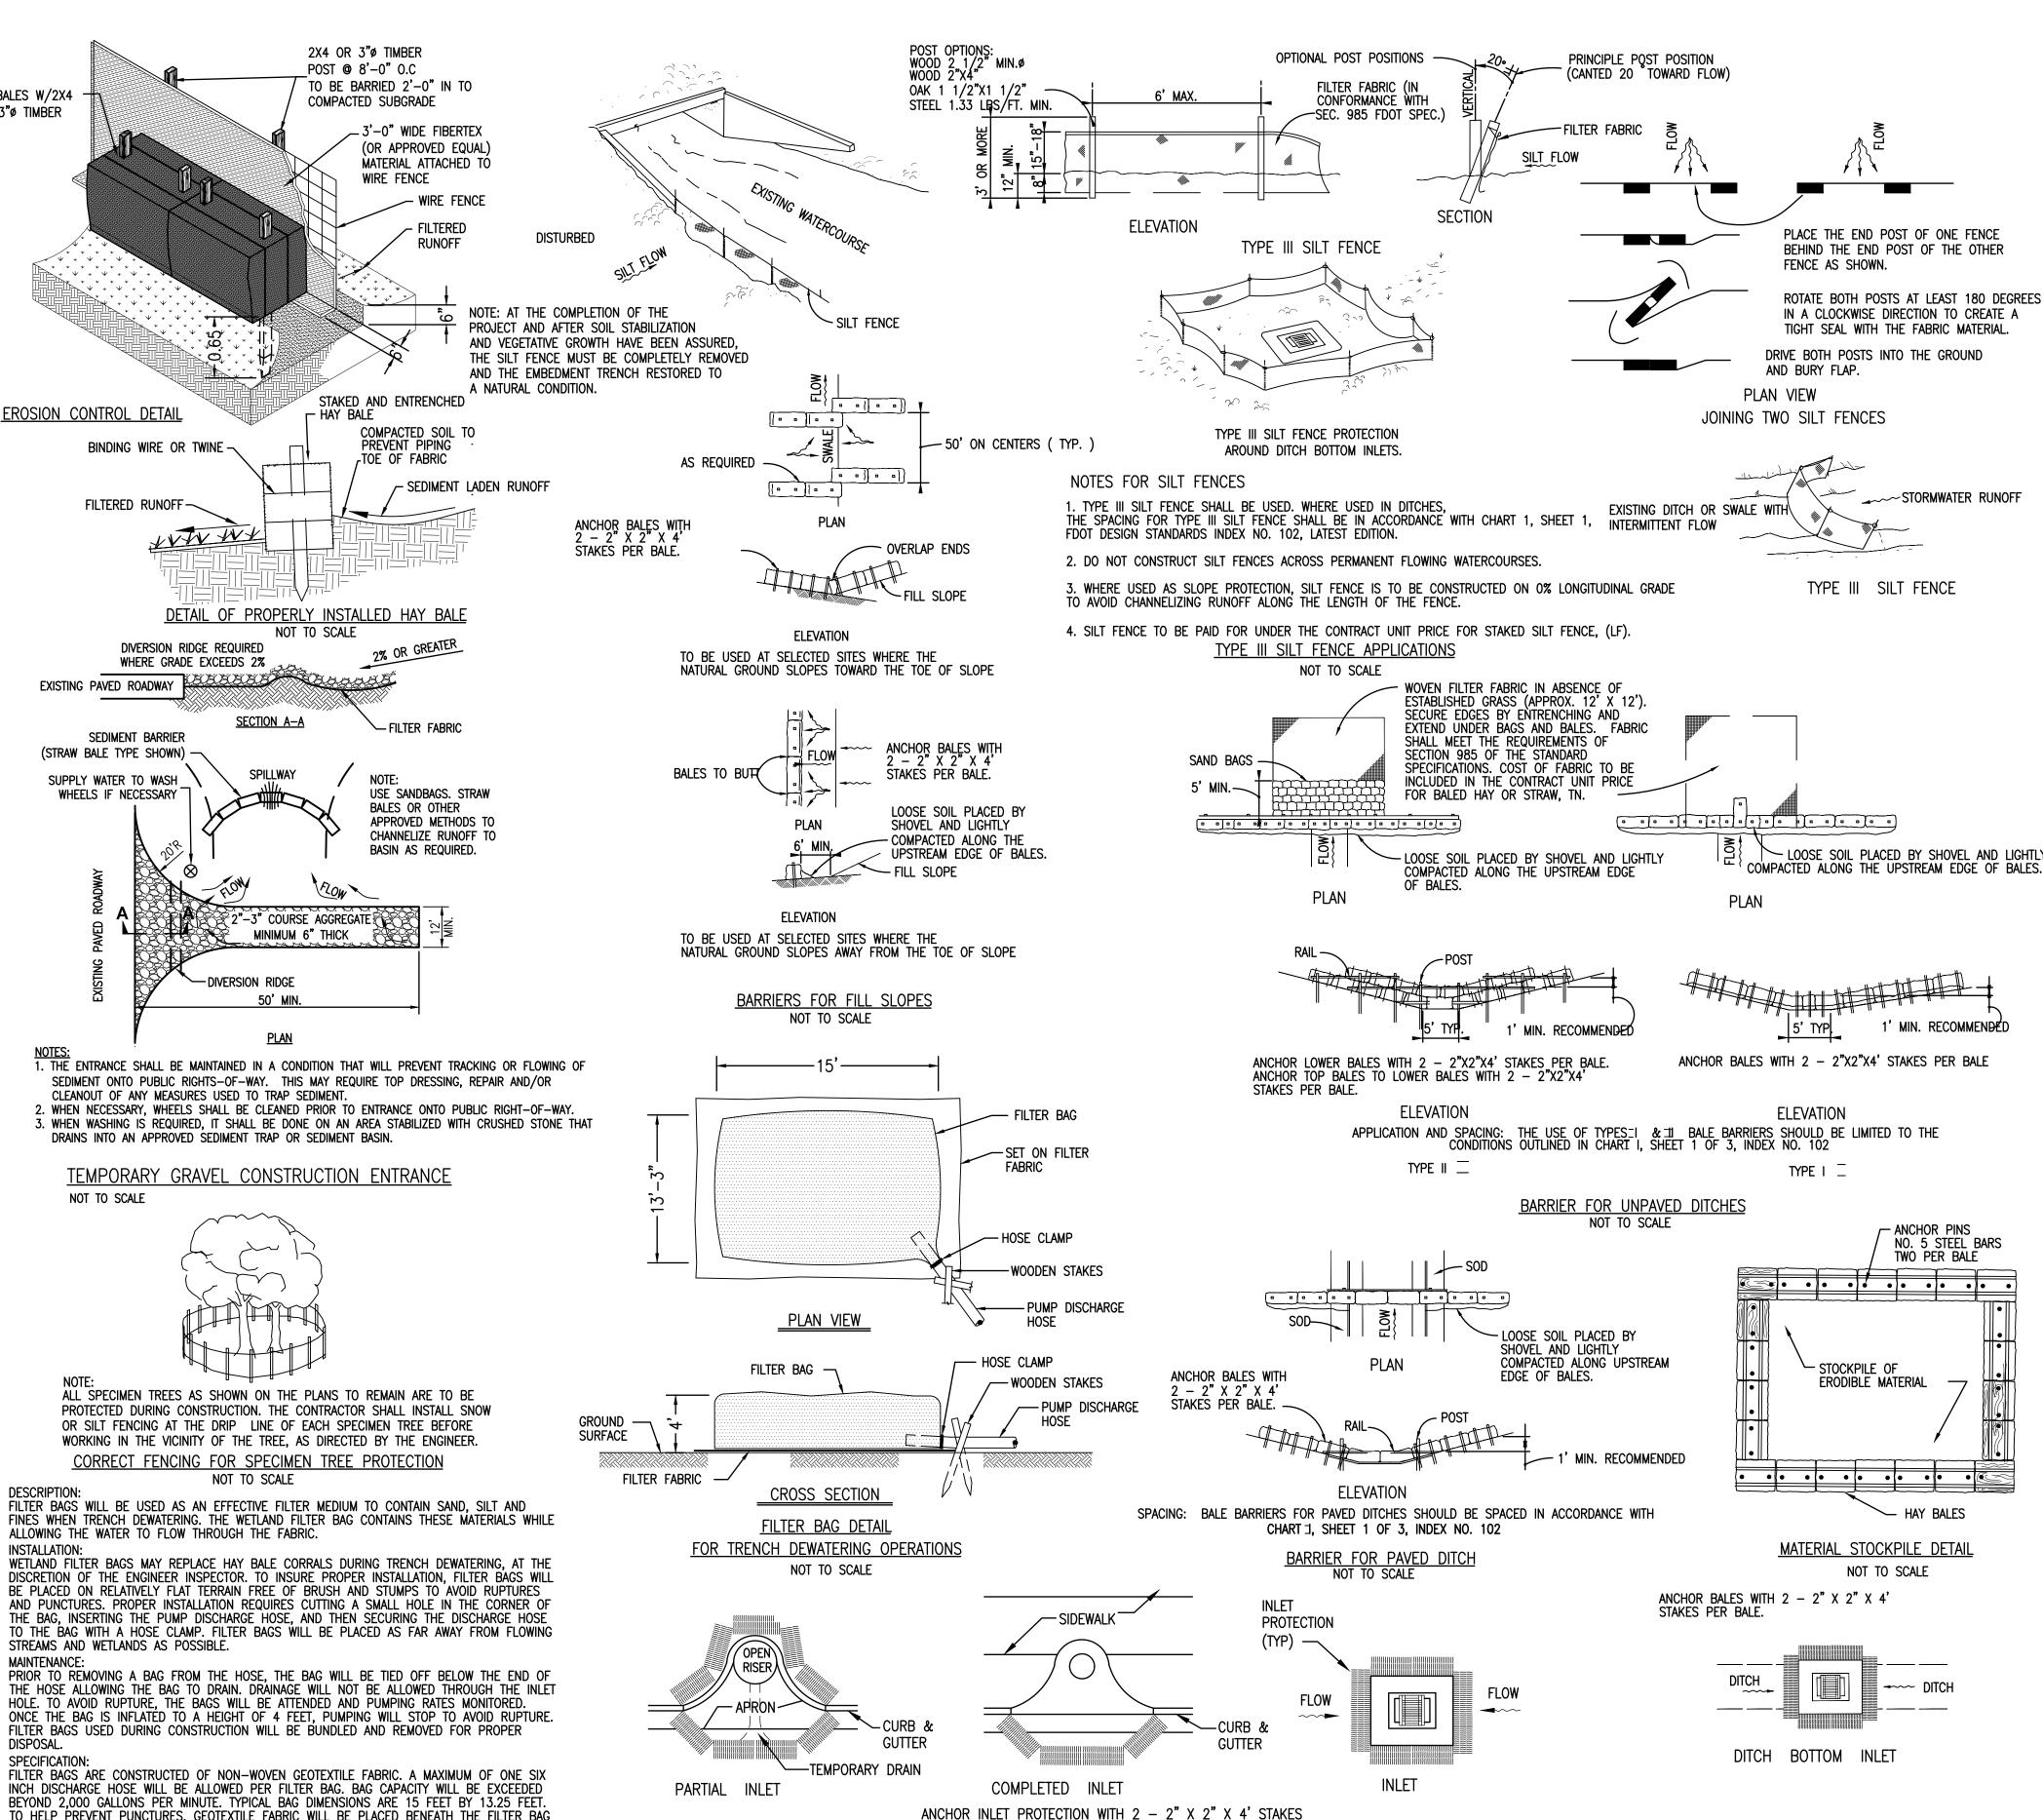
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PENSACOLA, FLORIDA

PENSACOLA GENERAL AVIATION FACILITY (GAF)

IN COLLABORATION WITH:



BASKERVILLE-DONOVAN, INC. Innovative Infrastructure Solutions

449 W MAIN ST PENSACOLA, FLORIDA 32502 (850)438-9661 Engineering Business: EB-0000346 PROFESSIONAL SEAL

JASON J. FRICK P.E.

FL Reg. Engineer #86469 REVISIONS DESCRIPTION DATE **DATE ISSUED:**

03/03/2020 **REVIEWED BY:** MDL DRAWN BY: RGG **DESIGNED BY:** JJF PROJECT NUMBER: 201-0052-002

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SEDIMENTATION EROSION CONTROL DETAILS

SHEET NUMBER

C903

1.1 INTRODUCTION:

THE REFERENCED SUPPORT DOCUMENTATION FOR THIS STORM WATER POLLUTION PREVENTION PLAN (SWPPP) IS THE UNITED STATES ENVIRONMENTAL PROTECTION AGENCY'S (EPA) STORM WATER MANAGEMENT FOR CONSTRUCTION ACTIVITIES, DEVELOPING POLLUTION PREVENTION PLANS AND BEST MANAGEMENT PRACTICES SUMMARY GUIDANCE (EPA 833-R-92-001) AND STORM WATER MANAGEMENT FOR CONSTRUCTION ACTIVITIES, DEVELOPING POLLUTION PREVENTION PLANS AND BEST MANAGEMENT PRACTICES (EPA 832-R-92-005). THIS SWPPP IS DESIGNED TO PROTECT ONSITE AND ADJACENT NATURAL RESOURCES, INCLUDING BUT NOT LIMITED TO, WETLANDS, MARSHES, BAYOUS AND BAYS, WHILE PRESERVING WILDLIFE AND ARCHEOLOGICAL RESOURCES.

1.2 NOTICE OF INTENT (NOI):

RULE 62-621.300(4), FAC REQUIRES THE CONSTRUCTION OPERATOR OF A SITE THAT DISTURBS ONE OR MORE ACRES TO OBTAIN COVERAGE FROM THE GENERIC PERMIT FOR STORMWATER DISCHARGE FROM CONSTRUCTION ACTIVITIES THE CONTRACTOR IS REQUIRED TO SUBMIT A NOTICE OF INTENT TO USE GENERIC PERMIT FOR STORMWATER DISCHARGE FROM CONSTRUCTION ACTIVITIES THAT DISTURB ONE OR MORE ACRES (FDEP FORM 62-621.300) ALONG WITH THE APPROPRIATE APPLICATION FEE TO THE FOLLOWING ADDRESS 48 HOURS PRIOR TO COMMENCING CONSTRUCTION:

> NPDES STORMWATER NOTICES CENTER, MS # 2510 FLORIDA DEPARTMENT OF ENVIRONMENTAL PROTECTION 2600 BLAIR STONE ROAD TALLAHASSEE, FLORIDA 32399-2400

THIS FORM CAN BE OBTAINED FROM FDEP'S WEBSITE (WWW.DEP.STATE.FL.US) OR BY CONTACTING FDEP. PLEASE NOTE THAT THE CURRENT APPLICATION FEE'IS \$400(> 5 ACRES) OR \$250 (1-4.99 ACRES); HOWEVER, THIS FEE IS SUBJECT TO CHANGE WITHOUT NOTICE. ALWAYS REFER TO THE MOST CURRENT VERSION OF RULE 62-4.050(4)(D), FAC TO CONFIRM THE AMOUNT BEFORE SUBMITTING PAYMENT. IF CONSTRUCTION ACTIVITY EXCEEDS FIVE YEARS, THE CONTRACTOR MUST RE-APPLY FOR COVERAGE.

1.3 STORMWATER POLLUTION PREVENTION PLAN (SWPPP):

THE CONTRACTOR IS REQUIRED TO CERTIFY THIS STORMWATER POLLUTION PREVENTION PLAN (SWPPP) BELOW PRIOR TO SUBMITTING THE NOI. THIS SWPPP IS NOT REQUIRED TO BE SUBMITTED WITH THE NOI, BUT IS REQUIRED TO BE KEPT ON SITE DURING ALL PHASES OF CONSTRUCTION. BECAUSE EROSION AND SEDIMENT CONTROLS AND CONSTRUCTION METHODS VARY SIGNIFICANTLY FROM CONTRACTOR TO CONTRACTOR, THE CONTRACTOR CAN PROPOSE ALTERNATIVE METHODS TO THIS SWPPP THAT ARE EQUAL OR BETTER AT CONTROLLING EROSION AND SEDIMENTATION AT A MINIMUM. THE CONTRACTOR MUST FOLLOW THE EROSION CONTROL PLAN SPECIFIED IN THE CONSTRUCTION PLANS AND DOCUMENTS. ANY MODIFICATIONS TO THIS SWPPP MUST BE DOCUMENTED AND KEPT WITH THE PLAN AS PART OF THE RECORDS KEEPING PROCESS TO BE IN FULL COMPLIANCE WITH THE CGP.

1.4 CONTRACTOR'S CERTIFICATION:

I CERTIFY UNDER PENALTY OF LAW THAT I UNDERSTAND THE TERMS AND CONDITIONS OF THE GENERAL NATIONAL POLLUTANT DISCHARGE ELIMINATION SYSTEM (NPDES) PERMIT THAT AUTHORIZES THE STORM WATER DISCHARGES ASSOCIATED WITH CONSTRUCTION ACTIVITY FROM THE CONSTRUCTION SITE IDENTIFIED AS PART OF THIS CERTIFICATION.

PRINT & SIGN NAME

COMPANY & ADDRESS

NAME & TITLE (PRINT)

SIGNATURE

RESPONSIBILITIES (GENERAL CONTRACTOR, SITE CONTRACTOR, SUBCONTRACTOR, OTHER):

DATE

1.5 NOTICE OF TERMINATION (NOT):

THE CONTRACTOR IS REQUIRED TO SUBMIT A NOTICE OF TERMINATION OF GENERIC PERMIT COVERAGE (FDEP FORM 62-621.300(6)) UPON CONSTRUCTION COMPLETION TO DISCONTINUE PERMIT COVERAGE. THE NOT IS TO BE SUBMITTED TO THE FOLLOWING ADDRESS:

> NPDES STORMWATER NOTICES CENTER, MS # 2510 FLORIDA DEPARTMENT OF ENVIRONMENTAL PROTECTION 2600 BLAIR STONE ROAD TALLAHASSEE, FLORIDA 32399-2400

THIS FORM CAN BE OBTAINED FROM FDEP'S WEBSITE (WWW.DEP.STATE.FL.US) OR BY CONTACTING FDEP. THE NOT CAN NOT BE SUBMITTED UNTIL ALL DISTURBED SOILS AT THE CONSTRUCTION SITE HAVE BEEN FINALLY STABILIZED AND TEMPORARY EROSION AND SEDIMENT CONTROL MEASURES HAVE BEEN REMOVED OR WILL BE REMOVED AT AN APPROPRIATE TIME. FINAL STABILIZATION MEANS THAT ALL SOIL DISTURBING ACTIVITIES AT THE SITE HAVE BEEN COMPLETED AND THAT A UNIFORM PERENNIAL VEGETATIVE COVER WITH A DENSITY OF 70 PERCENT OF THE COVER FOR UNPAVED AREAS AND AREAS NOT COVERED BY PERMANENT STRUCTURES HAS BEEN ESTABLISHED, OR EQUIVALENT STABILIZATION MEASURES HAVE BEEN EMPLOYED. IF CONSTRUCTION ACTIVITY EXCEEDS FIVE YEARS, THE CONTRACTOR MUST RE-APPLY FOR COVERAGE.

1.6 APPLICATION INFORMATION:

PROJECT ADDRESS: SECTION 17, TOWNSHIP 1S, RANGE 29W, ESCAMBIA COUNTY. FL. LOCATED WEST OF JERRY L. MAYGARDEN RD. WITHIN THE

AIRPORT PROPERTY.

CITY OF PENSACOLA

N 28° 02' 74" LATITUDE: W 10° 52' 31" LONGITUDE:

WATER MANAGEMENT DISTRICT: NORTHWEST FLORIDA (NWFWMD)

ERP PERMIT NO.: 0230740-003-EI/17

RECEIVING WATER NAME: PENSACOLA BAY

2.0 SITE DESCRIPTION:

MS4 OPERATOR NAME:

2.1 NATURE OF CONSTRUCTION ACTIVITIES:

THE PROPOSED IMPROVEMENTS CONSIST OF THE CONSTRUCTION OF THE 18,700 SQUARE FOOT DEVELOPMENT WITH NECESSARY UTILITY CONNECTIONS, ASSOCIATED PARKING AND DRIVE ENTRANCES, LANDSCAPING, AND STORMWATER TREATMENT FACILITIES.

2.2 SEQUENCE OF MAJOR SOIL DISTURBING ACTIVITIES:

• EROSION CONTROL MEASURES

• CLEARING AND GRUBBING • EARTHWORK- BORROW STOCKPILE MATERIAL WILL BE SORTED AND USED

AS ON-SITE EARTH FILL

• EARTHWORK— STORMWATER CONVEYANCE CONSTRUCTION • EARTHWORK- ASSOCIATED WITH BUILDING FOUNDATION, STORM DRAINS, CURBING, BASE, AND PAVEMENT CONSTRUCTION

FINAL LANDSCAPING AND STABILIZATION

THE FOLLOWING SEQUENCE OF MAJOR ACTIVITIES SHALL BE FOLLOWED UNLESS THE CONTRACTOR CAN PROPOSE AN ALTERNATIVE THAT IS EQUAL TO OR BETTER AT CONTROLLING EROSION AND SEDIMENTATION. THE DETAILED SEQUENCE FOR THE ENTIRE PROJECT CAN VARY SIGNIFICANTLY FROM CONTRACTOR TO CONTRACTOR. THE CONTRACTOR IS RESPONSIBLE FOR DOCUMENTING ANY CHANGES.

THE CONSTRUCTION SHOULD PROCEED IN THE FOLLOWING GENERAL MANNER:

1. INSTALL PERIMETER FENCING. PER AIRPORT OPERATIONS.

2. INSTALL SEDIMENT AND EROSION CONTROL THAT CAN BE PLACED PRIOR TO MAJOR SOIL DISTURBANCE. INSTALL & MAINTAIN REMAINING SEDIMENT CONTROLS CONSISTENT WITH CONSTRUCTION ACTIVITIES.

. CLEAR AND GRUB SITE.

4. SORT STOCKPILE MATERIAL AND COMPLETE ROUGH GRADING

OPERATIONS. 5. CONSTRUCT PROPOSED UNDERGROUND UTILITIES, BUILDING, PARKING

LOTS, SIDEWALKS, & CURBS, ETC.

6. CONSTRUCT FINAL GRADING, LANDSCAPING AND PERMANENT EROSION

7. REMOVE TEMPORARY SEDIMENT & EROSION CONTROL WHEN FINAL EROSION CONTROL IS ESTABLISHED.

2.3 AREA ESTIMATES:

TOTAL PROJECT AREA: 5.32 ACRES

2.4 RUNOFF COEFICIENTS:

PRE-CONSTRUCTION- 0.2 DURING CONSTRUCTION— 0.4 — 0.5 POST CONSTRUCTION - 0.5

SOILS DATA: SEE SOILS REPORT FOR ADDITIONAL INFORMATION

2.5 SITE MAP:

THE CONSTRUCTION PLANS ARE BEING UTILIZED AS THE SITE MAP. THE EXISTING CONDITIONS SHEET SHOWS PRE-EXISTING DRAINAGE PATTERNS AND SLOPES. THE GRADING AND DRAINAGE PLANS SHOWS THE STORMWATER FACILITIES AND FINAL GRADE SLOPES. TEMPORARY EROSION CONTROL IS SHOWN ON THE SEDIMENT AND EROSION CONTROL PLAN. LANDSCAPING PLANS DEPICT THE FINAL PERMANENT STABILIZATION.

2.6 RECEIVING WATERS:

PENSACOLA BAY IS THE RECEIVING WATERS OF THE STORMWATER RUNOFF FROM THIS PROJECT.

3.0 CONTROLS:

3.1 EROSION AND SEDIMENT CONTROLS:

ALL EROSION AND SEDIMENT CONTROLS SPECIFIED ON THESE PLANS (LIMITS OF SOIL EROSION AND SEDIMENTATION CONTROL MEASURES) SHALL BE INSTALLED PRIOR TO ANY CONSTRUCTION OR DEMOLITION. SILT FÉNCING AND STAKED HAY BALES SHALL BE INSTALLED ALONG DOWN-GRADIENT LIMITS TO PROTECT EXISTING DRAINAGE STRUCTURES AND/OR DRAINAGE SYSTEMS FROM EROSION AND SEDIMENTATION. SILT FENCING IS LIMITED TO AREAS OUTSIDE OF AIRPORT SECURITY FENCING.

3.2 STORMWATER MANAGEMENT:

STORMWATER MANAGEMENT WILL BE CONSTRUCTED TO CONVEY STORMWATER TO THE PENSACOLA INTERNATIONAL AIRPORT REGIONAL POND FOR TREATMENT. THE FACILITIES HAVE BEEN PERMITTED BY THE FLORIDA DEPARTMENT OF ENVIRONMENTAL PROTECTION (FDEP) AND COMPLY WITH APPLICABLE DESIGN STANDARDS.

3.3 OTHER CONTROLS:

3.3.1 WASTE DISPOSAL

IN THE SEDIMENT AND EROSION CONTROL PLAN, THE CONTRACTOR SHALL DESCRIBE THE PROPOSED METHODS TO PREVENT THE DISCHARGE OF SOLID MATERIAL. INCLUDING BUILDING MATERIALS, TO WATERS OF THE STATE. THE PROPOSED METHODS SHALL INCLUDE AT LEAST THE FOLLOWING, UNLESS APPROVED BY THE

PROVIDING LITTER CONTROL AND COLLECTION WITHIN THE PROJECT DURING CONSTRUCTION ACTIVITIES.

DISPOSING OF ALL FERTILIZER OR OTHER CHEMICAL CONTAINERS ACCORDING TO EPA'S STANDARD PRACTICES AS DETAILED BY THE MANUFACTURER.

DISPOSING OF SOLID MATERIALS INCLUDING BUILDING AND CONSTRUCTION MATERIALS OFF THE PROJECT SITE IN ACCORDANCE WITH APPLICABLE LOCAL, STATE, AND FEDERAL REGULATIONS.

3.3.2 OFF-SITE VEHICLE TRACKING & DUST CONTROL.

IN THE SEDIMENT AND EROSION CONTROL PLAN, THE CONTRACTOR SHALL DESCRIBE THE PROPOSED METHODS FOR MINIMIZING OFF-SITE VEHICLE TRACKING OF SEDIMENTS AND GENERATING DUST. THE PROPOSED METHODS SHALL INCLUDE AT LEAST THE FOLLOWING, UNLESS APPROVED BY THE ENGINEER

COVERING LOADED HAUL TRUCKS WITH TARPAULINS

REMOVING EXCESS DIRT FROM ROADS DAILY.

STABILIZING CONSTRUCTION ENTRANCES ACCORDING TO THE FLORIDA EROSION AND SEDIMENT CONTROL MANUAL.

USING ROADWAY SWEEPERS DURING DUST GENERATING ACTIVITIES SUCH AS EXCAVATION.

3.3.3 STATE AND LOCAL REGULATIONS FOR WASTE DISPOSAL, SANITARY SEWER. OR SEPTIC TANK REGULATIONS:

IN THE SEDIMENT AND EROSION CONTROL PLAN, THE CONTRACTOR SHALL DESCRIBE THE PROPOSED PROCEDURES TO COMPLY WITH APPLICABLE STATE AND LOCAL REGULATION FOR WASTE DISPOSAL, AND SANITARY SEWER, OR SEPTIC SYSTEMS.

3.3.4 FERTILIZERS AND PESTICIDES:

IN THE SEDIMENT AND EROSION CONTROL PLAN, THE CONTRACTOR SHALL DESCRIBE THE PROPOSED PROCEDURES FOR APPLYING FERTILIZERS AND PESTICIDES.

3.3.5 TOXIC SUBSTANCES:

IN THE SEDIMENT AND EROSION CONTROL PLAN, THE CONTRACTOR SHALL PROVIDE A LIST OF TOXIC SUBSTANCES THAT ARE LIKELY TO BE USED ON THE JOB AND PROVIDE A PLAN ADDRESSING THE GENERATION, APPLICATION, MIGRATION, STORAGE AND DISPOSAL OF THESE SUBSTANCES.

3.3.6 APPROVED STATE AND LOCAL PLANS AND PERMITS. CONTRACTOR SHALL ADHERE TO THE CITY AND NWFWMD PERMITS ISSUED FOR THIS PROJECT, AS WELL AS ANY ADDITIONAL FEDERAL, STATE, OR LOCAL PERMITS/ORDINANCES THAT ARE APPLICABLE TO THIS PROJECT.

4.0 MAINTENANCE

IN THE SEDIMENT AND EROSION CONTROL PLAN, THE CONTRACTOR SHALL PROVIDE A PLAN FOR MAINTAINING ALL EROSION AND SEDIMENT CONTROLS THROUGHOUT CONSTRUCTION. THE MAINTENANCE PLAN SHALL AT A MINIMUM COMPLY WITH THE FOLLOWING:

SILT FENCE: MAINTAIN PER FDOT SECTION 104 OF THE SPECIFICATIONS. THE CONTRACTOR SHOULD ANTICIPATE REPLACING SILT FENCE ON 6 MONTH INTERVALS.

SEDIMENT BARRIERS: REMOVE SEDIMENT AS PER MANUFACTURER'S RECOMMENDATIONS OR WHEN WATER PONDS IN UNACCEPTABLE AMOUNTS OR AREAS.

FLORIDA EROSION AND SEDIMENT CONTROL MANUAL.

5.0 INSPECTIONS:

QUALIFIED PERSONNEL SHALL INSPECT THE FOLLOWING ITEMS AT LEAST ONCE EVERY SEVEN CALENDAR DAYS AND WITHIN 24 HOURS OF THE END OF A STORM THAT IS 0.5 INCHES PRECIPITATION OR GREATER. TO COMPLY THE CONTRACTOR SHALL INSTALL AND MAINTAIN RAIN GAUGES AND RECORD THE DAILY RAINFALL. WHERE SITES HAVE BEEN PERMANENTLY STABILIZED INSPECTIONS SHALL BE CONDUCTED AT LEAST ONCE EVERY MONTH. THE CONTRACTOR SHALL ALSO INSPECT THAT CONTROLS INSTALLED IN THE FIELD AGREE WITH THE LATEST STORMWATER POLLUTION PREVENTION PLAN.

THE CONTRACTOR SHALL INITIATE REPAIRS WITHIN 24 HOURS OF INSPECTIONS THAT INDICATE ITEMS ARE NOT IN GOOD WORKING ORDER.

IF INSPECTIONS INDICATE THAT THE INSTALLED STABILIZATION AND STRUCTURAL PRACTICES ARE NOT SUFFICIENT TO MINIMIZE EROSION, RETAIN SEDIMENT, AND PREVENT DISCHARGING POLLUTANTS, THE CONTRACTOR SHALL PROVIDE ADDITIONAL MEASURES. AS APPROVED BY THE ENGINEER.

6.0 NON-STORMWATER DISCHARGES

THE CONTRACTOR SHALL BE RESPONSIBLE FOR REPORTING ANY HAZARDOUS SUBSTANCE SPILLS THAT MAY EQUAL OR EXCEED A REPORTABLE QUANTITY (RQ). REFER TO EPA'S LIST OF HAZARDOUS SUBSTANCES AND REPORTABLE QUANTITIES (EPA 40 CFR 302.4 & 117). THIS LIST CAN BE OBTAINED FROM EPA'S WEBSITE (WWW.EPA.GOV) OR BY CONTACTING EPA. IF AN RQ RELEASE DOES OCCUR THE CONTRACTOR SHALL PERFORM THE FOLLOWING PROCEDURES:

NOTIFY THE NATIONAL RESPONSE CENTER IMMEDIATELY AT 800-424-8802.

PROVIDE WRITTEN DESCRIPTION OF THE RELEASE WITHIN 14 DAYS PROVIDING DATES, CAUSE AND PREVENTION METHODS TO THE REGIONAL EPA OFFICE.

MODIFY THE SWPPP AS NECESSARY TO ADDRESS ADDED PREVENTION METHODS.

7.0 IMPLEMENTATION CHECKLIST:

7.1 RECORDS:

THE CONTRACTOR SHALL MAINTAIN RECORDS OF CONSTRUCTION ACTIVITIES INCLUDING, BUT NOT LIMITED TO:

DATES WHEN MAJOR GRADING ACTIVITIES OCCUR.

DATES WHEN CONSTRUCTION ACTIVITIES TEMPORARILY CEASE ON A PORTION OF THE SITE.

DATES WHEN CONSTRUCTION ACTIVITIES PERMANENTLY CEASE ON A PORTION OF THE SITE.

DATES WHEN STABILIZATION MEASURES ARE INITIATED ON THE SITE.

7.2 INSPECTION REPORTS:

THE CONTRACTOR SHALL PREPARE INSPECTION REPORTS SUMMARIZING THE FOLLOWING, BUT NOT LIMITED TO:

NAME OF INSPECTOR.

• QUALIFICATIONS OF INSPECTOR.

MEASURES/AREAS INSPECTED.

OBSERVED CONDITIONS.

CHANGES NECESSARY TO THE SWPPP.

7.3 RELEASES OF REPORTABLE QUANTITIES OF OIL OR HAZARDOUS MATERIALS:

THE CONTRACTOR SHALL REPORT ANY RELEASES OF REPORTABLE QUANTITIES OF OIL OR HAZARDOUS MATERIALS IF THEY OCCUR AS PER THE MEASURES OUTLINED IN SECTION 6.0 OF THE SWPPP.

7.4 SWPPP MODIFICATION:

THE CONTRACTOR SHALL MODIFY THE SWPPP AS NECESSARY TO:

- COMPLY WITH MINIMUM PERMIT REQUIREMENTS WHEN NOTIFIED BY FDEP THAT THE PLAN DOES NOT COMPLY.
- . ADDRESS ANY CHANGES IN DESIGN, CONSTRUCTION OPERATIONS OR MAINTENANCE. WHICH HAS AN EFFECT ON THE POTENTIAL FOR DISCHARGE OF POLLUTANTS.
- PREVENT REOCCURRENCE OF REPORTABLE QUANTITY RELEASES OF HAZARDOUS MATERIAL * OR OIL.

8.0 TERMINATION CHECKLIST:

THE FOLLOWING ITEMS SHALL BE COMPLETE BEFORE SUBMITTING THE NOT:

- ALL SOIL DISTURBING ACTIVITIES ARE COMPLETE.
- TEMPORARY EROSION AND SEDIMENT CONTROL MEASURES HAVE BEEN REMOVED. OR WILL BE REMOVED AT AN APPROPRIATE TIME.
- ALL AREAS OF THE CONSTRUCTION SITE NOT OTHERWISE COVERED BY PERMANENT PAVEMENT OR STRUCTURE HAVE BEEN STABILIZED WITH UNIFORM PERENNIAL VEGETATIVE COVER WITH A DENSITY OF 70% OR EQUIVALENT MEASURES HAVE BEEN EMPLOYED.

10748 Deerwood Park Blvd. South Jacksonville, Florida 32256-0597 904-256-2500 Fax 904-256-2503

FL Cert. Nos. AAC001886 * IB26000956 EB0005620 * LCC000210 * GB238

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PENSACOLA INTERNATIONAL **AIRPORT**

PENSACOLA, FLORIDA

PENSACOLA GENERAL AVIATION FACILITY (GAF)

IN COLLABORATION WITH:



BASKERVILLE-DONOVAN, INC. 449 W. MAIN ST.

PENSACOLA, FLORIDA 32502 (850)438-9661 Engineering Business: EB-0000340 PROFESSIONAL SEAL

JASON J. FRICK P.E.

FL Reg. Engineer #86469 REVISIONS

NO.	DESCRIPTION	DATE

DATE ISSUED: 03/03/2020 **REVIEWED BY:** MDL RGG DRAWN BY: **DESIGNED BY:** JJF PROJECT NUMBER:

201-0052-002

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SHEET TITLE

SWPPP PLAN

SHEET NUMBER

BID DOCUMENTS

C904

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PLANT S	CHEE	DULE					
TREES	CODE	QTY	BOTANICAL / COMMON NAME	CONT	CAL	SIZE	
	СС	6	Cercis canadensis / Eastern Redbud	30 gal			
£ • }	QV	3	Quercus virginiana / Southern Live Oak	B & B	4"Cal		
C. Frank	SS2	2	Sabal palmetto / Cabbage Palmetto	B & B		10` CT	
	SS1	2	Sabal palmetto / Cabbage Palmetto	B & B		12` CT	
Norman Samura Sa	SS3	2	Sabal palmetto / Cabbage Palmetto	B & B		15` CT	
igoredown	VC	2	Vitex agnus-castus / Chaste Tree	30 gal			
SHRUBS	CODE	QTY	BOTANICAL / COMMON NAME	CONT	SIZE	SPEC	SPACING
\bigoplus	AA4	84	Azalea Encore `Autumn Coral` TM / Autumn Coral Azalea	3 gal		Full Pot	36" o.c.
£33	DV	175	Daniellia tasmanica `Variegata` / Varigated Flax Lily	3 gal		Full Pot	24" o.c.
Every)	IN	159	Ilex vomitoria `Nana` / Dwarf Yaupon	3 gal		FULL POT	36" o.c.
	MU	38	Muhlenbergia capillaris / Pink Muhly	3 gal		FULL POT	36" o.c.
\bigcirc	PM	10	Podocarpus macrophyllus maki / Shrubby Yew	3 gal		FTB, SP	60" o.c.
\odot	TD	85	Tripsacum dactyloides nana / Dwarf Fakahatchee Grass	3 gal		FULL POT	48" o.c.
TURFGRASS	CODE	QTY	BOTANICAL / COMMON NAME	CONT	SIZE	SPAC	SPACING
\(\psi \)	PA	20,659 sf	Paspalum notatum `Argentine` / Bahia Grass	SOD			

NOTE: CONTRACTOR SHALL SOD TO LIMITS OF DISTURBANCE WITH BAHIA GRASS. CONTRACTOR IS RESPONSIBLE FOR THE EXACT QUANTITY OF BAHIA TO BE SODDED.

970

TAXIWAY C2



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PENSACOLA INTERNATIONAL AIRPORT

PENSACOLA, FLORIDA

PENSACOLA
GENERAL
AVIATION
FACILITY (GAF)

IN COLLABORATION WITH:





PROFESSIONAL SEAL

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REVIEWED BY: S
DRAWN BY: E
DESIGNED BY: E

PROJECT NUMBER:

201-0052-002

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SHEET TITLE


LANDSCAPE PLAN

SHEET NUMBER

L101

NORTH

1 INCH = 20 FT.

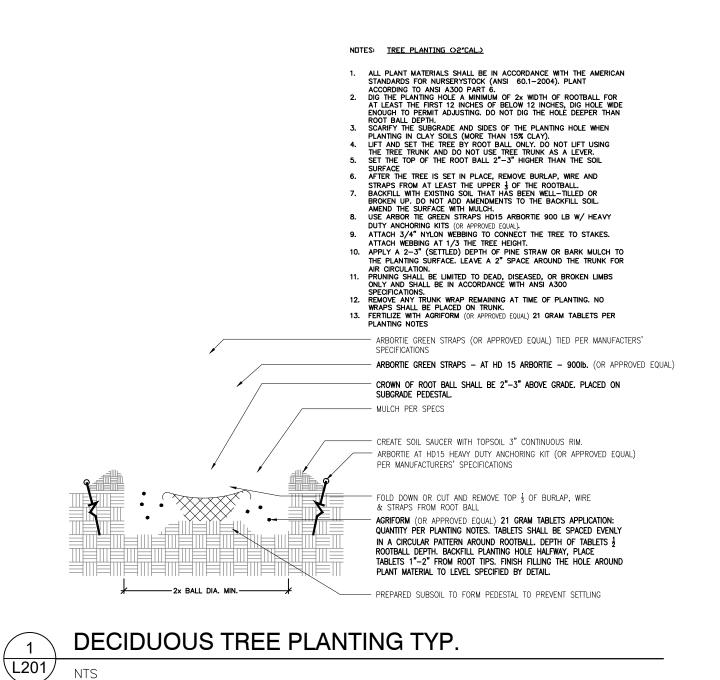

ET ROOTBALL CROWN 1"-2" HIGHER THAN SURROUNDING FINISHED GRADE. SLOPE FINISHED GRADE AT BACKFILL AWAY FROM MULCH PER SPECS CREATE SOIL SAUCER WITH TOPSOIL 1"-2" CONTINUOUS RIM. PRUNE DAMAGED OR DESICCATED ROOTS. BACKFILL WITH A MIXTURE OF PLANTING PIT SPOIL & PREPARED PLANTING SOIL, PER SPECS, FROM ADJACENT PLANTING AREA PLANTING TABLETS, AGRIFORM, PER MANUF AGRIFORM 21 GRAM TABLETS APPLICATION BE SPACED EVENLY IN A CIRCULAR PATTERN AROUND ROOTBALL DEPTH OF TABLETS \$ 3X ROOTBALL DIAM. ROOTBALL DEPTH. BACKFILL PLANTING HOL HALFWAY, PLACE TABLETS 1"-2" FROM ROOT TIPS, FINISH FILLING THE HOLE AROUND PLANT MATERIAL TO LEVEL SPECIFIED BY DETAIL.



SHRUB PLANTING - BARE ROOT

A DISTANCE OF 1'.

TYPICAL SPACING DETAIL

igtriangled spaced in rows parallel to the straight edge.

ASPH. /ROAD TYP.

1. LANDSCAPE ARCHITECTURE GENERAL PROJECT NOTES & SPECS

1.1. EXISTING SITE CONDITIONS PROVIDED BY OTHERS.

1.2. ALL DIMENSIONS SHOWN ON THE PLANS SHALL BE FIELD VERIFIED BY THE CONTRACTOR PRIOR TO CONSTRUCTION. THE CONTRACTOR SHALL NOTIFY THE LANDSCAPE ARCHITECT IF ANY DISCREPANCIES EXIST PRIOR TO PROCEEDING WITH CONSTRUCTION FOR NECESSARY PLAN CHANGES. NO EXTRA COMPENSATION SHALL BE PAID TO THE CONTRACTOR FOR WORK HAVING TO BE REDONE DUE TO DIMENSIONS OR GRADES SHOWN INCORRECTLY ON THESE PLANS IF SUCH NOTIFICATION HAS NOT BEEN GIVEN.

1.3. THE CONTRACTOR IS TO COORDINATE WITH THE RESPONSIBLE UTILITY PROVIDER FOR PROTECTION/HOLDING OF UTILITY POLES, GUY WIRES, AND GUY ANCHORS IN AREAS OF CONSTRUCTION. THE CONTRACTOR SHALL INCLUDE THE COST OF PROTECTING UTILITY POLES IN THEIR OVERALL PRICE TO THE OWNER/OWNER'S REPRESENTATIVE.

1.4. ALL EXCESS MATERIAL SHALL BE HAULED AWAY AND DISPOSED OF APPROPRIATELY AT THE CONTRACTOR'S EXPENSE IN

ACCORDANCE WITH ALL LOCAL, STATE AND FEDERAL ORDINANCES. 1.5. RELOCATION OR REPLACEMENT OF OBSTRUCTIONS OWNED BY PRIVATE PROPERTY OWNER SHALL BE THE

RESPONSIBILITY OF THE CONTRACTOR WHO MUST COORDINATE WITH THE PROPERTY OWNER. 1.6. THE CONTRACTOR SHALL MAINTAIN TRAFFIC CONTROL IN ACCORDANCE WITH FDOT STANDARD PLANS (LATEST EDITION), FDOT STANDARD SPECIFICATIONS FOR ROAD AND BRIDGE CONSTRUCTION (LATEST EDITION) AND IN

2. DEMOLITION NOTES:

2.1. ALL DEBRIS RESULTING FROM PROPOSED DEMOLITION WILL BE DISPOSED OF IN A LEGAL MANNER AND WILL CONFORM TO ANY AND ALL STATE AND LOCAL REGULATIONS AND/OR ORDINANCES WHICH GOVERN SUCH ACTIVITIES. 2.2. THE CONTRACTOR IS TO FIELD VERIFY THE LOCATION OF EXISTING UTILITIES AND COORDINATE RELOCATION WITH THE APPROPRIATE UTILITY OWNER AS NECESSARY. ANY AND ALL UTILITIES ENCOUNTERED DURING DEMOLITION WILL BE

PROTECTED AND/OR RELOCATED AT THE DISCRETION OF THEIR PROSPECTIVE OWNERS. 2.3. NO DEMOLITION DEBRIS WILL BE STOCKPILED OR GATHERED ON THE PROJECT SITE OR ADJACENT PROPERTIES WITHOUT PRIOR WRITTEN AUTHORIZATION BY THE LANDSCAPE ARCHITECT.

3. MATERIALS

3.1. MATERIALS LISTED UNDER THIS SECTION ARE EXPRESSLY SPECIFIED FOR USE BUT DOES NOT PROHIBIT OR RESTRICT THE CONTRACTOR FROM PROVIDING OTHER APPROVED MATERIALS NOT LISTED IN ORDER TO COMPLETE THE WORK REQUIRED HEREIN. ALL MATERIALS SHALL BE NEW AND IN PERFECT CONDITION.

3.2. IRRIGATION SYSTEM MATERIALS: ALL PARTS, PIECES, COMPONENTS AND PRODUCTS SHALL BE OF NEW, UNUSED,

THE IRRIGATION SYSTEM COMPONENTS SHALL COMPLY WITH THOSE FOUND ON PERMIT DOCUMENT'S IRRIGATION 6.2. PLAN(S) UNLESS OTHERWISE APPROVED IN WRITING BY THE LANDSCAPE ARCHITECT. 3.3. PLANT MATERIAL: ALL PLANT MATERIAL SHALL BE FLORIDA NO. 1 OR BETTER, UNLESS OTHERWISE NOTED, AS SET FORTH

IN THE CURRENT EDITION OF THE 'GRADES AND STANDARDS FOR NURSERY PLANTS,' STATE OF FLORIDA.

3.4. PRE-EMERGENCE WEED CONTROL: CONTRACTOR OPTION (GRANULAR)

3.5. POST-EMERGENCE WEED CONTROL: CONTRACTOR OPTION

3.6. HERBICIDE: CONTRACTOR OPTION.

3.7. INSECTICIDE: CONTRACTOR OPTION.

3.8. FUNGICIDE: CONTRACTOR OPTION.

3.9. SHRUB BED FERTILIZER: AGRIFORM TABLETS PER MANUFACTURER'S RECOMMENDED RATES FOR EACH PLANT USED. 3.10. LAWN FERTILIZER: N/A

3.11. TREE FERTILIZER: AGRIFORM (OR APPROVED EQUAL) 21 GRAM TABLETS. APPLIED PER MANUFACTURER SPECIFICATIONS.

3.12. MULCH: NATURAL PINE STRAW - 3" MINIMUM DEPTH. 3.13. TREE STAKES AND GUYS: ARBORTIE HD-15 OR APPROVED EQUAL APPROVED IN FDOT STANDARD PLANS (LATEST

4. LANDSCAPE GENERAL NOTES

4.1. ALL CONSTRUCTION SHALL BE IN ACCORDANCE WITH THE PLANS AND WRITTEN NOTES. NO SUBSTITUTIONS SHALL BE MADE WITHOUT PRIOR WRITTEN APPROVAL BY THE LANDSCAPE ARCHITECT, JERRY PATE DESIGN.

4.2. WRITTEN DIMENSIONS SHALL TAKE PRECEDENCE OVER SCALED DIMENSIONS. THE CONTRACTOR SHALL VERIFY AND B RESPONSIBLE FOR ALL DIMENSIONS AND CONDITIONS ON THE JOB. THE LANDSCAPE ARCHITECT SHALL BE NOTIFIED OF ANY VARIATION FROM THE DIMENSIONS AND CONDITIONS SHOWN ON THE PLANS.

4.3. LANDSCAPE MATERIALS SHALL BE ADJUSTED IN THE FIELD TO AVOID CONFLICTS WITH ANY PROPOSED OR REMAINING UTILITY STRUCTURES, DRAINAGE STRUCTURES, DITCHES, UNDER DRAINS, DITCH BLOCKS, STORM WATER FACILITIES AND DRAINAGE DISCHARGE PATHS, EXISTING SIGNÁGE, AND ÉXISTING LIGHTING AND THEIR ÁPPURTENANCES. THE CONTRACTOR SHALL NOT INSTALL THE PROPOSED IMPROVEMENTS IF A CONFLICT EXISTS. ANY COSTS TO REMOVE AND/OR REPAIR WORK ADJUSTED THAT HAS NOT BEEN APPROVED PREVIOUSLY BY THE LANDSCAPE ARCHITECT SHALL BE 6.7.1.

4.4. LANDSCAPE IMPROVEMENTS SHALL BE INSTALLED BY THE CONTRACTOR IN ACCORDANCE WITH THE MOST CURRENT "FDOT DESIGN MANUAL - CHAPTER 329 LANDSCAPE PLANS".

4.5. PLANT QUANTITIES SHOWN ON THE LANDSCAPE PLAN ARE MINIMUM ONLY. THE CONTRACTOR IS RESPONSIBLE FOR THE CONTRACTOR'S OWN QUANTITY TAKE-OFF AND SHALL PROVIDE ALL PLANT MATERIAL REQUIRED TO FILL THE PLANTING BEDS TO MEET DESIGN INTENT

4.6. PROTECTION OF EXISTING TREES TO REMAIN SHALL BE IN ACCORDANCE WITH THE MOST CURRENT "FDOT DESIGN MANUAL - CHAPTER 329 LANDSCAPE PLANS" AND ALL OTHER PLANTING SPECIFICATIONS INCLUDED IN THE PERMIT

4.7. THE CONTRACTOR SHALL ENSURE, PRIOR TO MOVING ON SITE, ALL EQUIPMENT WHICH LAST OPERATED IN PLACES KNOW TO BE INFESTED WITH NOXIOUS WEEDS IS FREE OF SOIL, SEEDS, VEGETATIVE MATTER, OR OTHER DEBRIS THAT COULD CONTAIN OR HOLD SEEDS.

4.8. THE CONTRACTOR SHALL NOT BRING ANY HAZARDOUS MATERIALS ONTO THE JOB SITE. IF ANY KNOWN OR SUSPECTED HAZARDOUS MATERIAL IS FOUND ON THE PROJECT, THE CONTRACTOR SHALL IMMEDIATELY NOTIFY THE LANDSCAPE

4.9. ANY PUBLIC LAND SURVEY SYSTEM CORNER OR ANY MONUMENT THAT PERPETUATES THE RIGHT-OF-WAY WITHIN THE LIMITS OF CONSTRUCTION IS TO BE PROTECTED BY THE CONTRACTOR. IF A MONUMENT IS IN DANGER OF BEING DESTROYED AND HAS NOT BEEN PROPERLY REFERENCED, THE CONTRACTOR SHOULD NOTIFY THE LANDSCAPE ARCHITECT.

5. PLANTING BED PREPARATION

5.1. ALL TRASH, ASPHALT, CONCRETE SIGNAGE, WEEDS AND OTHER SPOILAGE SHALL BE REMOVED FROM SITE PRIOR TO MOBILIZATION OF PLANTING CONTRACTOR. 5.2. ALL AREAS TO BE PLANTED OR SODDED SHALL BE GRADED TO SITE SPECIFICATIONS PRIOR TO MOBILIZATION OF

5.3. CONTRACTOR SHALL CONFIRM ALL PLANTING BEDS ARE NOT COMPACTED BEYOND 85 PERCENT TO ENSURE DRAINAGE. SHOULD COMPACTED SOILS EXIST, SOILS SHALL BE EXCAVATED AND REPLACED WITH WELL-DRAINING SOIL PRIOR TO MOBILIZATION OF PLANTING CONTRACTOR. NO PARKING LOT SUB-BASE, ASPHALT MATERIAL OR CONCRETE SPOILS

SHALL REMAIN IN PLANTING BEDS. 5.4. ALL EXISTING VEGETATION SHALL BE REMOVED IN ALL PLANTING BED AREAS UNLESS OTHERWISE NOTED ON THE PLANS. 8.3. PLANT MATERIAL HERBICIDE MANUFACTURER SPECIFICATIONS AND INSTRUCTIONS SHALL BE FOLLOWED AS TO TREATMENT DILUTION, MIX, APPLICATION, AND TIME PERIODS BETWEEN APPLICATIONS AS APPLICABLE TO ASSURE WEEDS ARE ELIMINATED FROM THE PLANTING BEDS PRIOR TO COMMENCING PLANTING. ALL PERSONNEL INVOLVED IN THE CHEMICAL PROGRAM ARE TO RECEIVE THE PROPER TRAINING AND LICENSURE. AND FOLLOW THE OPERATING GUIDELINES. PROVIDED BY FDOT FOR CHEMICAL CONTROL. CONTACT THE ESCAMBIA COUNTY EXTENSION SERVICE FOR ADDITIONAL

INFORMATION REGARDING HERBICIDES, PESTICIDES, AND REQUIRED LICENSES. ALL SOIL AMENDMENTS SHALL BE ADDED TO THE PLANTING BEDS AND INCORPORATED INTO THE SOIL PRIOR TO COMMENCING FINAL GRADING AND PLANTING. ALL BEDS SHALL BE GRADED TO PROVIDE POSITIVE DRAINAGE WITH NO

AREAS WHERE STANDING WATER COULD OCCUR. 5.6. ALL PLANTING BED AREAS SHALL BE TREATED WITH A PRE-EMERGENT HERBICIDE TO ENSURE THAT WEEDS WILL BE CONTROLLED.

6. PLANTING NOTES 6.1. THE LANDSCAPE INSTALLATION MUST BE PROPERLY SEQUENCED WITH OTHER CONSTRUCTION SO THAT THE LANDSCAPE IS NOT DAMAGED BY OTHER WORK/TRADES AND VICE VERSA.

. THE CONTRACTOR SHALL VERIFY THE EXISTENCE OF AND STAKE ALL UTILITIES PRIOR TO CONSTRUCTION. EXCAVATION OF PLANT PITS LOCATED WITHIN 5' OF UTILITIES SHALL BE PERFORMED BY HAND. ANY UTILITY AND PLANT MATERIAL CONFLICTS SHALL BE BROUGHT TO THE ATTENTION OF THE LANDSCAPE ARCHITECT PRIOR TO INSTALLATION, OR FIELD

6.3. ALL PLANTS SHALL MEET SIZE, CONTAINER, AND SPACING SPECIFICATIONS AS SHOWN IN THE PERMIT DOCUMENTS. THE CONTRACTOR SHALL GUARANTEE PLANT HEALTH AND SURVIVABILITY FOR ONE YEAR FROM DATE OF PROJECT ACCEPTANCE BY THE LANDSCAPE ARCHITECT. ANY MATERIAL NOT MEETING SPECIFICATIONS OR DISPLAYING POOR HEALTH SHALL BE REPLACED AT CONTRACTOR'S EXPENSE WITHIN TWO WEEKS OF NOTICE.

6.3.1. INSTALLED PLANT MATERIAL NOT MEETING SPECIFICATIONS SHALL BE REMOVED AND REPLACED AT CONTRACTOR'S EXPENSE.

6.3.2. ALL PLANTS MUST BE BROUGHT TO THE SITE FREE OF WEEDS. <u>ALL PLANT MATERIALS INDICATED</u> WITH A GALLON SIZE SHALL BE CONTAINER GROWN AND WITHIN A CONTAINER

6.3.3.1. ROOT BOUND PLANTS SHALL NOT BE ACCEPTED. 6.3.4. NO SUBSTITUTIONS SHALL BE PERMITTED WITHOUT PRIOR APPROVAL OF THE LANDSCAPE ARCHITECT. 6.4. THE LANDSCAPE ARCHITECT RESERVES THE RIGHT TO MAKE PLANTING BED FIELD CHANGES TO ACCOMMODATE SITE CONDITIONS AND TO ACHIEVE THE DESIGN INTENT. THE CONTRACTOR SHALL FLAG ALL TREE AND BED LINE LOCATIONS

FOR APPROVAL OF LANDSCAPE ARCHITECT PRIOR TO ANY INSTALLATION. 6.5. THE CONTRACTOR IS ULTIMATELY RESPONSIBLE FOR ALL APPROPRIATE SOIL AMENDMENTS AND A PROPERLY PREPARED FINISHED SOIL LAYER IN ACCORDANCE WITH CURRENT FDOT STANDARD PLANS FOR ROAD CONSTRUCTION.

6.6. THE CONTRACTOR SHALL REPAIR OR REPLACE ANY EXISTING VEGETATION INTENDED TO REMAIN THAT IS DISTURBED BY PLANT MATERIAL INSTALLATION ACTIVITIES. THIS REPAIR / REPLACEMENT SHALL BLEND SEAMLESSLY WITH THE EXISTING

6.7. ALL PLANT MATERIAL MUST BE PLANTED IMMEDIATELY UPON DELIVERY TO THE SITE AND WATERED IN, BY HAND IF THE RRIGATION SYSTEM IS NOT YET FUNCTIONING PROPERLY. ANY PLANT MATERIAL NOT INSTALLED WITHIN 6 HOURS OF DELIVERY TO THE SITE MUST BE STORED IN AN APPROVED, PROTECTED HOLDING AREA AND SHALL BE WATERED AS ECESSARY TO MAINTAIN PLANT HEALTH AND QUALITY. ALL BLACK PLASTIC PLACED AROUND TREE ROOTBALLS SHALL BE REMOVED IMMEDIATELY UPON DELIVERY TO THE SITE.

TREES NOT PLANTED WITHIN 6 HOURS OF DELIVERY TO THE SITE: WATER SHALL BE IMMEDIATELY APPLIED TO THE ROOTBALL AND FOLIAGE. THE TOPS SHALL BE UNTIED AND THE TREES STORED UPRIGHT WITH MULCH COVERING THE ROOTBALLS.

6.7.2. TREES SHALL NOT BE STORED LYING DOWN.

6.7.3. IF TREES HAVE PLASTIC TRUNK PROTECTORS, THE PROTECTORS MAY STAY IN PLACE PRIOR TO PLANTING BUT SHALL NOT BE LEFT ON INDEFINITELY.

6.8. PLANT SHRUBS IN CIRCULAR PITS WITH A DIAMETER 3X DIAMETER OF ROOTBALL OR CONTAINER.

6.9. THE CONTRACTOR SHALL BE RESPONSIBLE FOR MAINTAINING ALL PLANTING AND GRADES UNTIL FINAL ACCEPTANCE. THIS MAINTENANCE INCLUDES: KEEPING BEDS FREE OF DEBRIS, WEEDS, DISEASES, AND INFESTATIONS.

6.10. THE CONTRACTOR IS RESPONSIBLE FOR PROVIDING SUFFICIENT WATER TO THE PLANTS DURING THIS TIME AND REPAIRING ERODED AREAS WITHIN THE LANDSCAPE SCOPE.

6.11. THE CONTRACTOR SHALL PROVIDE A ONE YEAR WARRANTY ON ALL PLANTS AND LABOR BEGINNING UPON FINAL

ACCEPTANCE OF THE PROJECT.

6.12. A FINAL WALK-THROUGH SHALL NOT BE PERFORMED IF PREVIOUS PUNCH LISTS ARE NOT COMPLETED

7.2. THE CONTRACTOR SHALL NOTIFY ALL UTILITIES TWO BUSINESS DAYS PRIOR TO DEMOLITION AND/OR EXCAVATION. CALL

SHRUBS AND GROUNDCOVERS ADJACENT TO STRAIGHT EDGES SHALL BE TRIANGULAR -

SHRUBS AND GROUNDCOVERS ADJACENT TO CURVED EDGES SHALL BE PLANTED IN

ROWS PARALLEL TO THE CURVED EDGES. CURVED EDGES TO BE VERY SMOOTH RADII.

FIRST ROW OF SHRUBS ADJACENT TO CURB, BEDLINES & CONCRETE SHALL BE A OFFSET

SIDEWALK/CONC./PAVING

7.3. THE CONTRACTOR SHALL COORDINATE WITH THE UTILITY COMPANIES DURING CONSTRUCTION.

7.4. NO UTILITY IS TO BE RELOCATED.

8. SUBMITTALS REQUIRED 8.1. SUBMITTALS REQUIRED SHALL BE SUBMITTED TO THE LANDSCAPE ARCHITECT FOR REVIEW.

8.2. THE CONTRACTOR IS RESPONSIBLE FOR CONTACTING THE LANDSCAPE ARCHITECT TO REVIEW THE HARDSCAPE LAYOUT

THE CONTRACTOR SHALL PROVIDE THE LANDSCAPE ARCHITECT WITH REPRESENTATIVE PLANT PHOTOS TO APPROVE FOR ALL PLANT MATERIALS PRIOR TO ANY PLANT DELIVERY. MEASURING STICKS SHALL BE SHOWN IN

PHOTOS, AS APPROPRIATE. THE CONTRACTOR SHALL NOTIFY THE LANDSCAPE ARCHITECT A MINIMUM OF 48 HOURS PRIOR TO COMPLETION TO SCHEDULE A FINAL WALK-THROUGH.

8.3.3. ALL CERTIFICATIONS & LITERATURE ASSOCIATED WITH SIZE, HEALTH AND BRAND.

A FINAL WALK-THROUGH SHALL NOT BE PERFORMED IF PREVIOUS PUNCH LISTS ARE NOT COMPLETED. 8.4. THE CONTRACTOR SHALL CONDUCT REPRESENTATIVE SOIL ANALYSIS PRIOR TO THE INSTALLATION OF ANY PLANT

8.4.1. SUBMIT ALL SOIL SAMPLES AND AMENDMENT RECOMMENDATIONS TO THE LANDSCAPE ARCHITECT FOR REVIEW. THE SOIL SAMPLE TEST RESULTS SHALL INCLUDE, AT A MINIMUM, PH, PRIMARY MACRONUTRIENTS, MICRONUTRIENTS, PERCENTAGE OF ORGANIC MATTER, AND SOIL TEXTURE.

THE LOCATIONS OF THE UTILITIES SHOWN ON THE PLANS SHOULD BE CONSIDERED APPROXIMATE ONLY, AND INTERPOLATIONS BETWEEN THESE POINTS HAVE NOT BEEN VERIFIED.

"SUNSHINE STATE ONE CALL SYSTEM" (OR 811) SO THAT UNDERGROUND UTILITIES MAY BE FIELD LOCATED.

7.5. PLANTING SHALL BE ADJUSTED HORIZONTALLY, AT THE DIRECTION OF THE LANDSCAPE ARCHITECT, TO ADDRESS ANY UTILITY CONFLICTS.

NOTIFY THE LANDSCAPE ARCHITECT A MINIMUM OF ONE WEEK PRIOR TO PLANT DELIVERY TO SCHEDULE ON-SITE

THE CONTRACTOR SHALL NOTIFY THE LANDSCAPE ARCHITECT OF ANY IMPROPER SOIL CONDITION INCLUDING NUTRITIONAL DEFICIENCIES, WETNESS, MUCK, DEBRIS, ETC. AND SHALL RECOMMEND TO THE LANDSCAPE ARCHITECT, PRIOR TO INSTALLATION, ALL SOIL AMENDMENTS THAT MAY BE NECESSARY TO PROMOTE HEALTHY VIGOROUS PLANT GROWTH.

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PENSACOLA INTERNATIONAL **AIRPORT**

PENSACOLA, FLORIDA

PENSACOLA GENERAL **AVIATION** FACILITY (GAF)

IN COLLABORATION WITH:





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DATE ISSUED: 03/03/2020 **REVIEWED BY:** DRAWN BY: **DESIGNED BY:**

201-0052-002

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PROJECT NUMBER:

LANDSCAPE **DETAILS**

SHEET NUMBER

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PENSACOLA INTERNATIONAL **AIRPORT**

PENSACOLA, FLORIDA

PENSACOLA GENERAL AVIATION FACILITY (GAF)

IN COLLABORATION WITH:





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REVISIONS
KEVISIONS

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DATE ISSUED: 03/03/2020 **REVIEWED BY:** DRAWN BY: DESIGNED BY:


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SHEET TITLE

IRRIGATION PLAN

SHEET NUMBER

LI101

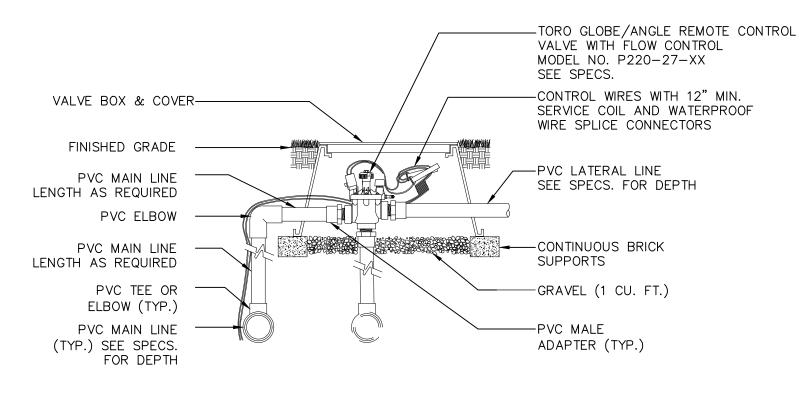

SECTION/ELEVATION

1. INSTALL SPRINKLER AT FINISHED GRADE. 2. INSTALLATION TO BE COMPLETED IN ACCORDANCE WITH MANUFACTURER'S SPECIFICATIONS.

TORO P-220 SERIES VALVE - PRESSURE REG. [1201] - 10" DIAMETER VALVE BOX. COIL 24" TO 30" OF DRIP TUBING IN THE BOX. ½" DRIP TUBING TO ¾" FPT ĀDAPTER. 7 34" PVC BALL VALVE WITH SHORT NIPPLE. SET VALVE BOX 2" ABOVE ½" DRIP TUBING. FINISHED GRADE OF SHRUB GEOTEXTILE FABRIC 4" THICK LAYER OF WASHED GRAVEL. THE BOX SHALL REST UPON THE ROCK BED. DO NOT


> 1. INSTALL (1) FLUSH VALVE AT THE END OF EACH 3/4" TUBING 2 ENSURE THAT THE COILED DRIP TUBING IS OF SUFFICIENT LENGTH TO COMPLETELY EXTEND 3' OUT OF THE VALVE BOX WHEN FLUSHING.

EXTEND GRAVEL INTO BOX.


1201

DRIP FLUSH-BALL VALVE ASSEMBLY

FLOOD BUBBLER, TORO FB-XX-PC, Or Approved Eq. (2) FINISH GRADE (3) LANDSCAPE STAPLE (4) FUNNY PIPE (5) LATERAL LINE PIPING (6) LATERAL LINE PIPE FITTING

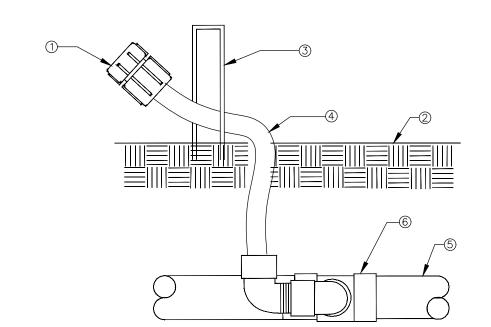



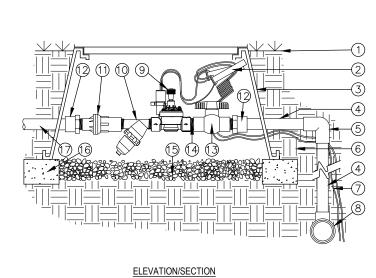

② CONTROL WIRES WITH 36" SERVICE COIL AND WATER PROOF WIRE CONNECTIONS, DBY OR EQUAL 3 RECTANGULAR PLASTIC VALVE BOX. HEAT BRAND STATION NUMBER ON LID IN 2" HIGH CHARACTERS. 4 PVC MAINLINE PER SPECIFICATIONS (LENGTH AS REQUIRED). 5 SCH 40 PVC ELL (SxS).

LEGEND:

① FINISH GRADE.

NATIVE SOIL PER SPECIFICATIONS. CONTROL WIRES TO CONTROLLER. BPVC MAINLINE FITTING. ${f @}$ TORO TPVF100 INLINE VALVE (*). TORO 150 MESH Y-FILTER (*). 🛈 TORO 25 PSI LOW FLOW PRÈŚSURE REGULATOR (*). ② SCH 40 PVC MALE ADAPTER. ③ SCH 40 PVC BALL VALVE (*). ⊕ SCH 80 PVC CLOSE NIPPLE (*).

(5) PEA GRAVEL SUMP, MINIMUM 6" DEEP. 6 BRICK SUPPORTS (4 COMMON BRICKS REQUIRED). () LATERAL LINE TO DRIP SYSTEM. (*) PARTS IN DRIP ZONE KIT.


NOTES:

1. INSTALLATION TO BE COMPLETED IN ACCORDANCE WITH MANUFACTURER'S SPECIFICATIONS. 2. DO NOT SCALE DRAWING.
DZK-TPV-1-MF


TORO DRIP KIT - DZK-TPV-1MF 2 | 1201

MIN. FLOW RATE - 2.0 GPM


MAX. FLOW RATE - 20.0 GPM

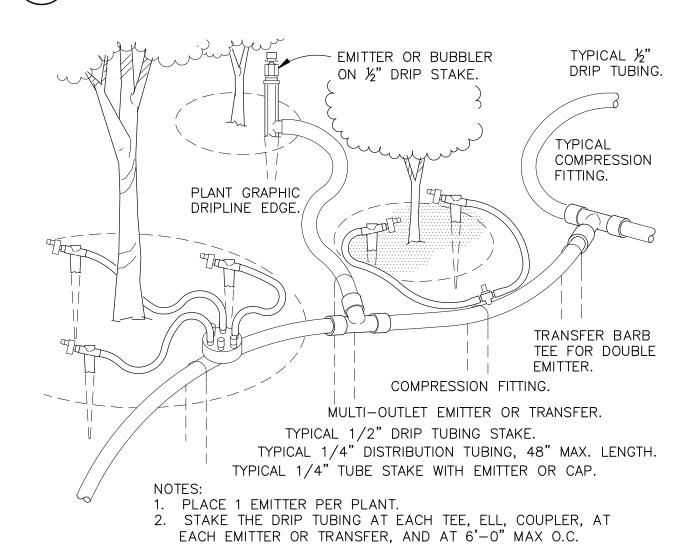



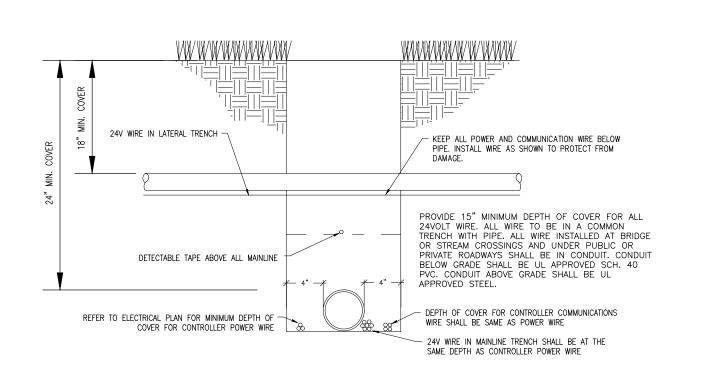




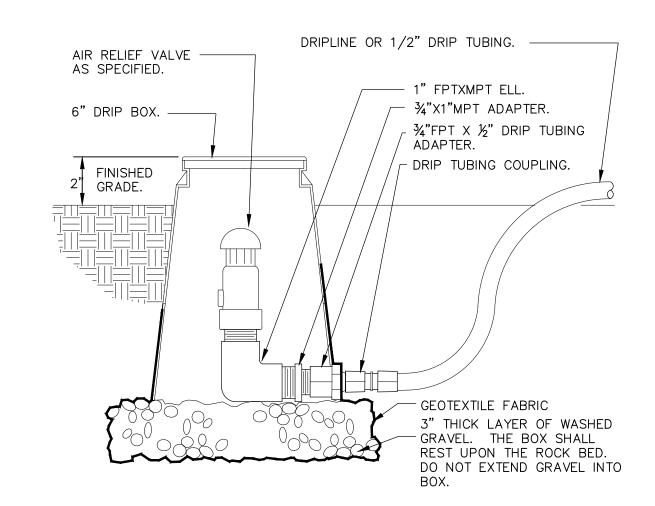

1. INSTALL MIN. (1) AIR RELIEF VALVE PER ZONE.


(3) (1201)

DRIP AIR RELIEF VALVE-IN 6" ROUND BOX

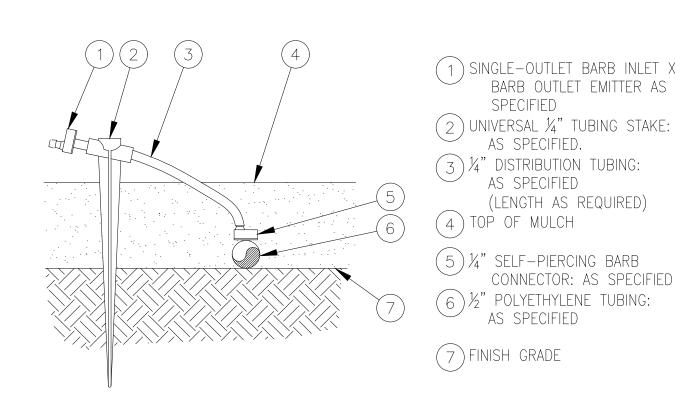



TORO T-DPC-DC DRIP EMITTER

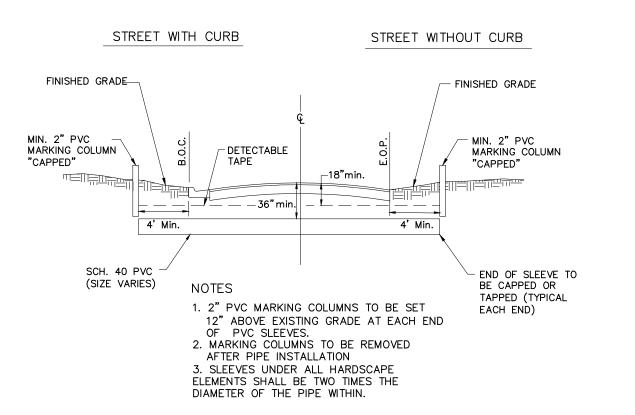



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PENSACOLA INTERNATIONAL AIRPORT

PENSACOLA, FLORIDA

PENSACOLA GENERAL AVIATION FACILITY (GAF)

IN COLLABORATION WITH:







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DATE ISSUED:	03/03/202
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DRAWN BY:	EZ
DESIGNED BY:	EZ

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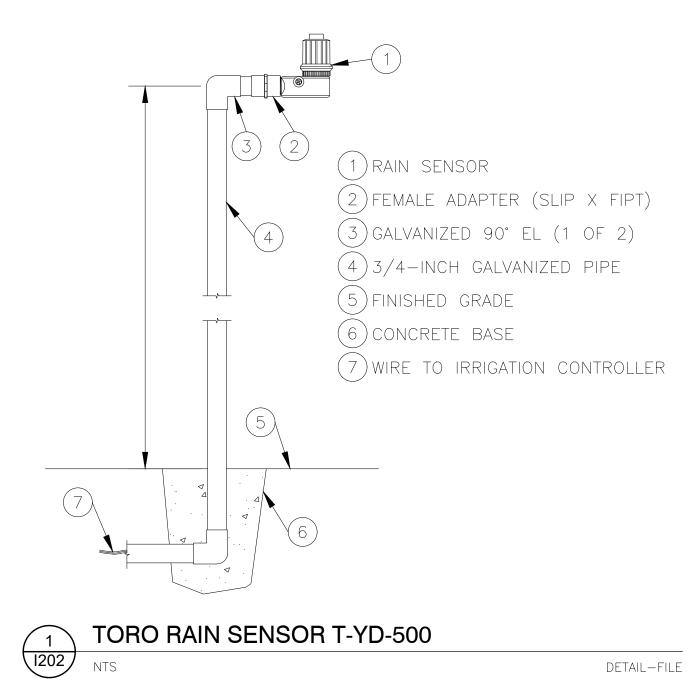
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SHEET TITLE

IRRIGATION **DETAILS**

SHEET NUMBER

LI201




DETAIL-FILE

LEGEND:

1 EVOLUTION OUTDOOR TORO CONTROLLER MODEL NO. STATIONS. SECURE TO WALL WITH APPROPRIATE FASTENERS.

2 1/2" CONDULET AND CONDUIT FOR ELECTRICAL POWER PER LOCAL AND NATIONAL ELECTRICAL CODES. SECURE TO WALL WITH APPROPRIATE PIPE CLAMPS.

- 3 1" CONDUIT FOR REMOTE CONTROL WIRES. SECURE TO WALL WITH APPROPRIATE PIPE CLAMPS.
- (4) FINISHED GRADE.
- OPTIONAL EVO-SC INTERNAL SMART CONNECT RECEIVER.

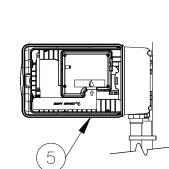

TORO ECO-40D EVOLUTION SERIES - OUTDOOR MODEL 2 1202 DETAIL-FILE

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PENSACOLA INTERNATIONAL

PENSACOLA, FLORIDA

AIRPORT

PENSACOLA GENERAL AVIATION FACILITY (GAF)

IN COLLABORATION WITH:





PROFESSIONAL SEAL

NO.	DESCRIPTION	DATE

03/03/2020 DATE ISSUED: REVIEWED BY: DRAWN BY: DESIGNED BY: PROJECT NUMBER:

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IRRIGATION **DETAILS**

SHEET NUMBER

LI202

- DEFINITIONS LATERAL PIPING: DOWNSTREAM FROM CONTROL VALVES
- IS UNDER PRESSURE DURING FLOW MAINLINE PIPING: DOWNSTREAM FROM POINT OF CONNECTION TO WATER DISTRIBUTION PIPING TO, AND INCLUDING, CONTROL VALVES, PIPING IS UNDER WATER-DISTRIBUTION-SYSTEM PRESSURE

TO SPRINKLERS, SPECIALTIES, AND DRAIN VALVES. PIPING

- LOW VOLTAGE: AS DEFINED IN NFPA 70 FOR CIRCUITS AND EQUIPMENT OPERATING AT LESS THAN 50 V OR FOR REMOTE-CONTROL, SIGNALING POWER-LIMITED CIRCUITS.
- **GENERAL** LOCATE ALL UNDERGROUND UTILITIES, ELECTRICAL WIRING, WATER, SEWER, TELEPHONE, CABLE TV, AND OTHER UNDERGROUND LINES BEFORE LANDSCAPE AND
- IRRIGATION INSTALLATION. INSTALL AN AUTOMATIC IRRIGATION SYSTEM TO ENSURE 100% COVERAGE OF ALL PLANTED AND GRASSED AREAS THE CONTRACTOR SHALL PROVIDE AS-BUILT DRAWINGS TO LANDSCAPE ARCHITECT AND OWNER SHOWING ALL INFORMATION REQUIRED BY LOCAL CODES AND NECESSARY FOR THE EFFICIENT OPERATION AND
- MAINTENANCE OF THE SYSTEM ELEMENT LOCATION ON THE DRAWINGS IS SCHEMATIC SHOWING INTENT. CONTRACTOR SHALL NOT MAKE CHANGES TO PIPE SIZING OR ROUTING WITHOUT PRIOR APPROVAL OF OWNER & IRRIGATION DESIGNER.
- THE CONTROLLER SHALL BE EXISTING WITH PROPERLY LOCATED AND INSTALLED RAIN I FREEZE I WIND SHUTOFF SENSORS. THE SENSORS SHALL BE LOCATED IN SUCH A MANNER SO THAT THEY ARE UNOBSTRUCTED, AND DIRECTLY EXPOSED TO NATURAL RAINFALL, WIND, AND SUNLIGHT FROM ALL DIRECTIONS, BUT NOT TO RUNOFF WATER FROM SWALES OR OTHER SURFACES
- THE LANDSCAPE BID SHALL BE FOR THE IRRIGATION MATERIALS SPECIFIED. REQUESTS TO USE EQUAL SUBSTITUTE MATERIALS SHALL BE SUBMITTED TO THE LANDSCAPE ARCHITECT IN WRITING AND OWNER'S APPROVAL GIVEN IN WRITING BEFORE THE SUBSTITUTION IS ALLOWED. REQUESTS TO USE EQUAL, SUBSTITUTE MATERIALS SHALL INCLUDE COMPLETE PRODUCT SPECIFICATIONS AND ANY COST SAVINGS TO THE **PROJECT**
- IF DISCREPANCIES OCCUR BETWEEN THE PLANS, NOTES, AND ACTUAL CONDITIONS CONTACT THE LANDSCAPE ARCHITECT IN WRITING FOR CLARIFICATION BEFORE PROCEEDING.
- THE INSTALLER SHALL BE FAMILIAR WITH ALL REQUIREMENTS FOR THE WORK. AND TO CONDUCT HIS WORK IN A CLEAN, SAFE, AND WORKMANLIKE MANNER. THE OWNER RESERVES THE RIGHT TO ACT TO PROTECT HIS PROPERTY AND THE OTHER PERSONNEL AT WORK THERE AND TO MAKE EMERGENCY REPAIRS OR TAKE CORRECTIVE ACTION IF THE INSTALLER DOES NOT FULFILL HIS OBLIGATIONS IN A TIMELY MANNER. THE OWNER FURTHER RESERVES THE RIGHT TO BACK-CHARGE THE INSTALLER TO COVER SUCH EXPENSES, TO THE EXTENT ALLOWED UNDER APPLICABLE LAW.
- IRRIGATION MATERIALS AND WORKMANSHIP SHALL BE WARRANTIED FOR ONE YEAR. MANUFACTURER'S WARRANTIES SHALL BE PASSED TO THE OWNER
- ALL WORK SHALL BE DONE IN ACCORDANCE WITH PREVAILING CODES AND REGULATIONS. AND ESCAMBIA COUNTY IRRIGATION STANDARDS. IT SHALL BE THE RESPONSIBILITY OF THE CONTRACTOR TO VERIFY AND CONFORM TO THE PARTICULAR CODES AND REGULATIONS APPLICABLE TO THIS LOCATION. AS WELL AS ESCAMBIA COUNTY IRRIGATION STANDARDS. THE CONTRACTOR SHALL BE RESPONSIBLE FOR OBTAINING ALL NECESSARY PERMITS, INCLUDING THOSE FOR ANY NEW WATER LINE TAPS OR WELLS, LOCATES, AND INSPECTIONS
- 2.10. IRRIGATION SYSTEM AND ITS COMPONENTS SHALL BE **INSTALLED ACCORDING TO MANUFACTURES'** SPECIFICATIONS
- 2.11. IRRIGATION SCHEDULES ARE PROVIDED FOR INFORMATIONAL PURPOSES ONLY. CONTRACTOR IS RESPONSIBLE FOR PERFORMING THEIR OWN TAKE OFF BASED ON PLAN DOCUMENTS & ENSURING UNIFORM COVERAGE OF LANDSCAPED AREAS.
- 2.12. NO SITE WORK ACTIVITIES SHALL TAKE PLACE WITHOUT CITY SITE REVIEW/APPROVAL OF PROPOSED EROSION CONTROL MEASURES AND ADVANCED NOTIFICATION OF THE REQUESTED INSPECTION IS REQUIRED.
- 2.13. PUBLIC WORKS STAFF SHALL BE NOTIFIED PRIOR TO PERFORMING ANY WORK IN THE CITY RIGHT OF WAY. ALL PROPOSED DEPTH OF IRRIGATION MAINLINE PIPE
- SHALL BE MIN. 18" DEPTH OF COVER. 2.15. ALL PROPOSED DEPTH OF IRRIGATION LATERAL CIRCUITING PIPE SHALL BE MIN. 18" DEPTH OF COVER.
- **ACTION SUBMITTALS** PRODUCT DATA: FOR EACH TYPE OF PRODUCT INDICATED INCLUDE RATED CAPACITIES, OPERATING CHARACTERISTICS, AND FURNISHED SPECIALTIES AND
- ACCESSORIES. WIRING DIAGRAMS: FOR POWER, SIGNAL, AND CONTROL
- WIRING. INFORMATIONAL SUBMITTALS
- QUALIFICATION DATA: FOR QUALIFIED INSTALLER. FIELD QUALITY-CONTROL REPORTS.
- 5. CLOSEOUT SUBMITTALS OPERATION AND MAINTENANCE DATA: FOR DRIP EMITTERS. CONTROLLER, AND AUTOMATIC CONTROL VALVES, RAIN

- SENSOR, ETC. TO INCLUDE IN OPERATION AND MAINTENANCE MANUALS.
- QUALITY ASSURANCE INSTALLER QUALIFICATIONS: COMPANY MUST HAVE THREE YEARS OF EXPERIENCE INSTALLING IRRIGATION SYSTEMS OF SIMILAR SIZE AND COMPLEXITY. COMPANY MUST HAVE QUALIFIED SUPERINTENDENT ON-SITE AT ALL TIMES WHO HAS MINIMUM THREE YEARS' EXPERIENCE INSTALLING IRRIGATION SYSTEMS OF SIMILAR SIZE AND COMPLEXITY
- ELECTRICAL COMPONENTS, DEVICES, AND ACCESSORIES: LISTED AND LABELED AS DEFINED IN NFPA 70, BY A QUALIFIED TESTING AGENCY, AND MARKED FOR INTENDED
- LOCATION AND APPLICATION. 7. DELIVERY, STORAGE, AND HANDLING
- STORE PLASTIC PIPING PROTECTED FROM DIRECT SUNLIGHT. SUPPORT TO PREVENT SAGGING AND BENDING. CONTRACTOR IS RESPONSIBLE FOR STORAGE AND SECURITY OF ALL MATERIALS STORED ON SITE.
- PROJECT CONDITIONS INTERRUPTION OF EXISTING WATER SERVICE: DO NOT INTERRUPT WATER SERVICE TO FACILITIES OCCUPIED BY OWNER OR OTHERS UNLESS PERMITTED UNDER THE FOLLOWING CONDITIONS AND THEN ONLY AFTER ARRANGING TO PROVIDE TEMPORARY WATER SERVICE
- ACCORDING TO REQUIREMENTS INDICATED: NOTIFY OWNER NO FEWER THAN FIVE DAYS IN ADVANCE OF PROPOSED INTERRUPTION OF WATER
- DO NOT PROCEED WITH INTERRUPTION OF WATER SERVICE WITHOUT OWNER'S WRITTEN PERMISSION
- **PRODUCTS** PIPES, TUBES, AND FITTINGS 9.1.1. PVC LATERAL PIPE 1", PRESSURE RATED: ASTM D 2241,
- PVC 1120 COMPOUND, SDR 21 CLASS 200, SOLVENT PVC SOCKET FITTINGS: ASTM D 2467, SCHEDULE 80. NO THREADED FITTINGS ALLOWED EXCEPT AS NOTED
- ON THE PLAN DOCUMENTS. PVC SOCKET UNIONS: CONSTRUCTION SIMILAR TO MSS SP-107, EXCEPT BOTH HEADPIECE AND TAILPIECE SHALL BE PVC WITH SOCKET ENDS
- PVC MAINLINE PIPE 1", PRESSURE RATED: ASTM D 2241, PVC 1120 COMPOUND, SDR 21 CLASS 200, GASKETED
- PVC SOCKET FITTINGS: ASTM D 2467, SCHEDULE 80 FITTINGS FOR MAINLINE PIPE MUST BE GASKETED AND THRUST BLOCKED ACCORDING TO MANUFACTURER'S
- RECOMMENDATIONS. PVC SOCKET UNIONS: CONSTRUCTION SIMILAR TO MSS SP-107, EXCEPT BOTH HEADPIECE AND TAILPIECE
- SHALL BE PVC WITH GASKETED ENDS. PIPING JOINING MATERIALS SOLVENT CEMENTS FOR JOINING PVC LATERAL PIPING
- ": ASTM D 2564. INCLUDE PRIMER ACCORDING TO ASTM F 656. AIR RELIEF VALVES
- AIR RELIEF VALVE SIZED TO MATCH MAINLINE PIPING WHERE LOCATED. 9.4. TRANSITION FITTINGS
- GENERAL REQUIREMENTS: SAME SIZE AS, AND WITH 9.4.1. PRESSURE RATING AT LEAST EQUAL TO AND WITH ENDS COMPATIBLE WITH, PIPING TO BE JOINED.
- 9.5. CONTROLLERS CONTROLLER TO BE MOUNTED ON ELECTRICAL RACK PER ELECTRICAL SPECIFICATIONS LOCATED NEAR THE
- **GROUNDWATER SUPPLY WELL** BOXES FOR AUTOMATIC CONTROL VALVES
- PLASTIC BOXES: DESCRIPTION: BOX AND COVER, WITH OPEN 9.6.1.1. BOTTOM AND OPENINGS FOR PIPING; DESIGNED FOR INSTALLING FLUSH WITH GRADE
- AS REQUIRED FOR VALVES AND SERVICE 9.6.1.2. 9.6.1.3. AS REQUIRED FOR VALVES AND SERVICE.
- SIDEWALL MATERIAL: PE. 9.6.1.4. COVER MATERIAL: PE. 9.6.1.5. 10. EXECUTION
- 10.1. EARTHWORK EXCAVATING, TRENCHING, AND BACKFILLING ARE SPECIFIED IN SECTION 312000 "EARTH MOVING."
- PROVIDE MINIMUM COVER OVER TOP OF UNDERGROUND PIPING ACCORDING TO THE FOLLOWING: IRRIGATION MAINLINE PIPING: TOP OF PIPE MINIMUM DEPTH OF 24 INCHES (900 MM) BELOW
- FINISHED GRADE, OR NOT LESS THAN 18 INCHES (450 MM) BELOW AVERAGE LOCAL FROST DEPTH, WHICHEVER IS DEEPER. LATERAL PIPING: 18 INCHES (300 MM) TO TOP OF
- PIPE. PIPE CAN BE SHALLOWER SLIGHTLY AT VALVE LOCATION AS NEEDED. DRAIN PIPING: 12 INCHES (300 MM)
- SLEEVES: 36 INCHES (600 MM) TO TOP OF SLEEVE 10.1.2.4. BELOW CROWN OF ROAD CROSSING. 10.2. PREPARATION
- SET STAKES TO IDENTIFY LOCATIONS OF PROPOSED IRRIGATION SYSTEM. OBTAIN LANDSCAPE ARCHITECT'S APPROVAL BEFORE EXCAVATION. 10.3. PIPING INSTALLATION
 - LOCATION AND ARRANGEMENT: DRAWINGS INDICATE SCHEMATIC LOCATION AND ARRANGEMENT OF PIPING SYSTEMS. PIPING SHALL BE LOCATED WITHIN BEDS. INSTALL PIPING AS INDICATED UNLESS DEVIATIONS

- ARE APPROVED ON COORDINATION DRAWINGS. INSTALL ALL PIPING AND FITTINGS IN ACCORDANCE TO MANUFACTURER'S RECOMMENDATIONS. INSTALL PIPING AT MINIMUM UNIFORM SLOPE OF 0.5 PERCENT DOWN TOWARD DRAIN VALVES. INSTALL PIPING FREE OF SAGS AND BENDS 10.3.4. INSTALL GROUPS OF PIPES PARALLEL TO EACH OTHER, SPACED TO PERMIT VALVE SERVICING.
- INSTALL FITTINGS FOR CHANGES IN DIRECTION AND BRANCH CONNECTIONS. THRUST BLOCK OR JOINT RESTRAINTS AS REQUIRED INSTALL UNIONS ADJACENT TO VALVES AND TO FINAL CONNECTIONS TO OTHER COMPONENTS WITH NPS 21/2
- (DN 50) OR SMALLER PIPE CONNECTION. INSTALL FLANGES ADJACENT TO ISOLATION GATE VALVES WITH NPS 3 (DN 65) OR LARGER PIPE
- CONNECTION. LAY PIPING ON SOLID SUBBASE, UNIFORMLY SLOPED WITHOUT HUMPS OR DEPRESSIONS. INSTALL DUCTILE-IRON PIPING ACCORDING TO 10.3.10.
- AWWA C600 INSTALL PVC PIPING IN DRY WEATHER WHEN TEMPERATURE IS ABOVE 40 DEG F (5 DEG C). ALLOW JOINTS TO CURE AT LEAST 24 HOURS AT TEMPERATURES ABOVE 40 DEG F (5 DEG C) BEFORE TESTING.
- INSTALL PIPING IN SLEEVES UNDER PARKING LOTS, ROADWAYS, AND SIDEWALKS.
- INSTALL SLEEVES MADE OF SCHEDULE 40 PVC PIPE AND SOCKET FITTINGS, AND SOLVENT-CEMENTED JOINTS.
- 10.4. JOINT CONSTRUCTION REAM ENDS OF PIPES AND TUBES AND REMOVE
- REMOVE SCALE, SLAG, DIRT, AND DEBRIS FROM INSIDE AND OUTSIDE OF PIPE AND FITTINGS BEFORE **ASSEMBLY**
- THREADED JOINTS: THREAD PIPE WITH TAPERED PIPE THREADS ACCORDING TO ASME B1.20.1. CUT THREADS FULL AND CLEAN USING SHARP DIES. REAM THREADED PIPE ENDS TO REMOVE BURRS AND RESTORE FULL ID JOIN PIPE FITTINGS AND VALVES AS FOLLOWS:
- APPLY APPROPRIATE TAPE OR THREAD COMPOUND TO EXTERNAL PIPE THREADS UNLESS DRY SEAL THREADING IS SPECIFIED.
- DAMAGED THREADS: DO NOT USE PIPE OR PIPE FITTINGS WITH THREADS THAT ARE CORRODED OR DAMAGED. DO NOT USE PIPE SECTIONS THAT
- HAVE CRACKED OR OPEN WELDS. FLANGED JOINTS: SELECT RUBBER GASKET MATERIAL, SIZE, TYPE, AND THICKNESS FOR SERVICE APPLICATION, INSTALL GASKET CONCENTRICALLY POSITIONED. USE SUITABLE LUBRICANTS ON BOLT
- THREADS. PVC PIPING SOLVENT-CEMENTED JOINTS: CLEAN AND DRY JOINING SURFACES. JOIN PIPE AND FITTINGS ACCORDING TO THE FOLLOWING
- COMPLY WITH ASTM F 402 FOR SAFE-HANDLING PRACTICE OF CLEANERS, PRIMERS, AND SOLVENT CEMENTS.
- PVC PRESSURE PIPING: JOIN SCHEDULE NUMBER, 10.0.5.2. ASTM D 1785, PVC PIPE AND PVC SOCKET FITTINGS ACCORDING TO ASTM D 2672. JOIN OTHER-THAN-SCHEDULE-NUMBER PVC PIPE AND
- SOCKET FITTINGS ACCORDING TO ASTM D 2855. PVC NON-PRESSURE PIPING: JOIN ACCORDING TO ASTM D 2855.
- 10.1. VALVE INSTALLATION 10.1.1. UNDERGROUND IRON GATE VALVES, RESILIENT SEAT: COMPLY WITH AWWA C600 AND AWWA M44. INSTALL IN VALVE CASING WITH TOP FLUSH WITH GRADE. INSTALL VALVES AND PVC PIPE WITH RESTRAINED,
- GASKETED JOINTS. PRESSURE-REDUCING VALVES: INSTALL IN BOXES FOR
- AUTOMATIC CONTROL VALVES. SPRINKLER INSTALLATION 10.2.1. INSTALL SPRINKLERS AFTER HYDROSTATIC TEST IS
- COMPLETED. INSTALL SPRINKLERS AT MANUFACTURER'S 10.2.2.
- RECOMMENDED HEIGHTS LOCATE PART-CIRCLE SPRINKLERS TO MAINTAIN A MINIMUM DISTANCE OF 12 INCHES (100 MM) FROM WALLS AND 6 INCHES (50 MM) FROM CURBS AND
- SIDEWALKS UNLESS OTHERWISE INDICATED 10.3. AUTOMATIC IRRIGATION-CONTROL SYSTEM INSTALLATION EQUIPMENT MOUNTING: INSTALL EXTERIOR WALL-MOUNTED DEVICES ON RACKING IN SPECIFIC
- LOCATION APPROVED BY OWNER AND LANDSCAPE ARCHITECT. PLACE AND SECURE ANCHORAGE DEVICES. USE SETTING DRAWINGS, TEMPLATES, DIAGRAMS. INSTRUCTIONS, AND DIRECTIONS FURNISHED WITH
 - ITEMS TO BE EMBEDDED. INSTALL ANCHOR BOLTS TO ELEVATIONS REQUIRED FOR PROPER ATTACHMENT TO SUPPORTED EQUIPMENT
- ALL WIRING EXTENDING ABOVE GRADE TO 10.3.1.3. CONTROLLER SHALL BE IN CONDUIT AND
- SECURELY NEATLY TO WALL. PROVIDE CONDUCTORS OF SIZE NOT SMALLER THAN RECOMMENDED BY CONTROLLER MANUFACTURER. 10.4. CONNECTIONS

- AUTOMATIC CONTROL VALVES USING DBY'S OR DBR'S
 - MANUFACTURER'S FIELD SERVICE: ENGAGE A INSPECT, TEST, AND ADJUST COMPONENTS, ASSEMBLIES, AND EQUIPMENT INSTALLATIONS.
- PERFORM TESTS AND INSPECTIONS. 10.5.2.1. MANUFACTURER'S FIELD SERVICE: ENGAGE A FACTORY-AUTHORIZED SERVICE REPRESENTATIVE TO INSPECT COMPONENTS, ASSEMBLIES, AND
- **TESTS AND INSPECTIONS:** 10.5.3.1. LEAK/PRESSURE TEST: AFTER INSTALLATION, LEAKS AND RETEST UNTIL NO LEAKS EXIST.
- OPERATIONAL TEST: AFTER ELECTRICAL CIRCUITRY HAS BEEN ENERGIZED, OPERATE CONTROLLERS AND AUTOMATIC CONTROL VALVES TO CONFIRM PROPER SYSTEM OPERATION. 10.5.3.3. TEST AND ADJUST CONTROLS AND SAFETIES
- CONTROLS AND EQUIPMENT. DEFECTIVE IF IT DOES NOT PASS TESTS AND
- PREPARE TEST AND INSPECTION REPORTS.
- PERFORM STARTUP SERVICE. COMPLETE INSTALLATION AND STARTUP CHECKS 10.6.1.1. ACCORDING TO MANUFACTURER'S WRITTEN
- INSTRUCTIONS. VERIFY THAT CONTROLLERS ARE INSTALLED AND CONNECTED ACCORDING TO THE CONTRACT
- 10.6.1.3. COMPLIES WITH MANUFACTURER'S SUBMITTAL.
- ADJUST SETTINGS OF CONTROLLERS ADJUST AUTOMATIC CONTROL VALVES TO PROVIDE FLOW RATE AT RATED OPERATING PRESSURE
- WILL BE FLUSH WITH, OR NOT MORE THAN 1/2 INCH (13
- DEMONSTRATION
- CONTROL VALVES AND CONTROLLERS. 10.10. PIPING SCHEDULE
- PRESSURE.
- 10.10.3.1.
- PVC SOCKET FITTINGS; AND SOLVENT-CEMENTED JOINTS. 10.11. VALVE SCHEDULE

- INSTALL PIPING ADJACENT TO EQUIPMENT, VALVES, AND DEVICES TO ALLOW SERVICE AND MAINTENANCE. CONNECT WIRING BETWEEN CONTROLLERS AND
- FIELD QUALITY CONTROL FACTORY-AUTHORIZED SERVICE REPRESENTATIVE TO
- INCLUDING CONNECTIONS. EQUIPMENT INSTALLATIONS, INCLUDING
- CONNECTIONS, AND TO ASSIST IN TESTING. CHARGE SYSTEM AND TEST FOR LEAKS. REPAIR
- REPLACE DAMAGED AND MALFUNCTIONING
- ANY IRRIGATION PRODUCT WILL BE CONSIDERED INSPECTIONS.
- STARTUP SERVICE
- DOCUMENTS. VERIFY THAT ELECTRICAL WIRING INSTALLATION
- REQUIRED FOR EACH SPRINKLER CIRCUIT ADJUST SPRINKLERS AND DEVICES, EXCEPT THOSE INTENDED TO BE MOUNTED ABOVEGROUND, SO THEY
- MM) ABOVE, FINISH GRADE. CLEANING FLUSH DIRT AND DEBRIS FROM PIPING BEFORE INSTALLING SPRINKLERS AND OTHER DEVICES
- 10.9.1. TRAIN OWNER'S MAINTENANCE PERSONNEL TO ADJUST, OPERATE, AND MAINTAIN AUTOMATIC
- 10.10.1. INSTALL COMPONENTS HAVING PRESSURE RATING EQUAL TO OR GREATER THAN SYSTEM OPERATING
- PIPING IN CONTROL-VALVE BOXES AND ABOVEGROUND MAY BE JOINED WITH FLANGES OR UNIONS INSTEAD OF JOINTS INDICATED.
- 10.10.3. UNDERGROUND IRRIGATION MAINLINE PIPING SHALL BE FOLLOWING: SDR 21. PVC. PRESSURE-RATED PIPE CLASS 200:
- PVC SOCKET FITTINGS; AND GASKETED JOINTS. 10.10.4. LATERAL PIPING SHALL BE THE FOLLOWING: SDR 21, PVC, PRESSURE-RATED PIPE CLASS 200.
- 10.11.1. AS INDICATED ON PLAN DOCUMENTS.

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PENSACOLA INTERNATIONAL **AIRPORT**

PENSACOLA, FLORIDA

PENSACOLA GENERAL AVIATION FACILITY (GAF)

IN COLLABORATION WITH:







REVISIONS				
NO.	DESCRIPTION	DATE		

03/03/2020 DATE ISSUED: **REVIEWED BY:** SD ΕZ DRAWN BY: DESIGNED BY:

201-0052-002

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SHEET TITLE

PROJECT NUMBER:

IRRIGATION **SPECIFICATION**

SHEET NUMBER

DESIGN CRITERIA:

2. LIVE LOADS (PER ASCE 7-10):

3. WIND LOADS (PER ASCE 7-10).

RISK CATEGORY

SITE CLASS

TYPICAL SLAB

DEAD LOADS

TYPICAL

ROOF

DESIGN PER THE FLORIDA BUILDING CODE, BUILDING, 6TH EDITION (2017)

MECHANICAL AND LIGHT STORAGE SLAB

INTERNAL PRESSURE COEFFICIENT, GCpi

COMPONENTS AND CLADDING WIND PRESSURES

MAPPED SPECTRAL RESPONSE ACCELERATIONS

MAPPED SPECTRAL RESPONSE ACCELERATIONS

4. EARTHQUAKE DESIGN DATA - BUILDING (PER ASCE 7-10):

ULTIMATE DESIGN WIND SPEED, Vull

NOMINAL DESIGN WIND SPEED, Vasd

WIND EXPOSURE CATEGORY

SEISMIC IMPORTANCE FACTOR

SEISMIC DESIGN CATEGORY

DESIGN BASE SHEAR

5. SNOW LOADS (PER ASCE 7-10):

6. GEOTECHNICAL DATA:

GROUND SNOW LOAD

ALLOWABLE SOIL BEARING

MATERIAL PROPERTIES:

3. STRUCTURAL STEEL (PER AISC 360-10):

WIDE FLANGE SHAPES

HSS RECTANGULAR

1. CONCRETE (PER ACI 318-14):

ALL CONCRETE

2. REINFORCING STEEL

HSS ROUND

STEEL PIPES

ANCHOR BOLTS

4. WELDS (PER AWS D1.1)

GENERAL NOTES

PACKAGES.

ALL OTHER STEEL

METHOD OF CONSTRUCTION.

STRUCTURAL DRAWINGS.

1. DEFERRED SUBMITTALS

INC. DATED SEPTEMBER 18, 2019.

DEFERRED SUBMITTALS

THE DESIGN OF THE BUILDING.

ENGINEER LICENSED IN FLORIDA.

LOADS, CONSTRUCTION LOADS, WIND LOADS, ETC.

PROCEEDING WITH FABRICATION AND CONSTRUCTION.

A. METAL BUILDING SYSTEM (SPECIFICATION 133419) B. ALUMINUM CANOPY SYSTEMS (SPECIFICATION 107316)

HAVE BEEN APPROVED BY THE ENGINEER AND BUILDING OFFICIAL.

DETAILS TO THE SAME EXTENT AS IF REFERRED TO BY DETAIL NUMBER.

CHANNELS

PLATES

ANGLES

BOLTS

SPECTRAL RESPONSE COEFFICIENT

SPECTRAL RESPONSE COEFFICIENT

BASIC SEISMIC FORCE RESISTING SYSTEM

ALLOWABLE LATERAL BEARING PRESSURE

RESPONSE MODIFICATION COEFFICIENT

SEISMIC RESPONSE COEFFICIENT

ANALYSIS DESIGN PROCEDURE

SELFWEIGHT

100 PSF

125 PSF

150 MPH

117 MPH

± 0.18

SEE 1/S001

 $S_S = 0.091$

 $S_1 = 0.054$

 $S_{DS} = 0.097$

 $S_{D1} = 0.086$

V = 1.72 KIP

 $C_S = 0.029$

 $P_a = 0 PSF$

2,000 PSF

f'c = 4,500 PSI (UON)

ASTM A615 GRADE 60

ASTM A992

ASTM A36

ASTM A36 ASTM A36

ASTM A36

E70XX

THE STRUCTURAL NOTES SHALL GOVERN IN MATTERS COVERED ON THE STRUCTURAL DRAWINGS. SEE PROJECT

SPECIFICATION AND OTHER DRAWINGS FOR FURTHER REQUIREMENTS. TOTAL PROJECT DEFINITION WILL BE PROVIDED BY

2. THE DRAWINGS REPRESENT THE FINISHED STRUCTURE, UNLESS OTHERWISE INDICATED. THEY DO NOT REPRESENT THE

3. THE CONTRACTOR SHALL TAKE ALL MEASURES NECESSARY TO PROTECT THE STRUCTURE AND ANY PERSONNEL DURING

COMBINING PROJECT SPECIFICATIONS, ARCHITECTURAL, STRUCTURAL, MECHANICAL, PLUMBING, AND ELECTRICAL DRAWING

CONSTRUCTION. SUCH MEASURES SHOULD INCLUDE, BUT NOT BE LIMITED TO TEMPORARY BRACING AND SHORING OF DEAD

FOR TYPICAL DETAILS SHOWN BUT NOT BE REFERRED TO EXCEPT HEREIN, CONFORM TO ALL OF THE REQUIREMENTS OF THESE

EQUIPMENT SHALL BE VERIFIED WITH EQUIPMENT PURCHASED BEFORE PROCEEDING WITH STRUCTURAL WORK AFFECTED. SEE

SUBMITTAL DOCUMENTS FOR DEFERRED SUBMITTALS SHALL BE SUBMITTED TO THE ARCHITECT OR ENGINEER OF RECORD WHO

SHALL REVIEW THEM AND FORWARD THEM TO THE BUILDING OFFICIAL WITH A NOTATION INDICATING THAT THE DEFERRED

CERTIFICATES AND OTHER DATA. DRAWINGS AND CALCULATIONS SHALL BE SIGNED AND SEALED BY A STRUCTURAL

3. THE DEFERRED SUBMITTAL ITEMS SHALL NOT BE FABRICATED OR INSTALLED UNTIL THEIR DESIGN AND SUBMITTAL DOCUMENTS

B. SUBMITTAL DOCUMENTS SHALL INCLUDE PLAN LAYOUTS, SECTIONS, DETAILS, CALCULATIONS, PRODUCT DATA,

A. SUBMITTAL DOCUMENTS SHALL BE IN ACCORDANCE WITH THE SPECIFICATIONS AND PLANS

SUBMITTAL DOCUMENTS HAVE BEEN REVIEWED AND THAT THEY HAVE BEEN FOUND TO BE IN GENERAL CONFORMANCE WITH

ARCHITECTURAL, MECHANICAL, ELECTRICAL, AND PLUMBING DRAWINGS FOR OPENINGS, SLEEVES, ETC. NOT SHOWN ON THE

8. FOUNDATION DESIGN IS BASED ON THE RECOMMENDATIONS CONTAINED IN GEOTECHNICAL REPORT 4511-19-018-002 BY TIERRA.

5. IF FOOTING ELEVATIONS SHOWN OCCUR IN A DISTURBED, UNSTABLE OR UNSUITABLE SOIL THE ENGINEER SHALL BE NOTIFIED.

6. CONTRACTOR SHALL VERIFY ALL EXISTING CONDITIONS OF EXISTING SITE THAT ARE AFFECTED BY NEW WORK BEFORE

7. ALL STRUCTURAL OPENINGS AROUND OR AFFECTED BY ARCHITECTURAL, MECHANICAL, ELECTRICAL, AND PLUMBING

R = 3

SEISMIC RESISTANCE

EQUIVALENT LATERAL FORCE

150 PSF/FT (PER FBC TABLE 1806.2)

ASTM A500, GRADE B, $F_v = 46$ KSI

ASTM F3125 GR A325 (3/4"Ø UON)

ASTM F1554 (GRADE 36 UON)

ASTM A500, GR B, $F_v = 42$ KSI

ASTM A53, GRADE B, TYPE S

20 PSF

SELFWEIGHT + 5 PSF + 10 PSF COLLATERAL

STEEL NOT SPECIALLY DETAILED FOR

CONCRETE AND REINFORCING STEEL

1. ALL CONCRETE SHALL BE IN COMPLIANCE WITH THE BUILDING CODE REQUIREMENTS FOR STRUCTURAL CONCRETE ACI

2" FROM TOP OF CONC.

- 2. UNLESS OTHERWISE SHOWN ON DRAWINGS, MINIMUM COVER FOR REINFORCING SHALL BE AS FOLLOWS: **FOOTINGS PILASTERS**
- 3. ALL REINFORCING SHALL BE HELD SECURELY IN POSITION WITH STANDARD ACCESSORIES IN CONFORMANCE WITH THE CURRENT EDITIONS OF THE CRSI MANUAL OF STANDARD PRACTICE DURING THE PLACING OF THE CONCRETE.
- 4. PROVIDE CORNER BARS AT ALL BEAM AND WALL INTERSECTIONS. CORNER BARS SHALL BE THE SAME SIZE AS THE LARGER
- 5. ALL GRADE BEAM AND WALL STEEL SHALL BE CONTINUOUS WHERE POSSIBLE. TOP BARS SHALL BE SPLICED AT THE
- CENTER OF THE SPAN, BOTTOM BARS OVER SUPPORTS, AND OTHER HORIZONTAL AND TEMPERATURE BARS AS REQUIRED.
- 6. SPLICES IN REINFORCING, WHERE PERMITTED, SHALL BE AS FOLLOWS UNLESS OTHERWISE NOTED. REINFORCING STEEL
- 7. SEE ARCHITECTURAL, MECHANICAL, PLUMBING, FIRE PROTECTION AND ELECTRICAL PLANS FOR CAST-IN-PLACE BOLTS, INSERTS, ANCHORS, ETC AND FOR ALL SLAB LEAVE-OUTS, SLOPES, DEPRESSIONS, SLEEVES, ETC.
- 8. ALL HOOKS IN REINFORCING BARS SHALL BE AN ACI STANDARD HOOK, UNLESS OTHERWISE NOTED.
- 9. ALL EXPOSED EDGES OF CONCRETE SHALL BE CHAMFERED 3/4", UNLESS OTHERWISE NOTED
- 10. PROVIDE 1/2" PREMOLDED EXPANSION JOINT MATERIAL WHERE SLAB ON GRADE IS POURED AGAINST GRADE BEAMS OR WALLS, UNLESS OTHERWISE SHOWN OR NOTED.
- 11. ALL CONCRETE SHALL BE DESIGNED BY AN APPROVED LABORATORY, AND THE DESIGN MIX SHALL BE SUBMITTED TO THE ARCHITECT/ENGINEER FOR REVIEW. AND APPROVAL OBTAINED PRIOR TO USE.
- 12. NO PIPES OR DUCTS SHALL BE PLACED IN STRUCTURAL CONCRETE UNLESS SPECIFICALLY DETAILED. SEE ARCHITECTURAL AND MECHANICAL DRAWINGS FOR LOCATION OF SLEEVES, MOULDS, FLOOR HINGES, ETC TO BE CAST INTO THE CONCRETE.

STRUCTURAL STEEL

SLAB ON GRADI

INTERSECTING BARS.

- 1. STRUCTURAL STEEL SHALL CONFORM TO THE CURRENT EDITION OF THE AISC STEEL CONSTRUCTION MANUAL (FOURTEENTH EDITION) INCLUDING AISC 360-10 (SPECIFICATION FOR STRUCTURAL STEEL BUILDINGS) AND AISC 303-10 (CODE OF STANDARD PRACTICE FOR STRUCTURAL STEEL BUILDINGS AND BRIDGES).
- 2. QUALITY CONTROL (QC) SHALL BE PERFORMED BY THE CONTRACTOR (ERECTOR/FABRICATOR) IN ACCORDANCE WITH THE PROVISIONS OF AISC 360-10 CHAPTER N AND ALL APPLICABLE REFERENCED STANDARDS. ALL WELDING INSPECTIONS PERFORMED BY THE CONTRACTOR SHALL BE PERFORMED BY A CERTIFIED WELDING INSPECTOR (AWS CWI QC1). CONTRACTOR SHALL KEEP CURRENT AND HAVE AVAILABLE FOR REVIEW ALL DOCUMENTATION LISTED IN AISC CHAPTER N. SECTION N3 AS WELL AS ALL DOCUMENTATION REQUIRED FOR INDIVIDUAL INSPECTION TASKS OUTLINED IN AISC 360
- 3. ALL WELDS SHALL BE PERFORMED IN ACCORDANCE WITH AWS D1.1 (LATEST EDITION). ALL WELDS SHALL BE 3/16" MINIMUM FILLET WELDS UON OR AS REQUIRED BY AISC.
- 4. FABRICATOR SHALL SUBMIT SHOP DRAWINGS TO STRUCTURAL ENGINEER FOR REVIEW AND APPROVAL PRIOR TO THE START OF FABRICATION. ALL STRUCTURAL STEEL SHALL BE INSTALLED IN ACCORDANCE WITH APPROVED SHOP DRAWINGS.
- 5. ALL SHOP CONNECTIONS SHALL BE WELDED. ALL FIELD WELDING SHALL BE SHOWN ON THE SHOP DRAWINGS.
- 6. BOLTS AND BOLTED CONNECTIONS SHALL CONFORM TO THE REQUIREMENTS OF THE LATEST EDITION OF THE SPECIFICATION FOR STRUCTURAL JOINTS USING HIGH-STRENGTH BOLTS, AS APPROVED BY THE RESEARCH COUNCIL ON STRUCTURAL CONNECTIONS (RCSC). ALL BOLTING HARDWARE INCLUDING BOLTS, NUTS AND WASHERS SHALL BE EITHER HOT-DIP OR MECHANICALLY GALVANIZED. ALL COMPONENTS OF BOLTING ASSEMBLY SHALL BE GALVANIZED BY THE SAME
- 7. ALL BOLTS SHALL BE ASTM F3125 GR A325 INSTALLED TO SNUG-TIGHT IN BEARING TYPE CONDITION WITH THREADS ALLOWED ACROSS THE SHEAR PLANE UON.
- 8. EXCEPT WHERE SPECIFICALLY NOTED, CONNECTION DETAILS ON THE DRAWINGS ARE CONSIDERED COMPLETELY DESIGNED AND SHALL NOT BE MODIFIED WITHOUT SPECIFIC WRITTEN APPROVAL FROM THE ENGINEER.
- 9. NO SHOP OR FIELD SPLICES WILL BE ALLOWED IN BEAMS, GIRDERS OR COLUMNS EXCEPT WHERE SHOWN ON THE STRUCTURAL DRAWINGS.

FRAME DURING ERECTION, USE NELSON STUD BOLTS IN LIEU OF PUNCHED OR DRILLED HOLES.

- 10. NO ADDITIONAL HOLES FOR BOLTING OF TEMPORARY BRACING, ETC. DURING ERECTION WILL BE ALLOWED IN ANY STRUCTURAL STEEL MEMBER. WHERE TEMPORARY BOLTED CONNECTIONS ARE REQUIRED FOR STABILITY OF THE STEEL
- 11. ALL STRUCTURAL STEEL MEMBERS, ANGLES, BARS, ANCHORS, ANCHOR BOLTS, ETC. EXPOSED TO WEATHER SHALL BE HOT-DIP GALVANIZED AFTER FABRICATION. SEE ARCHITECTURAL FOR FINISH COATING SYSTEM. COATING SYSTEM SHALL BE COMPATIBLE WHEN APPLIED OVER GALVANIZED COATING.
- 12. ANGLE FRAME MEMBERS AROUND TRENCHES, PITS, OPENINGS, ETC. SHALL BE MITERED, WELDED AND GROUND SMOOTH.
- 13. STRUCTURAL GROUT FOR STEEL COLUMNS SHALL BE A NON-SHRINKAGE NON-EXPANSIVE, NON-METALLIC, GROUT WITH A 28-DAY COMPRESSIVE STRENGTH OF 5,000 PSI WHEN TESTED IN ACCORDANCE WITH ASTM C109.

MASONRY:

- 1. ALL MASONRY WORK SHALL CONFORM TO BUILDING CODE REQUIREMENTS FOR MASONRY STRUCTURES (TMS 402/ACI 530/ASCE 5) AND SPECIFICATIONS FOR MASONRY STRUCTURES (TMS 602/ACI 530.1/ASCE 6).
- 2. CONCRETE MASONRY UNITS SHALL CONFORM TO ASTM C90 WITH f'm = 1,900 PSI.
- 3. MORTAR SHALL CONFORM TO ASTM C270 TYPE S TYPICAL WITH TYPE M USED BELOW GRADE (UON).
- 4. GROUT SHALL BE 3000 PSI STRENGTH AT 28 DAYS. GROUT SOLID ALL CELLS WITH REINFORCING OR EMBEDDED BOLTS.
- 5. REINFORCING STEEL SHALL CONFORM TO ASTM A615, GRADE 60. SEE SCHEDULE FOR LAP SPLICE LENGTHS.
- 6. METAL ANCHORS AND TIES SHALL BE OF CORROSION RESISTANT METAL HOT DIPPED GALVANIZED.
- 7. JOINT REINFORCING SHALL BE ASTM A153, CLASS B, HOT-DIP GALVANIZED LADDER TYPE WITH #9 GAUGE DEFORMED LONGITUDINAL WIRES AND SMOOTH CROSS WIRES CONFORMING TO ASTM A951. SPACE AT 16" OC VERTICAL. EMBED LONGITUDINAL WIRES IN MORTAR WITH A MINIMUM COVER OF 5/8" WHEN EXPOSED TO WEATHER OR EARTH AND 1/2" WHEN NOT EXPOSED TO WEATHER OR EARTH.
- 8. CONCRETE MASONRY BOND BEAMS SHALL BE VERTICALLY SPACED AT 8'-0" ON CENTER MAXIMUM. PROVIDE (2) #5 BARS IN 8" BOND BEAMS AND PROVIDE (2) #6 BARS IN 12" BOND BEAMS.
- 9. UNLESS OTHERWISE NOTED, ALL CMU WALLS SHALL BE REINFORCED WITH (1) #5 AT EACH CORNER, CELLS ADJACENT TO EACH CORNER, AND EACH SIDE OF ALL OPENINGS AND RECESSES. PROVIDE (1) #5 IN EACH OF 2 CELLS EACH SIDE OF OPENINGS OF 6'-0" OR MORE. PROVIDE #5 @ 48" OC (MIN) FOR VERTICAL REINFORCING IN ALL MASONRY WALLS, TYPICAL UNLESS OTHERWISE NOTED
- 10. PROVIDE TEMPORARY BRACING FOR MASONRY WALLS UNTIL THEY ARE CONSTRUCTED TO THEIR FINAL DESIGN CONDITION.
- 11. ALL PRECAST OR POURED LINTELS SHALL BE REINFORCED WITH (2) #4 TOP AND BOTTOM W/ #3 TIES AT 12" AS A MINIMUM AND SHALL HAVE MINIMUM MASONRY END BEARING OF 8". SEE STANDARD LINTEL SCHEDULE FOR MORE INFORMATION.
- 12. PROVIDE MASONRY CONTROL JOINTS AT 25'-0" OC MAX. UON SEE SPECS FOR JOINT INFORMATION.

EARTHWORK NOTES:

SITE PREPARATION

- 1. THE PROPOSED BUILDING FOOTPRINT AND FIVE FEET BEYOND SHALL BE CLEARED, GRUBBED, AND STRIPPED OF ALL EXISTING PAVEMENT, DEMOLITION DEBRIS, AND OTHER DELETERIOUS MATERIALS IN THEIR ENTIRETY.
- 2. PRIOR TO PLACING STRUCTURAL FILL, THE UPPER 12 INCHES (AS A MINIMUM) OF GROUND SURFACE SHALL BE COMPACTED TO A MINIMUM 93% OF THE MODIFIED PROCTOR TEST (ASTM D1557) USING A STATIC ROLLER (NON-VIBRATORY COMPACTION EQUIPMENT SHALL BE USED, VIBRATORY ROLLER NOT PERMITTED).
- 3. ANY EXPOSED SUBGRADE SOILS THAT ARE FOUND TO BE UNSTABLE OR UNSUITABLE SHALL BE REMOVED IN THEIR ENTIRETY AND REPLACED WITH WELL COMPACTED STRUCTURAL FILL.

STRUCTURAL FILL AND COMPACTION

- 1. STRUCTURAL FILL SHALL BE A CLEAN GRANULAR FILL FREE OF ROCK FRAGMENTS GREATER THAN 6 INCHES, TOPSOIL, ORGANICS, OR ANY OTHER UNSUITABLE MATERIAL, SHALL HAVE A LOW TO MODERATE PLASTICITY, UNIFORM COMPOSITION, PLASTICITY INDEX (PI) LESS THAN 30 PERCENT, STANDARD PROCTOR (ASTM D698) MAXIMUM DRY DENSITY OF AT LEAST 90 POUNDS PER CUBIC FOOT (PCF), AND SHALL BE APPROVED BY A QUALIFIED GEOTECHNICAL ENGINEER.
- 2. STRUCTURAL FILL SHALL BE PLACED IN UNIFORM HORIZONTAL LAYERS NOT EXCEEDING 8 INCHES IN LOOSE THICKNESS AND SHALL BE COMPACTED TO A MINIMUM SOIL DENSITY OF 95% OF THE MODIFIED PROCTOR TEST (ASTM D1557).


FOUNDATIONS:

- 1. THE SOIL IMMEDIATELY BENEATH AND TO A MINIMUM DEPTH OF 12 INCHES BELOW THE FOOTINGS SHALL BE COMPACTED TO A MINIMUM SOIL DENSITY OF 98% OF THE MODIFIED PROCTOR TEST (ASTM D1557).
- 2. ALL FOUNDATION EXCAVATIONS SHALL BE OBSERVED AND TESTED TO VERIFY THAT IN-SITU SOIL BEARING PRESSURES, COMPATIBLE WITH THE DESIGN VALUE, ARE ACHIEVED.
- 3. ALL FOUNDATIONS SHALL BE FORMED TO PREVENT THE CREATION OF AN ENLARGED AREA OF CONCRETE (MUSHROOM)
- 4. FOUNDATION EXCAVATIONS SHALL BE OBSERVED, AND CONCRETE PLACED AS QUICKLY AS POSSIBLE TO AVOID EXPOSURE OF THE FOUNDATION BEARING SOILS TO WETTING AND DRYING. SURFACE WATER RUNOFF SHALL BE DRAINED AWAY FROM THE EXCAVATIONS AND NOT BE ALLOWED TO POND. THE FOUNDATION CONCRETE SHALL BE PLACED DURING THE SAME DAY THE EXCAVATION IS MADE. IF IT IS REQUIRED THAT FOOTING EXCAVATIONS BE LEFT OPEN FOR MORE THAN ONE DAY, THEY SHALL BE PROTECTED TO REDUCE EVAPORATION AND ENTRY OF MOISTURE.

<u>SLAB-ON-GRADE:</u>

- 1. 6 INCHES (MIN) OF COMPACTED STRUCTURAL FILL SHALL BE PLACED UNDER THE SLAB-ON-GRADE
- 2. PROVIDE ASTM E1745 15 MIL VAPOR BARRIER BELOW SLAB ON GRADE.

COMPONENTS AND CLADDING WIND PRESSURES (PSF)				
ONE	EFFEC	EFFECTIVE WIND AREA (SF)		
ONE	10	50	100	500
123	+29.4	+23.3	+20.8	+20.8
1	-46.6	-43.6	-42.3	-42.3
2	-81.1	-66.0	-59.6	-59.6
3	-119.9	-101.8	-94.0	-94.0
2	-102.7	-102.7	-102.7	-102.7
3	-167.3	-131.2	-115.6	-115.6
45	+50.9	+45.6	+43.3	+38.0
4	-55.2	-49.9	-47.6	-42.3
(5)	-68.1	-57.5	-52.9	-42.3
	WIND ONE 1 2 3 2 3 4 5 4 6	WIND PRESS ONE EFFEC	WIND PRESSURES (ONE	WIND PRESSURES (PSF) ONE EFFECTIVE WIND ARI 10

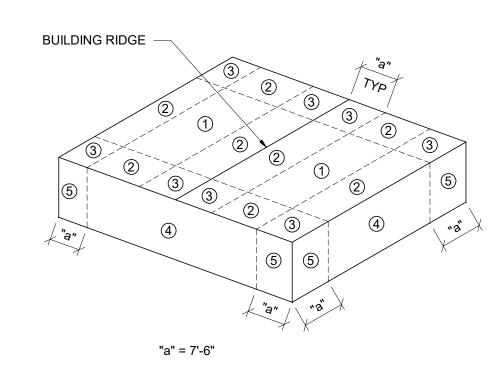

- ALL WIND LOADS SHOWN ARE ULTIMATE PER ASCE 7-10 AND UNITS PSF.
- 2. PLUS AND MINUS SIGNS SIGNIFY PRESSURES ACTING TOWARDS AND AWAY FROM THE SURFACES, RESPECTIVELY.
- 3. EACH COMPONENT SHALL BE DESIGNED FOR MAXIMUM POSITIVE AND NEGATIVE PRESSURES.
- 4. EDGE ZONE ("a") IS DISTANCE FROM CORNERS OF BUILDINGS.
- 5. FOR EFFECTIVE AREAS BETWEEN VALUES GIVEN, INTERPOLATION MAY BE USED. OTHERWISE, USE THE LOWER EFFECTIVE AREA.
- 6. ALL ROOF CANOPIES SHALL BE DESIGNED USING ZONE 3 ROOF OVERHANG PRESSURES. SEE ARCH FOR LOCATIONS.

COMPONENTS AND CLADDING

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PENSACOLA, FLORIDA

PENSACOLA GENERAL **AVIATION** FACILITY (GAF)



PROFESSIONAL SEAL



REVISIONS NO. DESCRIPTION DATE

DATE ISSUED:	03/03/2020
REVIEWED BY:	RLM
DRAWN BY:	СММ
DESIGNED BY:	CMM


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SHEET TITLE

DESIGN CRITERIA AND STRUCTURAL

SHEET NUMBER



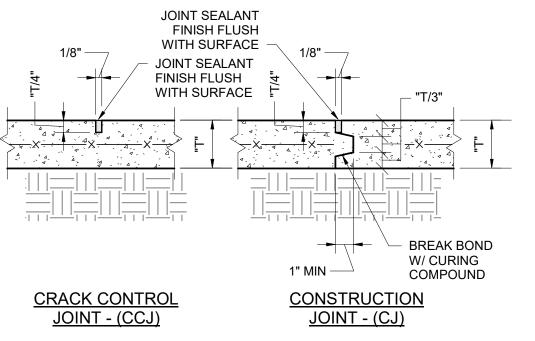


1. CCJ SHALL BE PREFORMED OR SAWED. IF SAWED, SAWING MUST TAKE PLACE WITHIN 12 HOURS OF SLAB PLACEMENT.


2. USE CJ INSTEAD OF CRACK CONTROL JOINT WHEREVER CONSTRUCTION IS STOPPED OR WHERE CALLED FOR ON PLAN.

TYPICAL SLAB ON GRADE JOINT DETAILS

S002 SCALE: N.T.S.

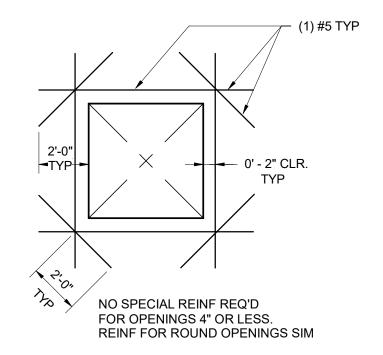

SLAB OPENING REINFORCING

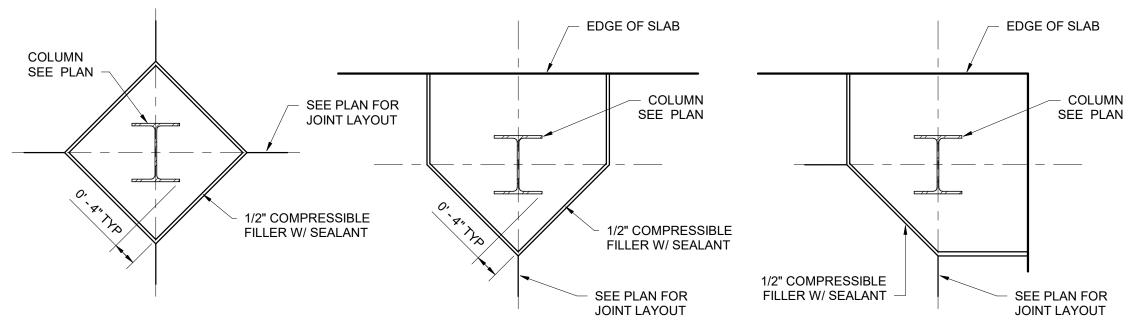

TYPICAL BLOCKOUT @ COLUMNS

TYPICAL LAP

SPLICE SCHEDULE

SPLICE

2'-0"

2'-8"

3'-4"

4'-0"

5'-10"

6'-8"

7'-6"

(CONCRETE)

BAR

SIZE

#3

#4

#5


#6

#7


#8

#9


S002 SCALE: N.T.S.

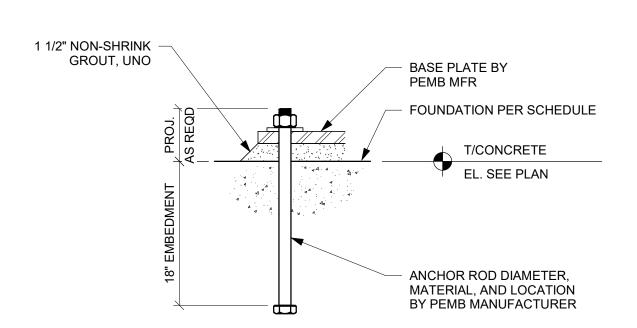



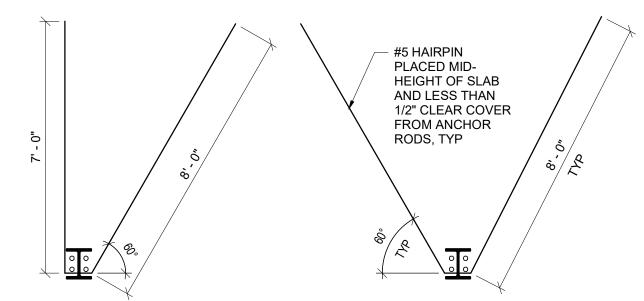



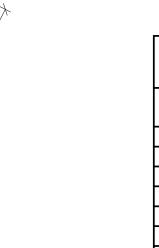

TYPICAL LAP SPLICE SCHEDULE (MASONRY)				
BAR SIZE	LAP SPLICE			
#3	2'-3"			
#4	3'-0"			
#5	3'-9"			
#6	4'-6"			


BARS PER CELL

(1) #5


(1) #5

TYPICAL LAP SPLICES

CONCRETE NOTES: 1. TABULATED VALUES ARE BASED ON THE FOLLOWING: NORMAL WEIGHT CONCRETE. UNCOATED GRADE 60 REINFORCING BARS. CLEAR COVER NOT LESS THAN 1.0 x BAR DIAMETER CLEAR SPACING NOT LESS THAN 2.0 x BAR DIAMETER. LAP CLASS B. f'c = 4500 psi.2.TOP BARS ARE HORIZONTAL BARS WITH MORE THAN 12 INCHES OF CONCRETE CAST BELOW THE BARS.

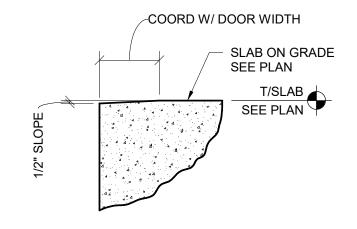


SECTION AT DOOR S002 SCALE: N.T.S.

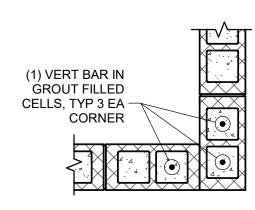


MASONRY CORNER DETAIL

MASONRY DETAILS


S002 SCALE: N.T.S.

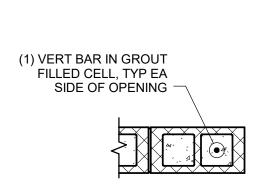

MASONRY END OF WALL DETAIL

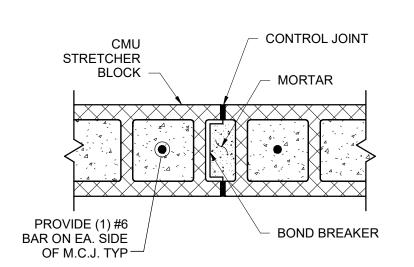


9 MASONRY CONTROL JOINT DETAIL
10 MASONRY JAMB SCHEDULE
10 S002 SCALE: N.T.S.

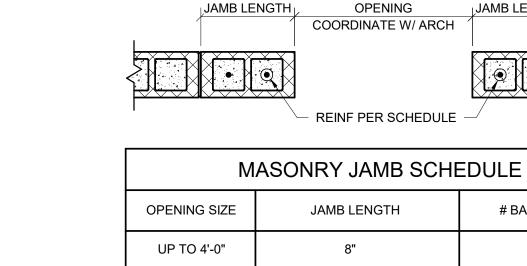

4'-1" TO 6'-0"

16"

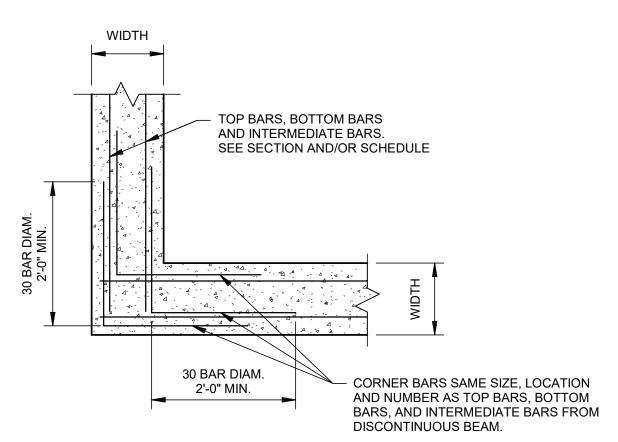



TYPICAL SECTIONS AND

DETAILS

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PENSACOLA

GENERAL

AVIATION

FACILITY (GAF)

PROFESSIONAL SEAL

NO. DESCRIPTION DATE

REVISIONS

DATE ISSUED:

REVIEWED BY:

DESIGNED BY:

PROJECT NUMBER:


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S002

BID DOCUMENTS

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87' - 9"

REFERENCE ELEVATION 100'-0" = 103.25 N.G.V.D. 88 (SEE CIVIL)

TOP OF SLAB ELEVATION = 100'-0" UON

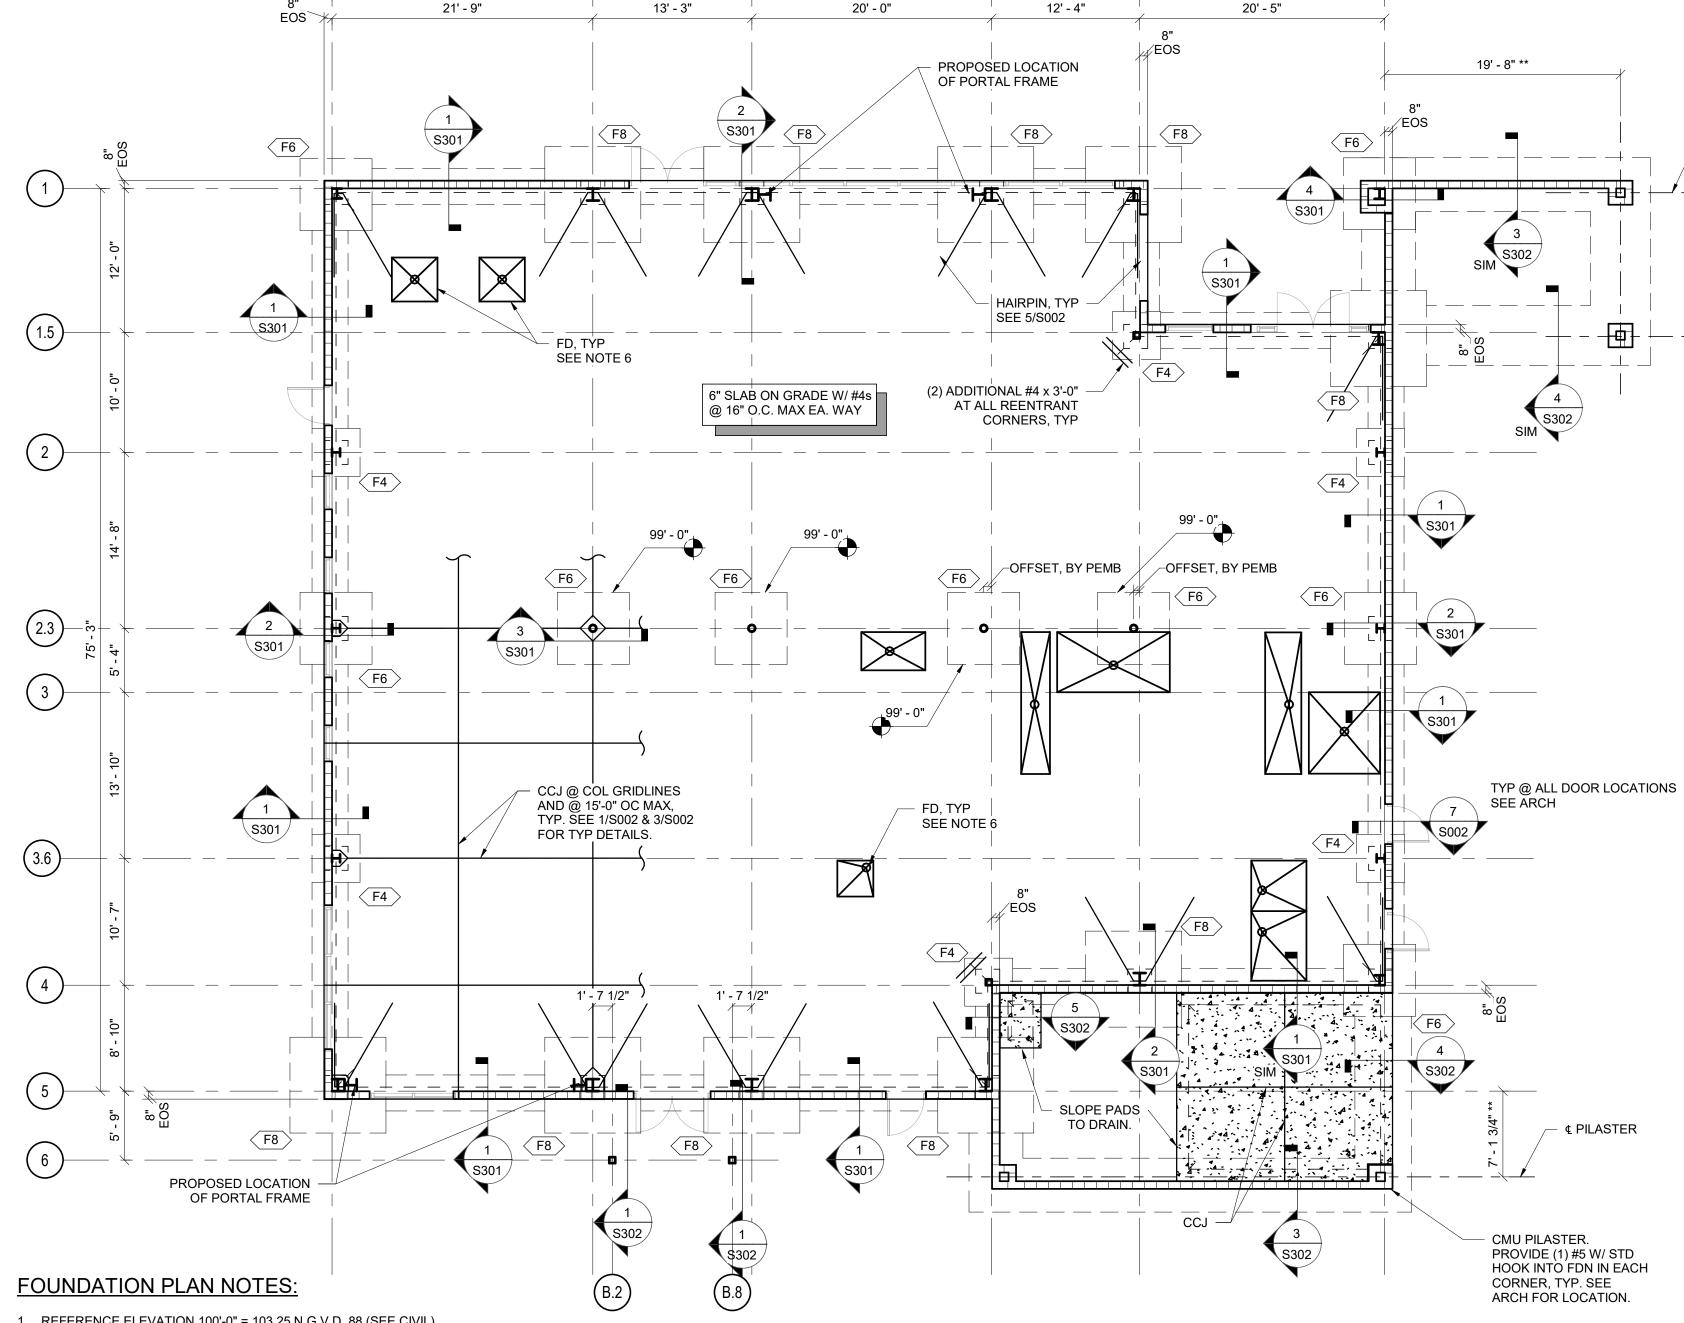TOP OF FOOTING ELEVATION = SEE SCHEDULE COLUMN FOOTING IS CENTERED ON COLUMN BASE PLATE.

5. SEE 4/S002 FOR TYPICAL ANCHOR ROD DETAIL. 6. FD = FLOOR DRAIN. SEE PLUMBING AND ARCH FOR LOCATION AND SLAB SLOPES.

7. ** DENOTES COORDINATE WITH ARCHITECTURAL PLANS FOR LOCATION.


FOUNDATION PLAN

S101 | SCALE: 1/8" = 1'-0"

FOUNDATION SCHEDULE

DESIGNATION	LENGTH x WIDTH	THICKNESS	REINFORCEMENT	TOP OF FOOTING ELEVATION
F4	4'-0"x4'-0"	1'-6"	#6 @ 12" OC MAX T&B EW	98'-0"
F5	5'-0"x5'-0"	2'-0"	#7 @ 12" OC MAX T&B EW	98'-0"
F6	6'-0"x6'-0"	2'-0"	#7 @ 12" OC MAX T&B EW	98'-0" (TYP, UON)
F8	8'-0"x8'-0"	2'-0"	#7 @ 12" OC MAX T&B EW	98'-0"

FOUNDATION SCHEDULE

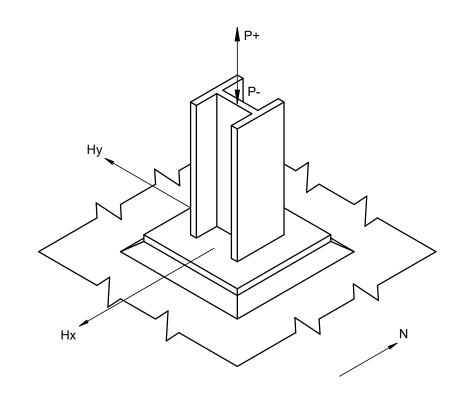

METAL BUILDING				
COLUMN LOCATION		Р	Hx	Ну
A/1	+ 11.5	- 3.00	± 0.00	± 5.50
B/1, C/5, D/5,	+ 12.0	- 8.75	± 0.00	± 6.00
E/1, E/4	+ 25.0	- 17.0	± 0.00	± 8.00
F/1.5, F/4	+ 15.5	- 7.50	± 0.00	± 4.50
E/1.5, D/4	+ 0.00	- 5.00	± 4.50	± 4.50
B/2.3, C/2.3, D/2.3, E/2.3	+ 16.0	- 16.5	± 0.00	± 0.00
A/2, A/3.6, F/2	+ 0.00	- 8.00	± 9.00	± 0.00
C/1, D/1, A/5, B,5	+ 20.0	- 13.0	± 14.0	± 6.00
F/1	+ 25.0	- 17.0	± 0.00	± 0.00
A/2.3, F/3	+ 15.0	- 25.5	± 9.00	± 0.00


NOTES:

— ⊈ PILASTER, TYP

- 1. ALL REACTIONS ARE PER 2017 FBC LRFD LOAD COMBINATIONS (KIPS)
- 2. P(+), Hx AND Hy ARE DUE TO WIND LOADS
- 3. FOUNDATION DESIGN FOR METAL BUILDING COLUMNS IS PRELIMINARY. FOUNDATION AS SHOWN ON PLANS IS NOT FOR CONSTRUCTION. PRIOR TO FABRICATION AND CONSTRUCTION METAL BUILDING MANUFACTURER SHALL SUBMIT SIGNED AND SEALED COLUMN REACTIONS TO ENGINEER FOR VERIFICATION THAT PRELIMINARY FOUNDATION DESIGN COMPLIES WITH ALL APPLICABLE CODES. SEE DEFERRED SUBMITTAL FOR ADDITIONAL REQUIREMENTS.

METAL BUILDING REACTIONS

S101 SCALE: N.T.S.

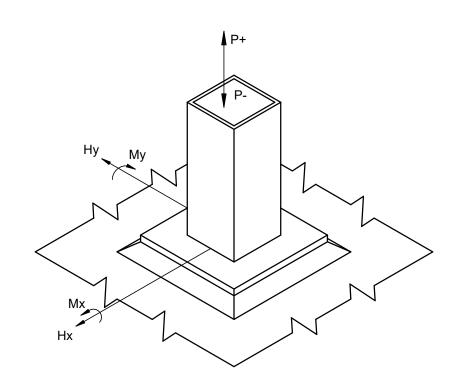


CANOPY						
COLUMN	I)	Hx	Ну	Mx	Му
B.2/6, B.8/6	+ 2.0	- 15.0	± 1.00	± 1.00	± 10.00	± 10.00

NOTES:

- 1. ALL REACTIONS ARE IN KIPS AND MOMENTS IN KIP-FT.
- 2. P(+), Hx AND Hy ARE DUE TO WIND LOAD
- 3. FOUNDATION DESIGN COMPLIES WITH ALL APPLICABLE CODES. FOUNDATION DESIGN FOR CANOPY COLUMNS IS PRELIMINARY, BASED ON PRELIMINARY REACTIONS. FOUNDATION AS SHOWN ON PLANS IS NOT FOR CONSTRUCTION . PRIOR TO FABRICATION AND CONSTRUCTION CANOPY MANUFACTURER SHALL SUBMIT SIGNED AND SEALED COLUMN REACTIONS TO ENGINEER FOR VERIFICATION THAT PRELIMINARY FOUNDATION DESIGN COMPLIES WITH ALL APPLICABLE CODES. SEE DEFERRED SUBMITTAL FOR ADDITIONAL REQUIREMENTS.



S101 SCALE: N.T.S.

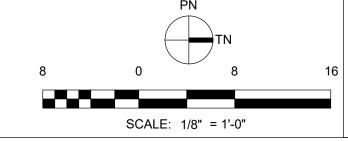



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PROFESSIONAL SEAL



REVISIONS				
NO.	DESCRIPTION	DATE		

DATE	ISSUED:	03/03/2020
REVIE	WED BY:	RLM
DRAW	N BY:	CMM

DESIGNED BY: PROJECT NUMBER: 201-0052-002

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SHEET TITLE


FOUNDATION PLAN

SHEET NUMBER

S101

S301 SCALE: 3/4" = 1'-0"


S301 SCALE: 3/4" = 1'-0"

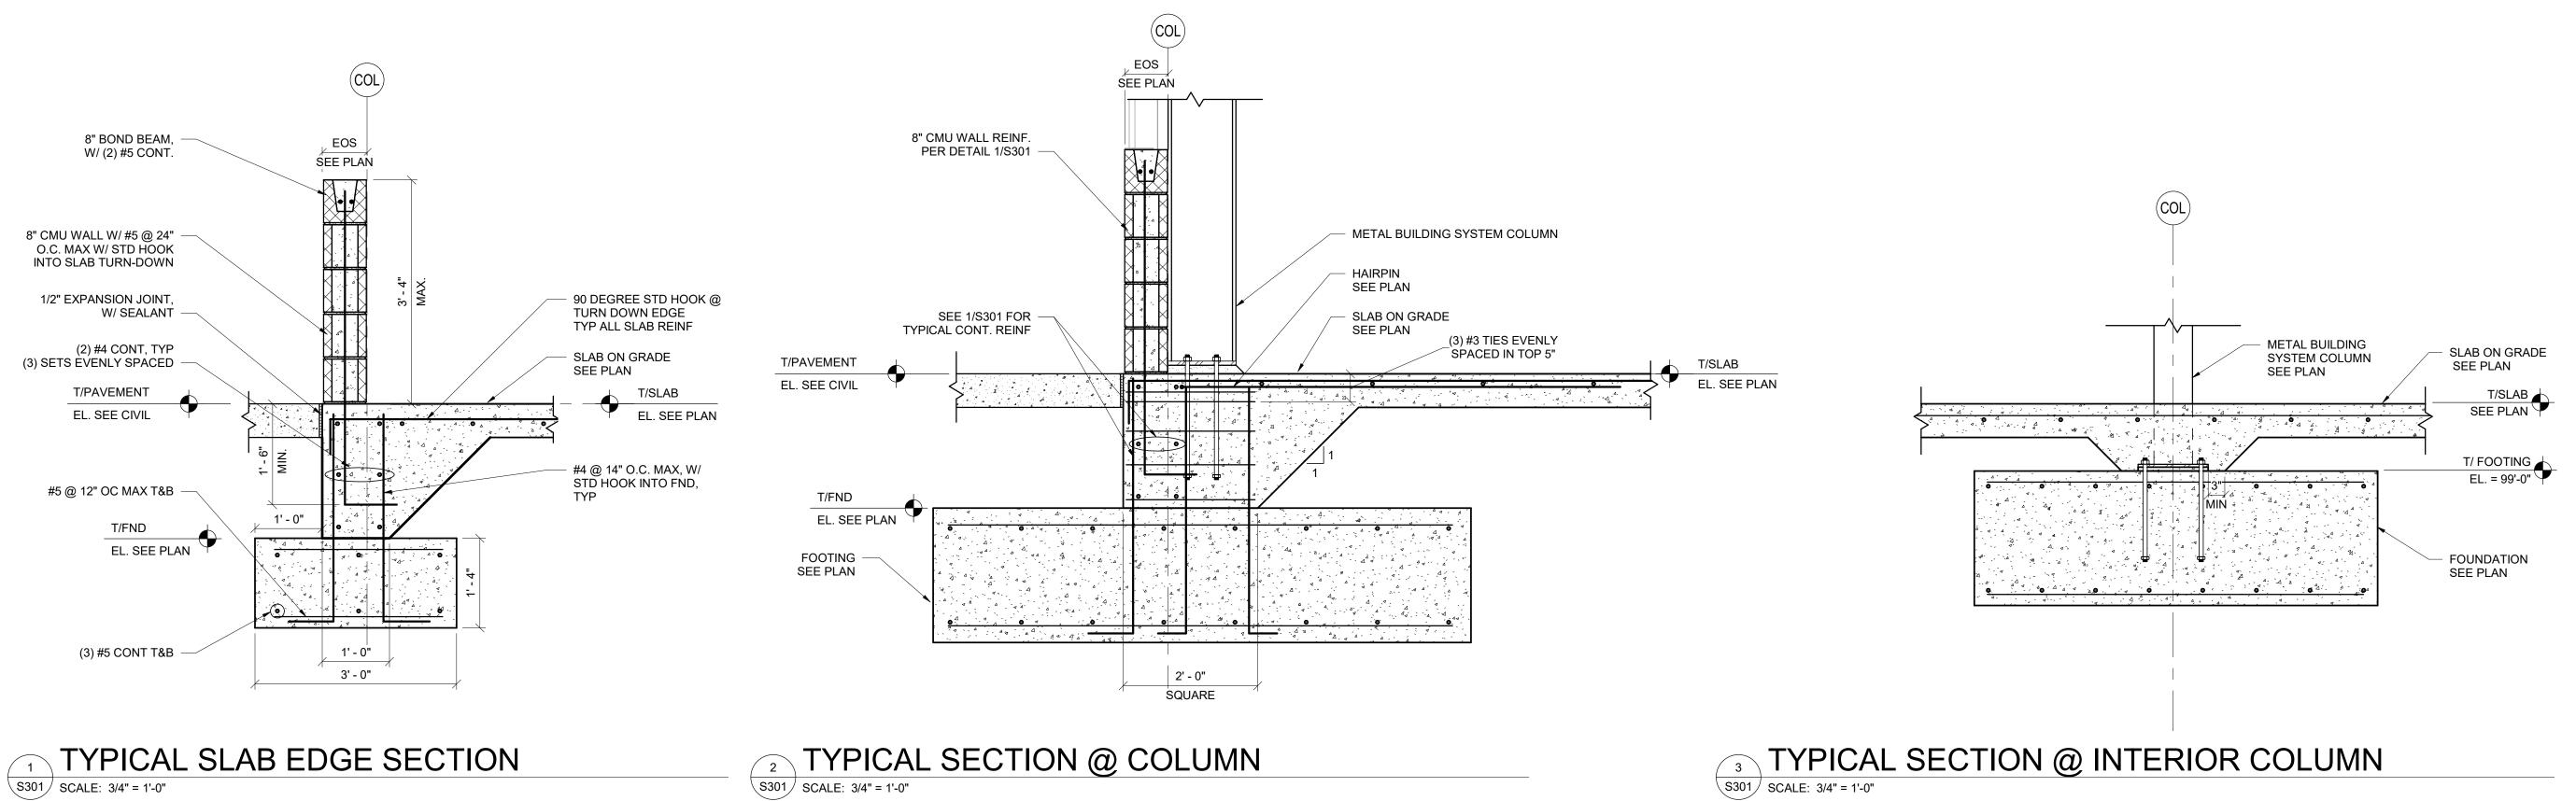



#3 TIES @ 6" OC MAX. PROVIDE (3) ADDITIONAL #3

PILASTER EVENLY SPACED.


TIES WITHIN TOP 5" OF

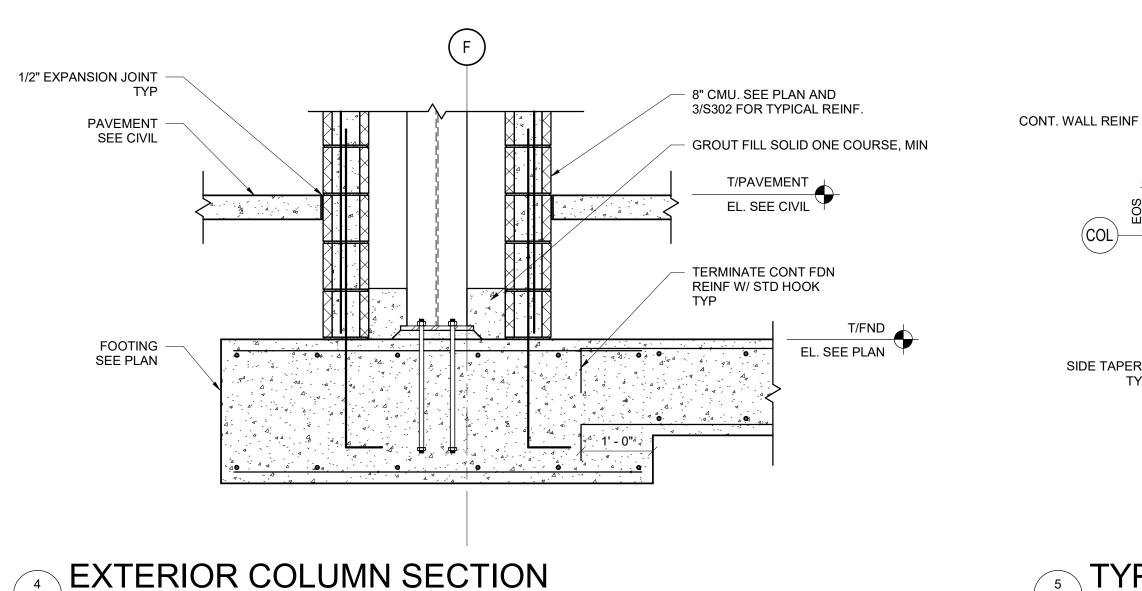

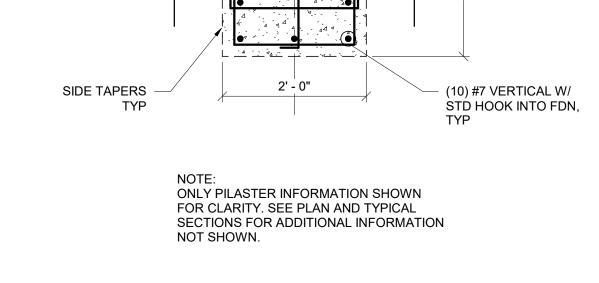


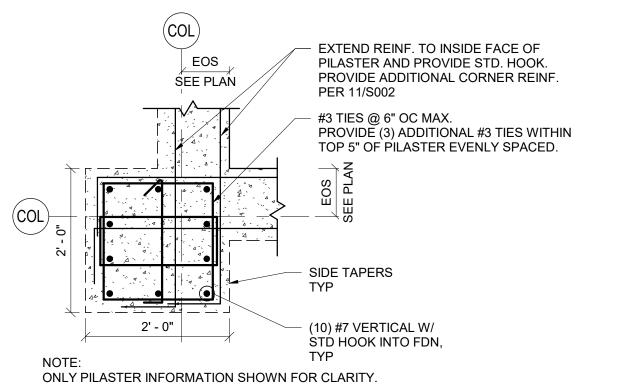

TYPICAL PILASTER DETAIL S301 | SCALE: 3/4" = 1'-0"

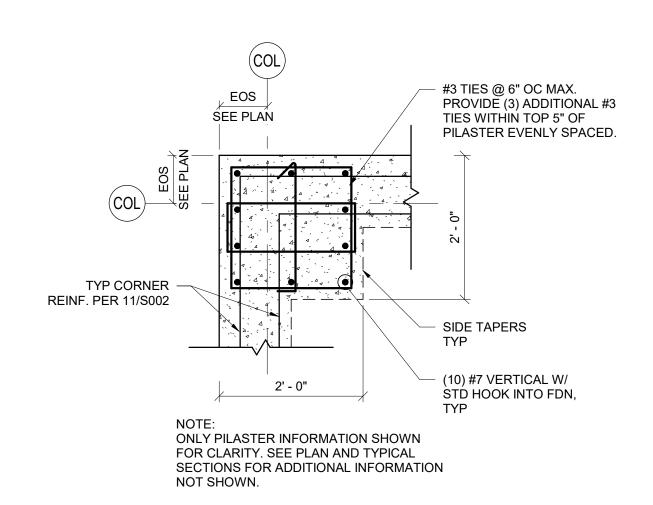

TYPICAL CORNER COLUMN PILASTER DETAIL S301 SCALE: 3/4" = 1'-0"

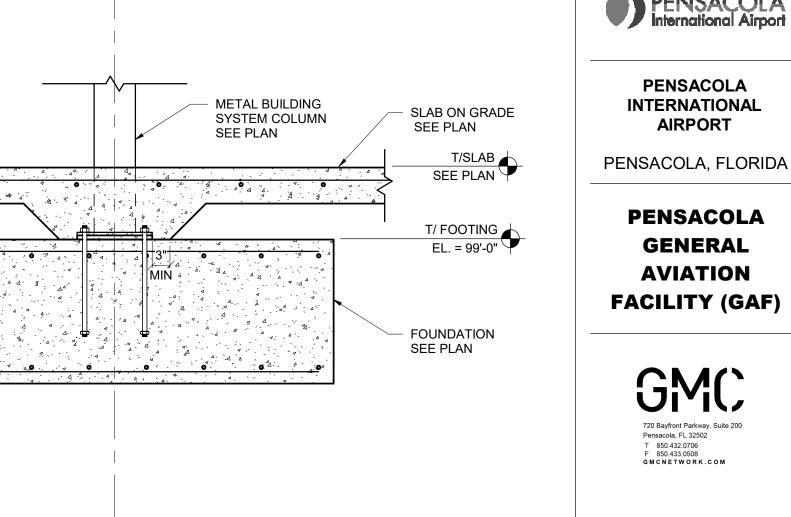

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DATE ISSUED:	03/03/2020
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DRAWN BY:	CMM

DESIGNED BY: PROJECT NUMBER:

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SHEET TITLE

SECTIONS AND DETAILS

SHEET NUMBER

S301


BID DOCUMENTS

TYPICAL REENTRANT CORNER PILASTER DETAIL

SEE PLAN AND TYPICAL SECTIONS FOR ADDITIONAL

INFORMATION NOT SHOWN.

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MONUMENT SIGN, SEE ARCH FOR ADDITIONAL INFORMATION PRECAST CAP, SEE ARCH FOR ADDITIONAL INFORMATION 8" BOND BEAM W/ (2) #5 CONT, TYP 8" CMU WALL W/ #5 @ 24" O.C. MAX, TYP 1/2" EXPANSION JOINT, W/ SEALANT, TYP SIDEWALK/APRON SEE CIVIL T/PAVEMENT EL. SEE CIVIL GROUT SOLID ALL CELLS BELOW GRADE DOWELS W/ STD HOOK INTO FND TO MATCH WALL TYP 4 SIDES (4) #5 CONT T&B #5 @ 10" OC MAX, TOP & BOTTOM, 4' - 4" **EACH WAY**
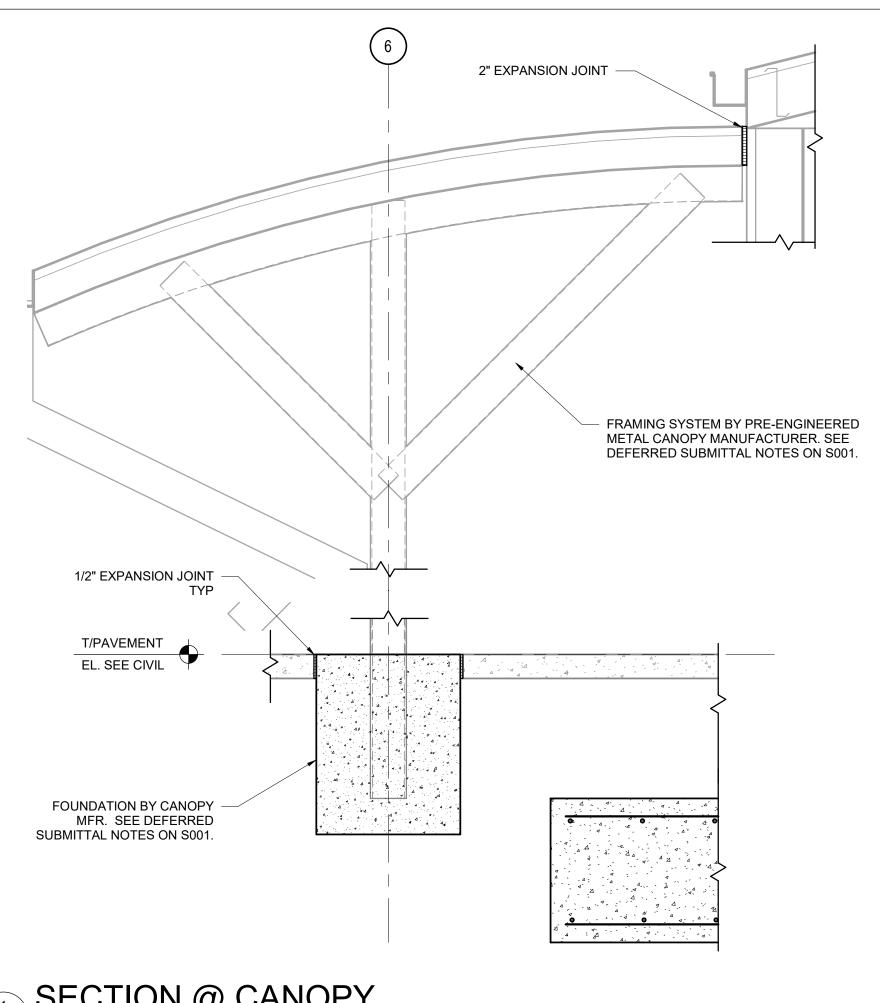
#4 @ 12" OC MAX EW

SECTION

S302 SCALE: 3/4" = 1'-0"

TYP 1/2" EXPANSION JOINT

- DOWEL W/ STD HOOK INTO FND TO MATCH WALL 1/2" EXPANSION JOINT, W/ SEALANT, TYP **GROUT SOLID ALL** CELLS BELOW GRADE T/PAVEMENT EL. SEE PLAN EL. SEE CIVIL VERT REINF IN SIZE & SPACING, TYP - #4 @12" OC MAX SEE PLAN 4' - 6" - #5 @ 10" OC MAX NOTE: MONUMENT SIGN IS AN ADDITIVE ALTERNATE. SEE ARCHITECTURAL DRAWINGS FOR LOCATION AND ADDITIONAL INFORMATION.

SEE 1/S301 FOR

TYPICAL DETAIL


8" BOND BEAM W/ -

8" CMU WALL W/

#5 @ 24" O.C. MAX. GROUT


(2) #5 CONT.



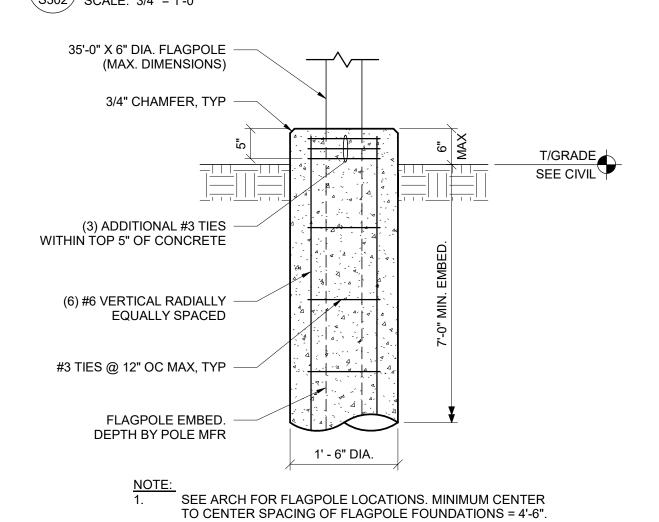


FLAGPOLE FOUNDATION S302 SCALE: 3/4" = 1'-0"

S302 SCALE: 3/4" = 1'-0" SECTION @ CANOPY S302 SCALE: 3/4" = 1'-0"

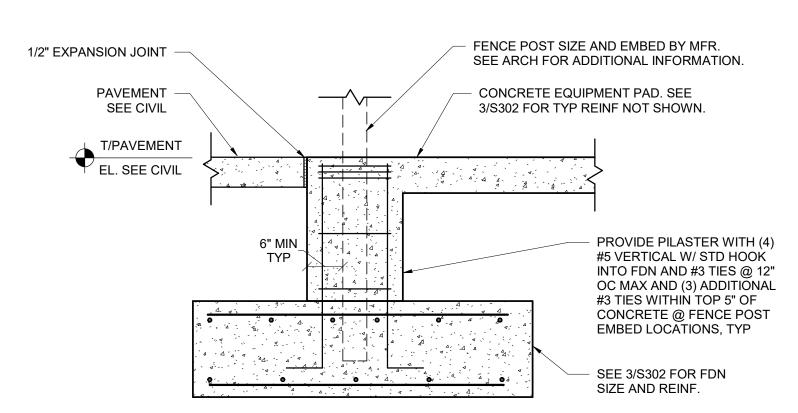

SECTION 4 S302 SCALE: 3/4" = 1'-0"

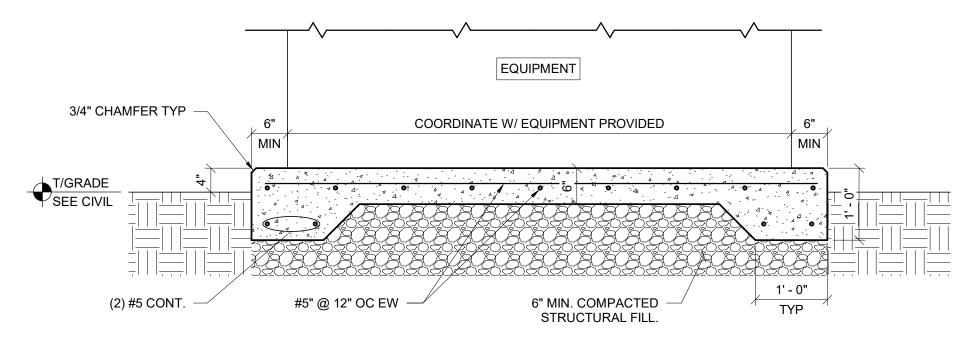


NOTE: SEE ARCH AND ELECTRICAL FOR LOCATION.

GENERATOR PAD

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S302 SCALE: 3/4" = 1'-0" Copyright © 2020. This drawing is an instrument of service and property of RS&H, Inc. Any use or reproduction without the

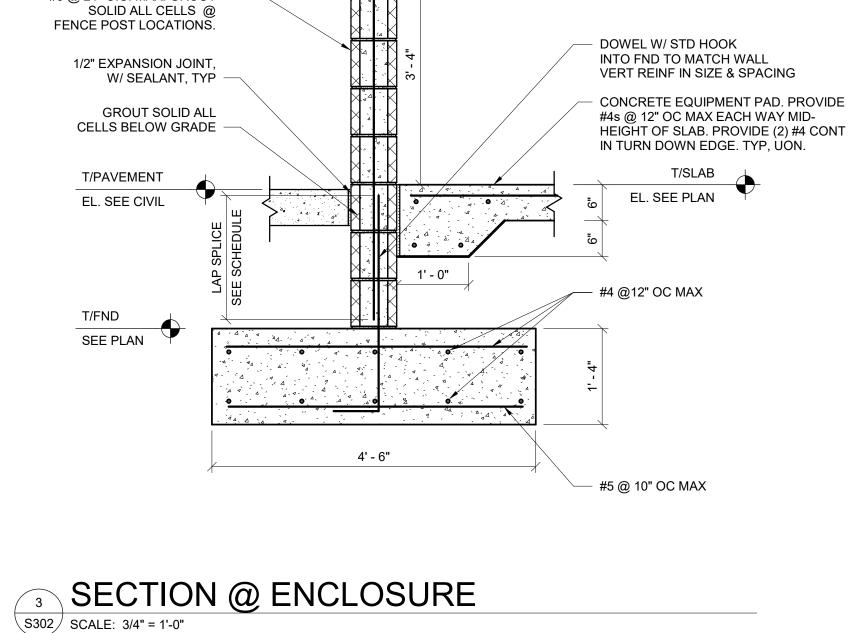

FENCE (6'-0" MAX ABOVE

CMU WALL), SEE ARCH FOR ADDITIONAL INFORMATION

PRECAST CAP, SEE ARCH FOR ADDITIONAL INFORMATION

> 03/03/2020 DATE ISSUED: RLM **REVIEWED BY:** CMM DRAWN BY: CMM **DESIGNED BY:**

REVISIONS

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SHEET TITLE

SECTIONS AND DETAILS

SHEET NUMBER

S302


PROJECT GENERAL NOTES:


TO THOSE DETAILED.

- 1. ALL WORK SHALL CONFORM TO ALL APPLICABLE CODES, STANDARDS AND GOVERNING
- 2. REFER TO CIVIL, ARCHITECTURAL, STRUCTURAL, MECHANICAL, PLUMBING, FIRE-PROTECTION, ELECTRICAL, SIGNAGE AND BAGGAGE SYSTEM DRAWINGS AND SPECIFICATIONS FOR COORDINATION OF WORK.
- 3. EACH SUBCONTRACTOR SHALL VISIT THE SITE AND BECOME KNOWLEDGEABLE OF CONDITIONS THEREIN. EACH TRADE CONTRACTOR SHALL INVESTIGATE, VERIFY AND BE RESPONSIBLE FOR ALL THE REQUIREMENTS OF THE PROJECT AND SHALL NOTIFY THE ARCHITECT AND OWNER OF ANY CONDITIONS REQUIRING INFORMATION BEFORE PROCEEDING WITH THE WORK.
- 4. THE SUBCONTRACTORS SHALL PROTECT ALL EXISTING SITE ELEMENTS FROM DAMAGE DUE TO CONSTRUCTION OPERATIONS AND REPAIR OR REPLACE ELEMENTS DAMAGED DURING
- 5. ANY UTILITY SHUT-OFFS AS REQUIRED BY THE CONTRACTOR FOR COMPLETION OF THE WORK SUCH AS ELECTRICAL, GAS, WATER, SEWER, STEAM, ETC. MUST BE SCHEDULED WITH THE OWNER 72 HOURS PRIOR TO COMMENCING THE WORK.
- DRAWINGS ARE TO BE ISSUED TO THE SUBCONTRACTORS IN COMPLETE SETS SO THAT THE EXTENT AND COORDINATION OF THE WORK IS MADE POSSIBLE.
- 7. DETAILS SHOWN ARE INTENDED TO BE INDICATIVE OF THE PROFILES AND TYPE OF DETAILING REQUIRED FOR THE WORK. DETAILS NOT SHOWN ARE SIMILAR IN CHARACTER
- 8. WHERE SPECIFIC DIMENSIONS, DETAILS AND DESIGN INTENT CANNOT BE DETERMINED, NOTIFY THE ARCHITECT IN WRITING BEFORE PROCEEDING WITH ANY WORK IN QUESTION.
- DIMENSIONS SHALL GOVERN. DO NOT SCALE DRAWINGS. THE CONTRACTOR SHALL NOTIFY THE ARCHITECT IN WRITING OF ANY DISCREPANCIES, OMISSIONS AND/OR CONFLICTS BEFORE PROCEEDING WITH THE WORK.
- 10. ALL DIMENSIONS SHALL BE VERIFIED ON THE SITE BEFORE PROCEEDING WITH THE WORK. NOTIFY THE ARCHITECT IN WRITING OF ANY DISCREPANCIES.
- 11. UNLESS NOTED OTHERWISE ALL NEW WALLS AND PARTITIONS ARE DIMENSIONED TO THE FACE OF THE STUD OR FACE OF THE BLOCK.
- 12. UNLESS NOTED OR DIMENSIONED OTHERWISE, ALL DOORS ARE LOCATED BY THE JAMB DETAIL AND/OR FLOOR PLAN DIMENSIONS. RELATIVE TO THE ADJACENT WALLS AND
- 13. UNLESS NOTED OTHERWISE, ALL FASTENERS AND FASTENING DEVICES ARE TO BE CONCEALED IN ALL FINISHED SPACES.
- 14. ANY PIPING, DUCTS, CONDUITS, ETC. THAT PENETRATE FIRE-RATED FLOOR SLABS AND WALLS SHALL BE INSTALLED IN A MANNER THAT WILL PRESERVE THE FIRE INTEGRITY OF THE FLOOR OR WALL WHERE PENETRATIONS OCCUR. PROVIDE FIRE DAMPERS IN DUCTS PENETRATING FIRE-RATED WALLS TO MEET THE APPLICABLE BUILDING CODES. REFER TO MECHANICAL, ELECTRICAL, PLUMBING AND FIRE-PROTECTION DRAWINGS FOR EXTENT AND FIRE-RATING REQUIREMENTS. THE FIRE-RATING OF THE FIRE-STOPPING MUST BE EQUAL OR GREATER TO THE MINIMUM FIRE-RATING OF THE FLOOR, ROOF OR WALL ASSEMBLY.


- 15. ALL JOINTS OF ANY ELEMENT OF CONSTRUCTION WHICH ARE REQUIRED TO HAVE A FIRE-RESISTANCE RATING SHALL BE INSTALLED PER THE MANUFACTURER'S PUBLISHED TESTED ASSEMBLIES, SHALL BE TIGHT AND SHALL PREVENT THE PASSAGE OF SMOKE AND FLAME.
- 16. WHERE THE FIRE RATING OF WALLS ARE NOTED ON THE DRAWINGS, THE FIRE RATING SHALL APPLY TO THE ENTIRE PERIMETER ENCLOSURE OF THE ROOM OR SPACE FOR THE FULL LENGTH AND HEIGHT OF AREAS BEING SEPARATED,
- 17. PROVIDE FIRE STOPS TO SEPARATE WALL CAVITIES FROM HORIZONTAL PLENUM AREAS AND BETWEEN FLOORS TO CLOSE THE OPENINGS. FIRE RATING OF STOPS SHALL MATCH THE FIRE RATING OF VERTICAL SEPARATION OR FLOOR CONSTRUCTION, WHICHEVER IS GREATER.
- 18. ALL DISSIMILAR METALS SHALL BE EFFECTIVELY ISOLATED FROM EACH OTHER BY GASKETS OR COATINGS OR BOTH TO AVOID GALVANIC CORROSION ACTION.
- 19. ALL FERROUS METAL WORK LOCATED ON THE EXTERIOR OR IN NONCONDITIONED SPACES (INTERIOR) SHALL BE HOT-DIPPED GALVANIZED (MINIMUM G-90 COATING
- 20. PROVIDE A 7'-6" MINIMUM HEADROOM CLEARANCE IN ALL EXIT PASSAGES AT ALL LOCATIONS (BENEATH SPRINKLER PIPING, LIGHTING, ETC.).
- 21. THE EXTENT OF THE WORK SHOWN ON THE PLANS AND DETAILS REFLECTS THE BEST JUDGMENT OF THE ARCHITECT/ENGINEER. THE CONTRACTOR SHALL FAMILIARIZE HIMSELF WITH THE EXISTING CONDITIONS AND ADVISE THE ARCHITECT IN WRITING OF ANY SITUATION THAT WOULD NOT ALLOW HIM TO PROCEED ON THE BASIS OF THESE DOCUMENTS.
- 22. THE ARCHITECT/ENGINEER SELECTION OF MATERIALS AND DETAILS DOES NOT RELIEVE THE CONTRACTOR FROM VERIFYING WITH THE MATERIAL SUPPLIERS THAT THE PROPOSED MATERIALS ARE CORRECT AND PROPER FOR THE INTENDED APPLICATION AND USE.
- 23. CONTRACTOR SHALL COORDINATE WITH EARLY CIVIL/STRUCTURAL FOUNDATION DOCUMENTS.
- 24. CONTRACTOR SHALL COORDINATE WITH SIGNAGE DOCUMENTS AND PROVIDE MOUNTING DEVICE INCLUDING FIRE RETARDANT TREATED BLOCKING FOR ALL EXTERIOR AND INTERIOR SIGNS.
- 25. ALL WOOD BLOCKING SHALL BE PRESSURE TREATED AND FIRE RETARDANT.
- 26. CONTRACTOR SHALL PROVIDE BLOCKING IN WALLS AND CEILINGS FOR WALL AND CEILING MOUNTED FURNITURE, FIXTURES, EQUIPMENT, AND ACCESSORIES.
- 27. CONTRACTOR SHALL PROVIDE STAINLESS STEEL CORNER GUARDS AT ALL OUTSIDE GWB CORNERS.
- 28. CONTRACTOR SHALL PROVIDE WALL/FLOOR MOUNTED DOOR STOPS AT ALL DOORS.

ADA MOUTING GUIDLINES AND DOOR CLEARANCE

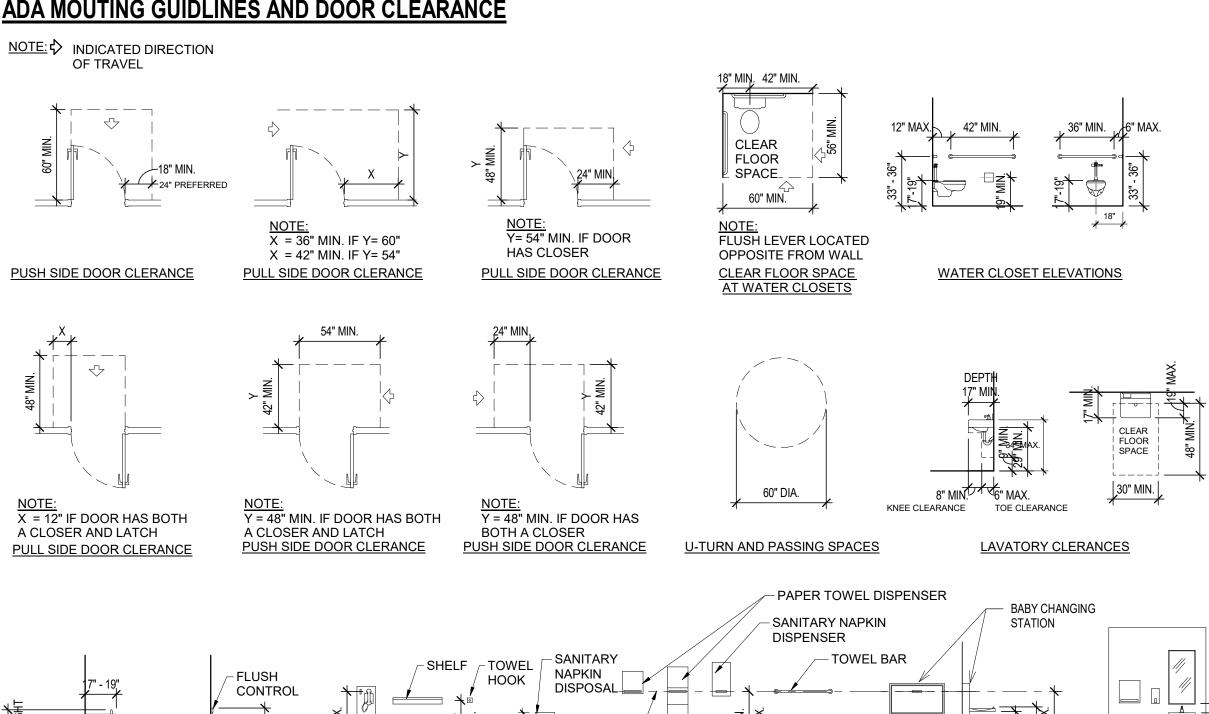

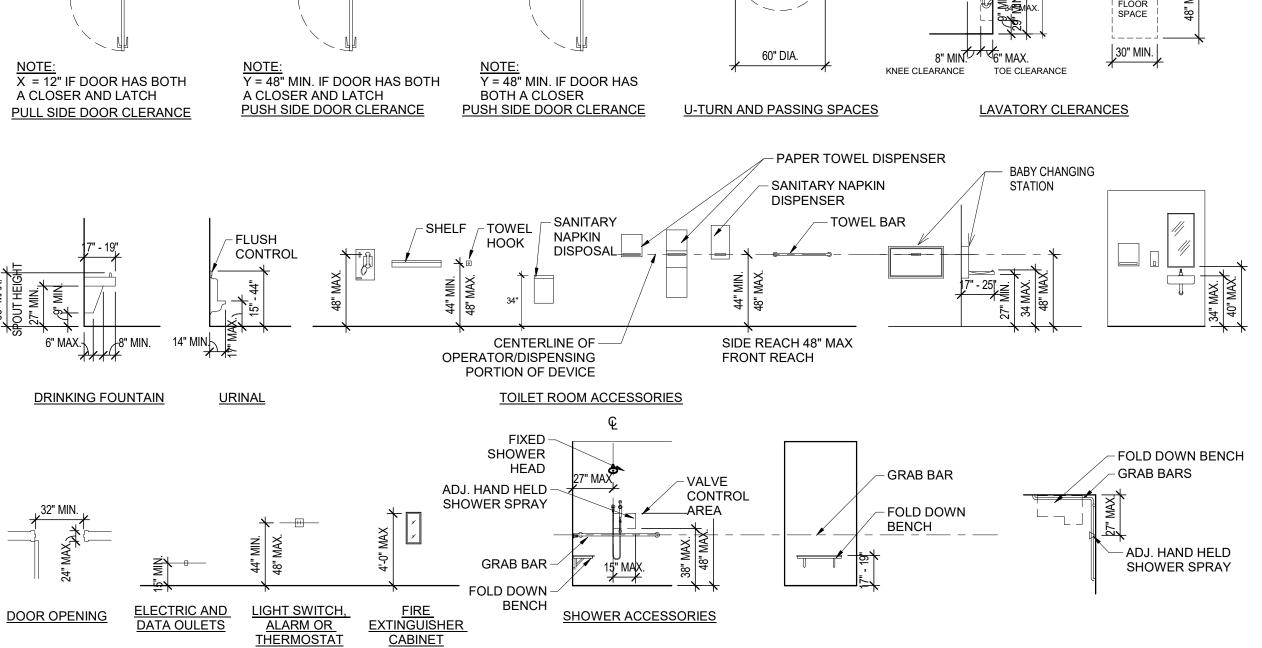

<u>ABBREVIATIONS</u>							
A.F.F.	ABOVE FINISHED FLOOR	EA.	EACH	K.P.	KICK PLATE	REINF.	REINFORCEMENT
A.C.T.	ACOUSTIC CEILING TILE	E.W.	EACH WAY			RESIST.	RESITANT
A.P.	ACCESS PANEL	E.D.	EXISTING DIMENSION	LAM.	LAMINATE	REQD.	REQUIRED
ADJ.	ADJACENT	ELEC.	ELECTRICAL	LAV.	LAVATORY	REV.	REVISION
A.H.U.	AIR HANDLING UNIT	E.W.C.	ELECTRICAL WATER COOLER	L.H.	LEFT HAND	R.H.	RIGHT HAND
A.T.O	AIRLINE TICKET OFFICE	EL.	ELEVATION	L.F.	LINEAR FEET	R.D.	ROOF DRAIN
ALT.	ALTERNATE	E.O.D.	EMERGENCY OVERFLOW DRAIN	L. PT.	LOW POINT	RM.	ROOM
ALUM.	ALUMINUM	ENCL.	ENCLOSURE			R.O.	ROUGH OPENING
APPROX.	APPROXIMATE	EQ.	EQUAL	MFR.	MANUFACTURER		
ARCH.	ARCHITECTURE	EQUIP.	EQUIPMENT	M.O.	MASONRY OPENING	SC.	SCALE
A.D.	AREA DRAIN	EXIST.	EXISTING	MATL.	MATERIAL	SCHED.	SCHEDULE
ASPH.	ASPHALT	E.J.	EXPANSION JOINT	MAX.	MAXIMUM	SEC.	SECTION
@	AT	EXP.	EXPOSED	MECH.	MECHANICAL	S.S.D.	SELF SERVICE DEVICE
AUTO.	AUTOMATIC	ETS.	EXPOSED TO STRUCTURE	MTL.	METAL	SHT.	SHEET
A.P.C.	AUTOMATIC PASSPORT CONTROL	E.T.D.	EXPLOSIVE TRACE DETECTION	M.S.F.	METAL STUD FRAMING	SIM.	SIMILAR
		EXT.	EXTERIOR	MIN.	MINIMUM	S.C.	SOLID CORE
BM.	BEAM	E.I.F.S.	EXTERIOR INSULATION FINISH SYSTEM	MIR.	MIRROR	SPEC.	SPECIFICATIONS
B.F.F.	BELOW FINISHED FLOOR			MISC.	MISCELLANEOUS	SQ.	SQUARE
B.M.	BENCH MARK	FT.	FEET	MR.	MOISTURE RESISTANT	S.F.	SQUARE FEET
BLKG.	BLOCKING	F.R.G.	FIBER REINF. GYPSUM	MRGWB	MOISTURE RESISTANT GWB	S.S.	STAINLESS STEEL
BD.	BOARD	F.R.G.	FINISH	MUL.	MULLION	STC.	SOUND TRANSMISSION CLASS
		F.F.L.					STANDARD
B.O.D.	BASIS OF DESIGN		FINISH FLOOR LEVEL	M.U.F.I.D.S.	MULTI USER FLIGHT INFORMATION DISPLAY SYSTEM	STD.	
BOT.	BOTTOM	F.E.	FIRE EXTINGUISHER	NOT		STL.	STEEL
BLDG.	BUILDING	F.E.C.	FIRE EXTINGUISHER CABINET	NOM.	NOMINAL	STRUCT.	STRUCTURAL
CAB.	CABINET	FFE	FURNITURE, FIXTURES AND EQUIPMENT	N.I.C.	NOT IN CONTRACT	SUSP.	SUSPENDED
C.R.	CARD READER	F.H.C.	FIRE HOSE CABINET	N.T.S.	NOT TO SCALE	SYM.	SYMBOL
CPT.	CARPET	F.H.R.	FIRE HOSE RACK	NO. or #	NUMBER	TAS	TOILET ACCESSORIES SCHEDULE
C.B.	CATCH BASIN	F.R.P.	FIRE RETARDANT PLYWOOD			TEL. or TELE.	TELEPHONE
CLG.	CEILING	F.V.C.	FIRE VALVE CABINET	O.C.	ON CENTER	TEMP.	TEMPERED
G or C.L.	CENTERLINE	FIXT.	FIXTURE	OPG.	OPENING	THR.	THRESHOLD
CTR.	CENTER	FLASH.	FLASHING	OPP. or OH	OPPOSITE or OPPOSITE HAND	THK.	THICKNESS
C.T.	CERAMIC TILE	FL.	FLOOR	OZ.	OUNCE	T.	TREAD
CLR.	CLEAR	F.D.	FLOOR DRAIN	O.D.	OUTSIDE DIAMETER	T.N.	TRUE NORTH
C.F.M.F.	COLD FORM METAL FRAMING	FLUOR.	FLUORESCENT	O.A.	OVERALL	T.O.S.	TOP OF STEEL
COL.	COLUMN	FTG.	FOOTING	OFRD	OVERFLOW ROOF DRAIN	T/SLAB	TOP OF SLAB
COMM.	COMMUNICATIONS	FDN.	FOUNDATION	O'HD. DR.	OVERHEAD DOOR	TYP.	TYPICAL
COMP.	COMPRESSIBLE	FR.	FRAME				
CONC.	CONCRETE	FURR.	FURRING	PEMB	PRE-ENGINEERED METAL BUILDING	U.L.	UNDERWRITERS LABRATORIES
CONC. BLK.	CONCRETE BLOCK			PTD.	PAINTED	U.O.N.	UNLESS OTHERWISE NOTED
CMU	CONCRETE MASONRY UNIT	GA.	GAUGE	PR.	PAIR		
CONN.	CONNECTION	GALV.	GALVINZED	P.J.	PANEL JOINT	V.B.	VAPOR BARRIER
CONST. JT.	CONSTRUCTION JOINT		GLASS				
•		⊢ GL.	GLASS	PLAS.	PLASTER	VEND.	VENDING
		GL. G.F.R.G.		PLAS. PLAM	PLASTER PLASTIC LAMINATE	VEND.	VENDING VENT
CONT.	CONTINUOUS	G.F.R.G.	GLASS FIBER REINF. GYPSUM	PLAM	PLASTIC LAMINATE	V.	VENT
CONT.	CONTINUOUS CONTROL JOINT	G.F.R.G. G.E.	GLASS FIBER REINF. GYPSUM GLOBAL ENTRY	PLAM PL.	PLASTIC LAMINATE PLATE	V. V.I.F.	VENT VERIFY IN FIELD
CONT. C.J. CORR.	CONTINUOUS CONTROL JOINT CORRIDOR	G.F.R.G. G.E. G.B.	GLASS FIBER REINF. GYPSUM GLOBAL ENTRY GRAB BAR	PLAM PL. PLMBG	PLASTIC LAMINATE PLATE PLUMBING	V. V.I.F. VERT.	VENT VERIFY IN FIELD VERTICAL
CONT.	CONTINUOUS CONTROL JOINT	G.F.R.G. G.E. G.B. GYP.	GLASS FIBER REINF. GYPSUM GLOBAL ENTRY GRAB BAR GYPSUM	PLAM PL. PLMBG PLYWD.	PLASTIC LAMINATE PLATE PLUMBING PLYWOOD	V. V.I.F. VERT. VEST.	VENT VERIFY IN FIELD VERTICAL VESTIBULE
CONT. C.J. CORR. CU.	CONTINUOUS CONTROL JOINT CORRIDOR CUBIC	G.F.R.G. G.E. G.B.	GLASS FIBER REINF. GYPSUM GLOBAL ENTRY GRAB BAR	PLAM PL. PLMBG PLYWD. PVC.	PLASTIC LAMINATE PLATE PLUMBING PLYWOOD POLYVINYLCHLORIDE	V. V.I.F. VERT. VEST. V.C.T.	VENT VERIFY IN FIELD VERTICAL VESTIBULE VINYL COMPOSITION TILE
CONT. C.J. CORR. CU. DEG.	CONTINUOUS CONTROL JOINT CORRIDOR CUBIC DEGREE	G.F.R.G. G.E. G.B. GYP. GWB	GLASS FIBER REINF. GYPSUM GLOBAL ENTRY GRAB BAR GYPSUM GYPSUM BOARD	PLAM PL. PLMBG PLYWD. PVC. PT.	PLASTIC LAMINATE PLATE PLUMBING PLYWOOD POLYVINYLCHLORIDE POINT	V. V.I.F. VERT. VEST. V.C.T. V.W.C.	VENT VERIFY IN FIELD VERTICAL VESTIBULE VINYL COMPOSITION TILE VINYL WALL COVERING
CONT. C.J. CORR. CU. DEG. DEMO.	CONTINUOUS CONTROL JOINT CORRIDOR CUBIC DEGREE DEMOLITION / DEMOLISH	G.F.R.G. G.E. G.B. GYP. GWB	GLASS FIBER REINF. GYPSUM GLOBAL ENTRY GRAB BAR GYPSUM GYPSUM BOARD HARDWARE	PLAM PL. PLMBG PLYWD. PVC. PT. LBS.	PLASTIC LAMINATE PLATE PLUMBING PLYWOOD POLYVINYLCHLORIDE POINT POUNDS	V. V.I.F. VERT. VEST. V.C.T.	VENT VERIFY IN FIELD VERTICAL VESTIBULE VINYL COMPOSITION TILE
CONT. C.J. CORR. CU. DEG. DEMO. DET.	CONTINUOUS CONTROL JOINT CORRIDOR CUBIC DEGREE DEMOLITION / DEMOLISH DETAIL	G.F.R.G. G.E. G.B. GYP. GWB HDW.	GLASS FIBER REINF. GYPSUM GLOBAL ENTRY GRAB BAR GYPSUM GYPSUM BOARD HARDWARE HEAD	PLAM PL. PLMBG PLYWD. PVC. PT. LBS. PSI.	PLASTIC LAMINATE PLATE PLUMBING PLYWOOD POLYVINYLCHLORIDE POINT POUNDS POUNDS PER SQUARE INCH	V. V.I.F. VERT. VEST. V.C.T. V.W.C. VOL.	VENT VERIFY IN FIELD VERTICAL VESTIBULE VINYL COMPOSITION TILE VINYL WALL COVERING VOLUME
CONT. C.J. CORR. CU. DEG. DEMO. DET. DIA. or Ø	CONTINUOUS CONTROL JOINT CORRIDOR CUBIC DEGREE DEMOLITION / DEMOLISH DETAIL DIAMETER	G.F.R.G. G.E. G.B. GYP. GWB HDW. HD. HT.	GLASS FIBER REINF. GYPSUM GLOBAL ENTRY GRAB BAR GYPSUM GYPSUM BOARD HARDWARE HEAD HEIGHT	PLAM PL. PLMBG PLYWD. PVC. PT. LBS. PSI. P.C.	PLASTIC LAMINATE PLATE PLUMBING PLYWOOD POLYVINYLCHLORIDE POINT POUNDS POUNDS PER SQUARE INCH PRECAST CONCRETE	V. V.I.F. VERT. VEST. V.C.T. V.W.C. VOL.	VENT VERIFY IN FIELD VERTICAL VESTIBULE VINYL COMPOSITION TILE VINYL WALL COVERING VOLUME WATER CLOSET
CONT. C.J. CORR. CU. DEG. DEMO. DET.	CONTINUOUS CONTROL JOINT CORRIDOR CUBIC DEGREE DEMOLITION / DEMOLISH DETAIL	G.F.R.G. G.E. G.B. GYP. GWB HDW. HD. HT. H.C.	GLASS FIBER REINF. GYPSUM GLOBAL ENTRY GRAB BAR GYPSUM GYPSUM BOARD HARDWARE HEAD	PLAM PL. PLMBG PLYWD. PVC. PT. LBS. PSI.	PLASTIC LAMINATE PLATE PLUMBING PLYWOOD POLYVINYLCHLORIDE POINT POUNDS POUNDS PER SQUARE INCH	V. V.I.F. VERT. VEST. V.C.T. V.W.C. VOL. W.C. W.G.	VENT VERIFY IN FIELD VERTICAL VESTIBULE VINYL COMPOSITION TILE VINYL WALL COVERING VOLUME
CONT. C.J. CORR. CU. DEG. DEMO. DET. DIA. or Ø	CONTINUOUS CONTROL JOINT CORRIDOR CUBIC DEGREE DEMOLITION / DEMOLISH DETAIL DIAMETER	G.F.R.G. G.E. G.B. GYP. GWB HDW. HD. HT.	GLASS FIBER REINF. GYPSUM GLOBAL ENTRY GRAB BAR GYPSUM GYPSUM BOARD HARDWARE HEAD HEIGHT	PLAM PL. PLMBG PLYWD. PVC. PT. LBS. PSI. P.C.	PLASTIC LAMINATE PLATE PLUMBING PLYWOOD POLYVINYLCHLORIDE POINT POUNDS POUNDS PER SQUARE INCH PRECAST CONCRETE	V. V.I.F. VERT. VEST. V.C.T. V.W.C. VOL.	VENT VERIFY IN FIELD VERTICAL VESTIBULE VINYL COMPOSITION TILE VINYL WALL COVERING VOLUME WATER CLOSET
CONT. C.J. CORR. CU. DEG. DEMO. DET. DIA. or Ø DIM.	CONTINUOUS CONTROL JOINT CORRIDOR CUBIC DEGREE DEMOLITION / DEMOLISH DETAIL DIAMETER DIMENSION	G.F.R.G. G.E. G.B. GYP. GWB HDW. HD. HT. H.C.	GLASS FIBER REINF. GYPSUM GLOBAL ENTRY GRAB BAR GYPSUM GYPSUM BOARD HARDWARE HEAD HEIGHT HOLLOW CORE	PLAM PL. PLMBG PLYWD. PVC. PT. LBS. PSI. P.C. PREFIN.	PLASTIC LAMINATE PLATE PLUMBING PLYWOOD POLYVINYLCHLORIDE POINT POUNDS POUNDS PER SQUARE INCH PRECAST CONCRETE PREFINISHED	V. V.I.F. VERT. VEST. V.C.T. V.W.C. VOL. W.C. W.G.	VENT VERIFY IN FIELD VERTICAL VESTIBULE VINYL COMPOSITION TILE VINYL WALL COVERING VOLUME WATER CLOSET WALL GUARD
CONT. C.J. CORR. CU. DEG. DEMO. DET. DIA. or Ø DIM. DIST.	CONTINUOUS CONTROL JOINT CORRIDOR CUBIC DEGREE DEMOLITION / DEMOLISH DETAIL DIAMETER DIMENSION DISTANCE	G.F.R.G. G.E. G.B. GYP. GWB HDW. HD. HT. H.C. H.M.	GLASS FIBER REINF. GYPSUM GLOBAL ENTRY GRAB BAR GYPSUM GYPSUM BOARD HARDWARE HEAD HEIGHT HOLLOW CORE HOLOW METAL	PLAM PL. PLMBG PLYWD. PVC. PT. LBS. PSI. P.C. PREFIN. PREMANUF.	PLASTIC LAMINATE PLATE PLUMBING PLYWOOD POLYVINYLCHLORIDE POINT POUNDS POUNDS PER SQUARE INCH PRECAST CONCRETE PREFINISHED PREMANUFACTERED	V. V.I.F. VERT. VEST. V.C.T. V.W.C. VOL. W.C. W.G. W.H.	VENT VERIFY IN FIELD VERTICAL VESTIBULE VINYL COMPOSITION TILE VINYL WALL COVERING VOLUME WATER CLOSET WALL GUARD WATER HEATER
CONT. C.J. CORR. CU. DEG. DEMO. DET. DIA. or Ø DIM. DIST. DIV.	CONTINUOUS CONTROL JOINT CORRIDOR CUBIC DEGREE DEMOLITION / DEMOLISH DETAIL DIAMETER DIMENSION DISTANCE DIVIDER	G.F.R.G. G.E. G.B. GYP. GWB HDW. HD. HT. H.C. H.M.	GLASS FIBER REINF. GYPSUM GLOBAL ENTRY GRAB BAR GYPSUM GYPSUM BOARD HARDWARE HEAD HEIGHT HOLLOW CORE HOLOW METAL	PLAM PL. PLMBG PLYWD. PVC. PT. LBS. PSI. P.C. PREFIN. PREMANUF. P.T.	PLASTIC LAMINATE PLATE PLUMBING PLYWOOD POLYVINYLCHLORIDE POINT POUNDS POUNDS PER SQUARE INCH PRECAST CONCRETE PREFINISHED PREMANUFACTERED PRESSURE TREATED	V. V.I.F. VERT. VEST. V.C.T. V.W.C. VOL. W.C. W.G. W.H. WP.	VENT VERIFY IN FIELD VERTICAL VESTIBULE VINYL COMPOSITION TILE VINYL WALL COVERING VOLUME WATER CLOSET WALL GUARD WATER HEATER WATERPROOF
CONT. C.J. CORR. CU. DEG. DEMO. DET. DIA. or Ø DIM. DIST. DIV. DR.	CONTINUOUS CONTROL JOINT CORRIDOR CUBIC DEGREE DEMOLITION / DEMOLISH DETAIL DIAMETER DIMENSION DISTANCE DIVIDER DOOR	G.F.R.G. G.E. G.B. GYP. GWB HDW. HD. HT. H.C. H.M. HORIZ.	GLASS FIBER REINF. GYPSUM GLOBAL ENTRY GRAB BAR GYPSUM GYPSUM BOARD HARDWARE HEAD HEIGHT HOLLOW CORE HOLOW METAL HORIZONTAL	PLAM PL. PLMBG PLYWD. PVC. PT. LBS. PSI. P.C. PREFIN. PREMANUF. P.T. P.R.D.	PLASTIC LAMINATE PLATE PLUMBING PLYWOOD POLYVINYLCHLORIDE POINT POUNDS POUNDS PER SQUARE INCH PRECAST CONCRETE PREFINISHED PREMANUFACTERED PRESSURE TREATED PRIMARY ROOF DRAIN	V. V.I.F. VERT. VEST. V.C.T. V.W.C. VOL. W.C. W.G. W.H. WP. W.R.	VENT VERIFY IN FIELD VERTICAL VESTIBULE VINYL COMPOSITION TILE VINYL WALL COVERING VOLUME WATER CLOSET WALL GUARD WATER HEATER WATERPROOF WATER RESISTANT
CONT. C.J. CORR. CU. DEG. DEMO. DET. DIA. or Ø DIM. DIST. DIV. DR. DBL.	CONTINUOUS CONTROL JOINT CORRIDOR CUBIC DEGREE DEMOLITION / DEMOLISH DETAIL DIAMETER DIMENSION DISTANCE DIVIDER DOOR DOUBLE	G.F.R.G. G.E. G.B. GYP. GWB HDW. HD. HT. H.C. H.M. HORIZ.	GLASS FIBER REINF. GYPSUM GLOBAL ENTRY GRAB BAR GYPSUM GYPSUM BOARD HARDWARE HEAD HEIGHT HOLLOW CORE HOLOW METAL HORIZONTAL	PLAM PL. PLMBG PLYWD. PVC. PT. LBS. PSI. P.C. PREFIN. PREMANUF. P.T. P.R.D.	PLASTIC LAMINATE PLATE PLUMBING PLYWOOD POLYVINYLCHLORIDE POINT POUNDS POUNDS PER SQUARE INCH PRECAST CONCRETE PREFINISHED PREMANUFACTERED PRESSURE TREATED PRIMARY ROOF DRAIN	V. V.I.F. VERT. VEST. V.C.T. V.W.C. VOL. W.C. W.G. W.H. WP. W.R. WT.	VENT VERIFY IN FIELD VERTICAL VESTIBULE VINYL COMPOSITION TILE VINYL WALL COVERING VOLUME WATER CLOSET WALL GUARD WATER HEATER WATERPROOF WATER RESISTANT WEIGHT
CONT. C.J. CORR. CU. DEG. DEMO. DET. DIA. or Ø DIM. DIST. DIV. DR. DBL. DN.	CONTROL JOINT CORRIDOR CUBIC DEGREE DEMOLITION / DEMOLISH DETAIL DIAMETER DIMENSION DISTANCE DIVIDER DOOR DOUBLE DOWN	G.F.R.G. G.E. G.B. GYP. GWB HDW. HD. HT. H.C. H.M. HORIZ.	GLASS FIBER REINF. GYPSUM GLOBAL ENTRY GRAB BAR GYPSUM GYPSUM BOARD HARDWARE HEAD HEIGHT HOLLOW CORE HOLOW METAL HORIZONTAL INCHES INSIDE DIAMETER	PLAM PL. PLMBG PLYWD. PVC. PT. LBS. PSI. P.C. PREFIN. PREMANUF. P.T. P.R.D. PRPTY.	PLASTIC LAMINATE PLATE PLUMBING PLYWOOD POLYVINYLCHLORIDE POINT POUNDS POUNDS PER SQUARE INCH PRECAST CONCRETE PREFINISHED PREMANUFACTERED PRESSURE TREATED PRIMARY ROOF DRAIN PROPERTY	V. V.I.F. VERT. VEST. V.C.T. V.W.C. VOL. W.C. W.G. W.H. WP. W.R. WT. W.W.F.	VENT VERIFY IN FIELD VERTICAL VESTIBULE VINYL COMPOSITION TILE VINYL WALL COVERING VOLUME WATER CLOSET WALL GUARD WATER HEATER WATERPROOF WATER RESISTANT WEIGHT WELDED WIRE FABRIC
CONT. C.J. CORR. CU. DEG. DEMO. DET. DIA. or Ø DIM. DIST. DIV. DR. DBL. DN. DS. D.	CONTROL JOINT CORRIDOR CUBIC DEGREE DEMOLITION / DEMOLISH DETAIL DIAMETER DIMENSION DISTANCE DIVIDER DOOR DOUBLE DOWN DOWNSPOUT DRAIN	G.F.R.G. G.E. G.B. GYP. GWB HDW. HD. HT. H.C. H.M. HORIZ. IN. I.D. INSUL. I.C.F.	GLASS FIBER REINF. GYPSUM GLOBAL ENTRY GRAB BAR GYPSUM GYPSUM BOARD HARDWARE HEAD HEIGHT HOLLOW CORE HOLOW METAL HORIZONTAL INCHES INSIDE DIAMETER INSULATION INSULATING CONRETE FORM	PLAM PL. PLMBG PLYWD. PVC. PT. LBS. PSI. P.C. PREFIN. PREMANUF. P.T. QTY.	PLASTIC LAMINATE PLATE PLUMBING PLYWOOD POLYVINYLCHLORIDE POINT POUNDS POUNDS PER SQUARE INCH PRECAST CONCRETE PREFINISHED PREMANUFACTERED PRESSURE TREATED PRIMARY ROOF DRAIN PROPERTY	V. VI.F. VERT. VEST. V.C.T. V.W.C. VOL. W.C. W.G. W.H. WP. W.R. WT. W.W.F. WDW.	VENT VERIFY IN FIELD VERTICAL VESTIBULE VINYL COMPOSITION TILE VINYL WALL COVERING VOLUME WATER CLOSET WALL GUARD WATER HEATER WATERPROOF WATER RESISTANT WEIGHT WELDED WIRE FABRIC WINDOW WITH
CONT. C.J. CORR. CU. DEG. DEMO. DET. DIA. or Ø DIM. DIST. DIV. DR. DBL. DN. DS. D. DWG.	CONTROL JOINT CORRIDOR CUBIC DEGREE DEMOLITION / DEMOLISH DETAIL DIAMETER DIMENSION DISTANCE DIVIDER DOOR DOUBLE DOWN DOWNSPOUT DRAIN DRAWING	G.F.R.G. G.E. G.B. GYP. GWB HDW. HD. HT. H.C. H.M. HORIZ.	GLASS FIBER REINF. GYPSUM GLOBAL ENTRY GRAB BAR GYPSUM GYPSUM BOARD HARDWARE HEAD HEIGHT HOLLOW CORE HOLOW METAL HORIZONTAL INCHES INSIDE DIAMETER INSULATION	PLAM PL. PLMBG PLYWD. PVC. PT. LBS. PSI. P.C. PREFIN. PREMANUF. P.T. P.R.D. PRPTY.	PLASTIC LAMINATE PLATE PLUMBING PLYWOOD POLYVINYLCHLORIDE POINT POUNDS POUNDS PER SQUARE INCH PRECAST CONCRETE PREFINISHED PREMANUFACTERED PRESSURE TREATED PRIMARY ROOF DRAIN PROPERTY QUANTITY QUARRY TILE	V. V.I.F. VERT. VEST. V.C.T. V.W.C. VOL. W.C. W.G. W.H. WP. W.R. WT. W.W.F. WDW. W/O	VENT VERIFY IN FIELD VERTICAL VESTIBULE VINYL COMPOSITION TILE VINYL WALL COVERING VOLUME WATER CLOSET WALL GUARD WATER HEATER WATERPROOF WATER RESISTANT WEIGHT WELDED WIRE FABRIC WINDOW WITH
CONT. C.J. CORR. CU. DEG. DEMO. DET. DIA. or Ø DIM. DIST. DIV. DR. DBL. DN. DS. D.	CONTROL JOINT CORRIDOR CUBIC DEGREE DEMOLITION / DEMOLISH DETAIL DIAMETER DIMENSION DISTANCE DIVIDER DOOR DOUBLE DOWN DOWNSPOUT DRAIN	G.F.R.G. G.E. G.B. GYP. GWB HDW. HD. HT. H.C. H.M. HORIZ. IN. I.D. INSUL. I.C.F.	GLASS FIBER REINF. GYPSUM GLOBAL ENTRY GRAB BAR GYPSUM GYPSUM BOARD HARDWARE HEAD HEIGHT HOLLOW CORE HOLOW METAL HORIZONTAL INCHES INSIDE DIAMETER INSULATION INSULATING CONRETE FORM	PLAM PL. PLMBG PLYWD. PVC. PT. LBS. PSI. P.C. PREFIN. PREMANUF. P.T. QTY.	PLASTIC LAMINATE PLATE PLUMBING PLYWOOD POLYVINYLCHLORIDE POINT POUNDS POUNDS PER SQUARE INCH PRECAST CONCRETE PREFINISHED PREMANUFACTERED PRESSURE TREATED PRIMARY ROOF DRAIN PROPERTY	V. VI.F. VERT. VEST. V.C.T. V.W.C. VOL. W.C. W.G. W.H. WP. W.R. WT. W.W.F. WDW.	VENT VERIFY IN FIELD VERTICAL VESTIBULE VINYL COMPOSITION TILE VINYL WALL COVERING VOLUME WATER CLOSET WALL GUARD WATER HEATER WATERPROOF WATER RESISTANT WEIGHT WELDED WIRE FABRIC WINDOW WITH

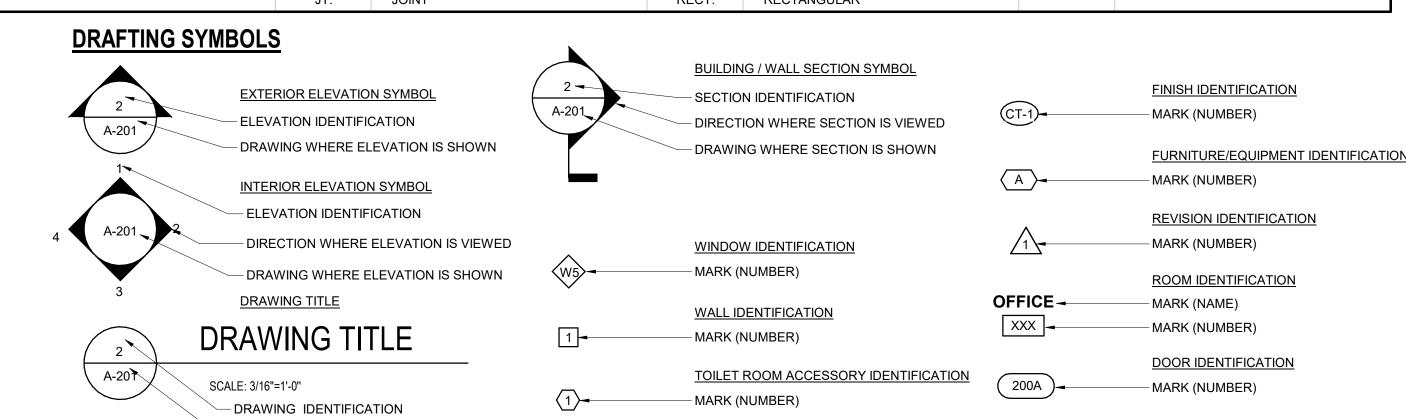

SHEET NUMBER WHERE DRAWINGS IS SHOWN



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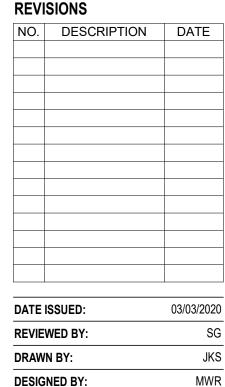
PENSACOLA, FLORIDA

PENSACOLA GENERAL AVIATION FACILITY (GAF)



PROFESSIONAL SEAL





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SHEET TITLE

GENERAL NOTES, ABBREVIATIONS, & SYMBOLS

SHEET NUMBER

A001

REFER TO LANDSCAPE

VEGETATION INFORMATION -

DRAWINGS FOR

ARCHITECTURAL SITE PLAN

TELECOMINICATION SHEETS

SCALE: 1" = 10'-0"

- BOLLARD, TYP.

ROLLING SECURITY VEHICLE GATE,

ARCHITECTURAL FENCE FABRIC

A100 /

LANDSIDE

AIRSIDE

03/03/2020 MWR

> **ARCHITECTURAL** SITE PLAN

> > SHEET NUMBER

EDGE OF EXISTING PAVEMENT


A100

BID DOCUMENTS

SCALE: 1" = 10'-0"

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CURB, TYP. ——

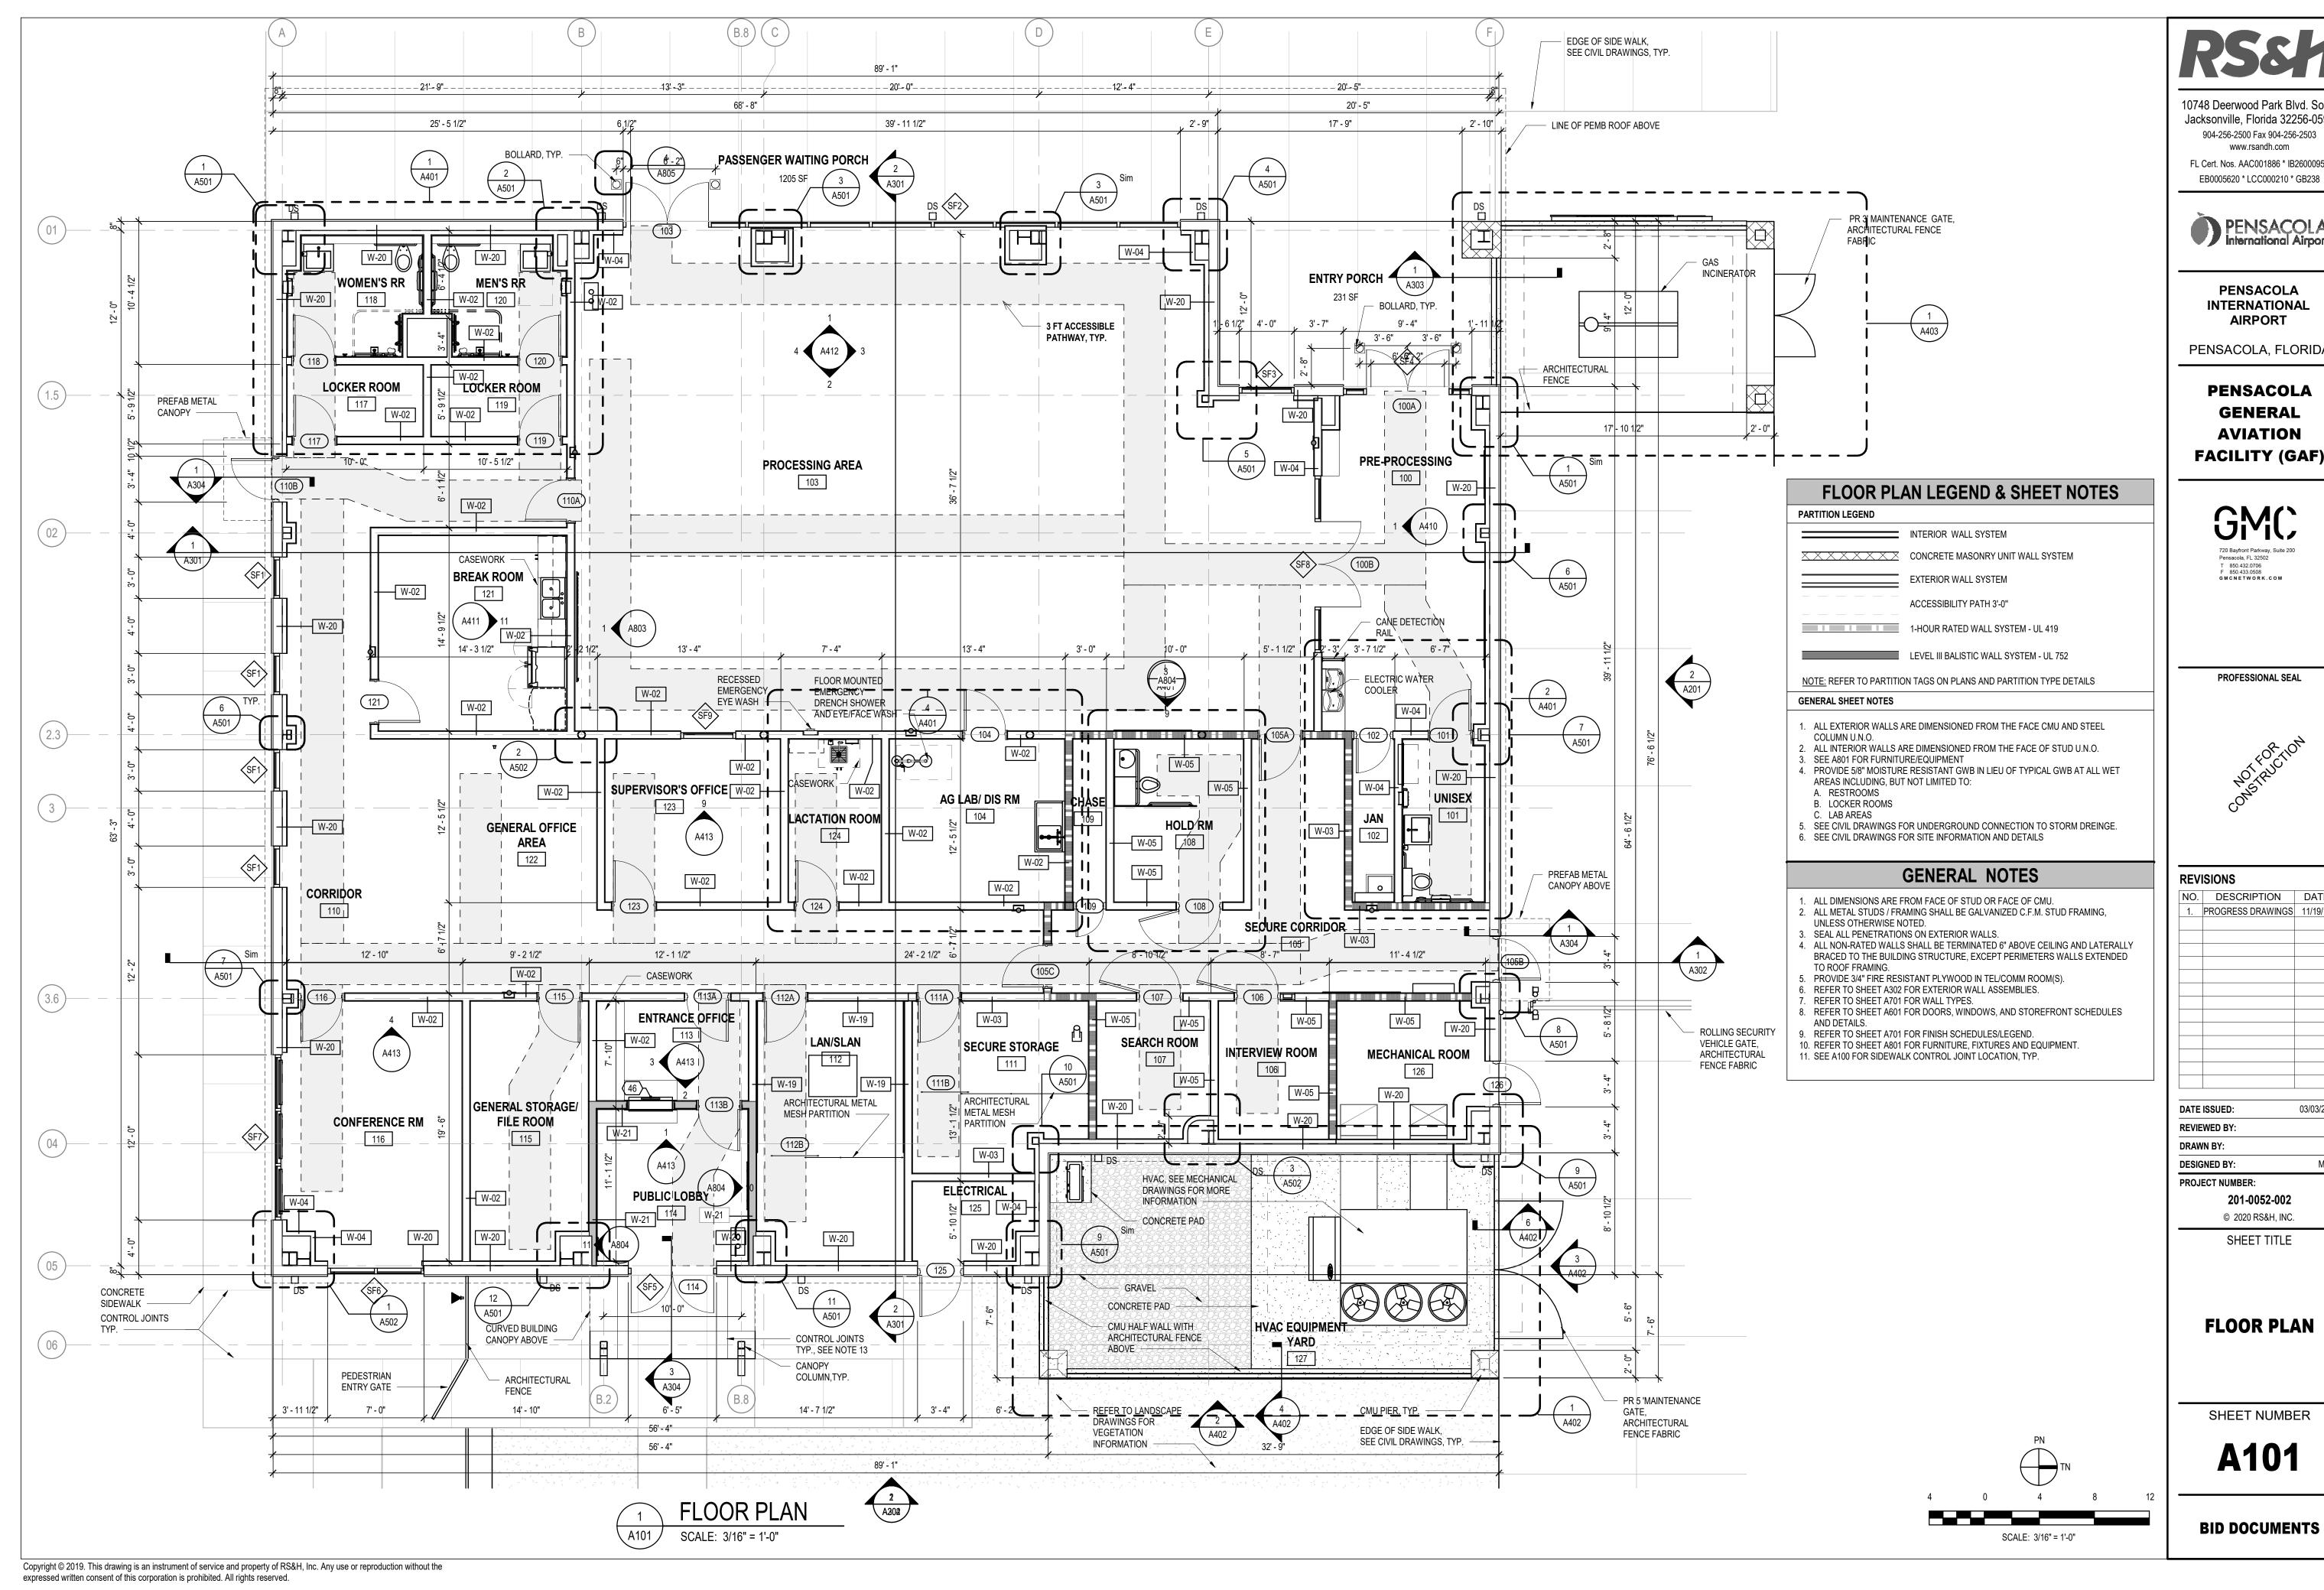

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PROGRESS DRAWINGS 11/19/19

DATE ISSUED: 03/03/2020

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MWR

SHEET TITLE

FLOOR PLAN

SHEET NUMBER

A101





FIXTURE LEGEND

1' x 4' FLUORESCENT LIGHT FIXTURE

1' x 4' EMERGENCY FLUORESCENT LIGHT FIXTURE

2' x 2' FLUORESCENT LIGHT FIXTURE

2' x 2' EMERGENCY FLUORESCENT LIGHT FIXTURE

2' x 2' FLUORESCENT LIGHT FIXTURE

4" x 4' PENDANT LIGHT FIXTURE

DOWNLIGHT RECESSED CAN LIGHT FIXTURE

DOWNLIGHT EMERGENCY RECESSED CAN LIGHT FIXTURE

WALL MOUNTED EXIT SIGN

CEILING MOUNTED EXIT SIGN

2' x 2' SUPPLY AIR DIFFUSER

2' x 2' RETURN AIR GRILLE

ACCESS PANEL

OCCUPANCY SENSOR

EXTERIOR WALL MOUNTED LIGHT FIXTURE

CEILING TYPES LEGEND

CF-02 GYPSUM BOARD OVER #9 (10 Ga) EXPENDED METAL MESH, PAINTED

CF-03 2' x 2' SUSPENDED ACOUSTICAL CEILING TILE SYSTEM

CF-07 GYPSUM BOARD, 5/8" MOISTURE RESISTANT, PAINTED

CF-15 5/8" GYPSUM BOARD OVER #9 (10 Ga) EXPENDED METAL MESH, ADHEARD ACT

CF-17* SECURE, 1H FIRE RATED ACOUSTICAL CEILING ASSEMBLY STC -55, GA NO. WP 1015

EXTERIOR METAL SOFFIT PANEL

EXPOSED TO ABOVE

GENERAL SHEET NOTES

DEVICES HAVE BEEN SHOWN FOR COORDINATION PURPOSES. SEE MECHANICAL, ELECTRICAL, PLUMBING AND FIRE PROTECTION DRAWINGS FOR ITEMS NOT SHOWN ON REFLECTED CEILING PLANS.

CONTACT THE ARCHITECT IF ANY CONFLICTS OCCUR. ALL CEILING MOUNTED DEVICES SHALL BE CENTERED IN BOTH DIRECTIONS IN ACOUSTICAL CEILING

CENTER SPRINKLER HEADS IN ACOUST. CEILING PANELS WHERE THEY OCCUR. COORDINATE THE

LOCATION OF THE SPRINKLER HEADS WITH OTHER CEILING FIXTURES AND EQUIPMENT IN ALL CEILINGS. ENSURE THAT A SYMMETRICAL AND BALANCED ARRANGEMENT IS INSTALLED. CONTRACTING OFFICER IS TO REVIEW INSTANCES OF NON-EQUAL SPACING PRIOR TO INSTALLATION.

COORDINATE ACCESS PANELS WITH MECHANICAL DRAWINGS.

SECURE FIRE RATED CEILING ON STRUCTURAL GRID REQUIRES ALL PENETRATION TO BE SECURED. 6. FOR SOUND TRANSMISSION CLASS RATING (STC) REFER TO ROOM FINISH SCHEDULE.

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SHEET TITLE

REFLECTED **CEILING PLAN**

SHEET NUMBER

A121

BID DOCUMENTS

SCALE: 3/16" = 1'-0"



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SHEET TITLE

SJ/MJ


ROOF PLAN


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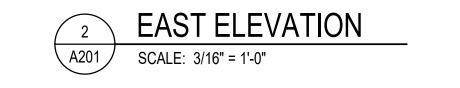
A131

BID DOCUMENTS

SCALE: 3/16" = 1'-0"



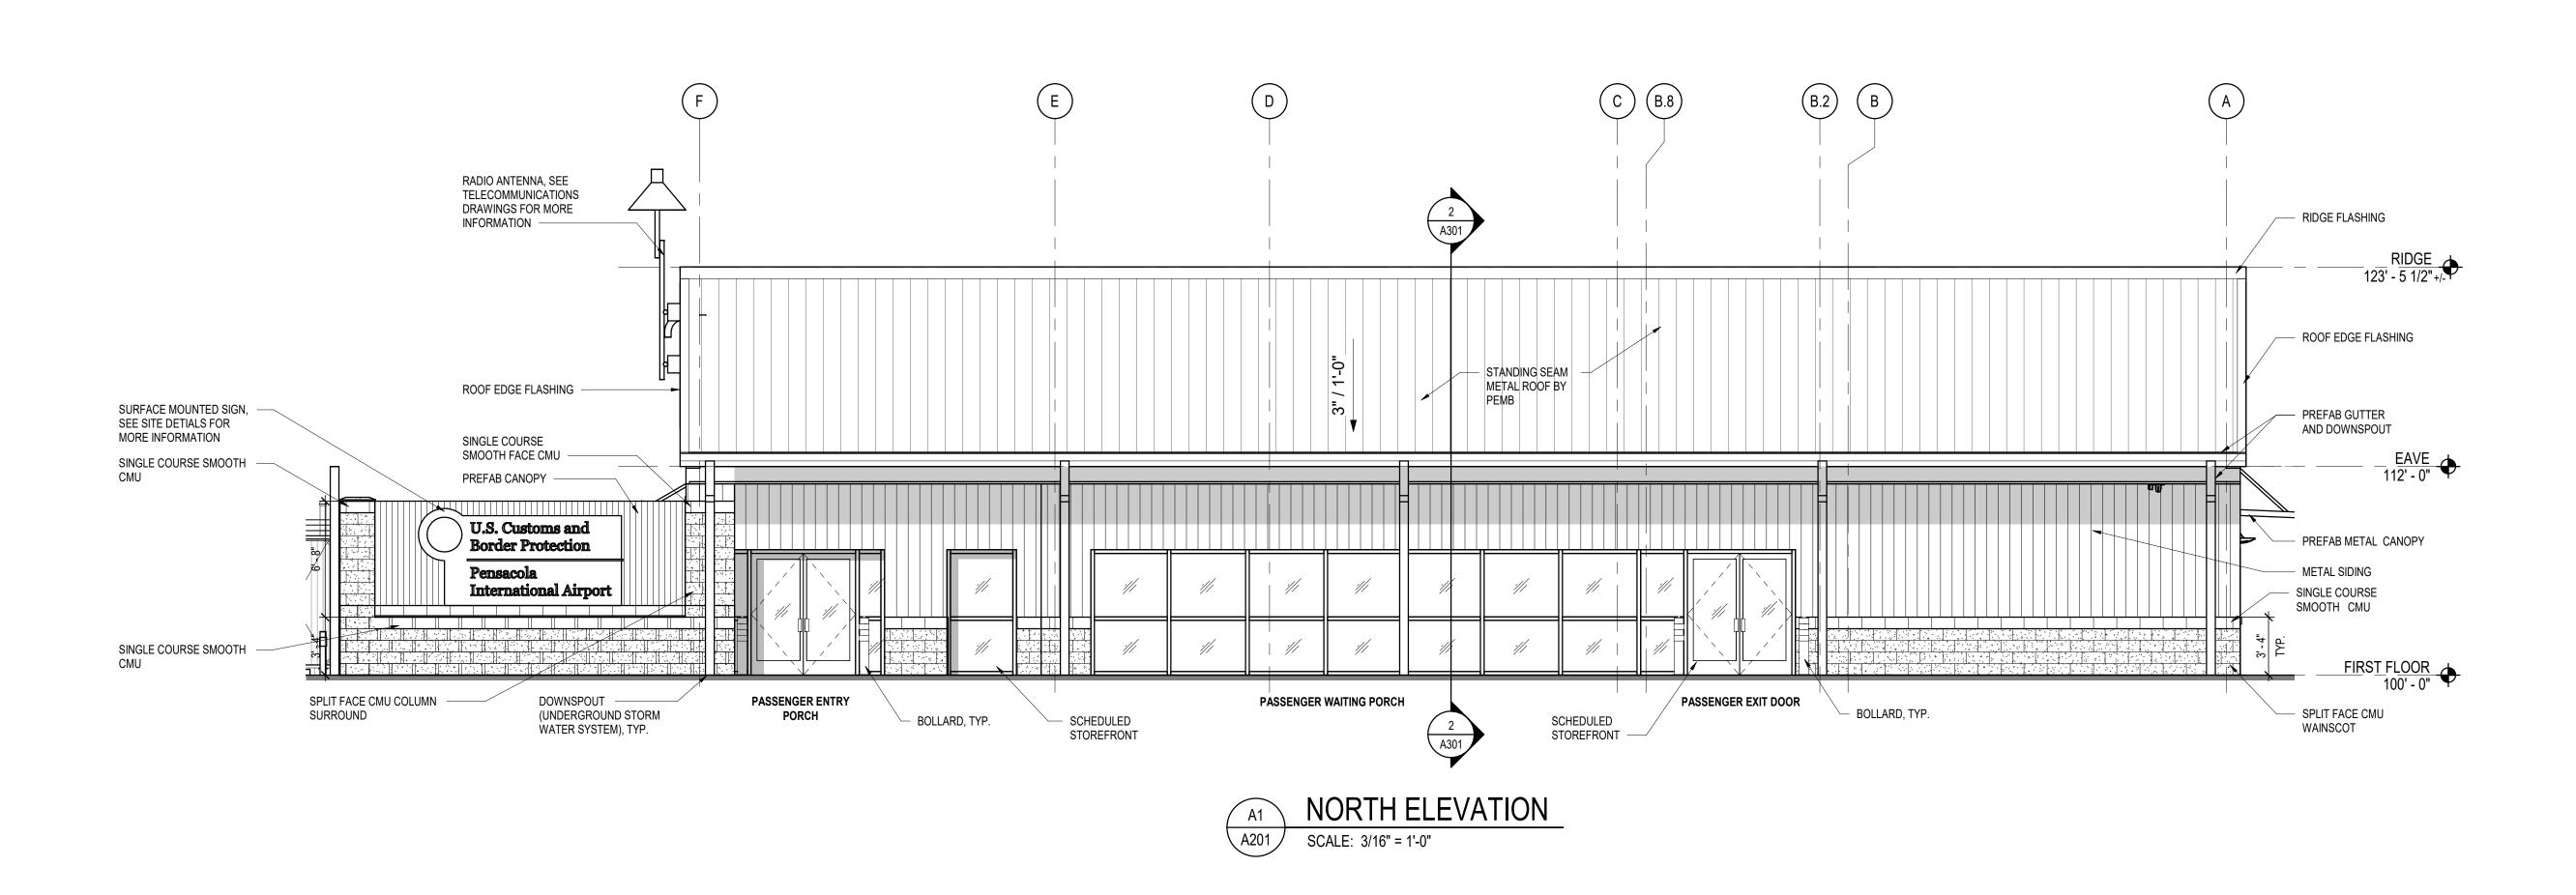

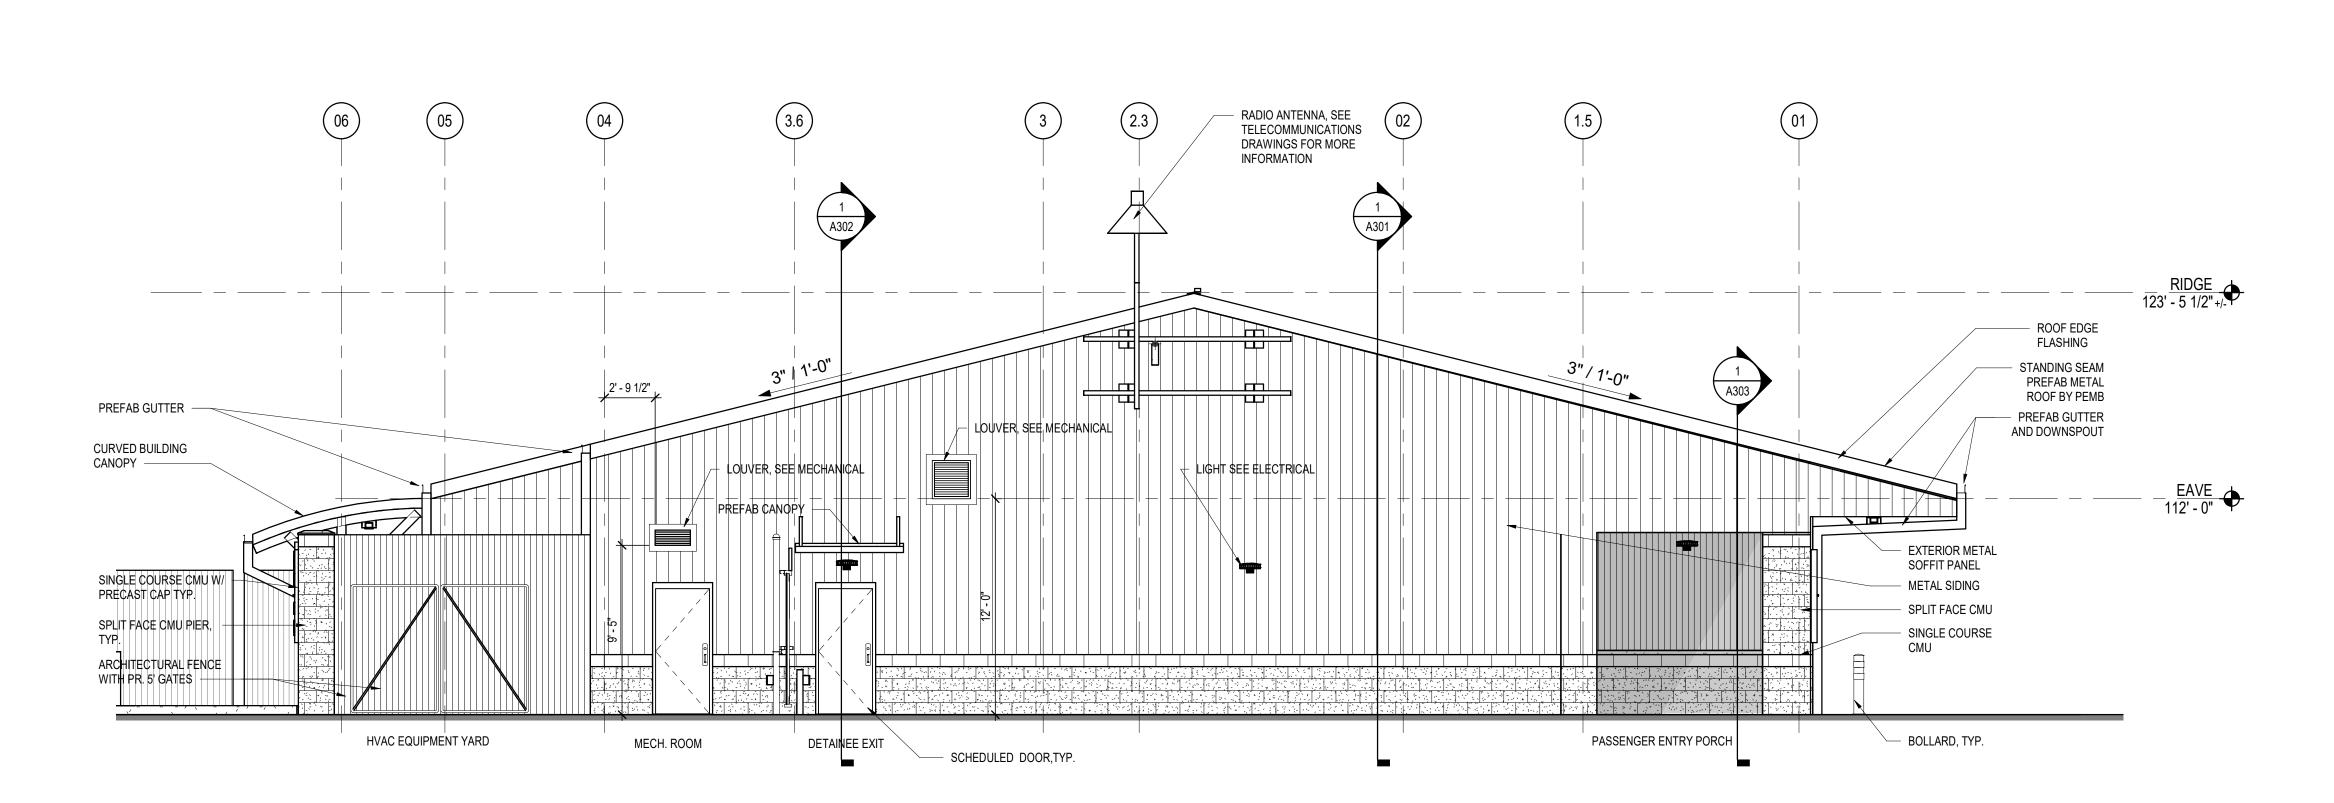



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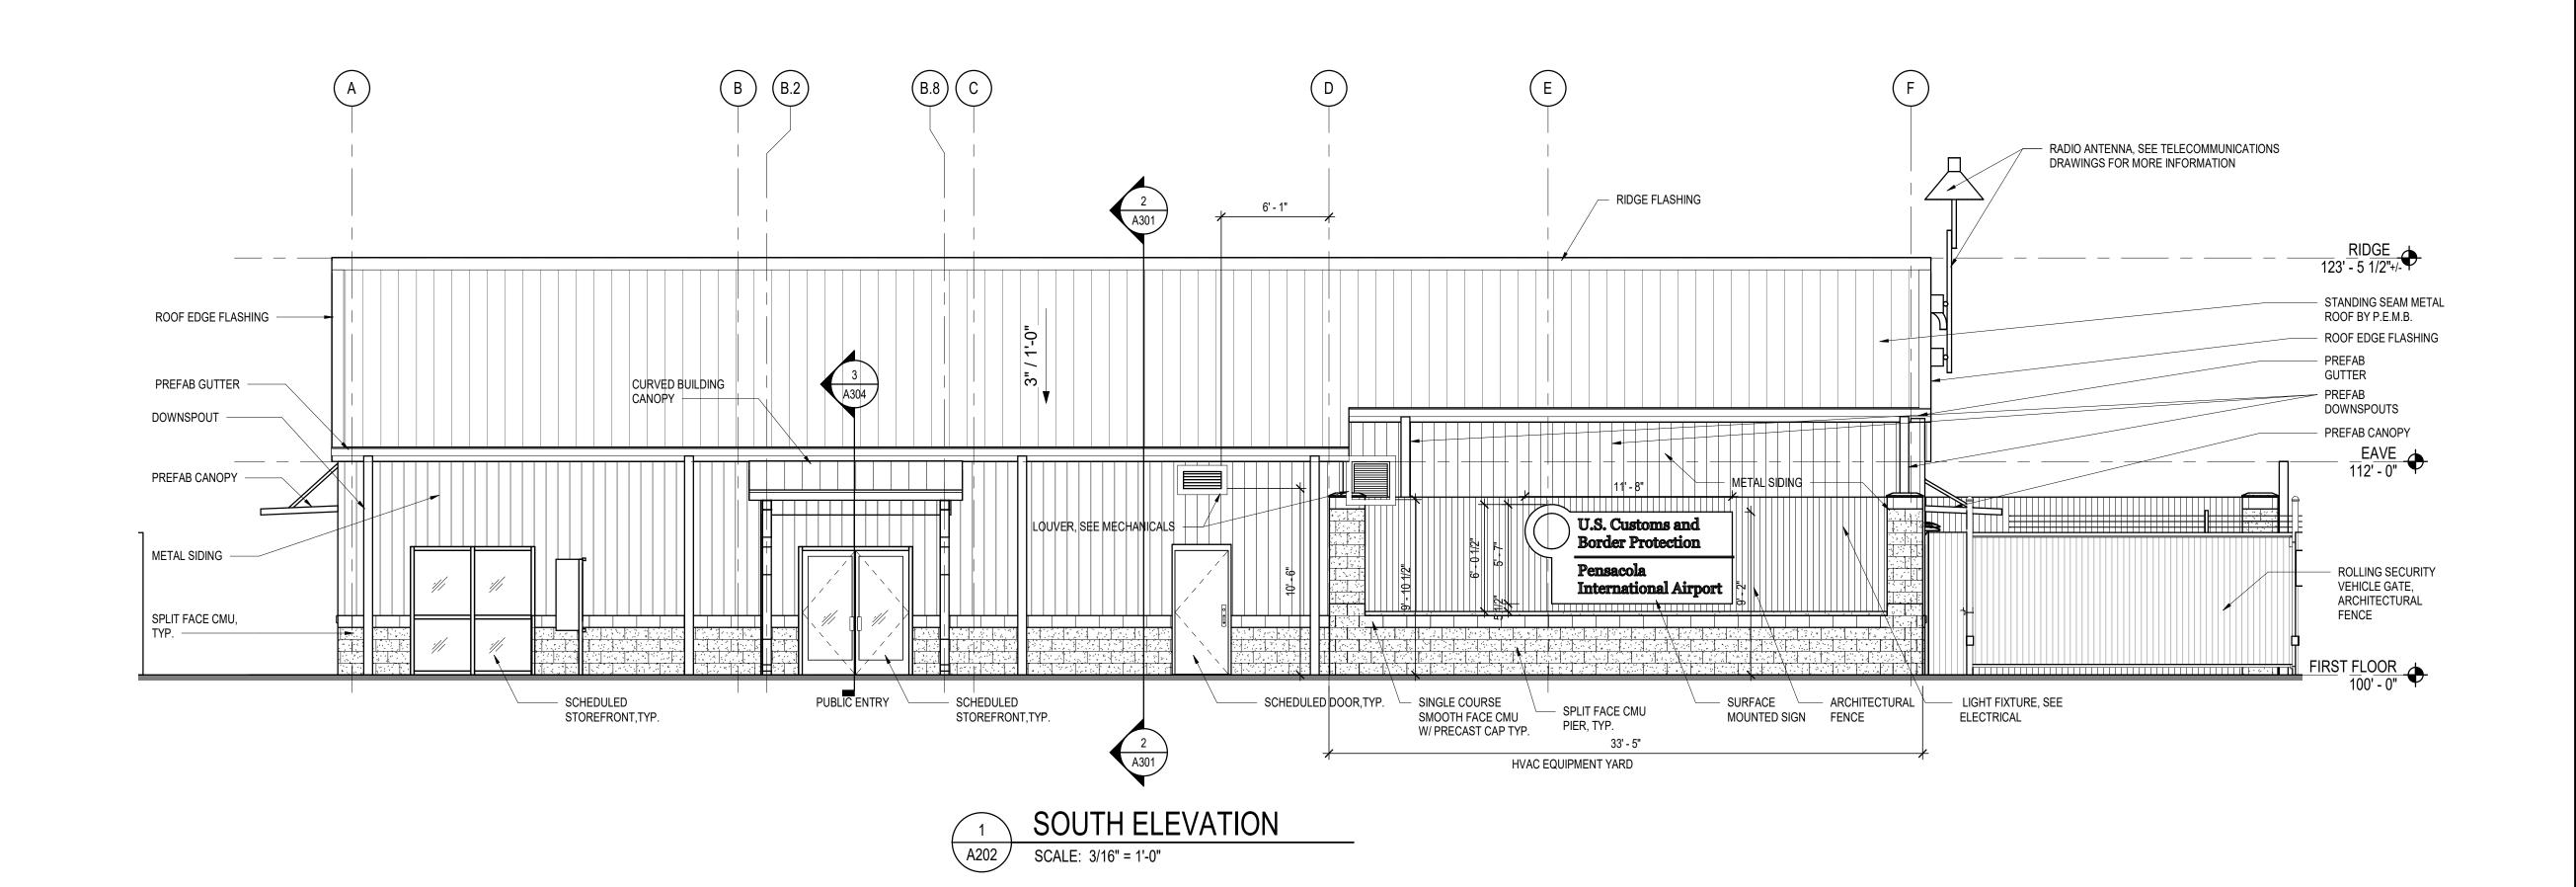
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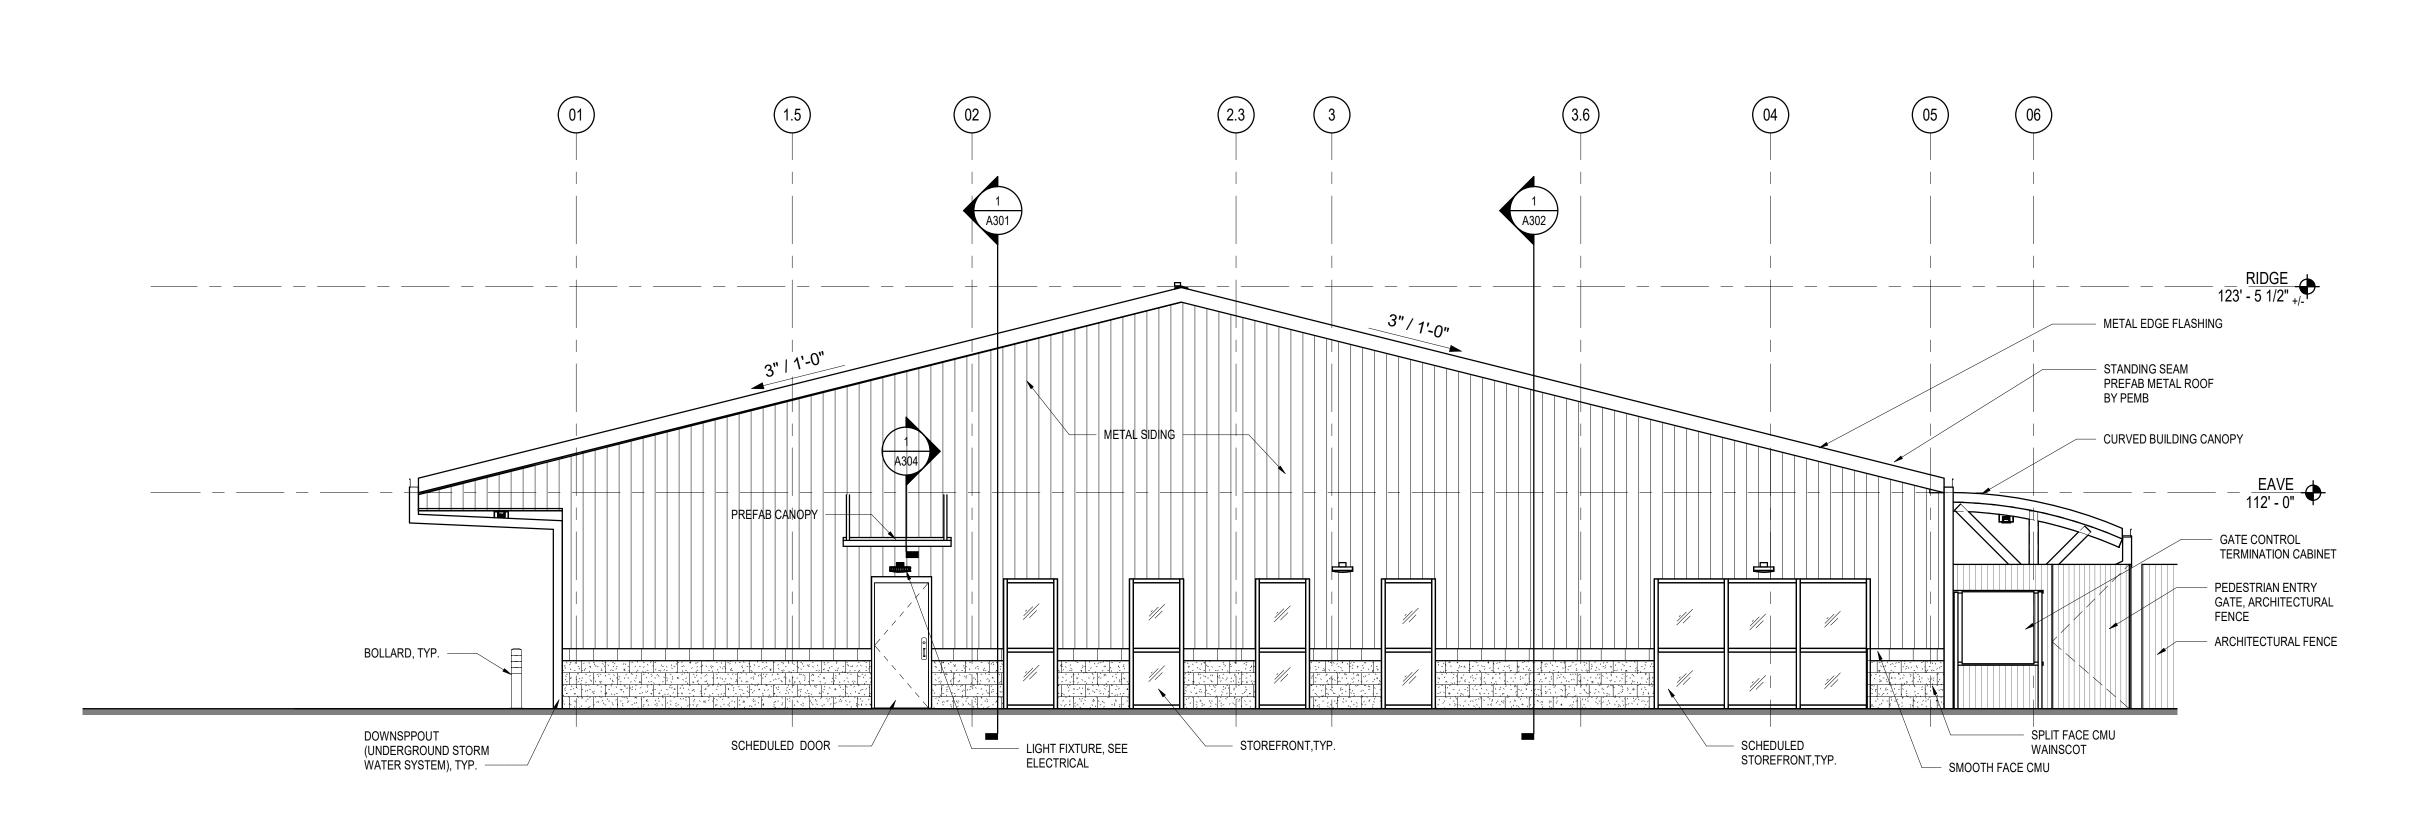
SHEET TITLE

BUILDING ELEVATIONS


SHEET NUMBER

A201







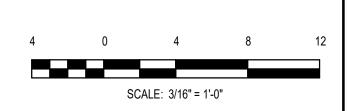

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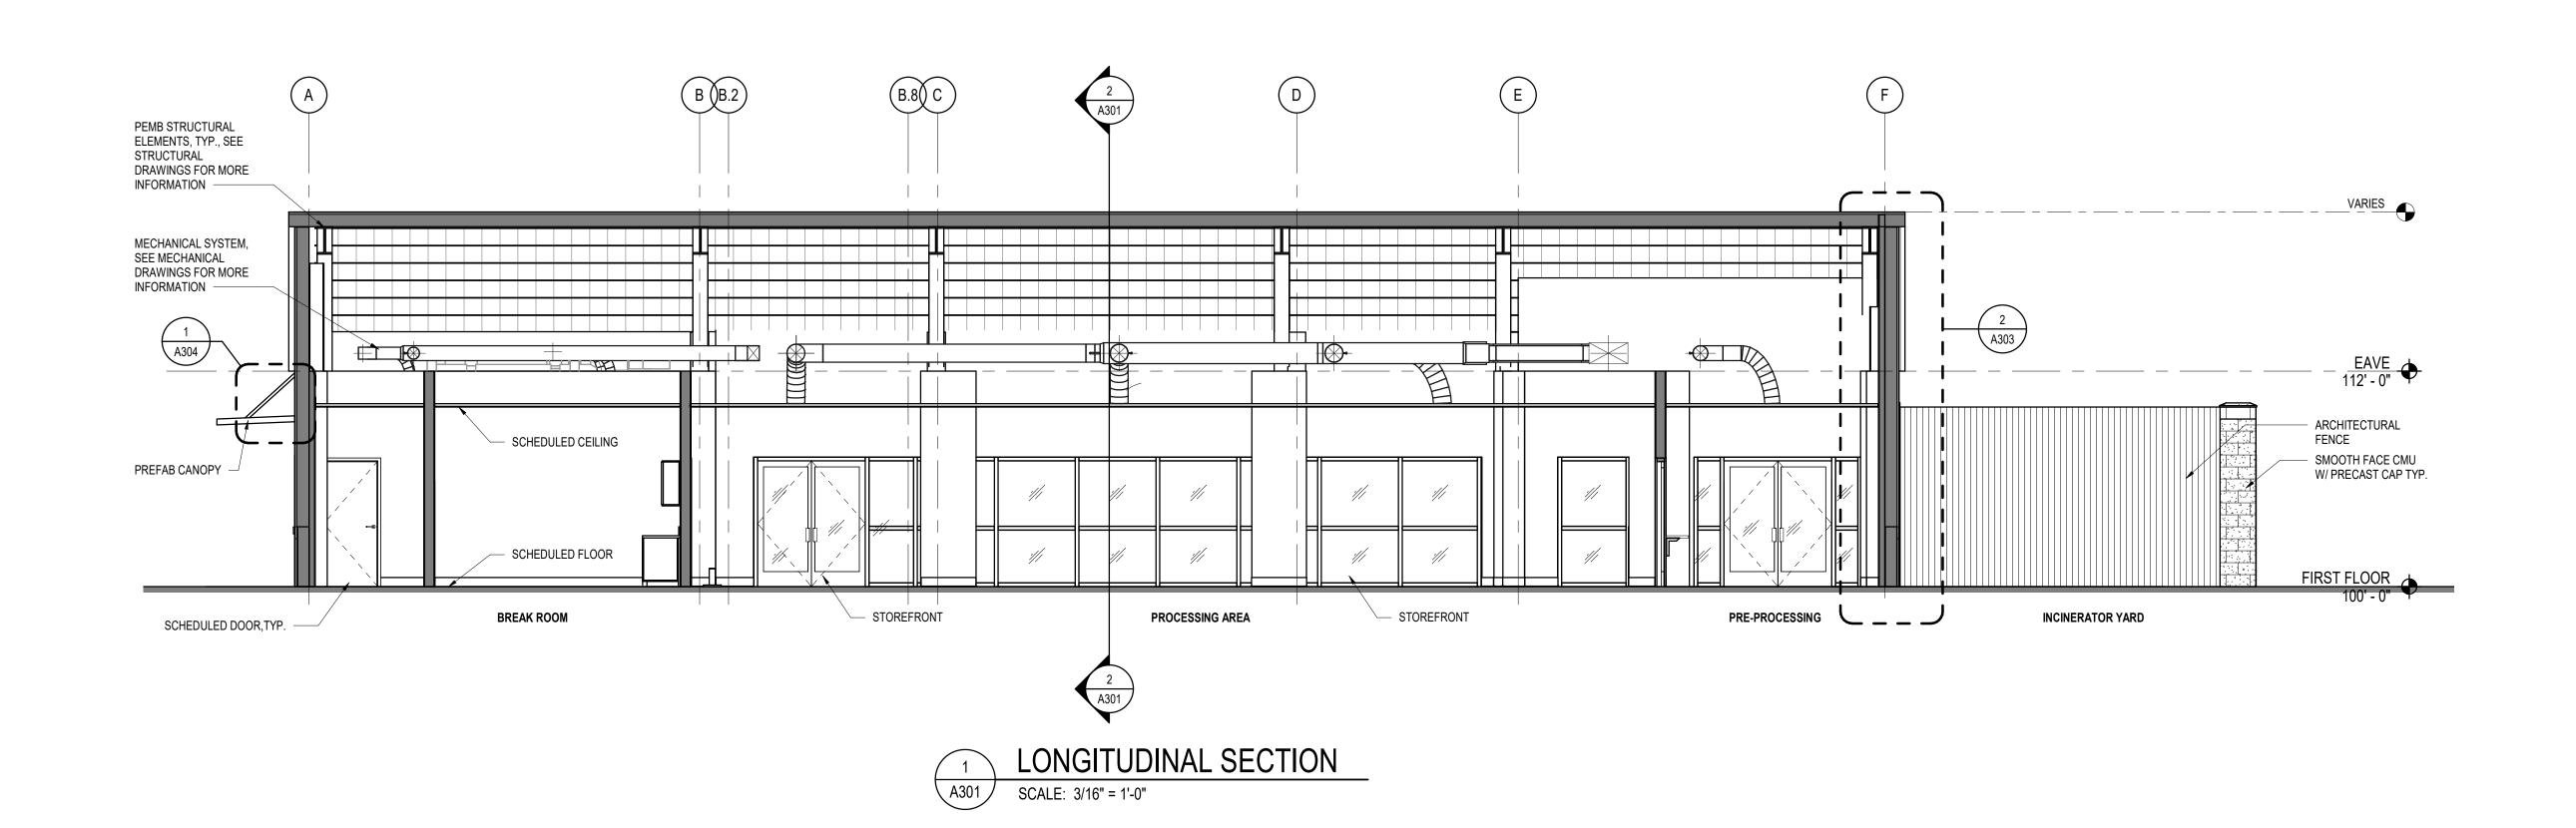
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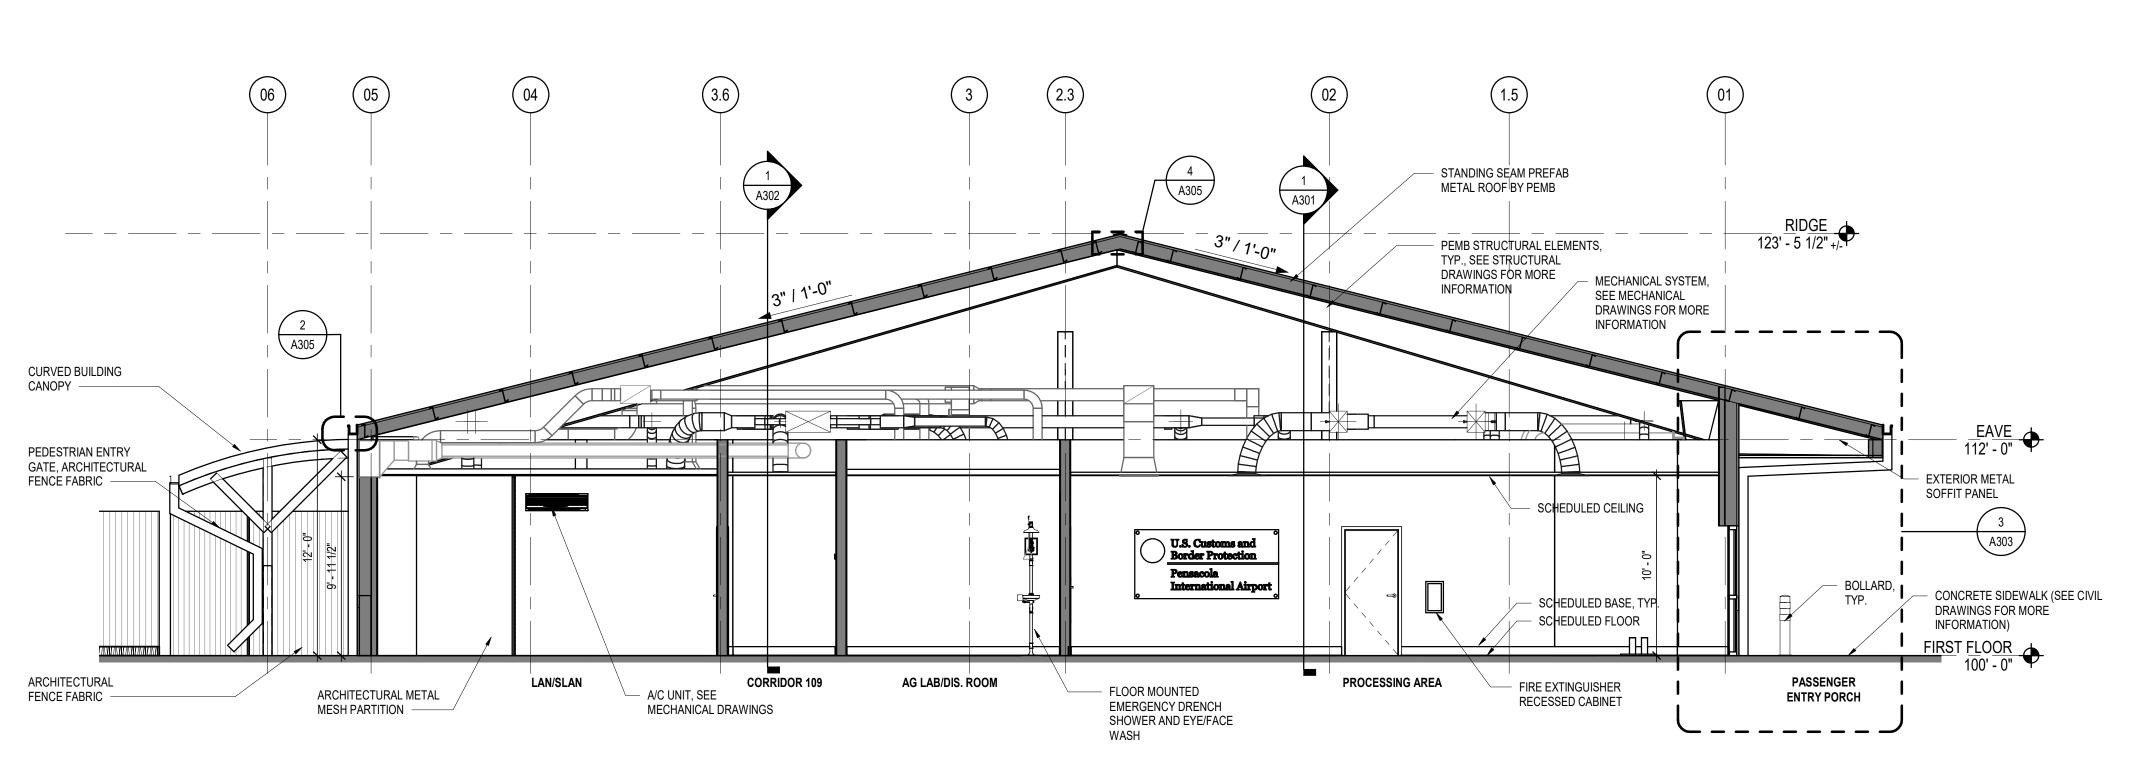
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SHEET TITLE


BUILDING ELEVATIONS


SHEET NUMBER

A202





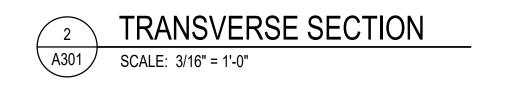

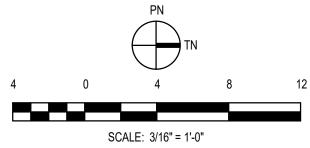



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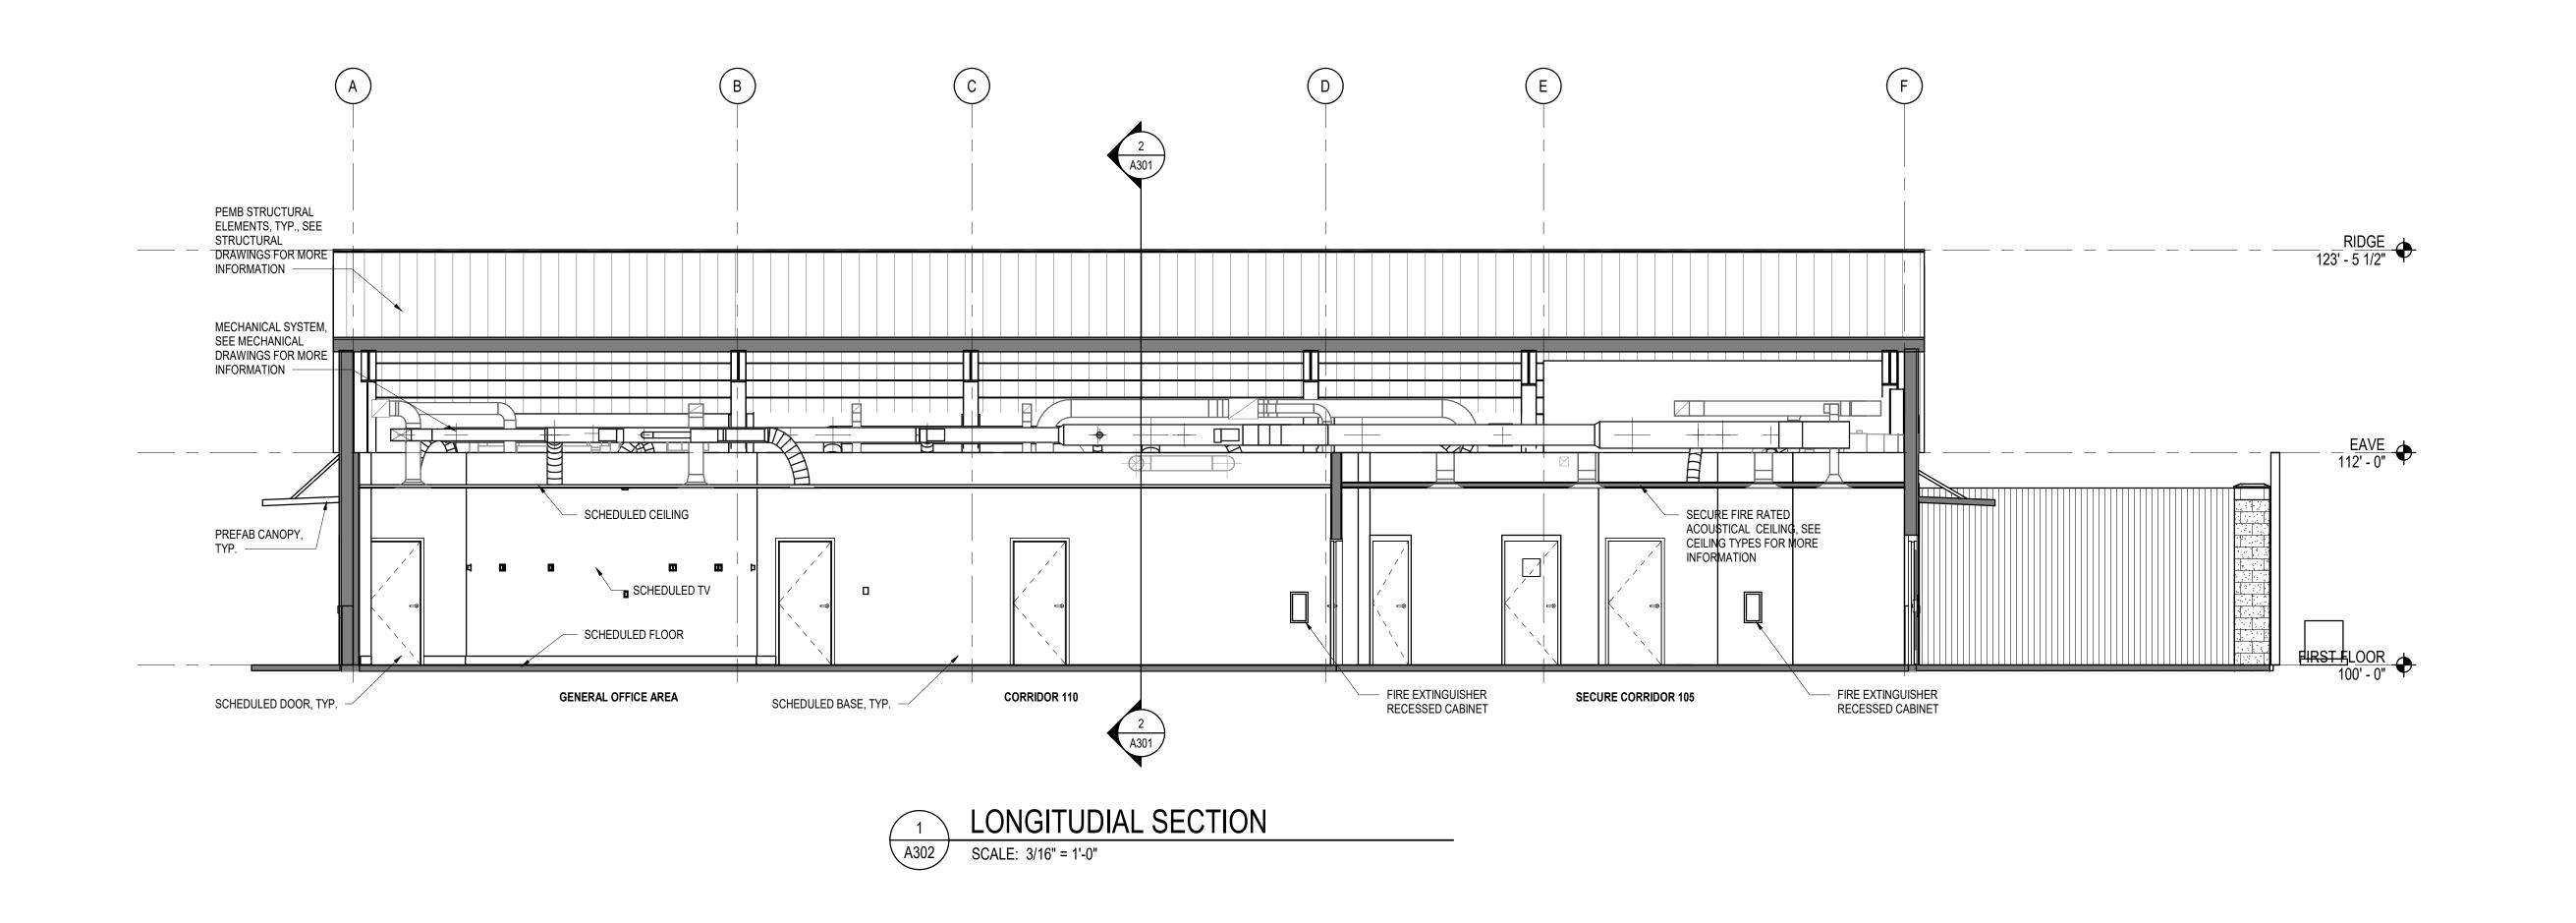
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SHEET TITLE

BUILDING SECTIONS

SHEET NUMBER

A301





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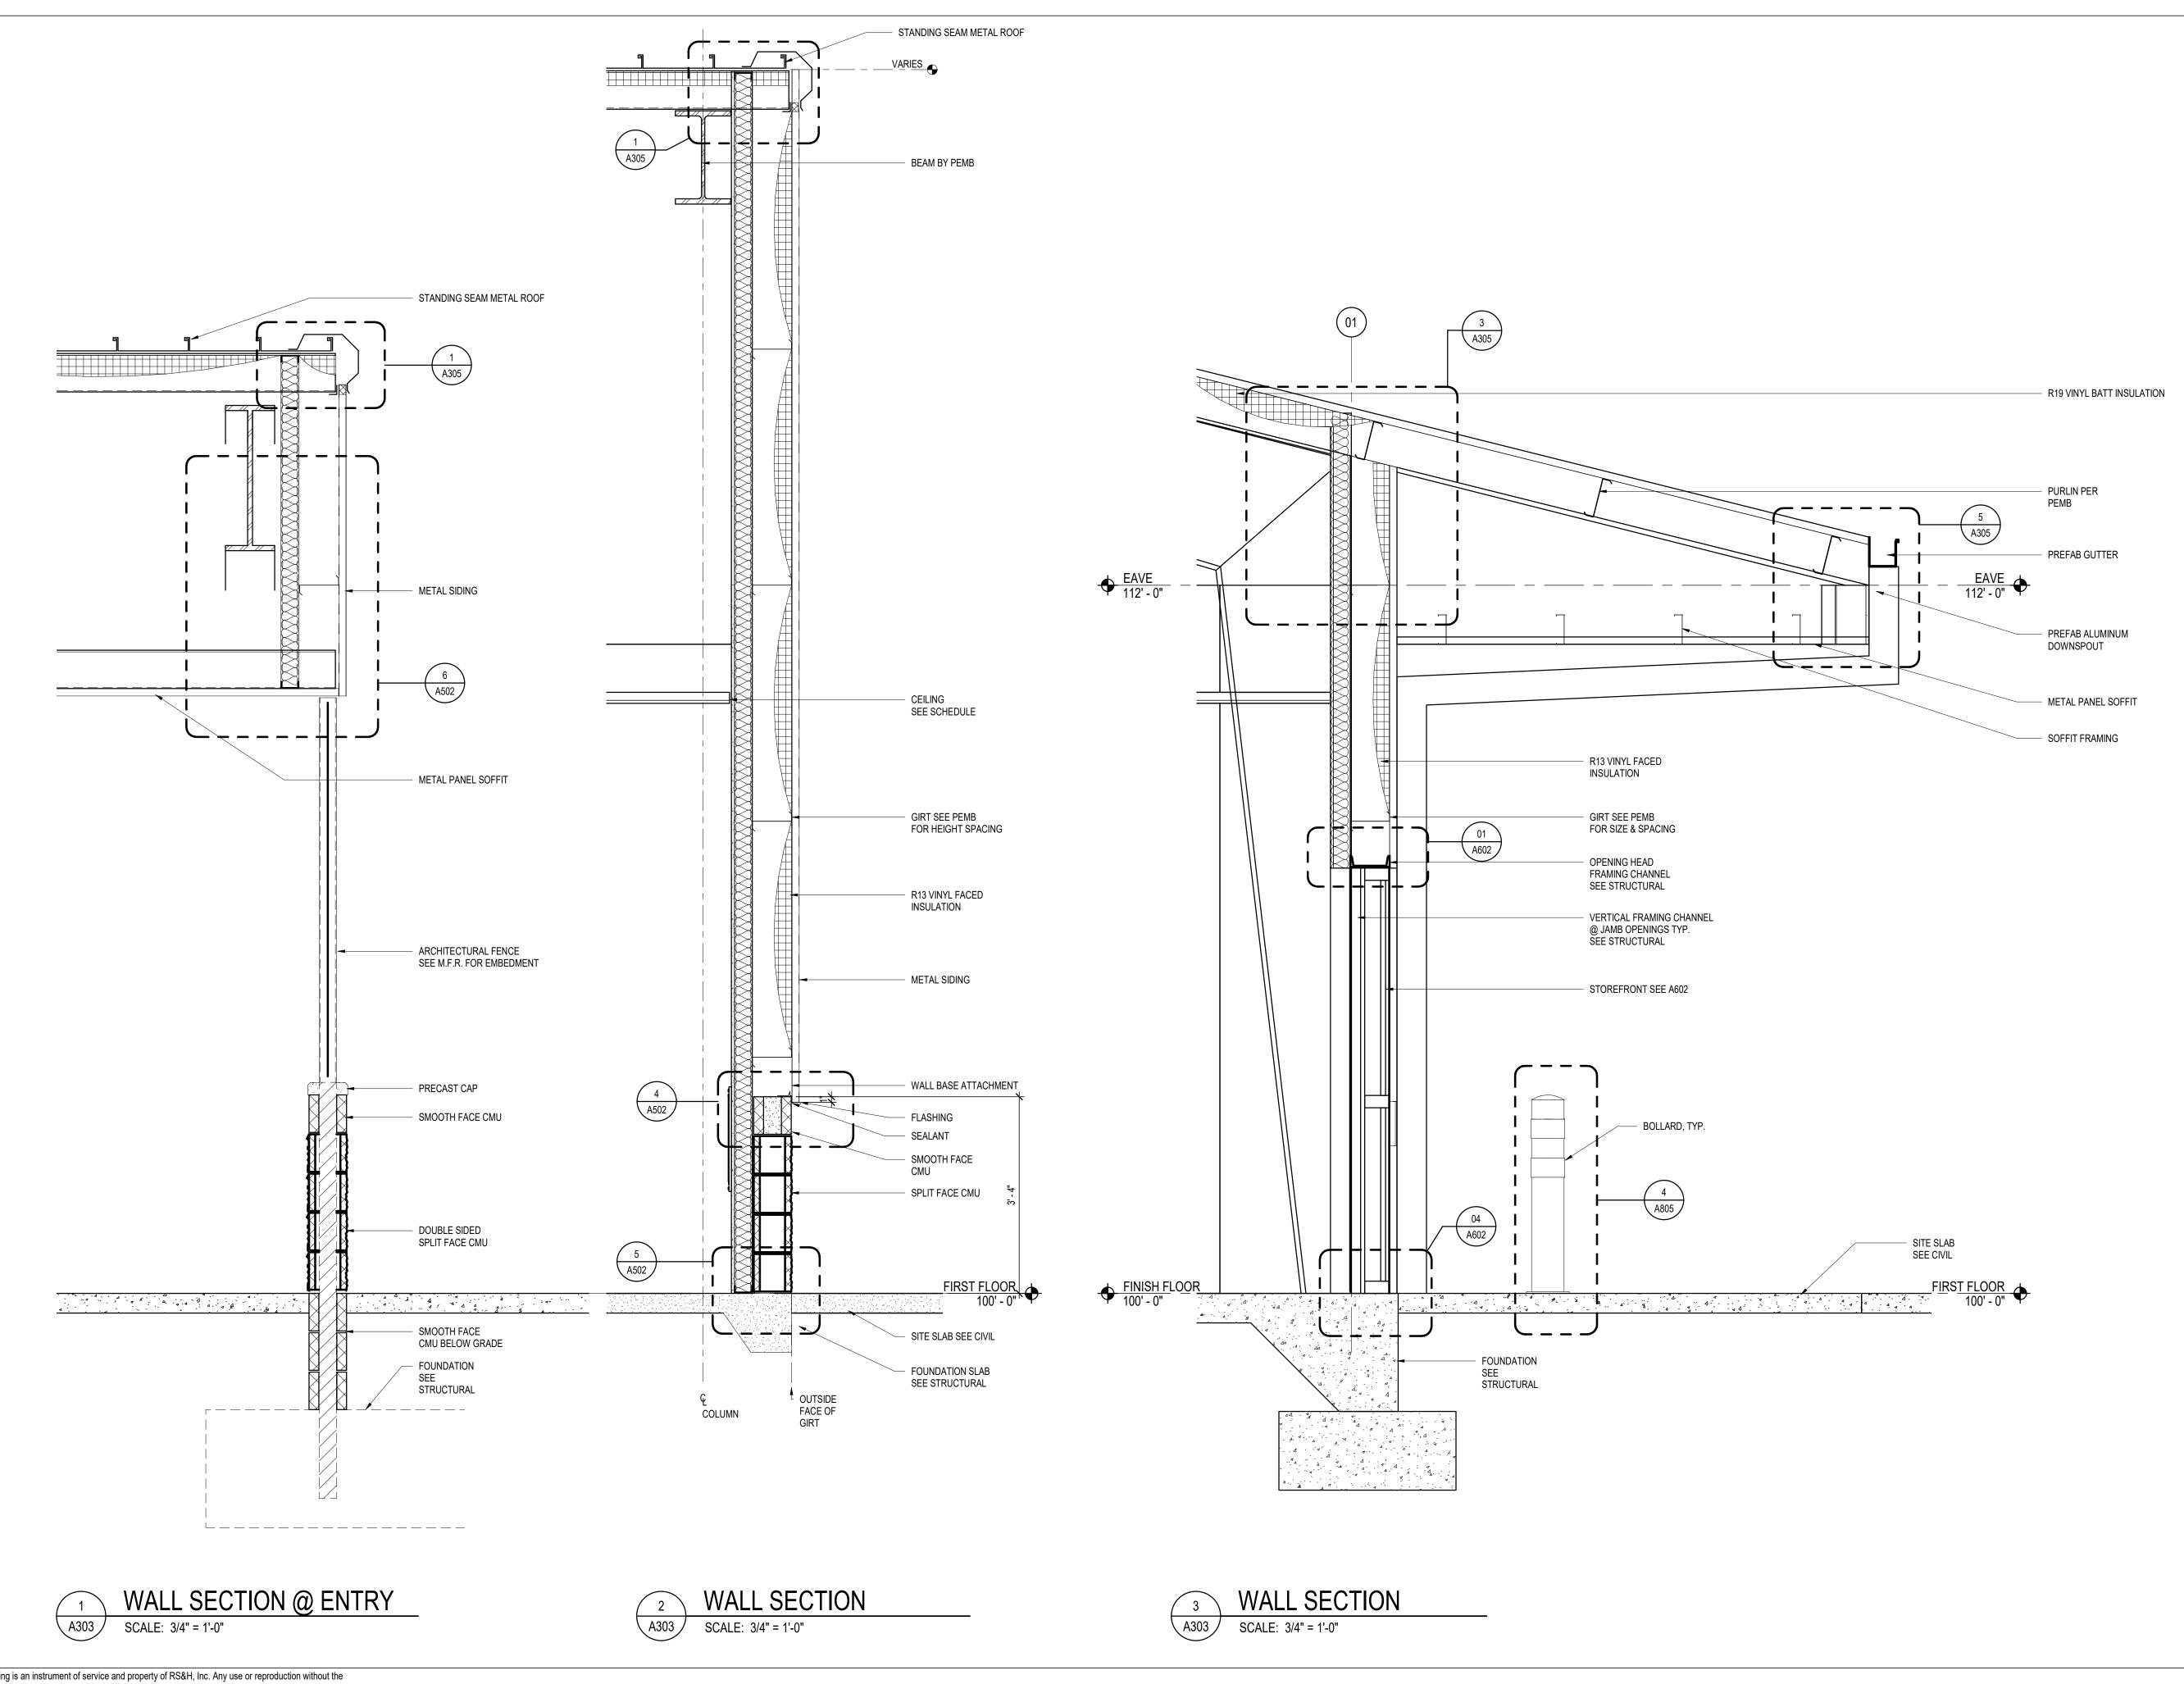
SHEET TITLE

OHEET TITLE

BUILDING SECTIONS

SHEET NUMBER

A302





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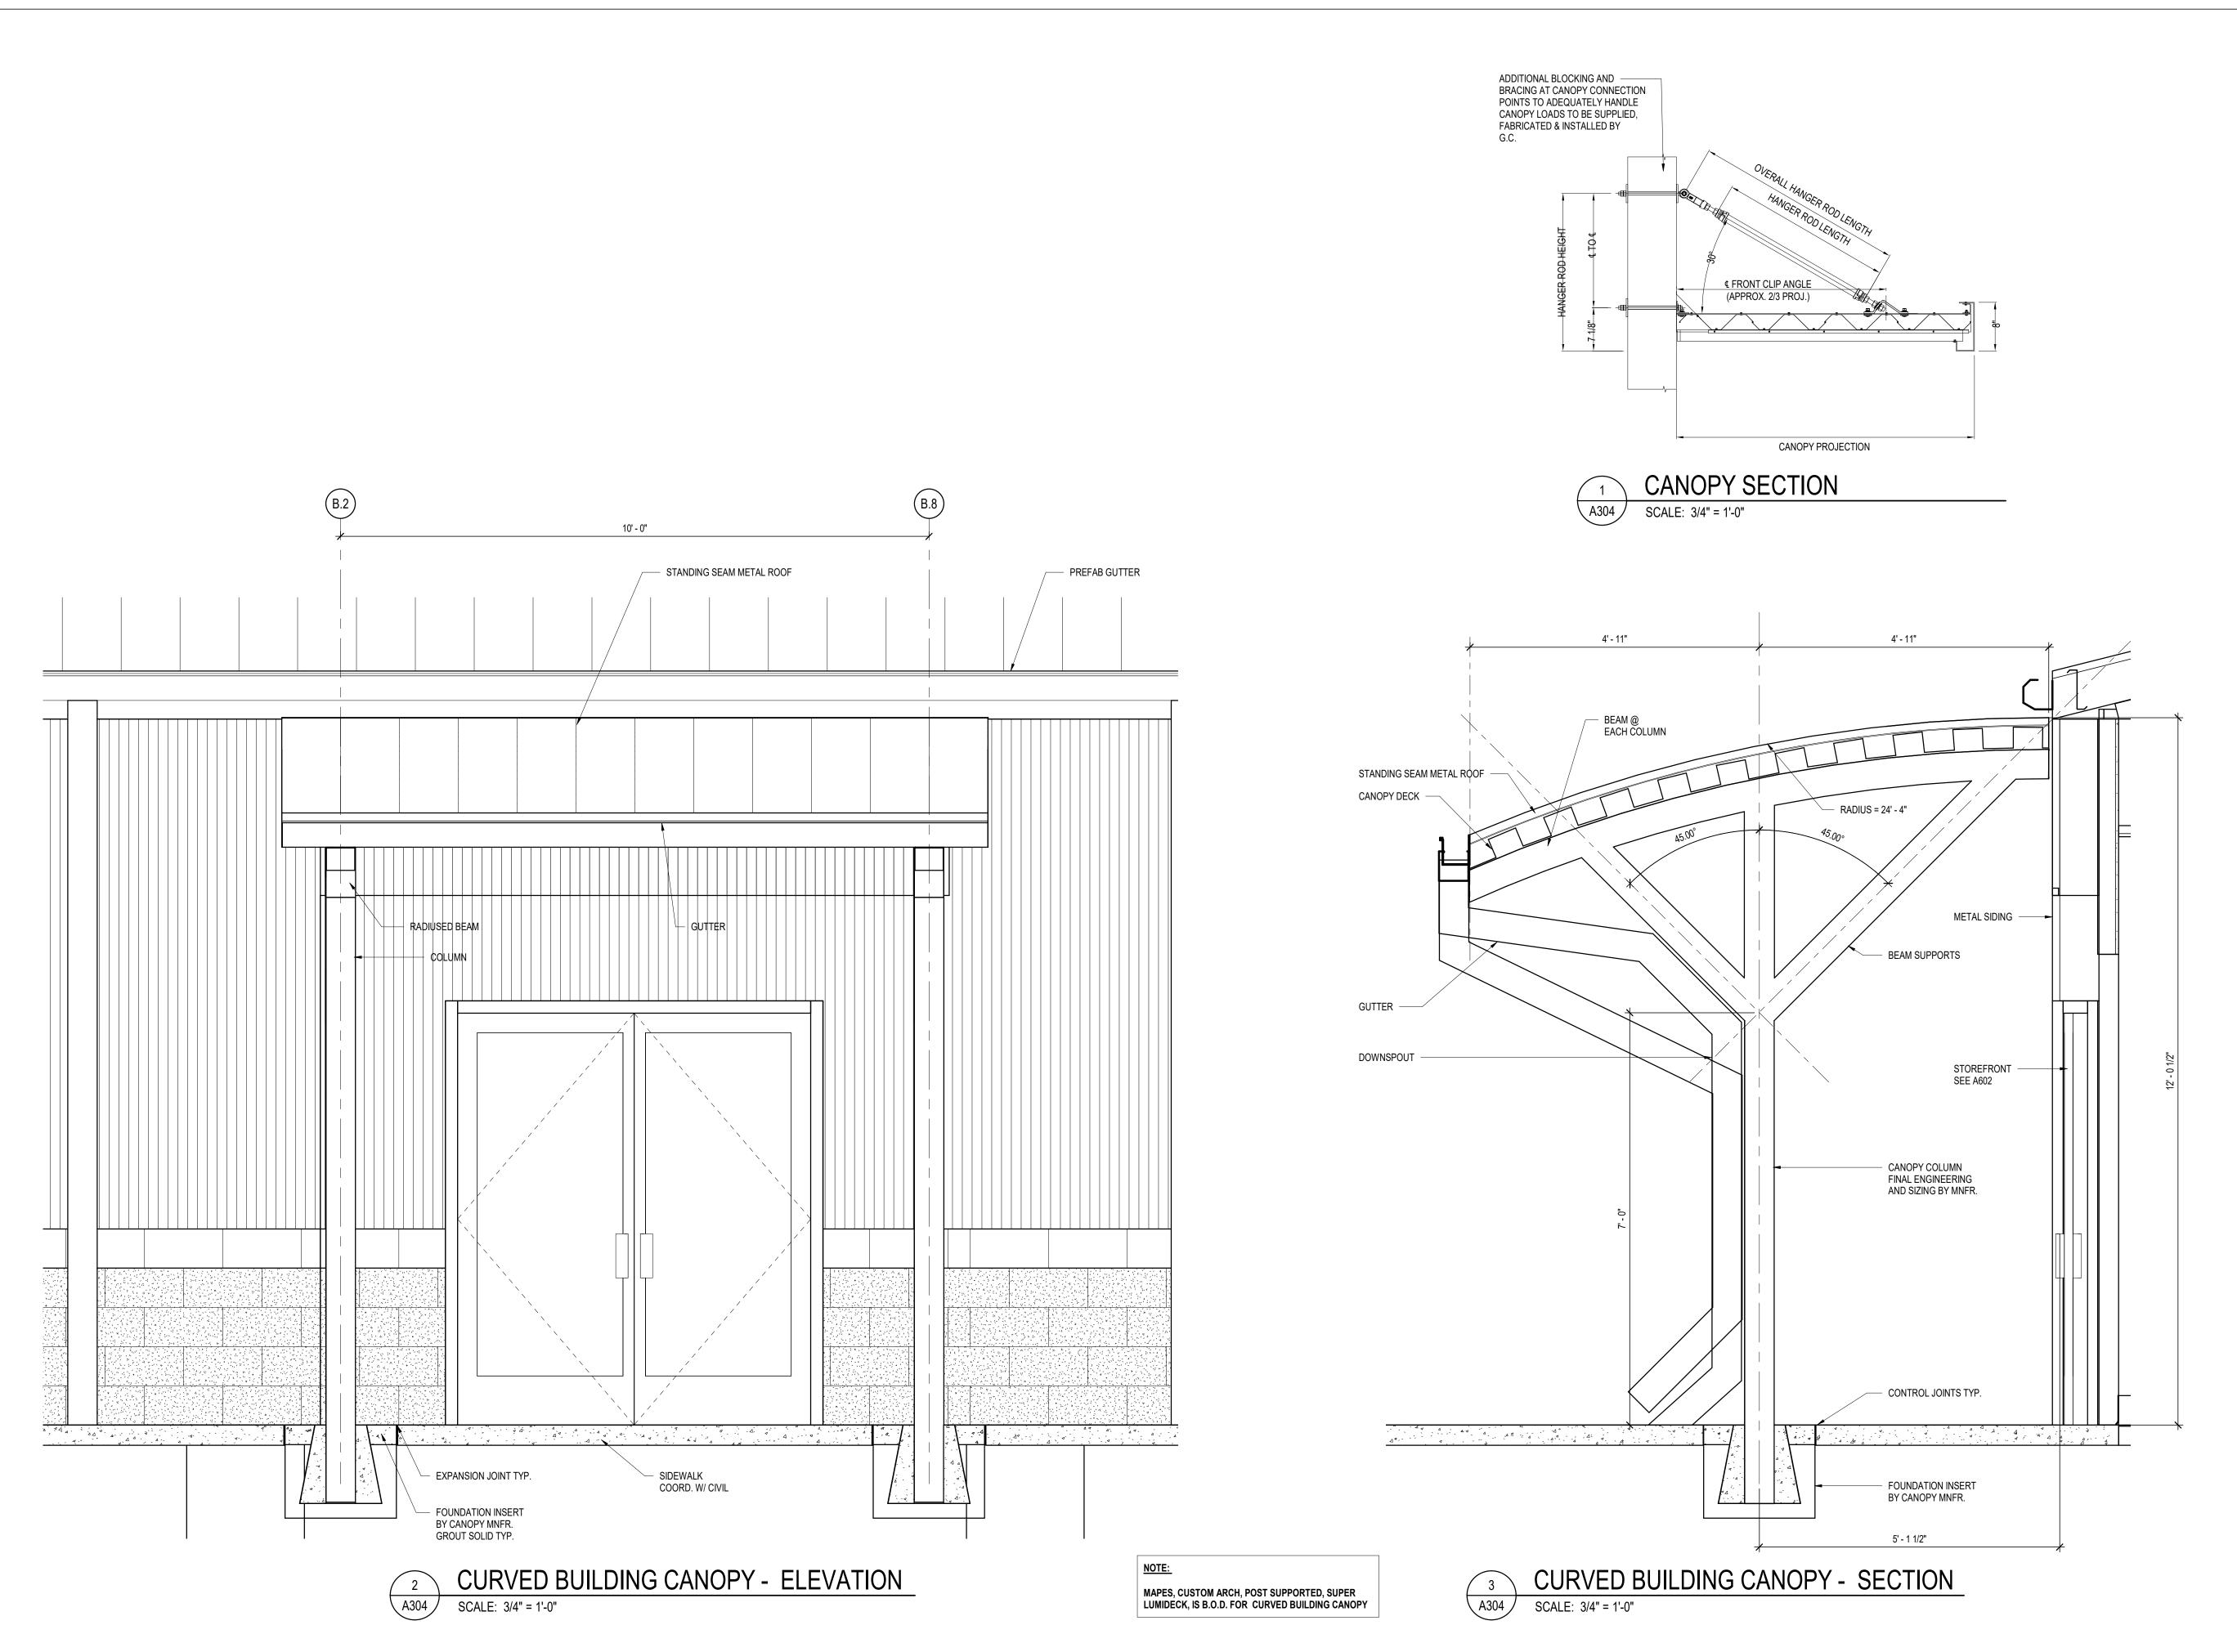
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SHEET TITLE

WALL SECTIONS

SHEET NUMBER

A303





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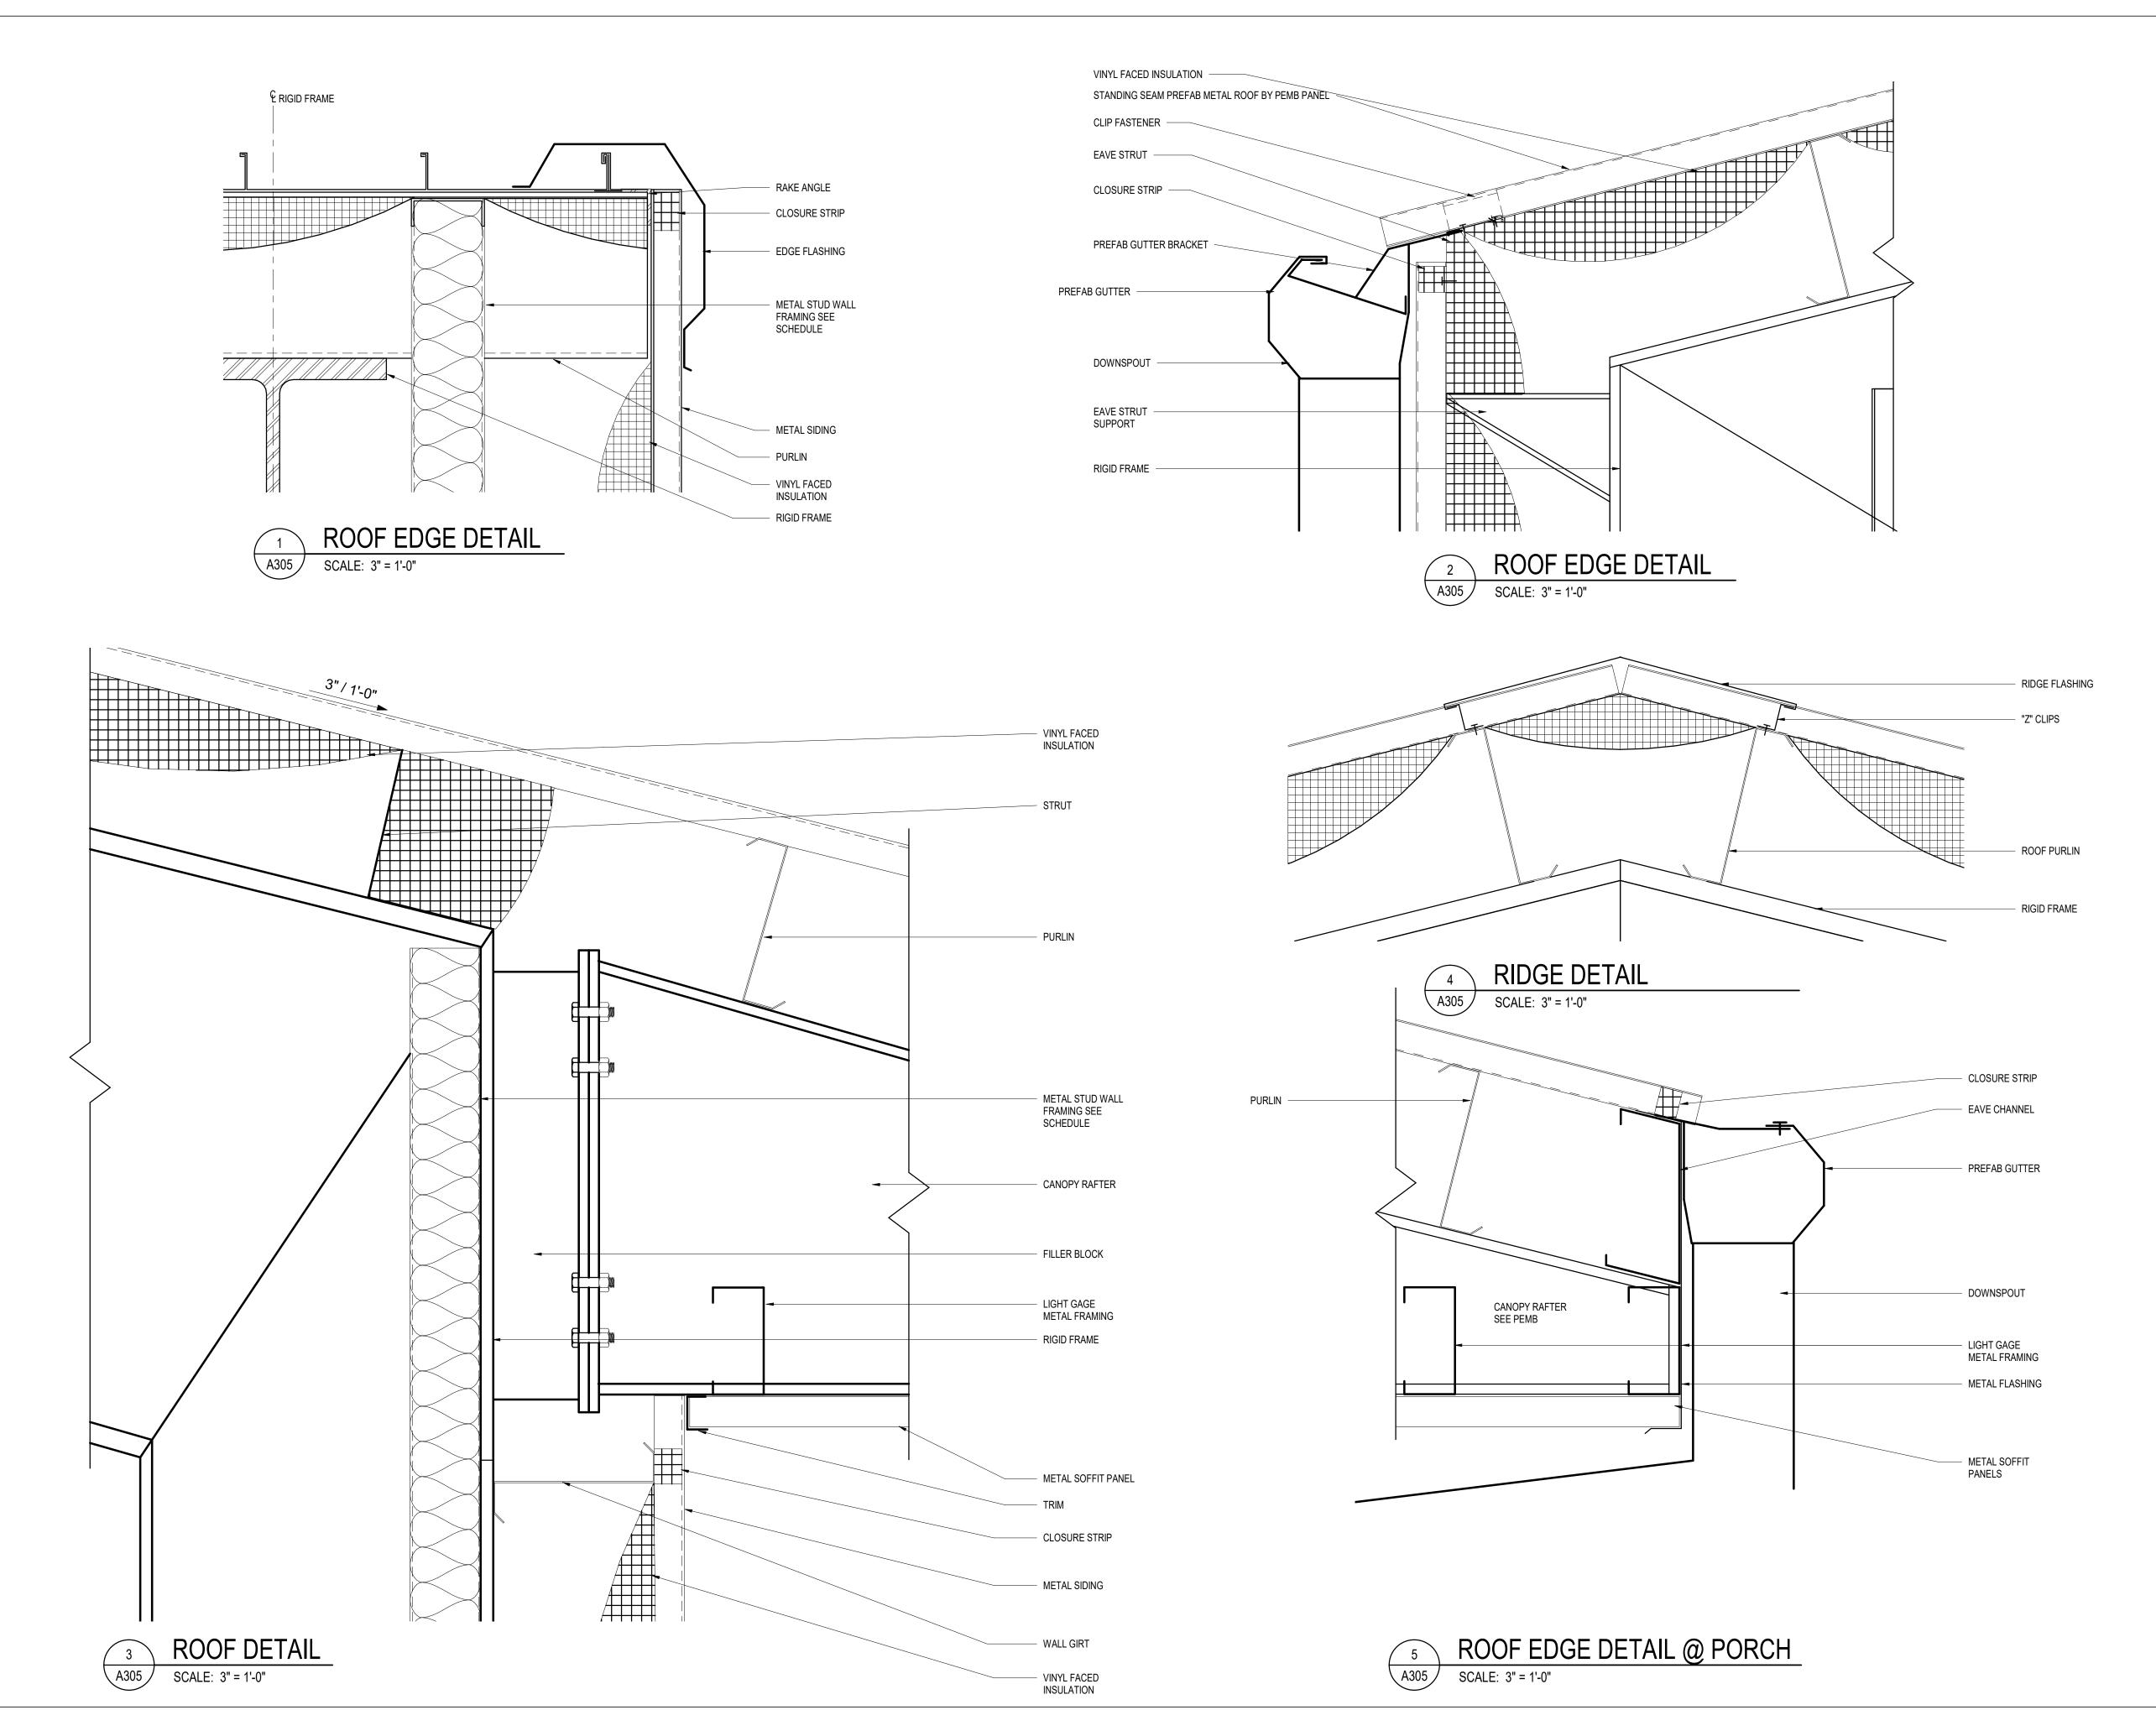
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SHEET TITLE

EXTERIOR SECTIONS & DETAILS

SHEET NUMBER

A304



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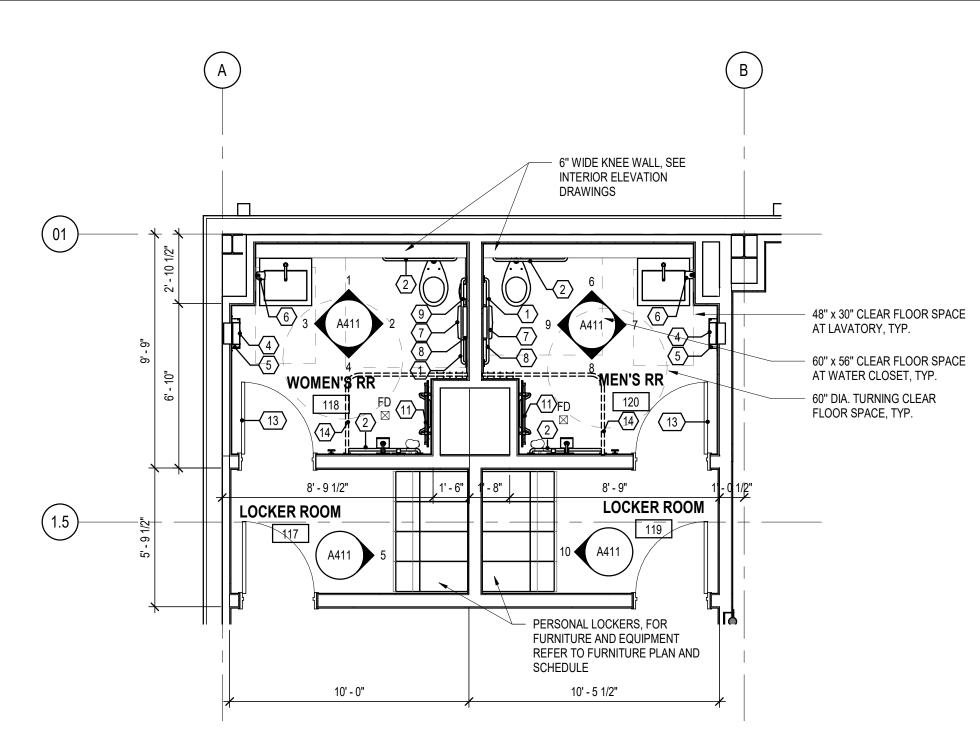
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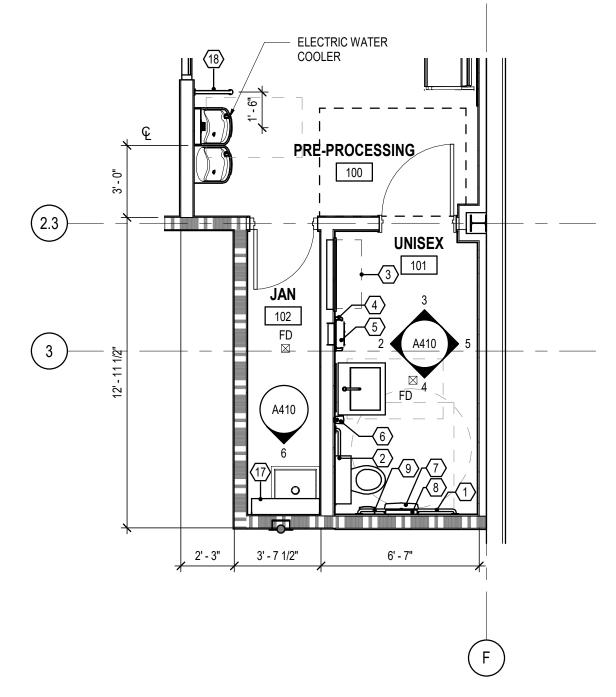
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SHEET NUMBER


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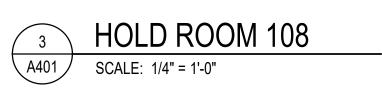



RESTROOM 118,120 & LOCKER ROOM 117,119



RESTROOM 101 & JANITOR 102 SCALE: 1/4" = 1'-0"



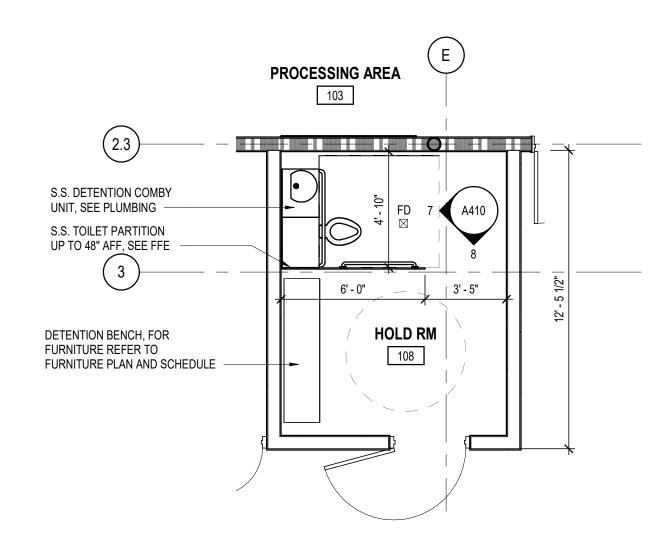

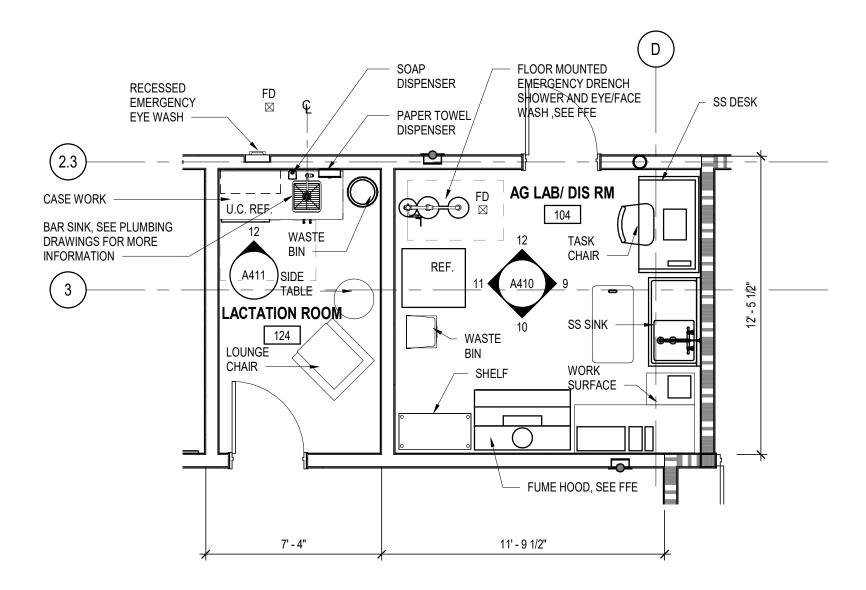

LACTATION ROOM 124 & AG LAB/ DIS ROOM 104 SCALE: 1/4" = 1'-0"

NOTE: FOR FFE SEE SHEET A801

LABEL	DESCRIPTION	MANUFACTURER	MODEL NUMBER	REMARK
1	GRAB BAR, 42" L.	MOEN	90 DEGREE	CHROME
2	GRAB BAR, 36" L.	MOEN	90 DEGREE	CHROME
3	BABY CHANGING STATION	BOBRICK	KB110-SSRE	RECESSED
4	HAND TOWEL DISPENSER	GP ENMOTION	59466A	SS TOUCH-FREE, RECESSED
<u>(5)</u>	FLEX WASTE RECEPTACLE	GP PRO	59791	SS RECESSED FLEX RECEPTACLE
<u>(6)</u>	SOAP DISPENSER, SURFACE MOUNTED, TANK TYPE	GOJO	1919-04	CHROME
<u>(7)</u>	TOILET PAPER DISPENSER	KIMBERLY-CLARK	09608 09601	JRT, SURFACE MOUNTED
<u>(8)</u>	SEAT COVER DISPENSER	BOBRICK	B-221	SS, SURFACE MOUNTED, CAP:250
9	NAPKIN DISPOSAL	BOBRICK	B-270	SS, SURFACE MOUNTED
(10)	SS SHELF	BRADLEY	-	SS, SURFACE MOUNTED
<u>(11)</u>	SHOWER FOLD DOWN SEAT	INVISIA	SERENA SEAT WS-32-CRP	
<u>(12)</u>	MIRROR	BOBRICK	B-165 2436	
<u>(13)</u>	MIRROR	BOBRICK	B-165 2460	
(14)	CEILING SHOWER TRACK WITH CURTAIN	TRAX	L-SHAPED ALUMINUM	SOLID WHITE FABRIC LINER
(15)	12"X12" SS ACCESS PANEL	MIFAB	CAD-SS1212	CYLINDER LOCK, VANDAL RESISTAN
/ټ		MIFAB	MI-SADHSS1212	@ RM 101, 118, 120
<u>(16)</u>	COAT HOOK	MOEN	90 DEGREE	CHROME
<u>(17)</u>	MOP RACK	BRADLEY		SS, SURFACE MOUNTED
⟨18⟩	DRINKING FOUNTAIN GRAB BAR	BOBRICK	819298	SS, FLOOR MOUNTED

1. CONTRACTOR TO PROVIDE ALL BLOCKING AND FRAMING TO SUPPORT CEILING HUNG PARTITIONS AND SCREENS ABOVE CEILING AND IN WALLS 2. SEE SHEET A001 FOR ADA CLEARANCE AND MOUNTING HEIGHTS.

3. ALL OUTSIDE WALL CORNERES WITH TILES TO RECEIVE EDGE- PROTECTION PROFILES SCHLUTER - QUADEC AS B.O.D. 4. FOR FURNITURE AND EQUIPMENT REFER TO FFE PLAN AND SCHEDULE, SEE SHEET A801.

SCALE: 1/4" = 1'-0"

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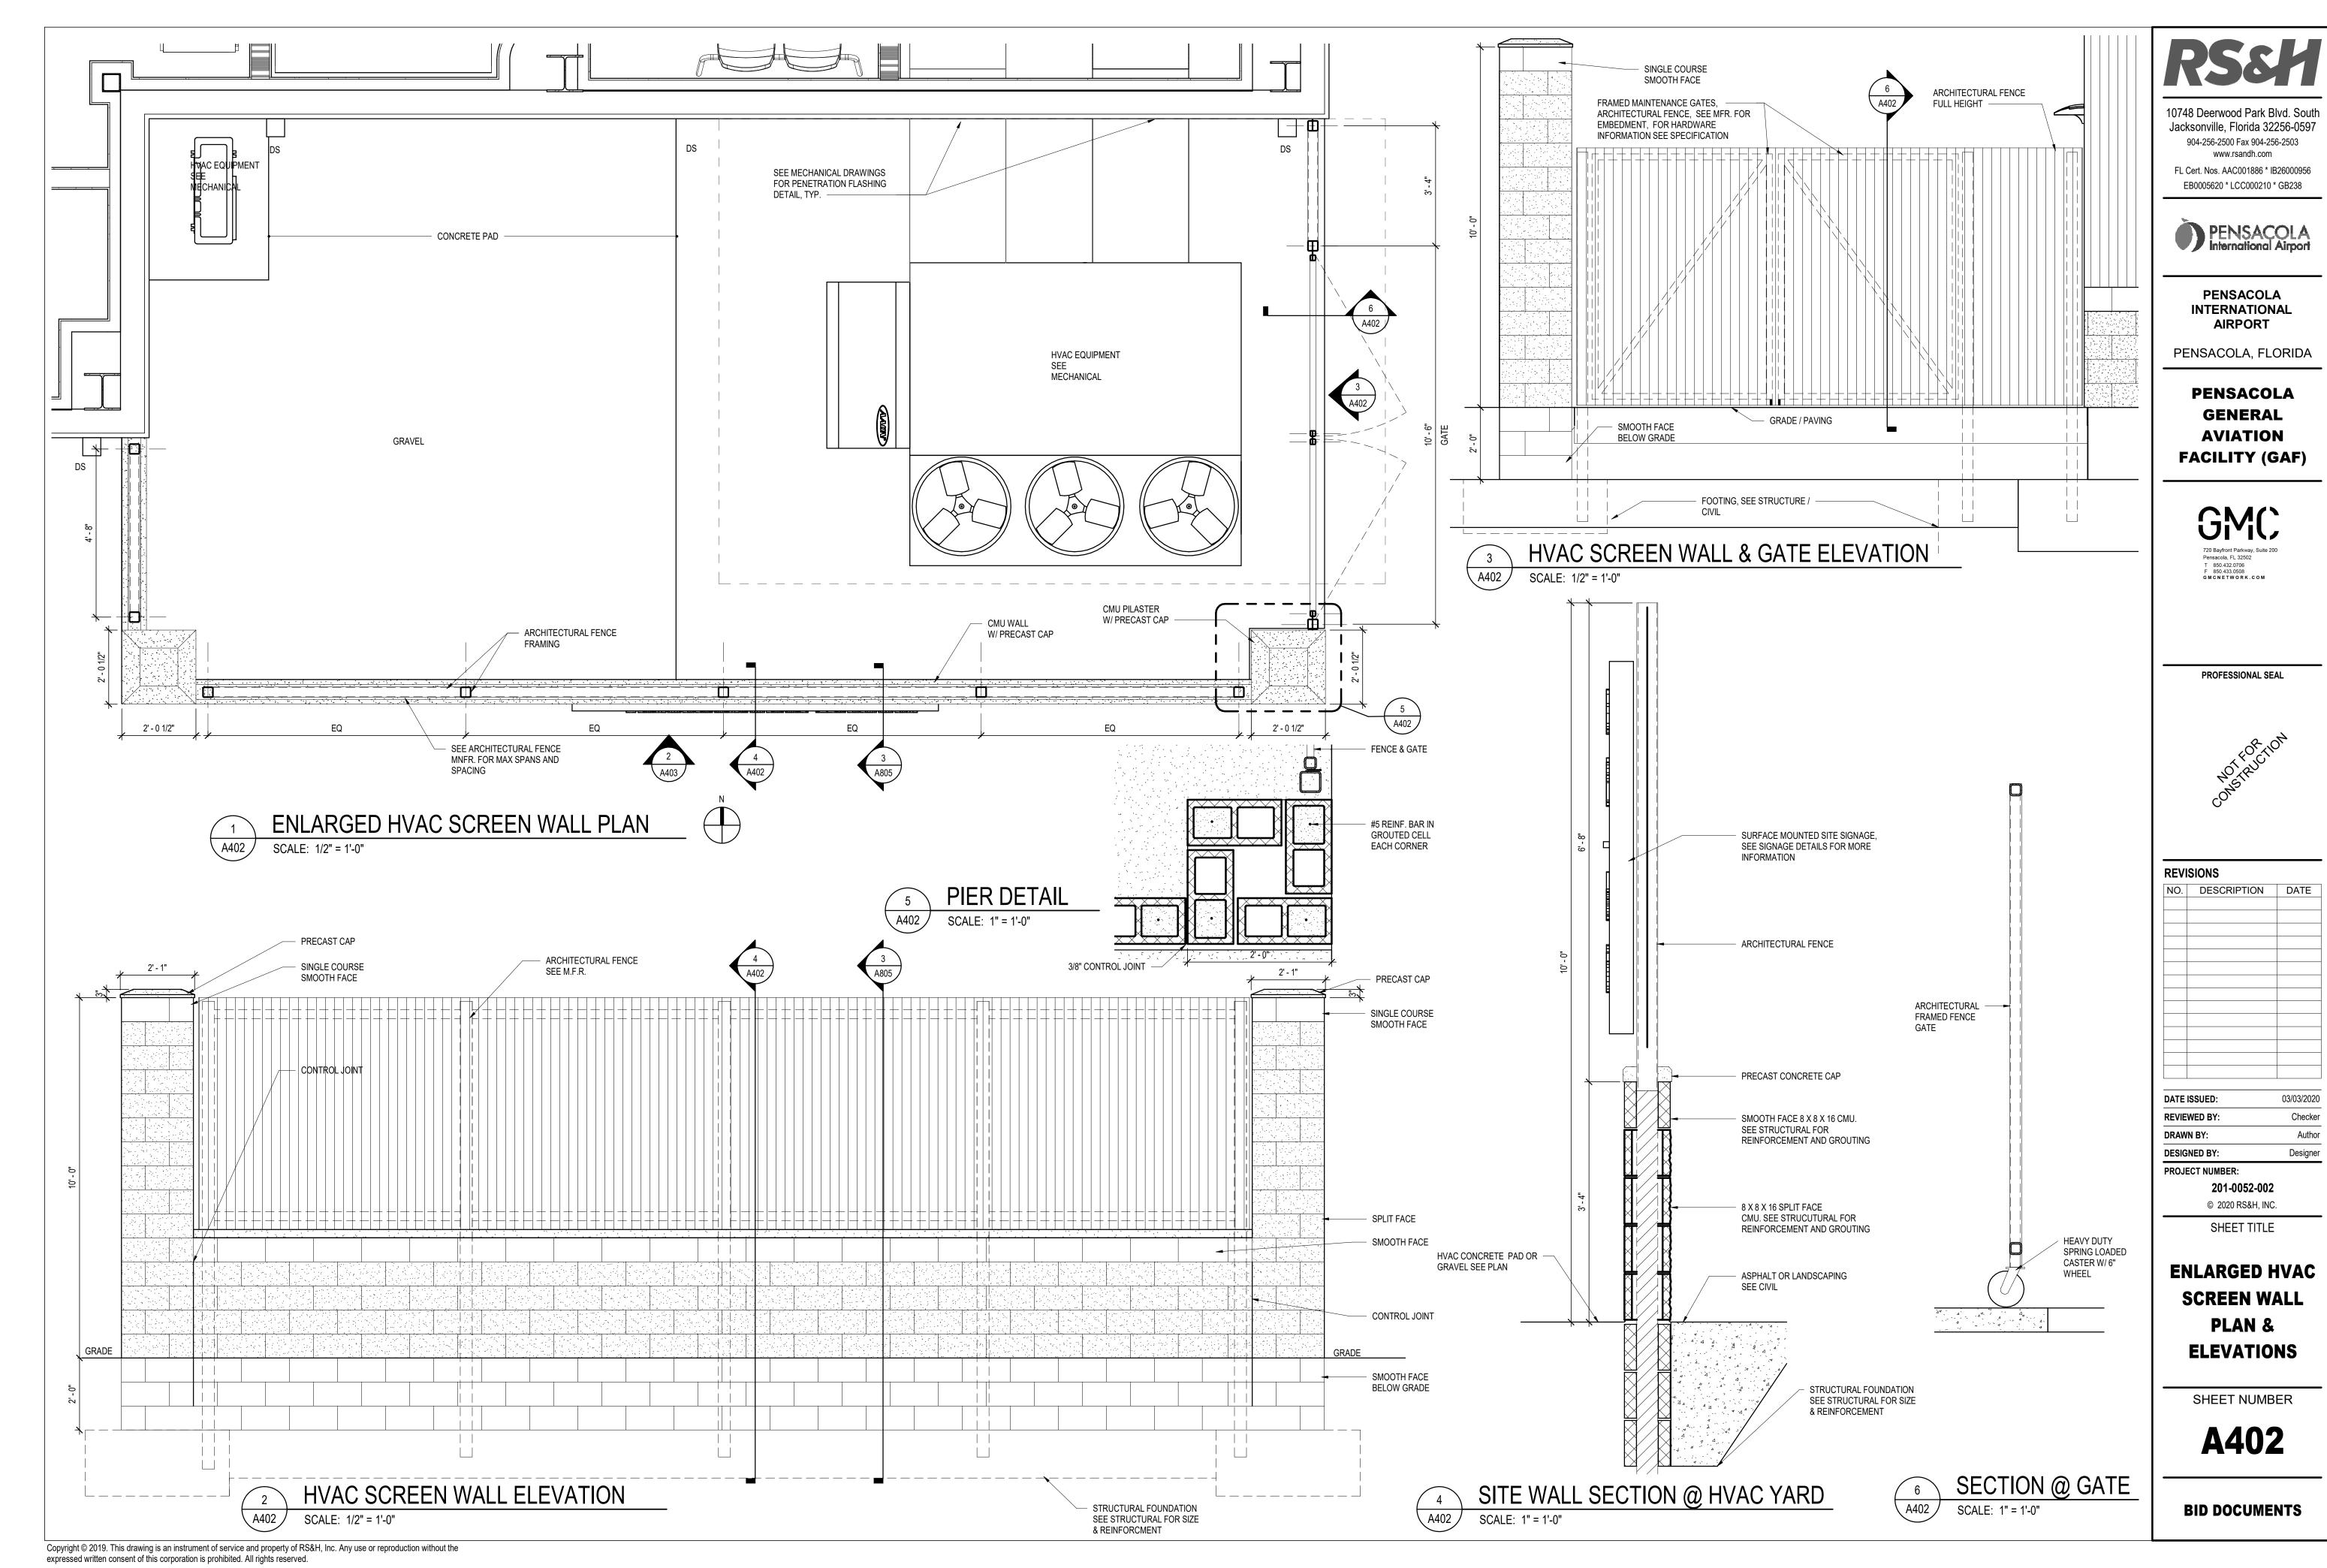
ENLARGED PLANS


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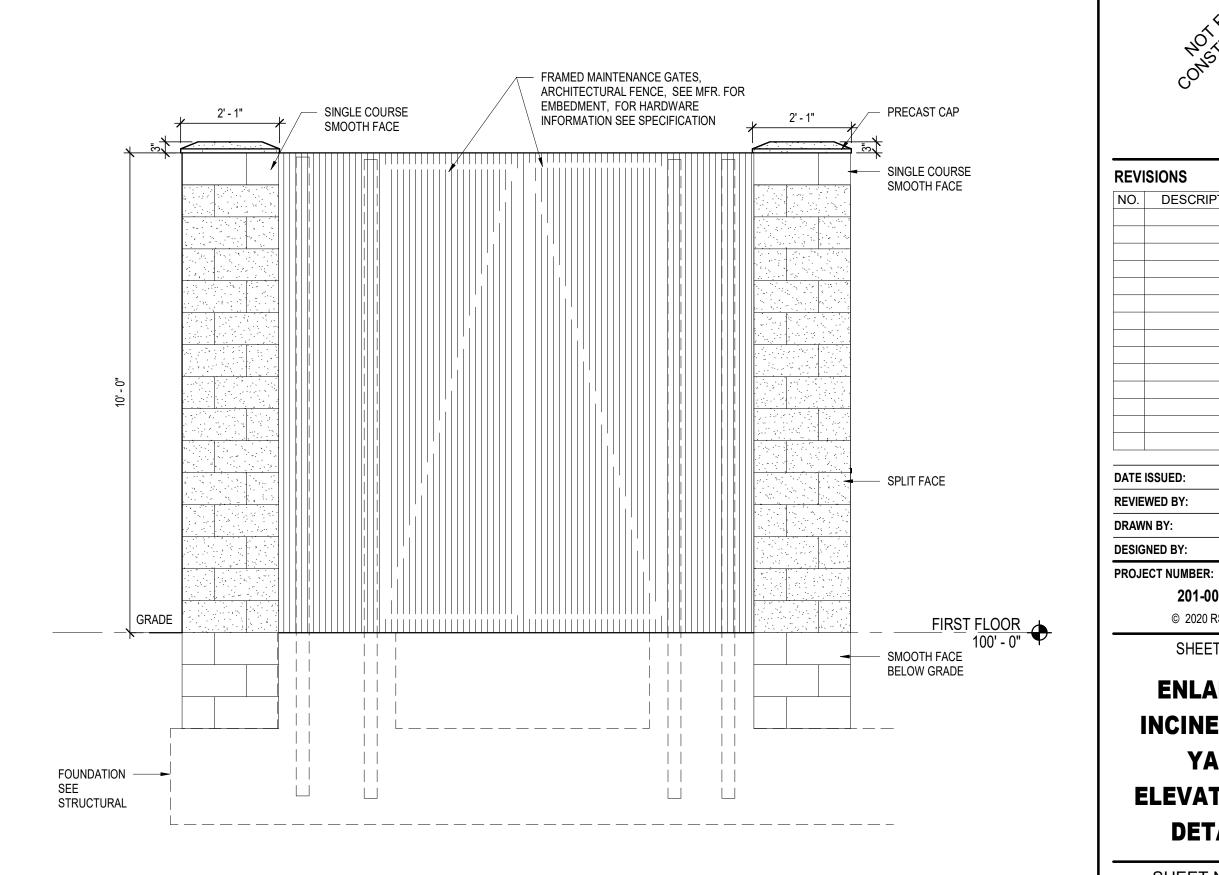
SHEET TITLE

SHEET NUMBER

A401





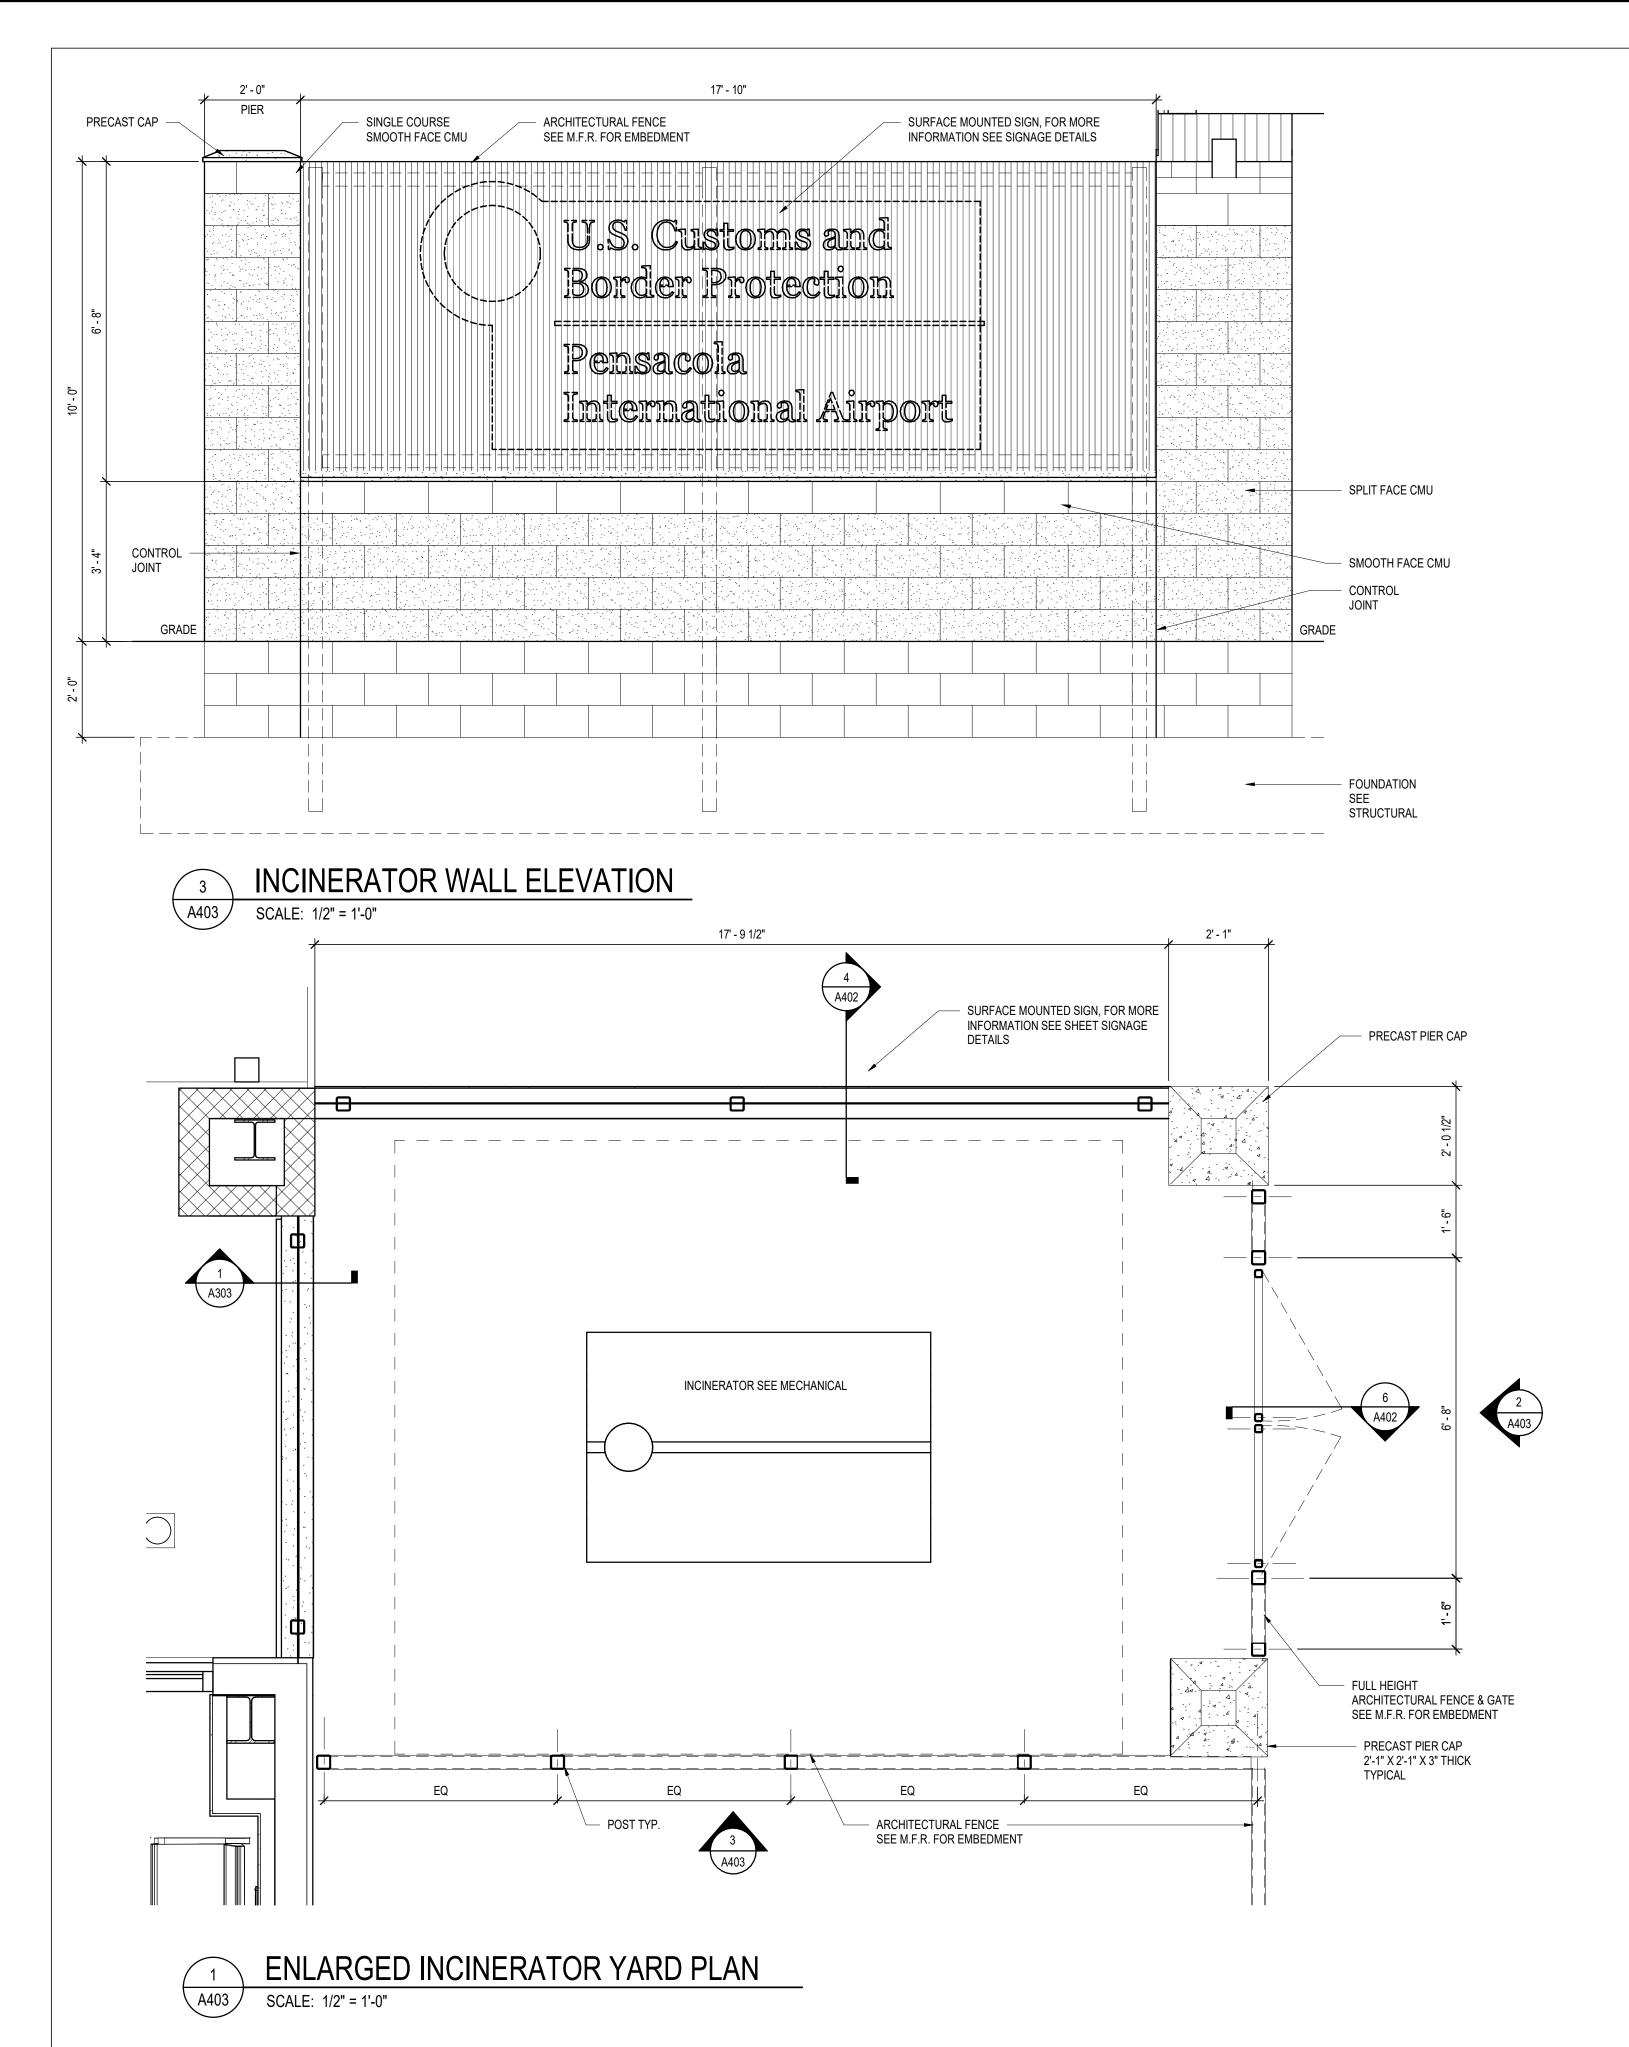

SCALE: 1/2" = 1'-0"

INCINERATOR GATE ELEVATION

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SHEET TITLE

ENLARGED

INCINERATOR

YARD

ELEVATIONS &


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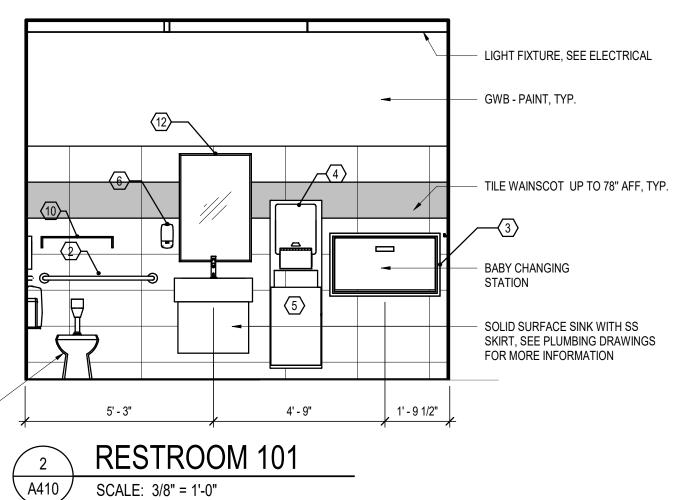
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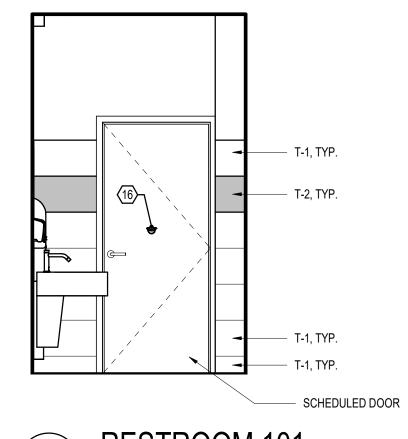
A403

Author


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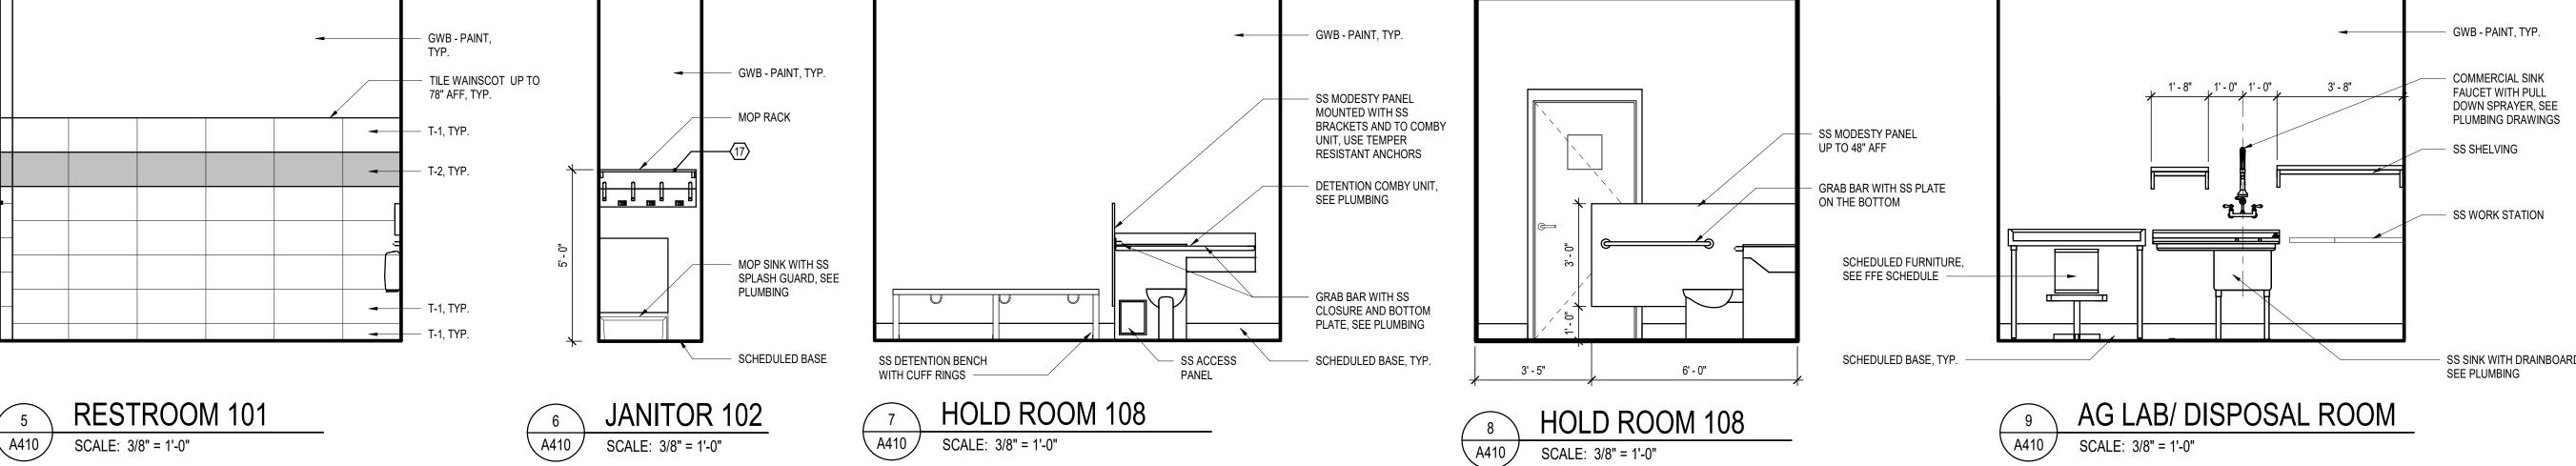








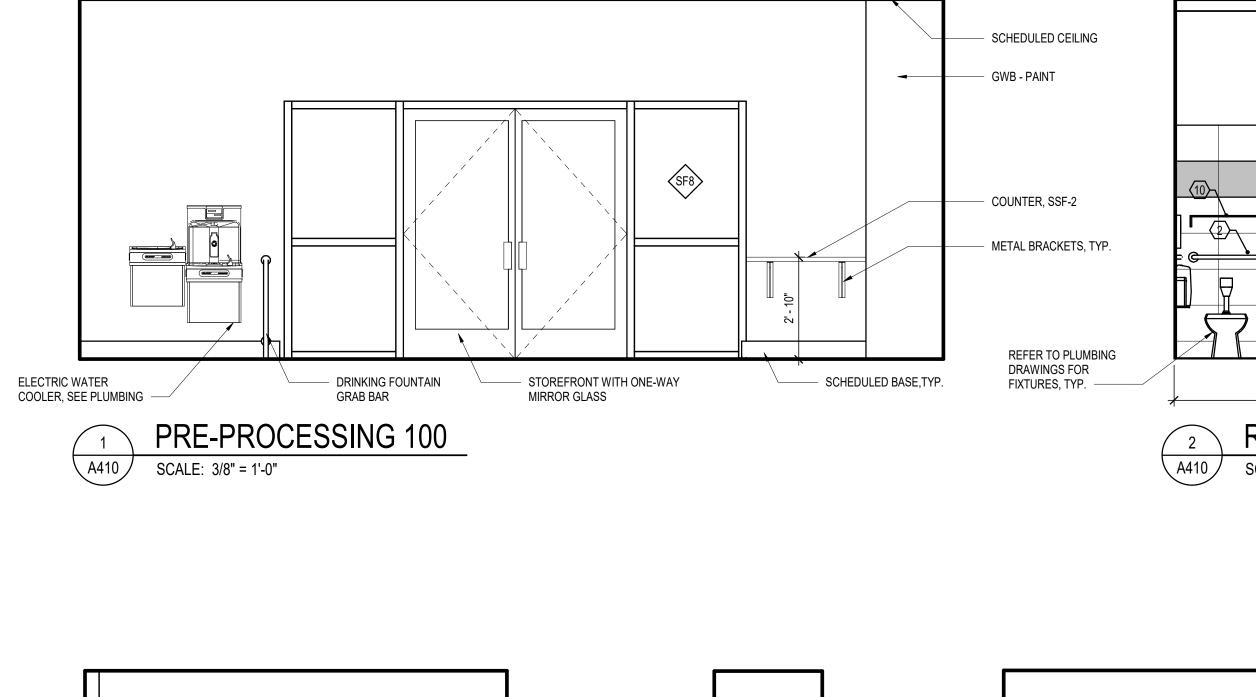





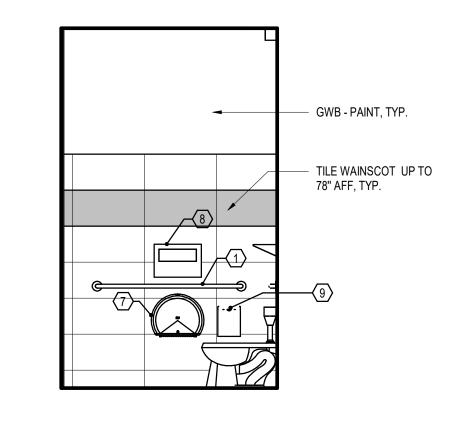

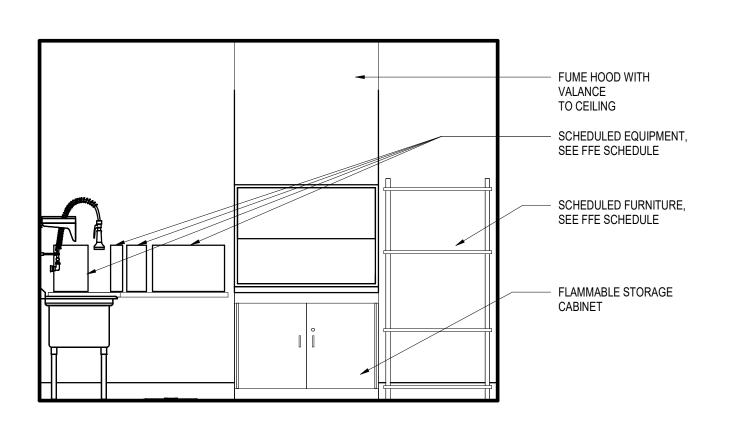


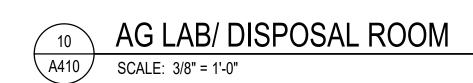

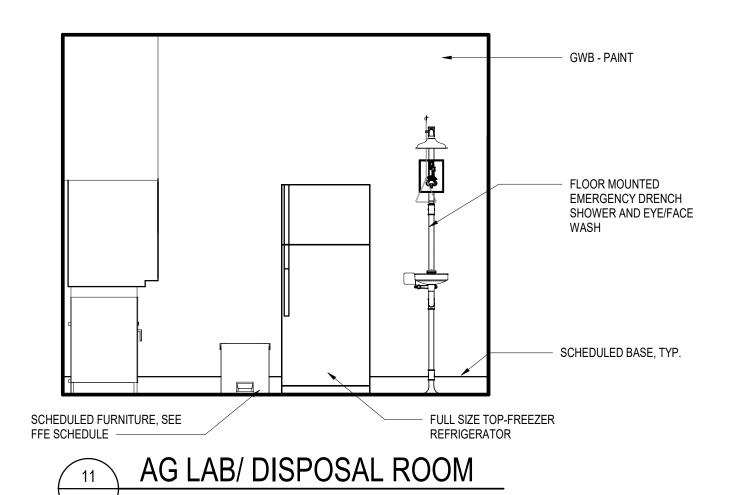

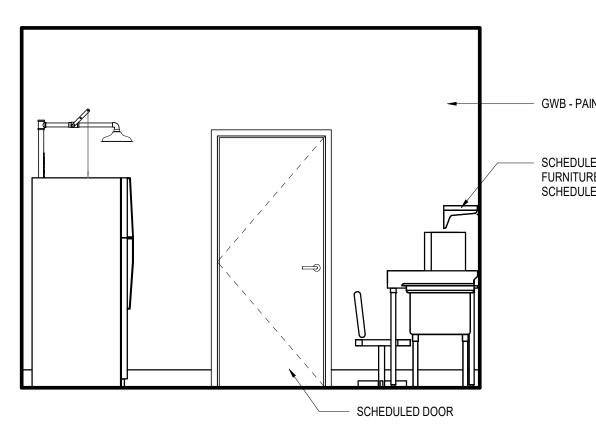



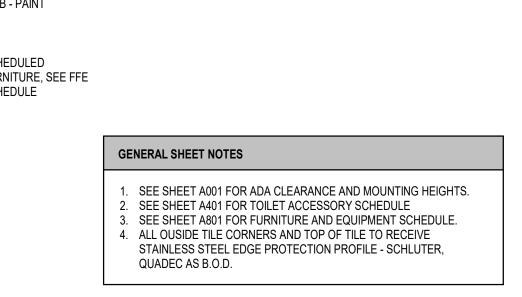



A410

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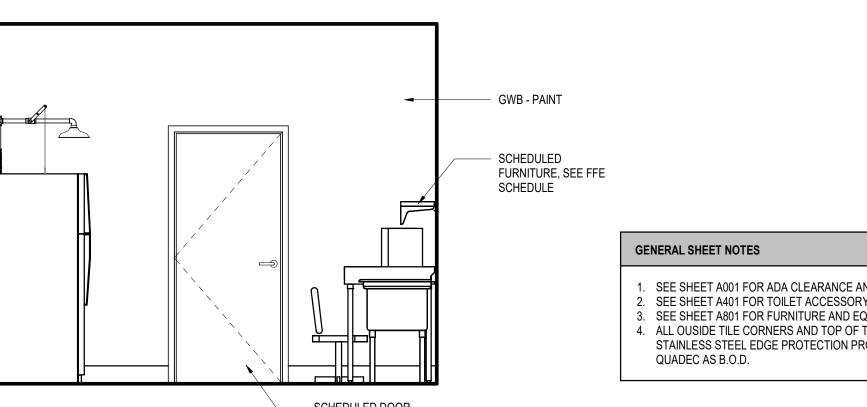
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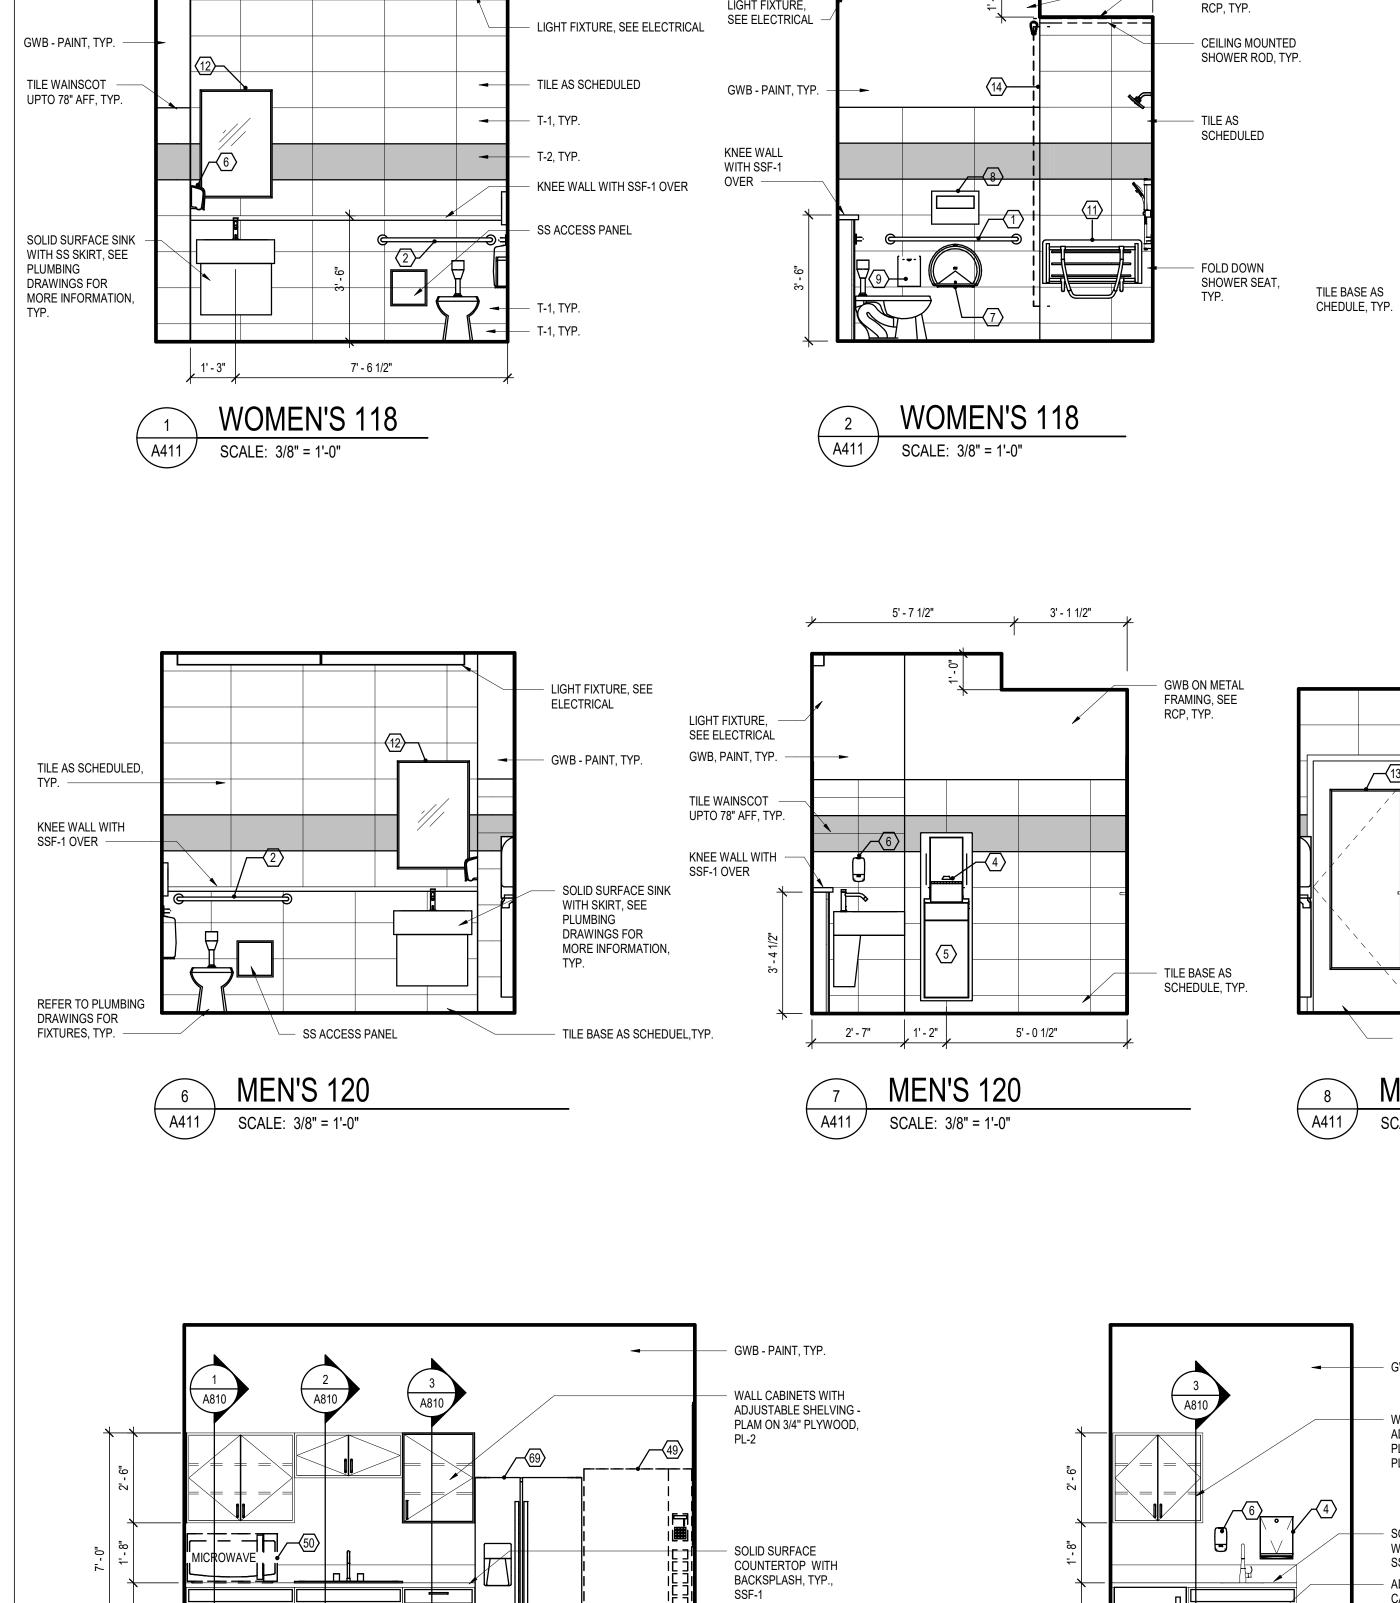
SHEET TITLE

INTERIOR

ELEVATIONS

DRAWN BY:





BASE CABINETS - PLAM ON 3/4" PLYWOOD, PL-2

SCHEDULED BASE

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ADA COMPLIANT

SINK BASE CABINET

2' - 0"

BREAKROOM 121

5' - 7 1/2"


LIGHT FIXTURE,


GWB ON METAL

FRAMING, SEE

GWB ON METAL FRAMING,

SEE RCP, TYP. -

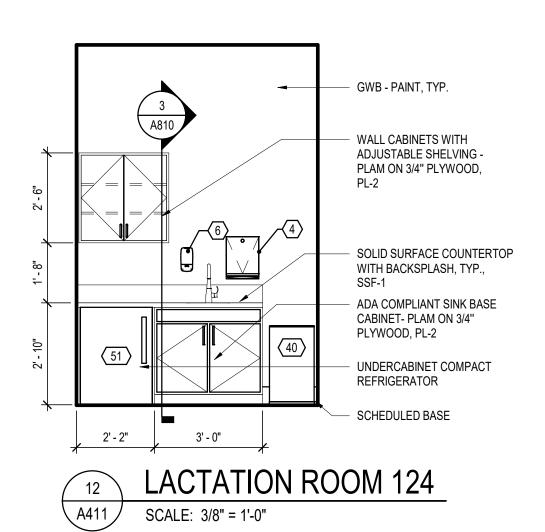

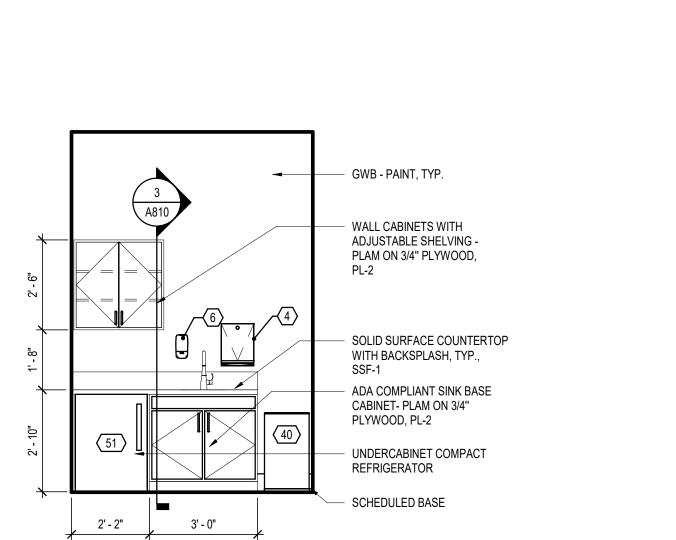

SCHEDULED DOOR

MEN'S 120

5' - 7 1/2"

 $\langle 5 \rangle$

WOMEN'S 118

1' - 2"

LIGHT FIXTURE,

SEE ELECTRICAL

GWB - PAINT, TYP.

TILE WAINSCOT

UPTO 78" AFF, TYP.

KNEE WALL WITH

GWB ON METAL FRAMING, SEE RCP, TYP.

TILE AS SCHEDULE,

FIXED SHOWER

ADJ. HAND HELD FOLD DOWN SHOWER SHOWER SPRAY SEAT, TYP.

FIXED SHOWER

SHOWER CURTAIN

VALVE CONTROL

HEAD

SSF-1 OVER

FIXED SHOWER

SHOWER COURTAIN


ADJ. HAND HELD

SHOWER SPRAY

VALVE CONTROL

AREA -

HEAD -

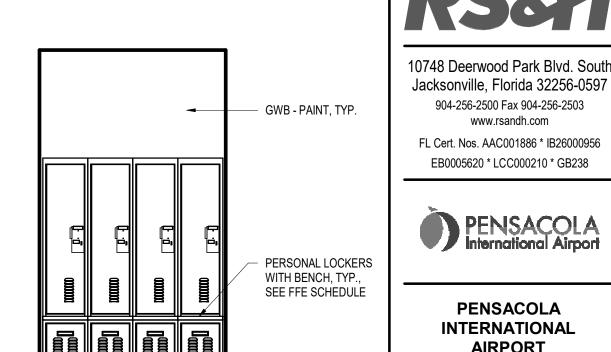

WOMEN'S 118 A411

LIGHT FIXTURE,

SEE ELECTRICAL

- GWB - PAINT, TYP.

78" AFF, TYP.

OVER

TILE WAINSCOT UPTO

KNEE WALL WITH SSF-1


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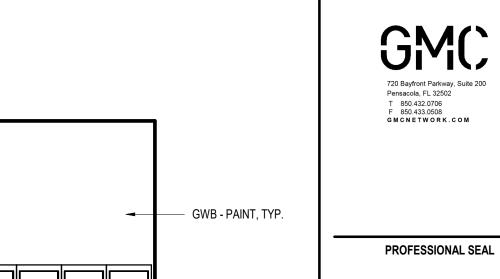
DRAWINGS FOR FIXTURES, TYP.

SCHEDULED DOOR

MEN'S 120





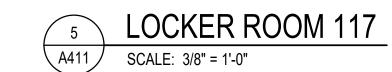

PERSONAL LOCKERS

WITH BENCH, TYP., SEE

FFE SCHEDULE

LOCKER ROOM 119



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REVISIONS NO. DESCRIPTION DATE

DATE ISSUED: 03/03/2020 **REVIEWED BY:** JKS DRAWN BY: MWR **DESIGNED BY:** PROJECT NUMBER:

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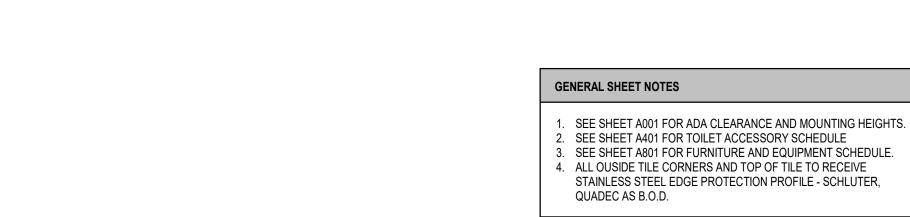
SHEET TITLE

INTERIOR ELEVATIONS

SHEET NUMBER

A411

BID DOCUMENTS



SCALE: 3/8" = 1'-0"



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DRAWN BY:			JKS	
DESIG	NED BY:	MWR		

DESIGNED BY:
PROJECT NUMBER:
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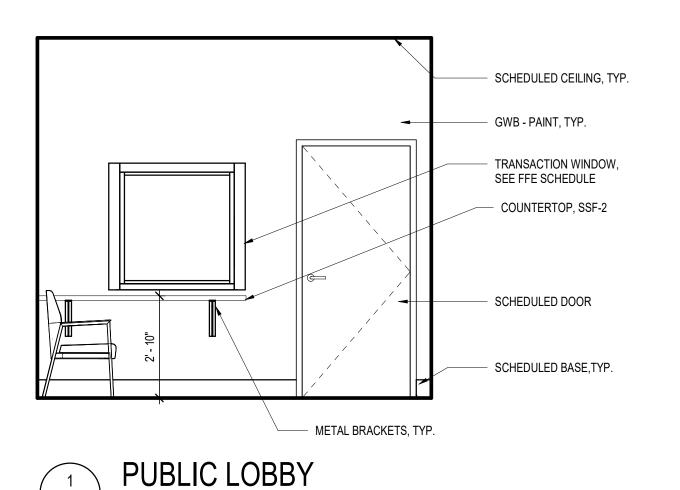
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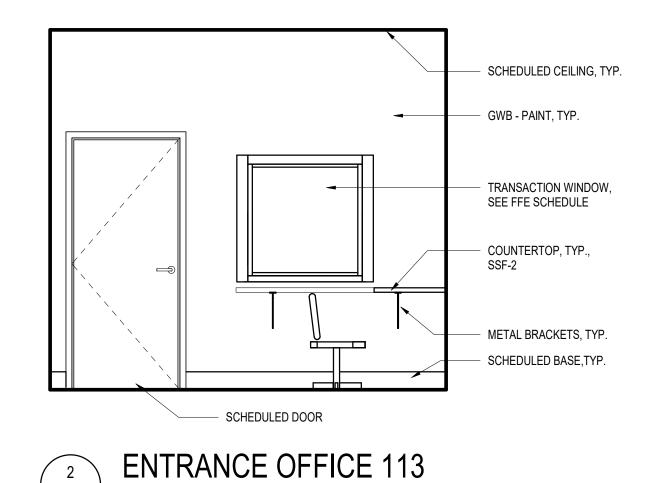
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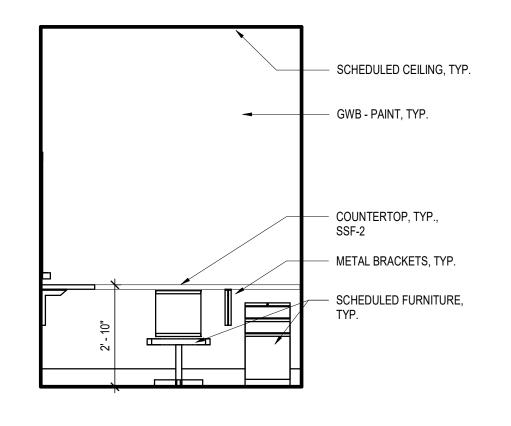
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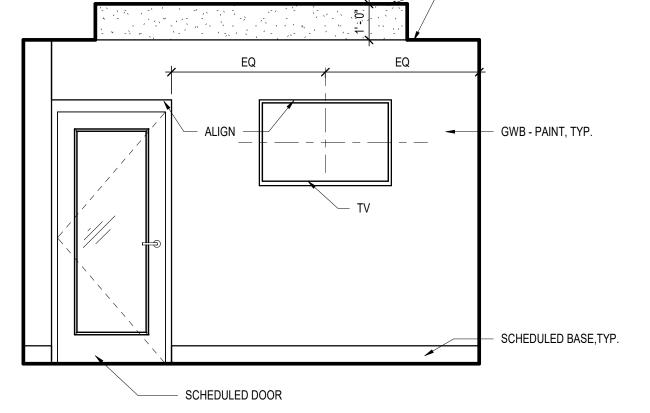
A412

A413









- SCHEDULED CEILING, TYP.

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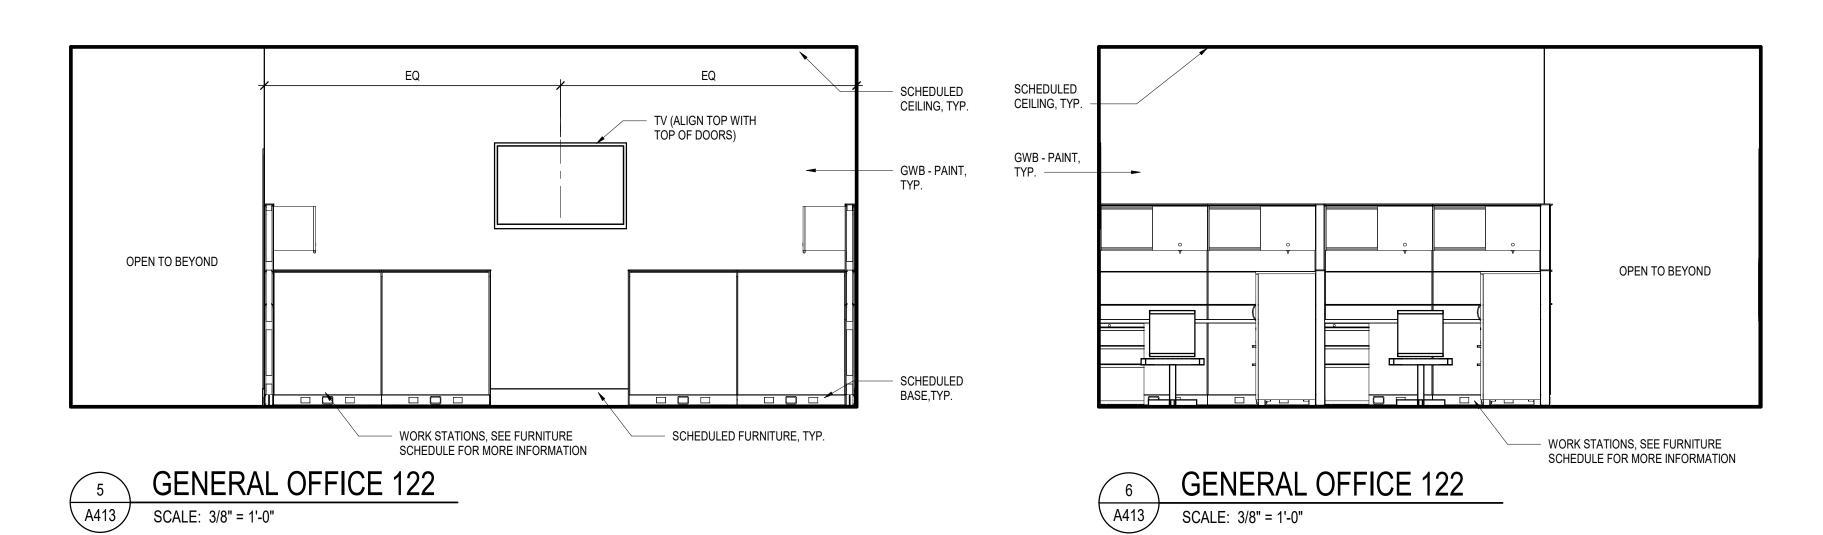
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DATE ISSUED:

REVIEWED BY:


ENTRANCE OFFICE 113 A413

CONFERENCE ROOM 116 A413 SCALE: 3/8" = 1'-0"





SCALE: 3/8" = 1'-0"


A413

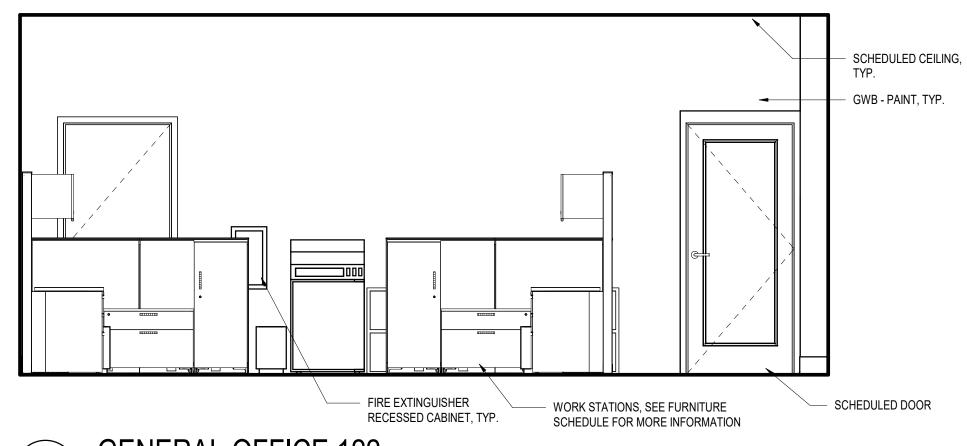

GENERAL OFFICE 122

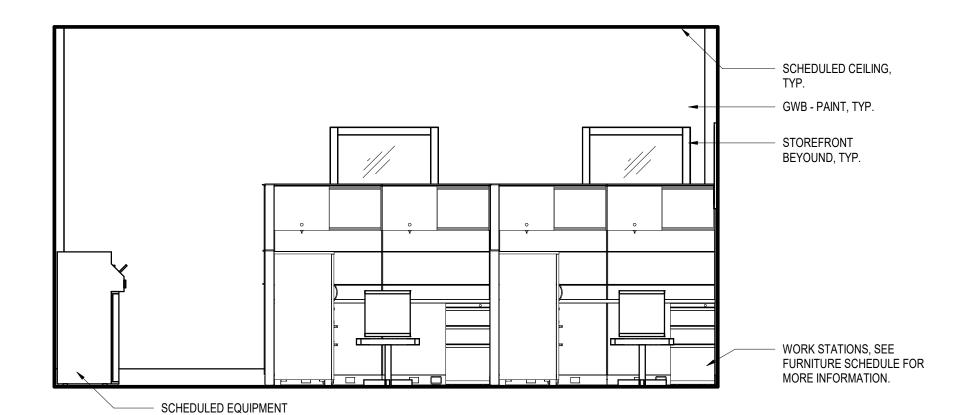

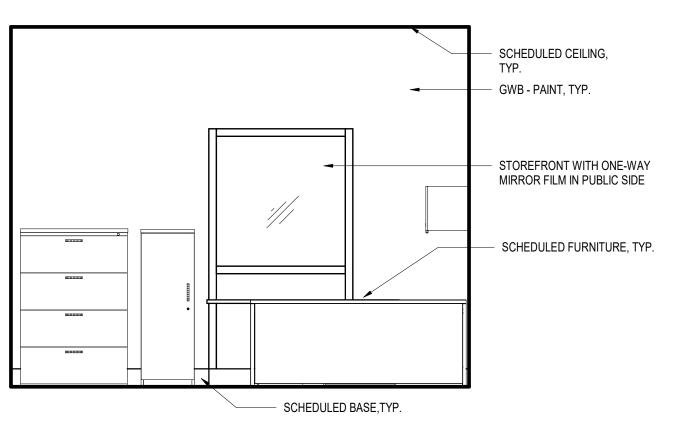

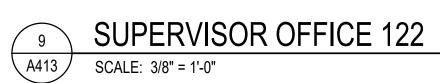





- 1. SEE SHEET A001 FOR ADA CLEARANCE AND MOUNTING HEIGHTS.
- 2. SEE SHEET A401 FOR TOILET ACCESSORY SCHEDULE
- 3. SEE SHEET A801 FOR FURNITURE AND EQUIPMENT SCHEDULE.
- 4. ALL OUSIDE TILE CORNERS AND TOP OF TILE TO RECEIVE STAINLESS STEEL EDGE PROTECTION PROFILE - SCHLUTER,
- QUADEC AS B.O.D.



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GENERAL OFFICE 121

DRAWN BY: **DESIGNED BY:** PROJECT NUMBER:

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03/03/2020

JKS


MWR

SHEET TITLE


INTERIOR ELEVATIONS

SHEET NUMBER

A413

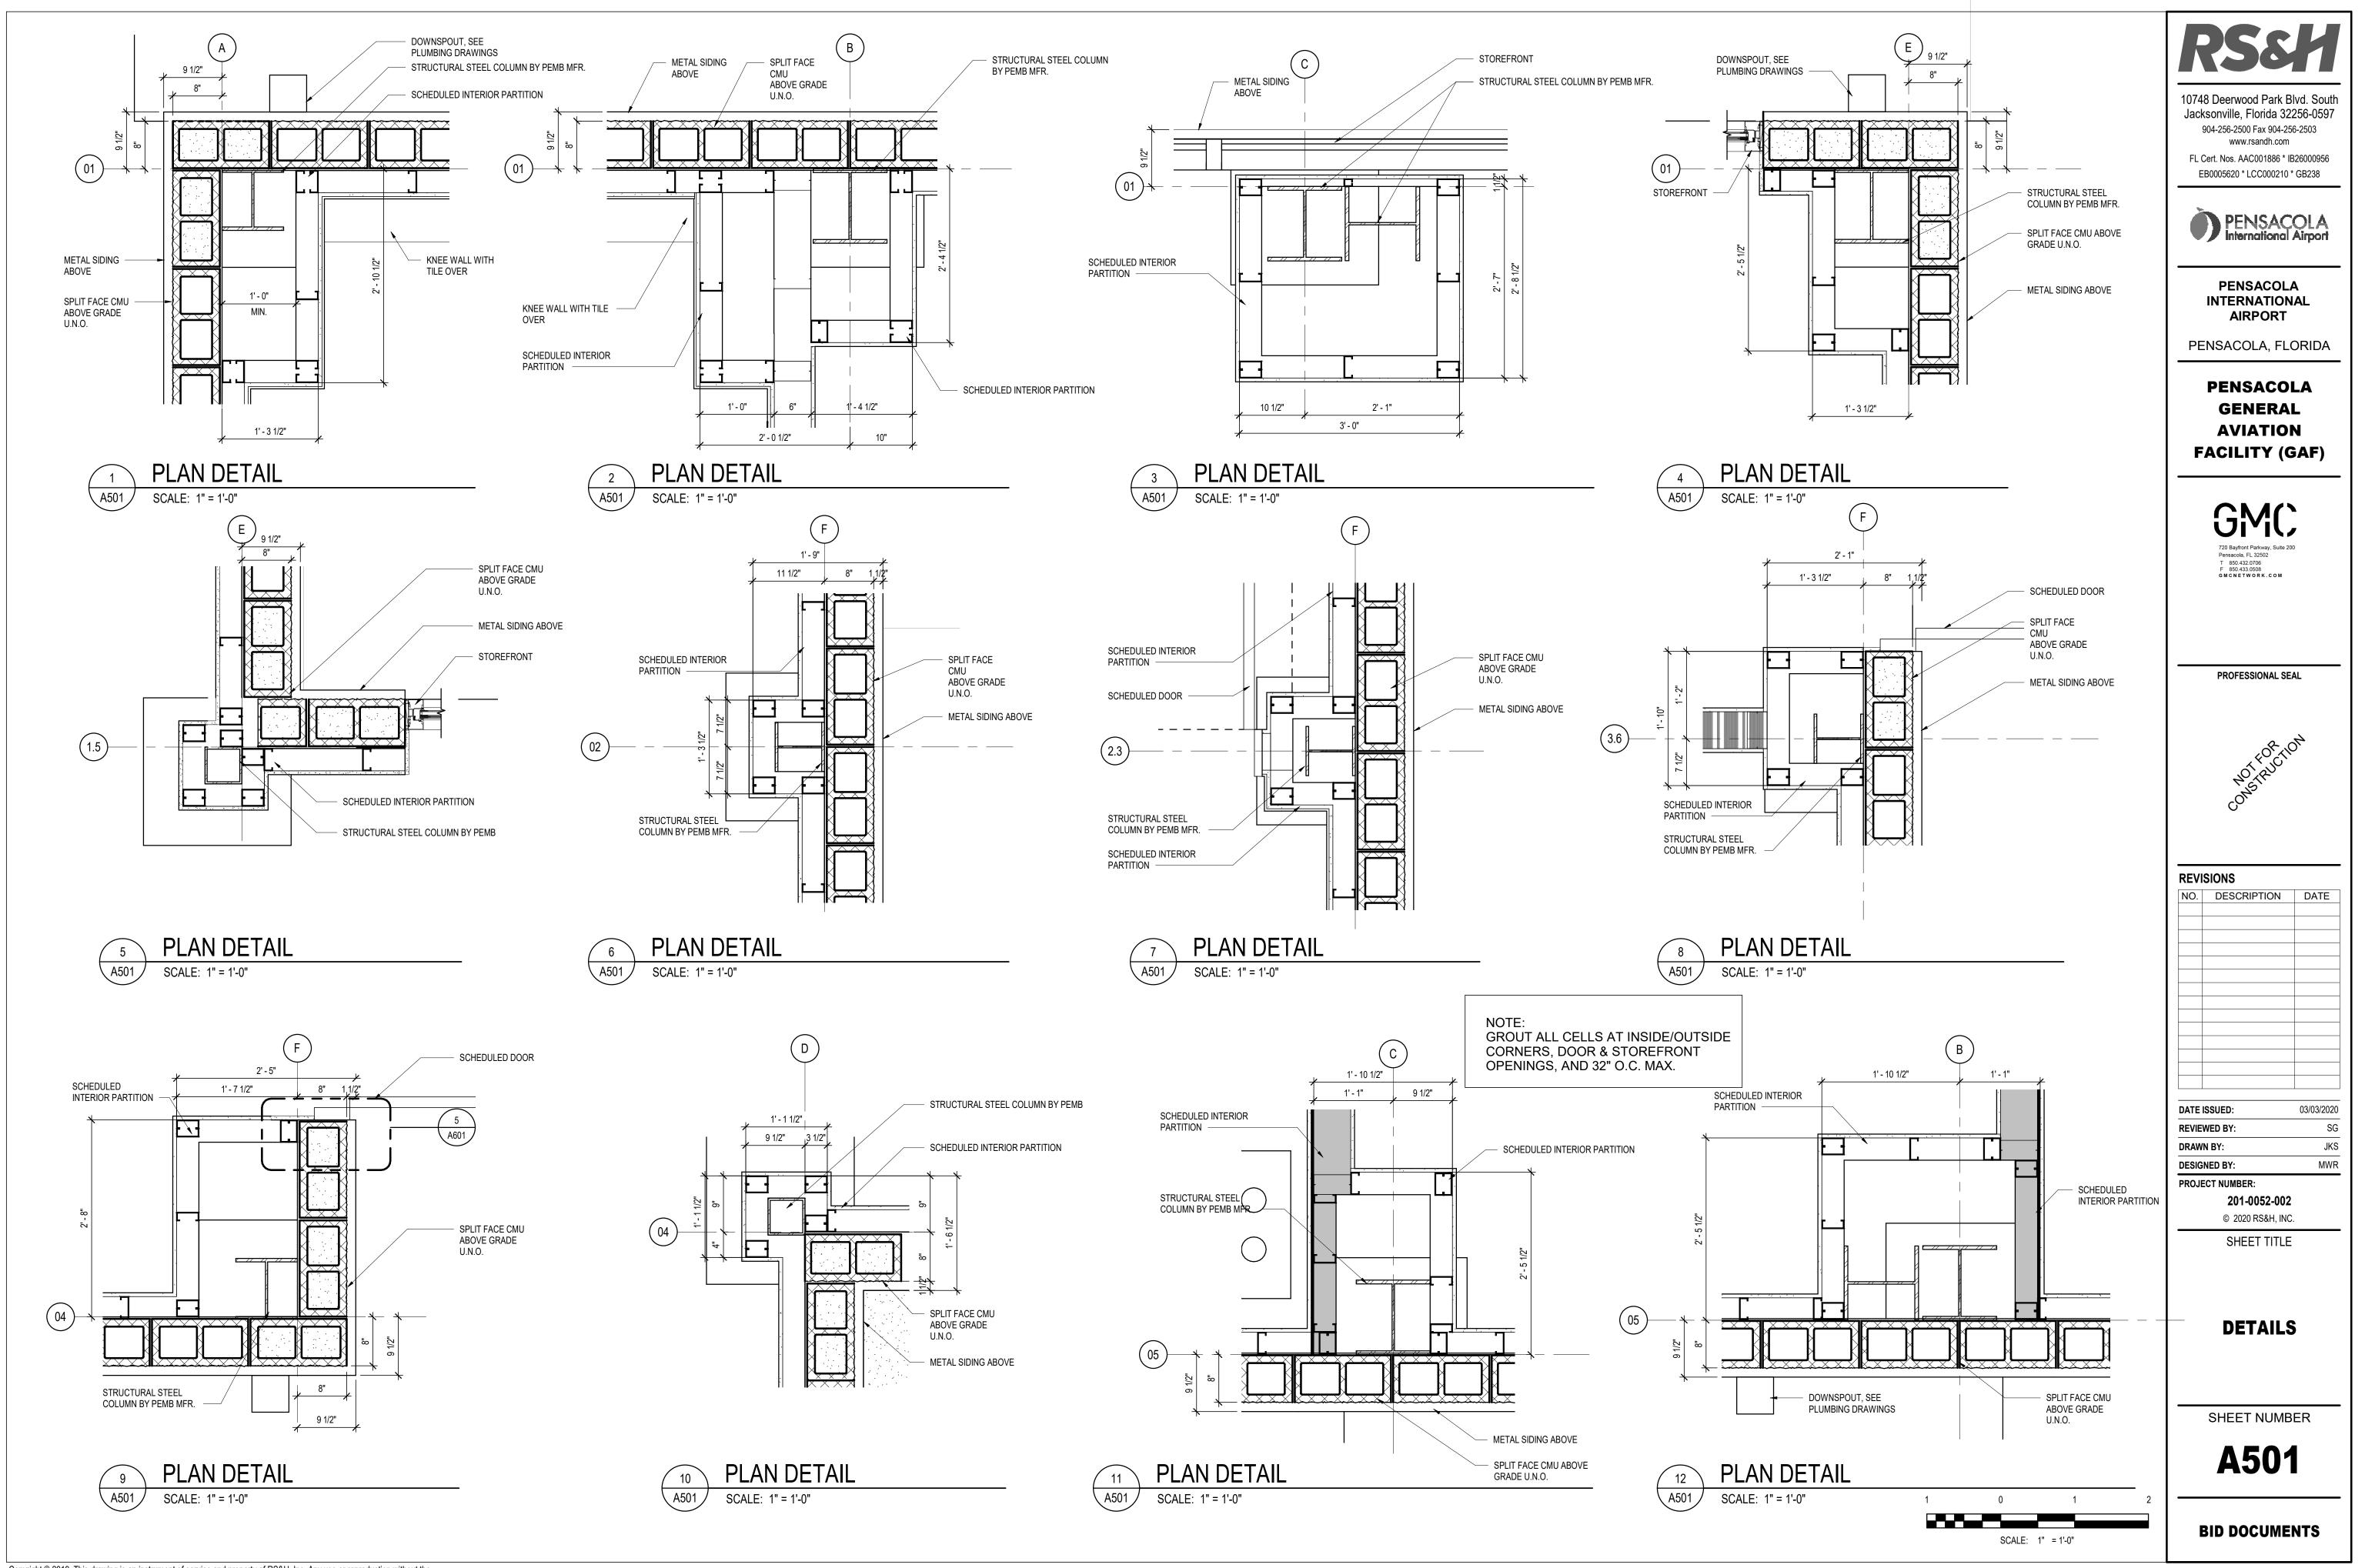

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CMU TO METAL SIDING TRANSITION DETAIL

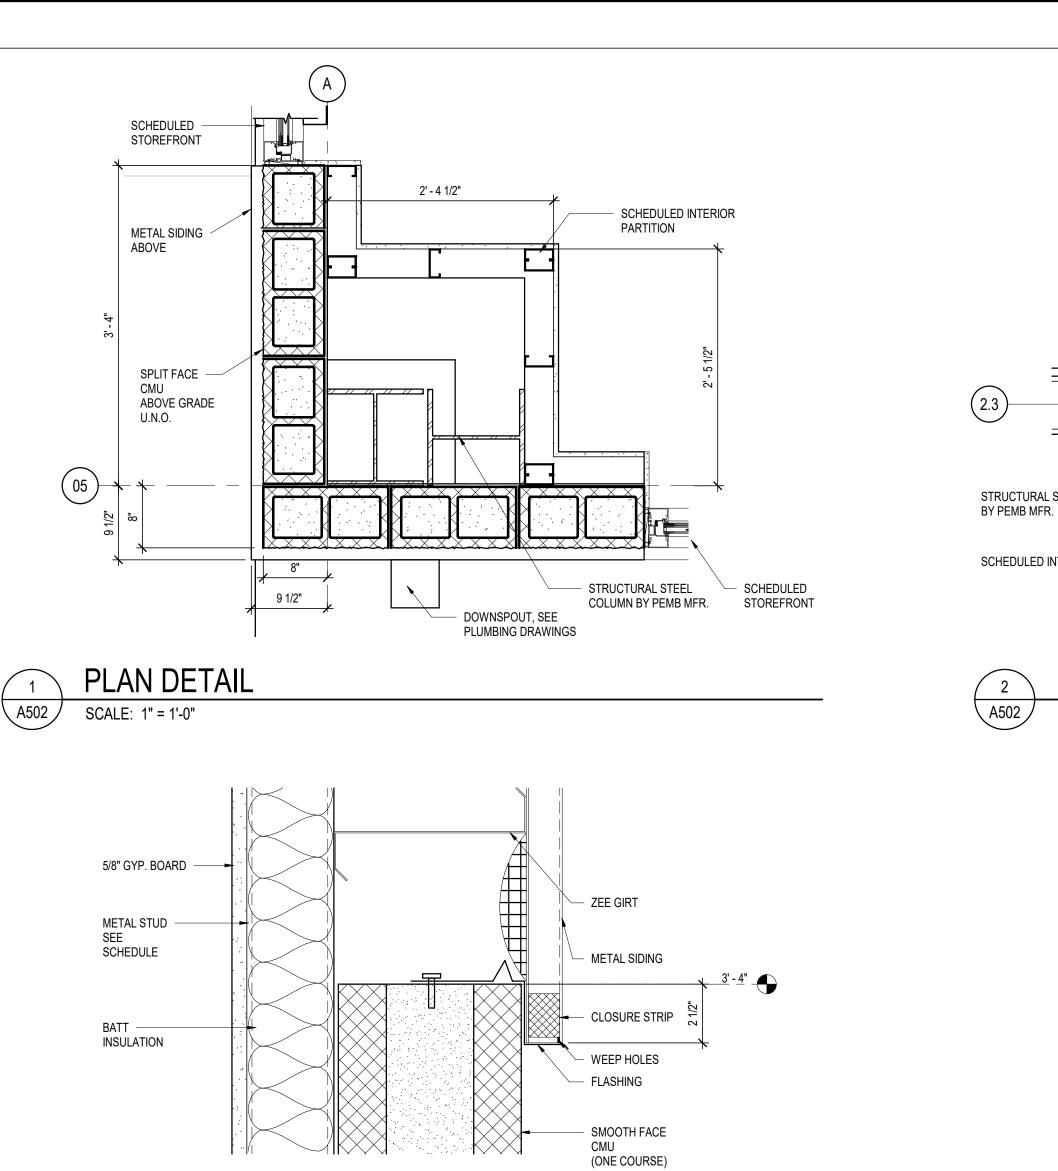SPLIT FACE CMU SEE STRUCTURAL FOR REINFORCEMENT


3/8" EXPANSION JOINT


FILLER & SEALANT


SIDEWALK SEE CIVIL

CONCRETE SLAB

SEE STRUCTURAL

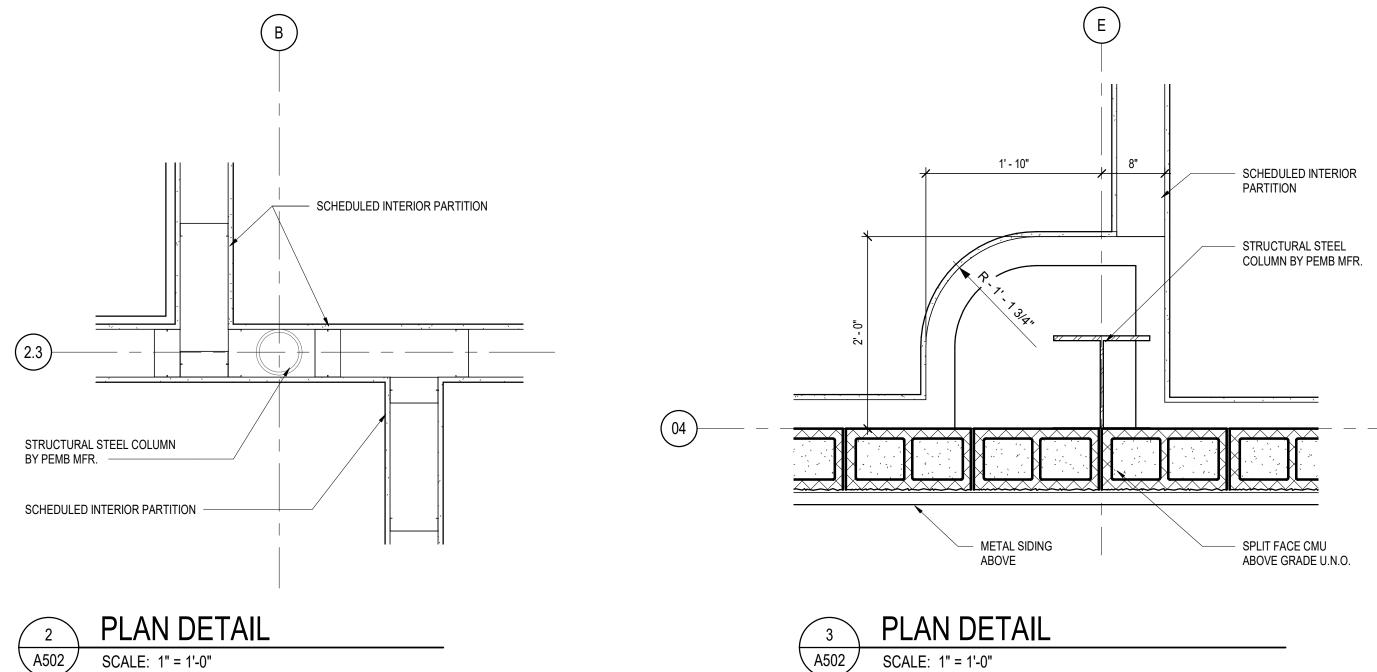

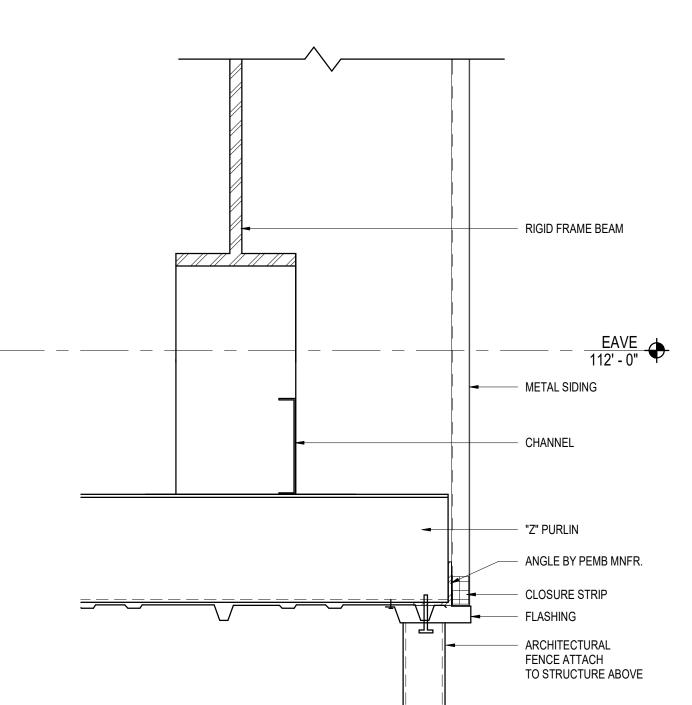

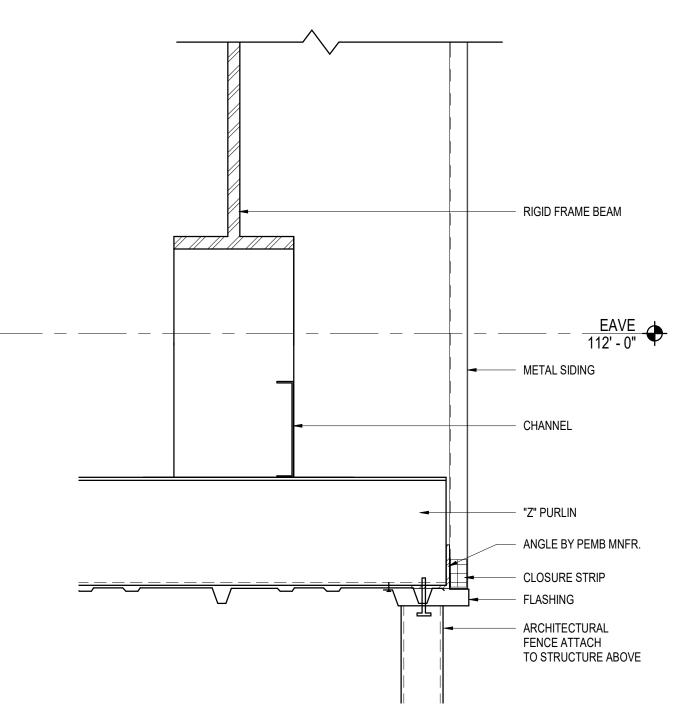



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DATE	ISSUED:	03/03/2020				
REVIEWED BY: Chec						
DRAWN BY: Aut						
DESIG	DESIGNED BY: Designer					
PROJI	PROJECT NUMBER:					

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SHEET TITLE

DETAILS

SHEET NUMBER

A502

BID DOCUMENTS

SCALE: 3" = 1'-0"

EXTERIOR WALL BASE DETAIL

\ A502 /

METAL STUD -

WALL FRAMING SEE WALL SCHEDULE

BATT INSULATION

SCALE: 3" = 1'-0"

STOREFRONT -

CONT. INT. CAULKING -

SCHEDULED FINISH FLOOR -

	DOOR SCHEDULE										
DOOR	DOOR DIMENSIONS DETAILS										
NO	ROOM NAME	WIDTH	HEIGHT	THCK.	DOOR TYPE	FRAME TYPE	HEAD	JAMB	SILL	FIRE RATING	COMMENTS
100A	PRE-PROCESSING AREA	6' - 0"	7' - 0"		GL-01	AL-1	1/A602	2&3/A602	4/A602		
100B	PRE-PROCESSING 100	6' - 2 1/2"	6' - 11 1/2"		GL-03	AL-2	1/A601	1/A601	2/A601		
101	UNISEX 101	3' - 0"	7' - 0"	0' - 1 3/4"	B-B	HM-1	3/A601	3/A601	4/A601		
102	JANITOR	2' - 6"	7' - 0"	0' - 1 3/4"	B-B	HM-1	3/A601	3/A601	4/A601		
103	PROCESSING AREA	6' - 0"	7' - 0"		GL-01	AL-1	1/A602	2&3/A602	4/A602		
104	AG LAB/ DIS ROOM 104	3' - 0"	7' - 0"	0' - 1 3/4"	B-B-01	HM-1	3/A601	3/A601	4/A601		
105A	CORRIDOR 105	3' - 0"	7' - 0"	0' - 1 3/4"	B-B-01	HM-3	3/A601	3/A601	4/A601	1H	
105B	CORRIDOR	3' - 0"	7' - 0"	0' - 1 3/4"	B-B-05	HM-4	7/A601	5/A601	8/A601		
105C	CORRIDOR 105	3' - 0"	7' - 0"	0' - 1 3/4"	B-B-01	HM-3	3/A601	3/A601	4/A601	1H	
106	INTERVIEW ROOM 106	3' - 0"	7' - 0"	0' - 1 3/4"	D	HM-2	3/A601	3/A601	4/A601		TYPE D- NO VISION PANEL
107	SEARCH ROOM 107	3' - 0"	7' - 0"	0' - 1 3/4"	B-B-03	HM-3	3/A601	3/A601	4/A601		
108	HOLD ROOM 108	3' - 0"	7' - 0"	0' - 1 3/4"	D	HM-3	3/A601	3/A601	4/A601		
109	CHASE 109	2' - 0"	7' - 0"	0' - 1 3/4"	B-B-01	HM-1	3/A601	3/A601	4/A601		
110A	CORRIDOR 110	3' - 0"	7' - 0"	0' - 1 3/4"	B-B-01	HM-1	3/A601	3/A601	4/A601		
110B	CORRIDOR	3' - 0"	7' - 0"	0' - 1 3/4"	B-B-05	HM-4	7/A601	5/A601	8/A601		
111A	SECURE STORAGE 111	3' - 0"	7' - 0"	0' - 1 3/4"	B-B-01	WS-1	3/A601	3/A601	4/A601		
111B	SECURE STORAGE 111	3' - 6"	10' - 0"		MSLG	-					ARCHITECTURAL METAL SLIDING GATE TO CLG.
112A	LAN/SLAN 112	3' - 0"	7' - 0"	0' - 1 3/4"	B-B-01	HM-1	3/A601	3/A601	4/A601		
112B	LAN/SLAN 112	3' - 6"	10' - 0"		MSLG	-					ARCHITECTURAL METAL SLIDING GATE TO CLG.
113A	ENTRANCE OFFICE 113	3' - 0"	7' - 0"	0' - 1 3/4"	B-B-04	HM-1	3/A601	3/A601	4/A601		
113B	PUBLIC LOBBY 114	3' - 0"	7' - 0"	0' - 1 3/4"	B-B-06	HM-1	3/A601	3/A601	4/A601		BULLET RESISTANT, DOOR TYPE LEVEL 3
114	PUBLIC LOBBY	6' - 0"	7' - 0"		GL-01	AL-1	1/A602	2&3/A602	4/A602		
115	GENERAL STORAGE 115	3' - 0"	7' - 0"	0' - 1 3/4"	A-A	HM-1	3/A601	3/A601	4/A601		
116	CONFERENCE ROOM 116	3' - 0"	7' - 0"	0' - 1 3/4"	A-A	HM-1	3/A601	3/A601	4/A601		
117	LOCKER ROOM 117	3' - 0"	7' - 0"	0' - 1 3/4"	B-B-01	HM-1	3/A601	3/A601	4/A601		
118	WOMEN'S RR 118	3' - 0"	7' - 0"	0' - 1 3/4"	B-B-01	HM-1	3/A601	3/A601	4/A601		
119	LOCKER ROOM 119	3' - 0"	7' - 0"	0' - 1 3/4"	B-B-01	HM-1	3/A601	3/A601	4/A601		
120	MEN'S RR 120	3' - 0"	7' - 0"	0' - 1 3/4"	B-B-01	HM-1	3/A601	3/A601	4/A601		
121	BREAK ROOM 121	3' - 0"	7' - 0"	0' - 1 3/4"	B-B-01	HM-1	3/A601	3/A601	4/A601		
123	SUPERVISOR OFFICE 123	3' - 0"	7' - 0"	0' - 1 3/4"	B-B-01	HM-1	3/A601	3/A601	4/A601		
124	LACTATION ROOM 124	3' - 0"	7' - 0"	0' - 1 3/4"	A-A	HM-1	3/A601	3/A601	4/A601		
125	ELECTRICAL	3' - 0"	7' - 0"	0' - 1 3/4"	B-B-05	HM-4	7/A601	5/A601	8/A601		
126	MECHANICAL	3' - 0"	7' - 0"	0' - 1 3/4"	B-B-05	HM-4	7/A601	5/A601	8/A601		

	DOOR FRAME TYPES
HM-1	INTERIOR, 12-GAUGE HOLLOW METAL, FULLY WELDED.
HM-2	INTERIOR, 12-GAUGE HOLLOW METAL, FULLY WELDED, WITH SIDELIGHT.
HM-3	DETENTION, 12-GAUGE, FULLY WELDED, GROUTED INTO CONCRETE MASONRY UNIT (CMU).
HM-3A	DETENTION, 3/32", FULLY WELDED, GROUTED INTO CMU.
HM-4	EXTERIOR, 12-GAUGE HOLLOW METAL, FULLY WELDED, GALVANIZED.
HM-5	HOLLOW METAL AS INCLUDED WITH PRE-FABRICATED BUILDING.
AL-1	EXTERIOR ALUMINUM STOREFRONT SYSTEM.
AL-2	INTERIOR ALUMINUM STOREFRONT SYSTEM.
SS-1	EXTERIOR, 12-GAUGE STAINLESS STEEL, FULLY WELDED.
W-1	WOOD FRAME.
WS-1	FORMED, REINFORCED AND WELDED STEEL.

- HOLLOW METAL FRAMES (HM-1, HM-2, HM-4, AND HM-5) SHALL COMPLY WITH ANSI A250.8/SDI 100. FRAMES SHALL BE LEVEL 2, 16-GAUGE, WITH CONTINUOUSLY WELDED CORNERS AND SEAMLESS FACE JOINTS, FACTORY PRIMED.
- STEEL FRAMES FOR DETENTION SUITE ROOMS (HM-3) SHALL BE 12-GAUGE STEEL AND GROUTED INTO THE SURROUNDING WALL/FRAMING.


GENERAL SHEET NOTES

- SEE ROOM DATA SHEETS IN APPENDIX A IN SPECIFICATION.
- 2. DOOR IN STC RATED WALLS SHALL MATCH THE WALL STC RATING. . ALL DOORS TO RECEIVE DOOR STOPS.


5 A601


- 4. FOR DOOR HARDAWARE INFORMATION SEE SPECIFICATION.
- 5. FOR ACCESS CONTROL INFORMATION AND LOCATION REFER TO SPECIFICATION.
- 6. PROVIDE CAULK / SEALANT ON BOTH SIDES OF FRAMES, TYPICAL FIELD VERIFY ALL CONDITIONS PRIOR TO ORDERING DOORS, HARDWARE, OR ACCESS CONTROLS,
- 8. NOTIFY ARCHITECT OF ANY DISCREPANCIES BETWEEN DOOR SCHEDULE AND PLAN
- 9. SET ALL THRESHOLDS IN EXTERIOR DOORS IN FULL BED OF SEALANT. 10. ALL EXTERIOR DOORS TO MEET WATER TIGHT CONDITION INCLUDING ALL WATERPROOF
- THRESHOLDS. BUMPER SEALS REQUIRED AT ALL EXTERIOR DOORS U.O.N.
- 11. COORDINATE ALL DOOR HARDWARE WITH ACCESS CONTROL AND FIRE ALARM SYSTEM AS REQUIRED. 12. INSTALL TILE THRESHOLD AT DOORS WHERE TILE IS THE FINISHED FLOOR SURFACE. SEE FINISH SCHEDULE.

	DOOR TYPES
A-A	WOOD, FULL FLUSH, SOLID CORE, FIVE LAYERS, 7' X 36" X 1¾" TYPICAL, NATURAL STAIN FINISH
B-B-01	HOLLOW METAL, FULL FLUSH, SEAMLESS, 7' X 36" X 1¾,"TYPICAL, 12 GA, PAINTED FINISH, LEVEL A, EXTRA HEAVY-DUTY.
B-B-02	HOLLOW METAL, FULL FLUSH, SEAMLESS, OVERSIZED, 80" X 42" X 1¾", 12 GA, PAINTED FINISH, LEVEL A, EXTRA HEAVY-DUTY.
B-B-03	HOLLOW METAL, FULL FLUSH, SEAMLESS, ACOUSTIC-RATED, 7' X 36" X 1¾" TYPICAL.
B-B-04	HOLLOW METAL, VISION LIGHT UNIT, SEAMLESS, ACOUSTIC-RATED, 7' X 36" X 13/4"
B-B-05	HOLLOW METAL, FULL FLUSH, SEAMLESS,THERMAL INSULATION U-FACTOR 0.41, 7' X 36" X 1¾"
B-B-06	HOLLOW METAL, FULL FLUSH, SEAMLESS, BULLET RESISTANT DOOR, DOOR TYPE LEVEL, 37' X 36" X 1¾"
D	DETENTION GRADE, 12-GAUGE HM, 2", FLUSH, SEAMLESS, 12" SQ. VISION PANEL, 180° OUTSWINGS, 7' X 36" X 2", VISION PANEL OF POLYCARBONATE LAMINATE, GLASS-CLAD POLYCARBONATE OR GLASS LAMINATE WITH A SLIDING COVER OVER VISION PANEL ON INGRESS SIDE.
D-03	DETENTION GRADE, 12-GAUGE HM, 1½", HALF-GLASS, SEAMLESS, 180° OUTSWINGS, 7' X 36" X 2", VISION PANEL OF POLYCARBONATE LAMINATE, GLASS-CLAD POLYCARBONATE OR GLASS LAMINATE.
GL-01	ALUMINUM STOREFRONT, FRAMED FULL HEIGHT LOW-E INSULATED GLASS, 36" MINIMUM WIDTH.
GL-02	ALUMINUM STOREFRONT, FRAMED PARTIAL HEIGHT, LOW-E INSULATED GLASS, 36" MINIMUM WIDTH.
GL-03	ALUMINUM STOREFRONT, FRAMELESS FULL HEIGHT GLASS, 36" MINIMUM WIDTH.
MSLG	METAL SLIDING GATE FOR MESH PARTITION, 42" MINIMUM WIDTH.
SL-01	SLIDING (INTEGRAL WITH INSPECTION BOOTH).
SS-01	STAINLESS STEEL, FULL FLUSH, SEAMLESS WITH 4" X 25" POLYCARBONATE VISION PANEL, 7' X 36" X 1¾" WITH 4" X 25" POLYCARBONATE VISION PANEL.
OH-1	COMMERCIAL GRADE OVERHEAD, 12' - 16' W X 16'H
V-1	VAULT: 12-GAUGE, HOLLOW METAL, FULL FLUSH, SEAMLESS, 7' X 36" X 1¾" TYPICAL.
FE-1	SD-STD-01.01, REVISION G (AMENDED) (OPAQUE) 5 MIN FE.

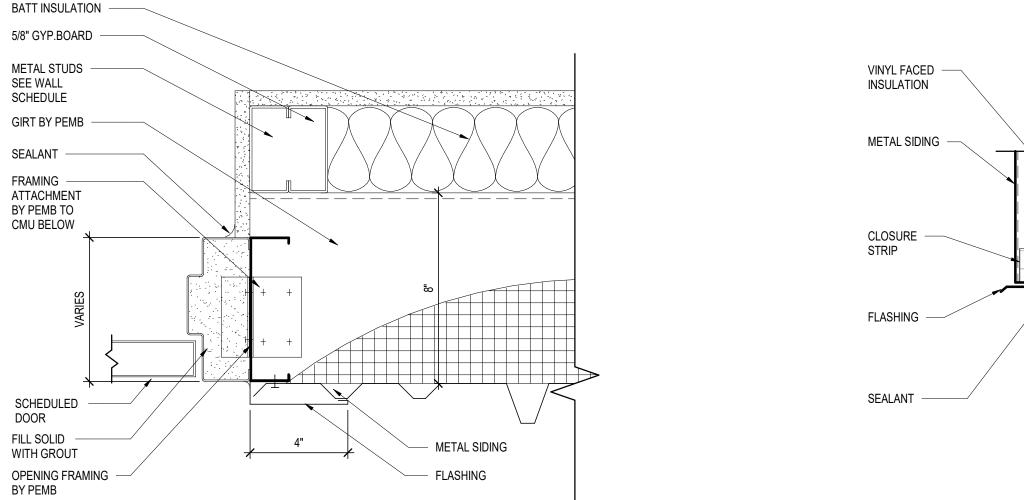





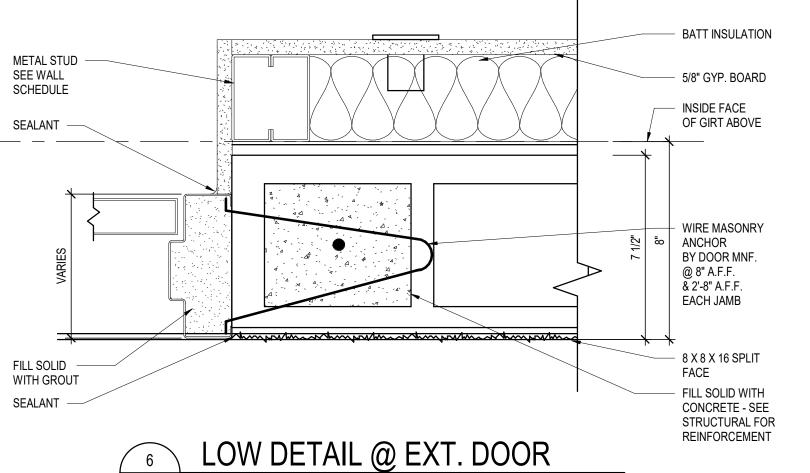

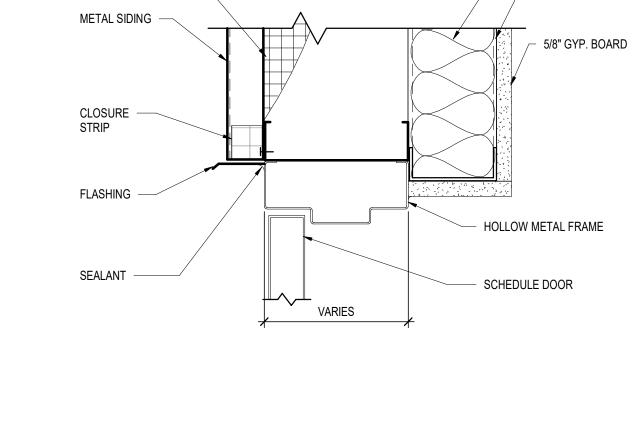



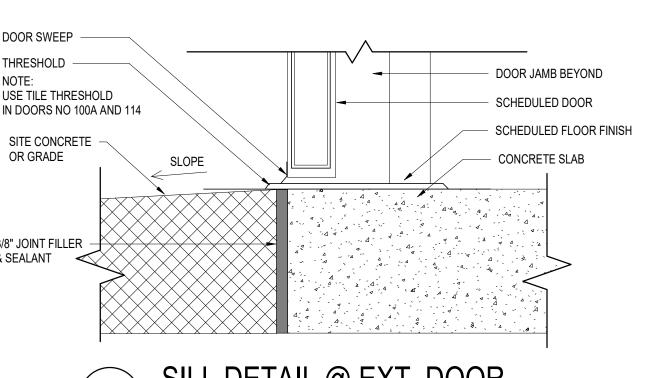

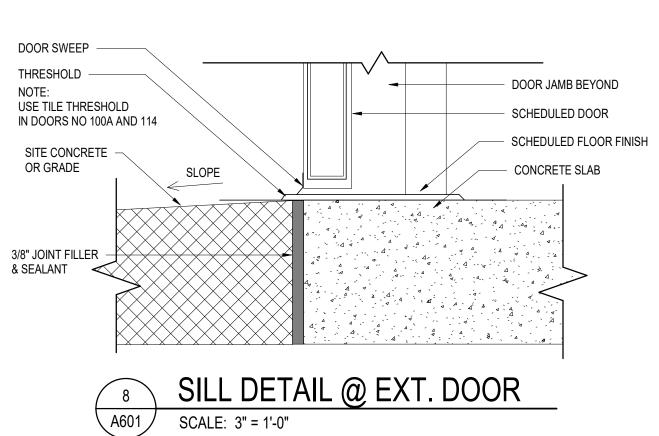

A601

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REVISIONS

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REVIEWED BY:

DESIGNED BY:

PROJECT NUMBER:

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SHEET TITLE

DOOR SCHEDULE,

DOOR TYPES &

NOTES

SHEET NUMBER


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03/03/2020


MWR

BATT INSULATION

METAL STUD WALL SEE WALL SCHEDULE



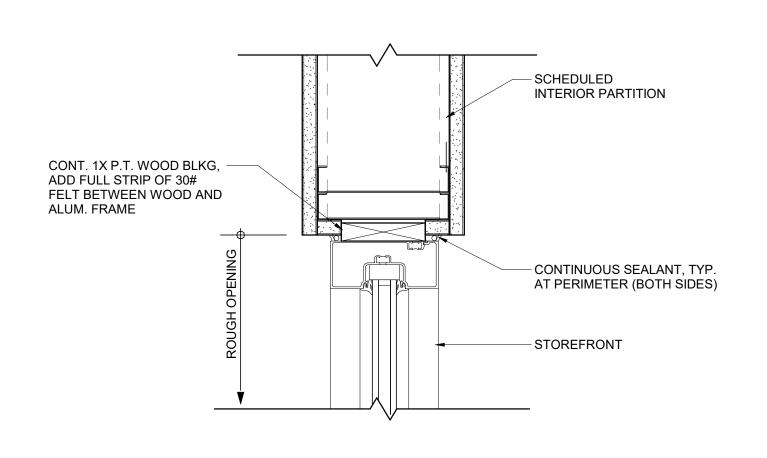

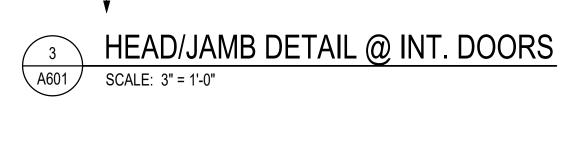

PARTITION

PER TYPE

VARIES


GWB PARTITION, PER

SEALANT EACH SIDE

METAL FRAMING

HOLLOW METAL FRAME

SCHEDULED DOOR

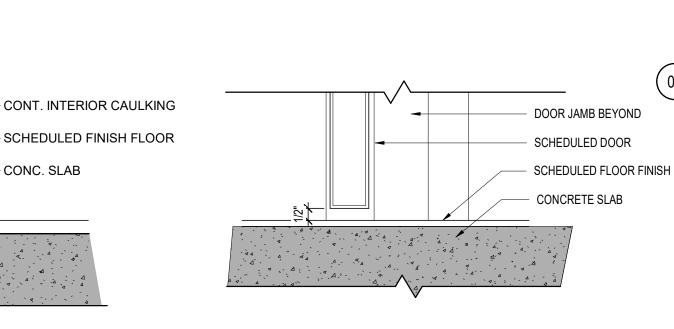

SILL DETAIL @ INT. DOOR

SILL DETAIL @ INT. STOREFRONT

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VINYL FACED

INSULATION

BATT INSULATION

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GENERAL SHEET NOTES

ALL EXTERIOR ALUMINUM STOREFRONT TO HAVE MINIMUM 2 1/2" X 5" MULLIONS. ALL GLAZING 1 5/16" W/ 1/4" TEMPERED/TINTED OUTSIDE LIGHT & 9/16" IMPACT RESISTANT LITE. LOW E COATING

ON #2 SURFACE.

2. DOOR GLAZING 9/16" IMPACT RESISTANT LITE (TINTED)

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PENSACOLA, FLORIDA

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03/03/2020 Checker Author

Designer PROJECT NUMBER: 201-0052-002

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SHEET TITLE

STOREFRONT ELEVATIONS AND DETAILS

SHEET NUMBER

A602

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3/4/2020 9:41:45 AM

	WALL TYPES
W-01	GYPSUM BOARD ON WOOD STUD, SOUND INSULATION.
W-02	GYPSUM BOARD ON METAL STUD, SOUND INSULATION.
W-03	GYPSUM BOARD ON #9 (10 GA) EXPANDED METAL MESH ON STUD, SOUND INSULATION.
W-04	GYPSUM BOARD ON METAL STUD, UNINSULATED.
W-05	GYPSUM BOARD 2X PANELS WITH #9 (10 GA) EXPANDED METAL MESH ON METAL STUD, SOUND INSULATION
W-06	FIBER REINFORCED BACKER BOARD ON METAL STUD, UNINSULATED.
W-07	CMU-4" MIN, FULLY GROUTED, LEVEL 3 BULLET-RESISTANT.
W-08	CMU-8"
W-09	CMU-8" - SECURE - VERTICAL REBAR AT 16" OC (EVERY BLOCK), FULLY GROUTED.
W-10	CMU-8" - TIED INTO MEDIUM SECURITY CEILING, PER SPPH.
W-11	GLAZED MASONRY UNITS.
W-12	[RESERVED].
W-13	INSULATED METAL PANELS WITH STEEL ROLL FRAMES, LEVEL 3 BULLET-RESISTANT.
W-14	CORRUGATED METAL WALLS ON METAL STUDS WITH INSULATION.
W-15	PRE-ENGINEERED, INSULATED METAL PANELS, PAINTED.
W-16	HOT DIPPED (HD) GALVANIZED CHAIN LINK 14' HIGH.
W-17	HD GALVANIZED CHAIN LINK 12' HIGH.
W-18	MATCH ADJACENT SPACE.
W-19	3/4" FIRE RESISTANT PAINTED PLYWOOD OVER #9 (10GA) EXPANDED METAL MESH ON METAL STUDS
W-20*	EXTERIOR WALL - 8" CMU WAINSCOT UP TO 40" HIGH WITH METAL WALL PANELS SUPPORTED BY WALL GIRTS WITH METAL STUD WITH GWB
W-21*	GYPSUM BOARD WITH LEVEL 3 BULLET RESISTANT PANEL ON METAL STUD; UL 752 B.O.D.

SOUND ISOLA	TION RATINGS - SEE ROOM DATA SHEETS FOR STC REQ.
NIC 40:	MINIMUM SOUND ISOLATION FOR PRIVATE OFFICES.
NIC 46:	MODERATE SOUND ISOLATION FOR PRIVATE OFFICES WITH CONFERENCE AREA.
NIC 50:	EXCELLENT SOUND ISOLATION FOR ALL CONFERENCE, TRAINING, AND MEETING SPACES
NIC 54:	SUPERIOR SOUND ISOLATION.
STC 45:	MINIMUM SOUND ISOLATION.
STC 50:	MODERATE SOUND ISOLATION. VERY LOUD SOUNDS CAN BE FAINTLY HEARD.
STC 55:	EXCELLENT SOUND ISOLATION.
STC 60:	SUPERIOR, MOST SOUNDS INAUDIBLE.

* PROJECT SPECIFIC WALL TYPE

	WALL FINISH TYPES
WF-01	GYPSUM BOARD, %" REGULAR, PAINTED.
WF-02	GYPSUM BOARD, %" HIGH IMPACT, PAINTED.
WF-03	GYPSUM BOARD, %" TYPE X, PAINTED.
WF-04	GYPSUM BOARD, %" MOISTURE RESISTANT, PAINTED.
WF-05	GYPSUM BOARD, %" REGULAR ON FURRING CHANNELS, PAINTED, FOR CMU SUBSTRATES.
WF-06	GYPSUM BOARD, %" REGULAR ON RESILIENT CHANNELS, PAINTED, FOR SOUND ISOLATION ASSEMBLIES ON STUD WALLS.
WF-07	CERAMIC TILE, FULL HEIGHT, INSTALL OVER FIBERGLASS MAT GYPSUM PANELS.
WF-08	CERAMIC TILE, PARTIAL HEIGHT. INSTALL OVER FIBERGLASS MAT GYPSUM PANELS.
WF-09	FIBER REINFORCED PLASTIC/POLYMER (FRP), FULL HEIGHT, INSTALL OVER GYPSUM BOARD.
WF-10	GLAZED MASONRY UNITS.
WF-11	PREFINISHED METAL PANELS.
WF-12	PAINT, FLAT.
WF-13	PAINT, SEMI-GLOSS.
WF-14	PAINT, GLOSS.
WF-15	PAINT, EPOXY, SEMI-GLOSS.
WF-16	FRT ¾" PLYWOOD ON FURRING CHANNELS, PAINTED.
WF-17	MATCH ADJACENT SPACE.

NOTE: CONTRACTOR TO INCLUDE THREE COLORS OF PAINT FOR WALLS COORDINATE LOCATIONS WITH ARCHITECT

	CEILING FINISH TYPES
CF-01	GYPSUM BOARD, 5/8" REGULAR, PAINTED.
CF-02	GYPSUM BOARD, 5/8" REGULAR, OVER #9 (10 GA) EXPANDED METAL MESH, PAINTED.
CF-03	ACOUSTIC CEILING TILE, SUSPENDED. STANDARD T-BAR SYSTEM.
CF-04	EXPOSED STRUCTURE, NO CEILING.
CF-05	EXPOSED STRUCTURE, SUSPENDED CEILING NOT PERMITTED.
CF-06	GYPSUM BOARD, 5/8" MOISTURE RESISTANT, OVER #9 (10 GA) EXPANDED METAL MESH, PAINTED.
CF-07	GYPSUM BOARD, 5/8" MOISTURE RESISTANT, PAINTED.
CF-08	8" CONCRETE WITH 5/8" REBAR AT 6" O.C, EACH WAY.
CF-09	EXPOSED STRUCTURE, EPOXY PAINT ON METAL DECK.
CF-10	PRE-ENGINEERED, EXPOSED STRUCTURE, PAINTED.
CF-11	PREFINISHED METAL PANELS.
CF-12	CEL-LINE / 24" WIDE PANELS / WHITE / CONCEALED FASTENERS
CF-13	HD GALVANIZED CHAIN LINK ROOF.
CF-14	MATCH ADJACENT SPACE.
CF-15	5/8" GYPSUM BOARD, OVER #9 (10 GA) EXPANDED METAL MESH, ADHERED ACOUSTIC TILE.
CF-16	5/8" GYPSUM BOARD; ACOUSTICAL TILE NOT PERMITTED
CF-17	SECURE, 1 H FIRE RATED ACOUSTICAL CEILING ASSEMBLY: 3 5/8" METAL STUDS WITH SOUND ATTENUATION BATTS WITH 5/8" TYPE X GWB OVER 1/4" GWB ON BOTH SIDES. 10 GA METAL MESH ON METAL STUD ON ROOM SIDE ONLY. STC -55, GA NO. WP 1015

	ROOM FINISH SCHEDULE													
								WALL	FINISH					
ROOM NO.	GAFDS ROOM NO.	ROOM NAME	BASE FINISH	FLOOR FINISH	WALL FINISH	STC WALL	N WALL	E WALL	S WALL	W WALL	CEILING HEIGHT	CEILING FINISH	STC CEILING	REMARKS
100	GAF-01-01	PRE-PROCESSING	BF-02	FF-08	WF-02		P3	P3	P1	P3	10' - 0"	CF-03		
101	GAF-01-04	UNISEX	BF-02	FF-08	WF-08/WF-07	STC45	P3	P3	P3	P3	10' - 0"	CF-02/P2	STC45	
102	N/A	JAN	BF-01	FF-04	WF-02		P3	P3	P3	P3	10' - 0"	CF-07/P2		
103	GAF-01-02	PROCESSING AREA	BF-01	FF-17	WF-01		P3	P3	P3	P3	10' - 0"	CF-03		
104	GAF-03-01	AG LAB/ DIS RM	BF-04	FF-10	WF-04	STC45	P3	P3	P3	P1	10' - 0"	CF-07/P2	STC45	
105	GAF-04-03	SECURE CORRIDOR	BF-04	FF-10	WF-02	STC55	P3	P3	P3	P3	10' - 0"	CF-17	STC55	
106	GAF-02-01	INTERVIEW ROOM	BF-04	FF-09	WF-15	STC55	P3	P3	P3	P3	10' - 0"	CF-17	STC55	INSTALLATION OF WIRE MESH MUST BE INSPECTED BY CBP PRIOR TO COVERING
107	GAF-02-02	SEARCH ROOM	BF-04	FF-10	WF-15	STC55	P3	P3	P3	P3	10' - 0"	CF-17	STC55	
108	GAF-02-03	HOLD RM	BF-04	FF-10	WF-15	STC55	P3	P3	P3	P1	10' - 0"	CF-17	STC55	INSTALLATION OF WIRE MESH MUST BE INSPECTED BY CBP PRIOR TO COVERING
109	N/A	CHASE	BF-04	FF-03	WF-15		P3	P3	P3	P3	10' - 0"	CF-17	STC55	
110	N/A	CORRIDOR	BF-04	FF-09	WF-01		P3	P3	P3	P3	10' - 0"	CF-03		
111	GAF-04-03	SECURE STORAGE	BF-04	FF-03	WF-13		P3	P3	P3	P3	10' - 0"	CF-02/P2		INSTALLATION OF WIRE MESH MUST BE INSPECTED BY CBP PRIOR TO COVERING
112	GAF-04-04/05	LAN/SLAN	BF-04	FF-17	WF-16	STC45	P3	P3	P3	P3	10' - 0"	CF-02/P2	STC45	
113	N/A	ENTRANCE OFFICE	BF-04	FF-09	WF-01		P1	P3	P1	P3	10' - 0"	CF-03		
114		PUBLIC LOBBY	BF-02	FF-08	WF-02		P1	P3	P1	P3	10' - 0"	CF-03		
115	GAF-04-06	GENERAL STORAGE/ FILE ROOM	BF-01	FF-09	WF-01		P3	P3	P3	P3	10' - 0"	CF-03		
116	N/A	CONFERENCE RM	BF-01	FF-09	WF-01		P1	P3	P3	P3	9' - 0"	CF-03		CEILING HEIGHT VARYS, SEE REFLECTED CEILING PLAN
117	GAF-04-10	LOCKER ROOM	BF-02	FF-08	WF-04		P3	P3	P3	P3	10' - 0"	CF-07/P2		
118	GAF-04-08	WOMEN'S RR	BF-02	FF-08	WF-08/WF-07		P3	P3	P3	P3	9' - 0"	CF-07/P2		CEILING HEIGHT VARYS, SEE REFLECTED CEILING PLAN
119	GAF-04-09	LOCKER ROOM	BF-02	FF-08	WF-04		P3	P3	P3	P3	10' - 0"	CF-07/P2		
120	GAF-04-08	MEN'S RR	BF-02	FF-08	WF-08/WF-07		P3	P3	P3	P3	9' - 0"	CF-07/P2		CEILING HEIGHT VARYS, SEE REFLECTED CEILING PLAN
121	GAF-04-07	BREAK ROOM	BF-01	FF-04	WF-01	STC45	P1	P3	P3	P3	10' - 0"	CF-03	STC45	
122	GAF-04-02	GENERAL OFFICE AREA	BF-01	FF-09	WF-01	STC45	P3	P3	P3	P1	10' - 0"	CF-03	STC45	
123	GAF-04-01	SUPERVISOR'S OFFICE	BF-01	FF-09	WF-01	STC45	P3	P3	P3	P1	10' - 0"	CF-03	STC45	
124	GAF-04-11	LACTATION ROOM	BF-01	FF-04	WF-13		P3	P3	P3	P1	10' - 0"	CF-03		
125	N/A	ELECTRICAL	BF-01	FF-03	WF-04		P3	P3	P3	P3	10' - 0"	CF-09		
126	N/A	MECHANICAL ROOM	BF-01	FF-03	WF-04		P3	P3	P3	P3	10' - 0"	CF-09		

NOTE: FOR MORE INFORMATION SEE NOTE NO 23

FINI	FINISH LEGEND AND COLOR SCHEDULE							
LABEL	DESCRIPTION	TYPE	MANUFACTURER	PROD. NAME/ COLOR/ FINISH/ SIZE/ INSTALL	REMARKS			
FF-09	CARPET TILE	1	MILLIKEN	CONSEQUENCE 2.0, SEQUIL, SEQ48-108, SIDE				
FF-13	WALK OFF MATT	1	MILLIKEN	OBEX, CUT, FIZZ, MOCHA				
Т	WALL TILE	1	CROSSVILLE	RETRO ACTIVE 2.0, EMPRESS WHITE UPS; FIELD TILE, COVE BASE	ALIGN JOINTS			
		2	CROSSVILLE	RETRO ACTIVE 2.0, EMPRESS WHITE PO; FIELD TILE	ACCENT TILE, ALIGN JOINTS			
FF-08	FLOOR TILE	3	CROSSVILLE	ALASKA, ICE UNPOLISHED	ALIGN JOINTS			
TS	TRANSITION STRIP	1	SCHLUTER	STAINLESS STEEL, SATIN FINISH , SIZED TO FIT	CARPET TO TILE TRANSITIONS			
		2	SCHLUTER	STAINLESS STEEL, SATIN FINISH , SIZED TO FIT	CARPET TO VCT TRANSITIONS			
		3	SCHLUTER	STAINLESS STEEL, SATIN FINISH , SIZED TO FIT	CARPET TO EPOXY FLOOR TRANSITIONS			
G	GROUT	1	CUSTOM BUILDING PRODUCTS	CEG-LITE EPOXY, 10 ANTIQUE WHITE				
FF-10	EPOXY FLOORING	1	DUR-A-FLEX, INC.	DURACHIP – OCEAN, SMALL CHIP				
FF-04	VINYL COMPOSITION TILE	1	ARMSTRONG	STANDARD EXCELON MULTI-COLOR / 52513 CIRQUE WHITE / 12"X12"				
PL	PLASTIC LAMINATE	1	WILSONART	DEC METAL L6445(408) RIBBONED SATIN BRUSHED PALADIUM				
		2	WILSONART	MUSHROOM 5013K-19				
			WILSONART	NIGHTFALL 5023K-19				
SSF	SOLID SURFACE	1	CORIAN	ARTIC ICE				
		2	CORIAN	EVENING PRIMA				
BF-01	VINYL WALL BASE	1	JOHNSONITE	CEMENT 121, 4" HIGH				
BF-02	TILE	3	CROSSVILLE	ALASKA, ICE UNPOLISHED	TILE COVE BASE			
CMU	CONCRETE BLOCK	1	8X8X16	SPLIT FACE CMU, COLOR T.B.D.				
Р	PAINT	1	SHERWIN WILLIAMS	SMOKEY BLUE SW 7604	ACCENT WALL			
		2	SHERWIN WILLIAMS	EXTRA WHITE SW 7006	CEILING			
		3	SHERWIN WILLIAMS	TOQUE WHITE SW 7003	WALLS, STL DR, STL DR FRM			
ACT	ACOUSTIC CEILING TILE			ARTIC / SQUARE TEGULAR NARROW / 2X2 / 9/16" GRID, WHITE				
MP	METAL PANEL	1	T.B.D.	T.B.D				
GWB	GYPSUM WALL BOARD	1		1/2"	USE MOISTURE RESISTANT "MR" GWB WHEN NOTED ON FINISH SCHEDULE			
		2 1/2" ON 9 GA DIAMOND MESH		1/2" ON 9 GA DIAMOND MESH	USE MOISTURE RESISTANT "MR" GWB WHEN NOTED ON FINISH SCHEDULE			
FF-17	RUBBER TILE	11	ROPPE	STATDEFEND, 702 ELECTRON BEIGE	ANTISTATIC RUBBER TILE			
		2	ROPPE	STATPROTECT, 751 HAZE GREY	ANTISTATIC RUBBER TILE			
SC	SEALED CONCRETE							
		•		•	·			

FF-01	FLOOR FINISH TYPES CONCRETE, TROWELED, BROOM FINISH, EXPOSED EXTERIOR AND INTERIOR UTILITY SPACES.
FF-02	CONCRETE, TROWELED, UNIFORM TEXTURE AND APPEARANCE, PREPARED TO RECEIVE OTHER FINISHES.
FF-03	CONCRETE, TROWELED, UNIFORM TEXTURE AND APPEARANCE, SEALED, EXPOSED AT INTERIOR SPACES.
FF-04	VINYL COMPOSITION TILE (VCT) OR RUBBER TILE.
FF-05	VCT, DISSIPATIVE.
FF-06	ATHLETIC RESILIENT.
FF-07	CERAMIC TILE.
FF-08	PORCELAIN TILE.
FF-09	CARPET TILE.
FF-10	CONCRETE WITH SEAMLESS EPOXY-RESIN NON-SLIP FLOORING SYSTEM, SLOPE-TO-FLOOR DRAIN, INSTALLED TO COMPLY WITH MANUFACTURER'S REQUIREMENTS SPECIFICATIONS.
FF-10A	CONCRETE, W/ SEAMLESS EPOXY-RESIN NON-SLIP FLOORING SYSTEM, INSTALLED TO COMPLY WITH MANUFACTURER'S REQUIREMENTS SPECIFICATIO
FF-11	CONCRETE, COLORED OR STAINED WITH SEALER, TROWELED, UNIFORM TEXTURE AND APPEARANCE.
FF-12	CONCRETE, SEALED 8", WITH %" REINFORCING BARS 6" OC EACH WAY.
FF-13	[RESERVED].
FF-14	RUBBER MAT (ANTI-FATIGUE).
FF-15	MATCH ADJACENT SPACE (AT EXISTING CONDITIONS).
FF-16	RAISED FLOOR WITH ANTI-STATIC VCT.
FF-17	ANTI-STATIC VCT.

	WALL BASE TYPES						
BF-01	RUBBER BASE, 4" HIGH.						
BF-02	CERAMIC TILE BASE 4" HIGH (MIN).						
BF-03	WOOD BASE.						
BF-04	INTEGRAL WITH SEAMLESS FLOORING, 8" HIGH.						
BF-05	[RESERVED].						
BF-06	[RESERVED].						
BF-07	MATCH ADJACENT SPACE (AT EXISTING CONDITIONS).						

FOR MORE INFORMATION SEE ROOM DATA SHEETS IN APPENDIX A IN SPECIFICATION.

GENERAL SHEET NOTES & SCHEDULE REMARKS

- MANUFACTURER AND PRODUCT NAMES ARE "BASIS OF DESIGN". 12. PROVIDE REQUIRED BRACING AND BLOCKING AT ALL WALL HUNG REFER TO SPECS FOR ADDITIONAL APPROVED MANUFACTURERS AND ALLOWABLE SUBSTITUTIONS.
- 2. SEE INTERIOR FINISH PLANS AND ELEVATIONS FOR
- CLARIFICATION ON LIMITS AND LOCATIONS OF FINISHES.
- 3. ALL INTERIOR FINISHES ARE TO BE IN COMPLIANCE WITH ALL CODES, NATIONAL AND LOCAL.
- 4. ALL FINISHES ARE TO BE INSTALLED IN ACCORDANCE WITH MANUFACTURER'S SPECIFICATIONS.
- 5. ALL FLOORING FINISH CHANGES TO OCCUR AT CENTER LINE OF CLOSED DOOR UNO
- 6. ALL COVER PLATES FOR JUNCTION BOXES TO BE STAINLESS
- CONTRACTOR TO PROVIDE AND INSTALL CORNER GUARDS ON

ALL OUTSIDE CORNERS. PROVIDE FULL HEIGHT SS CORNER

- GUARDS ON ALL EXTERIOR CORNERS IN PUBLIC AREAS. 8. FLOOR CONDITIONS ARE TO BE INSPECTED PRIOR TO ORDERING FLOOR FINISH MATERIALS, AND THEN AGAIN PRIOR TO THEIR INSTALLATION. ALL IMPERFECTIONS ARE TO BE PATCHED PRIOR
- TO INSTALLATION OF FLOOR FINISHES. 9. VARIATIONS IN FLOOR LEVEL IN EXCESS OF 1/2" FOR EVERY 10'-0" SHALL BE LEVELED.
- 10. ALL CABINET PULLS TO BE HAEFLE STAINLESS STEEL HANDLES, SIZE: 3 3/4" CATALOG NO. 117.05.600
- 11. ALL GROMMETS TO BE DOUG MOCKETT EDP SERIES, FINISHES TO BE SELECTED FROM SHOP DRAWINGS FOR APPROVAL

- CABINETRY COUNTERS AND FIXTURES.
- 13. ALL TILE GROUT JOINTS TO BE 1/8"
- 14. INSTALL PREFORMED INSIDE AND OUTSIDE VINYL WALL BASE.
- 15. INSPECT DRYWALL AND VERIFY THAT CONDITIONS ARE SUITABLE FOR THE APPLICATION OF PAINT OR WALL COVERINGS PRIOR TO
- 16. TRIM PAINT TO BE SEMI-GLOSS FINISH, WALL PAINT TO BE EGGSHELL FINISH, CEILING TO BE FLAT FINISH.

17. ALL MISCELLANEOUS GRILLS, DIFFUSERS, AND FIRE

- EXTINGUISHER CABINETS COLOR TO BE SELECTED BY ARCHITECT FROM FULL RANGE OF SAMPLES.
- 18. ALL HOLLOW METAL DOOR FRAMES TO BE PAINTED SEMIGLOSSS FINISH TO MATCH ADJACENT WALLS COLOR.
- 19. SCRIBE ALL COUNTERS TO WALL. CAULK TO MATCH COUNTER
- 20. LEAD TIMES FOR ALL MANUFACTURERS SHOULD BE CHECKED AT RECEIPT OF CONSTRUCTION DRAWINGS SO THAT ITEMS CAN BE ORDERED IN APPROPRIATE TIME FRAME FOR SHIPPING AND RECEIVING PRIOR TO SCHEDULED INSTALL DATE.
- 21. ALL INTERIOR FLOOR FINISH AND FLOOR COVERING MATERIAL SHALL COMPLY WITH NCBC SECTION 804 FOR CLASSIFICATION AND TESTING IDENTIFIED IN NFPA 253.
- 22. SEE ROOM FINISH SCHEDULE FOR STC RATING.
- 23. EXTEND ALL INTERIOR PARTITIONS 6" ABOVE SCHEDULE CEILING
- 24. EXTEND ALL PERIMETER WALLS TO ROOF DECK.

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REV	ISIONS ROGRESS DRAWINGS DESCRIPTION	
NO.	DESCRIPTION	DATE
		11/19/19
		11/10/10

DATE ISSUED: 03/03/2020 REVIEWED BY: DRAWN BY: MWR **DESIGNED BY:** PROJECT NUMBER:


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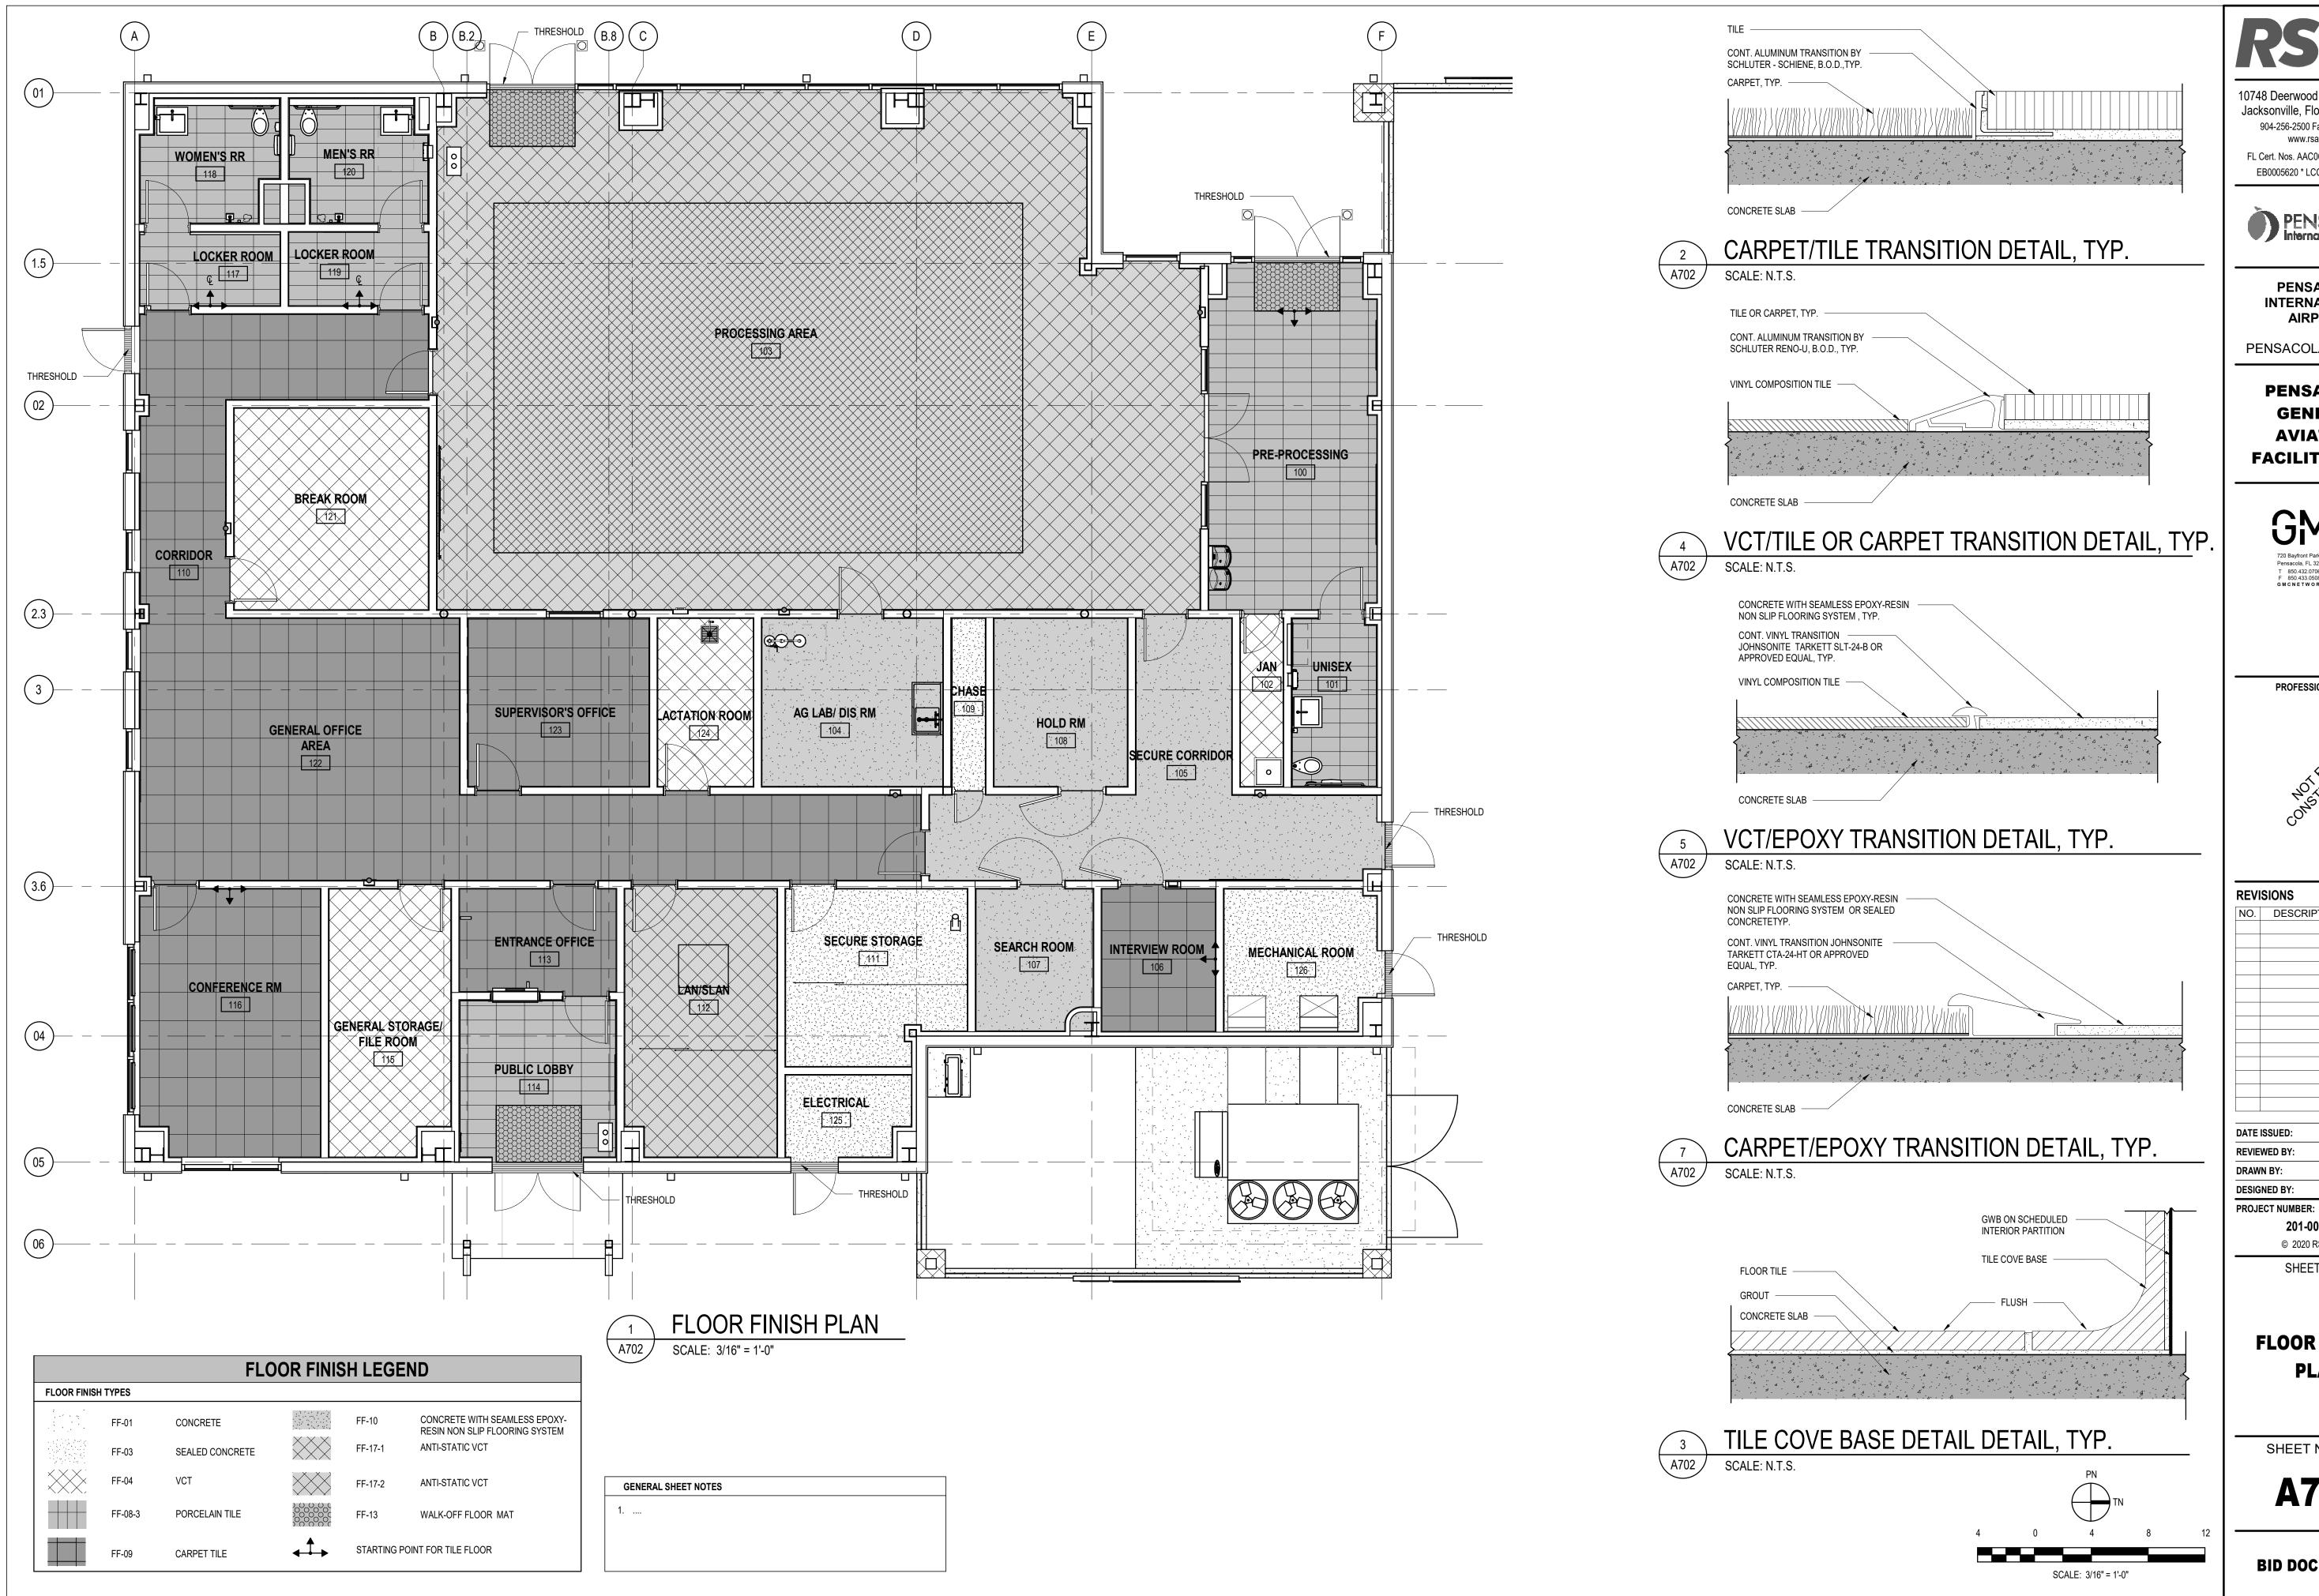
SHEET TITLE

ROOM FINISH SCHEDULE, **LEGEND & NOTES**

SHEET NUMBER

A701



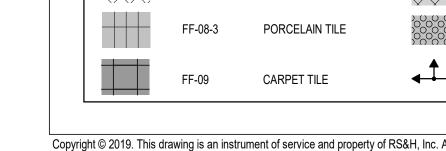

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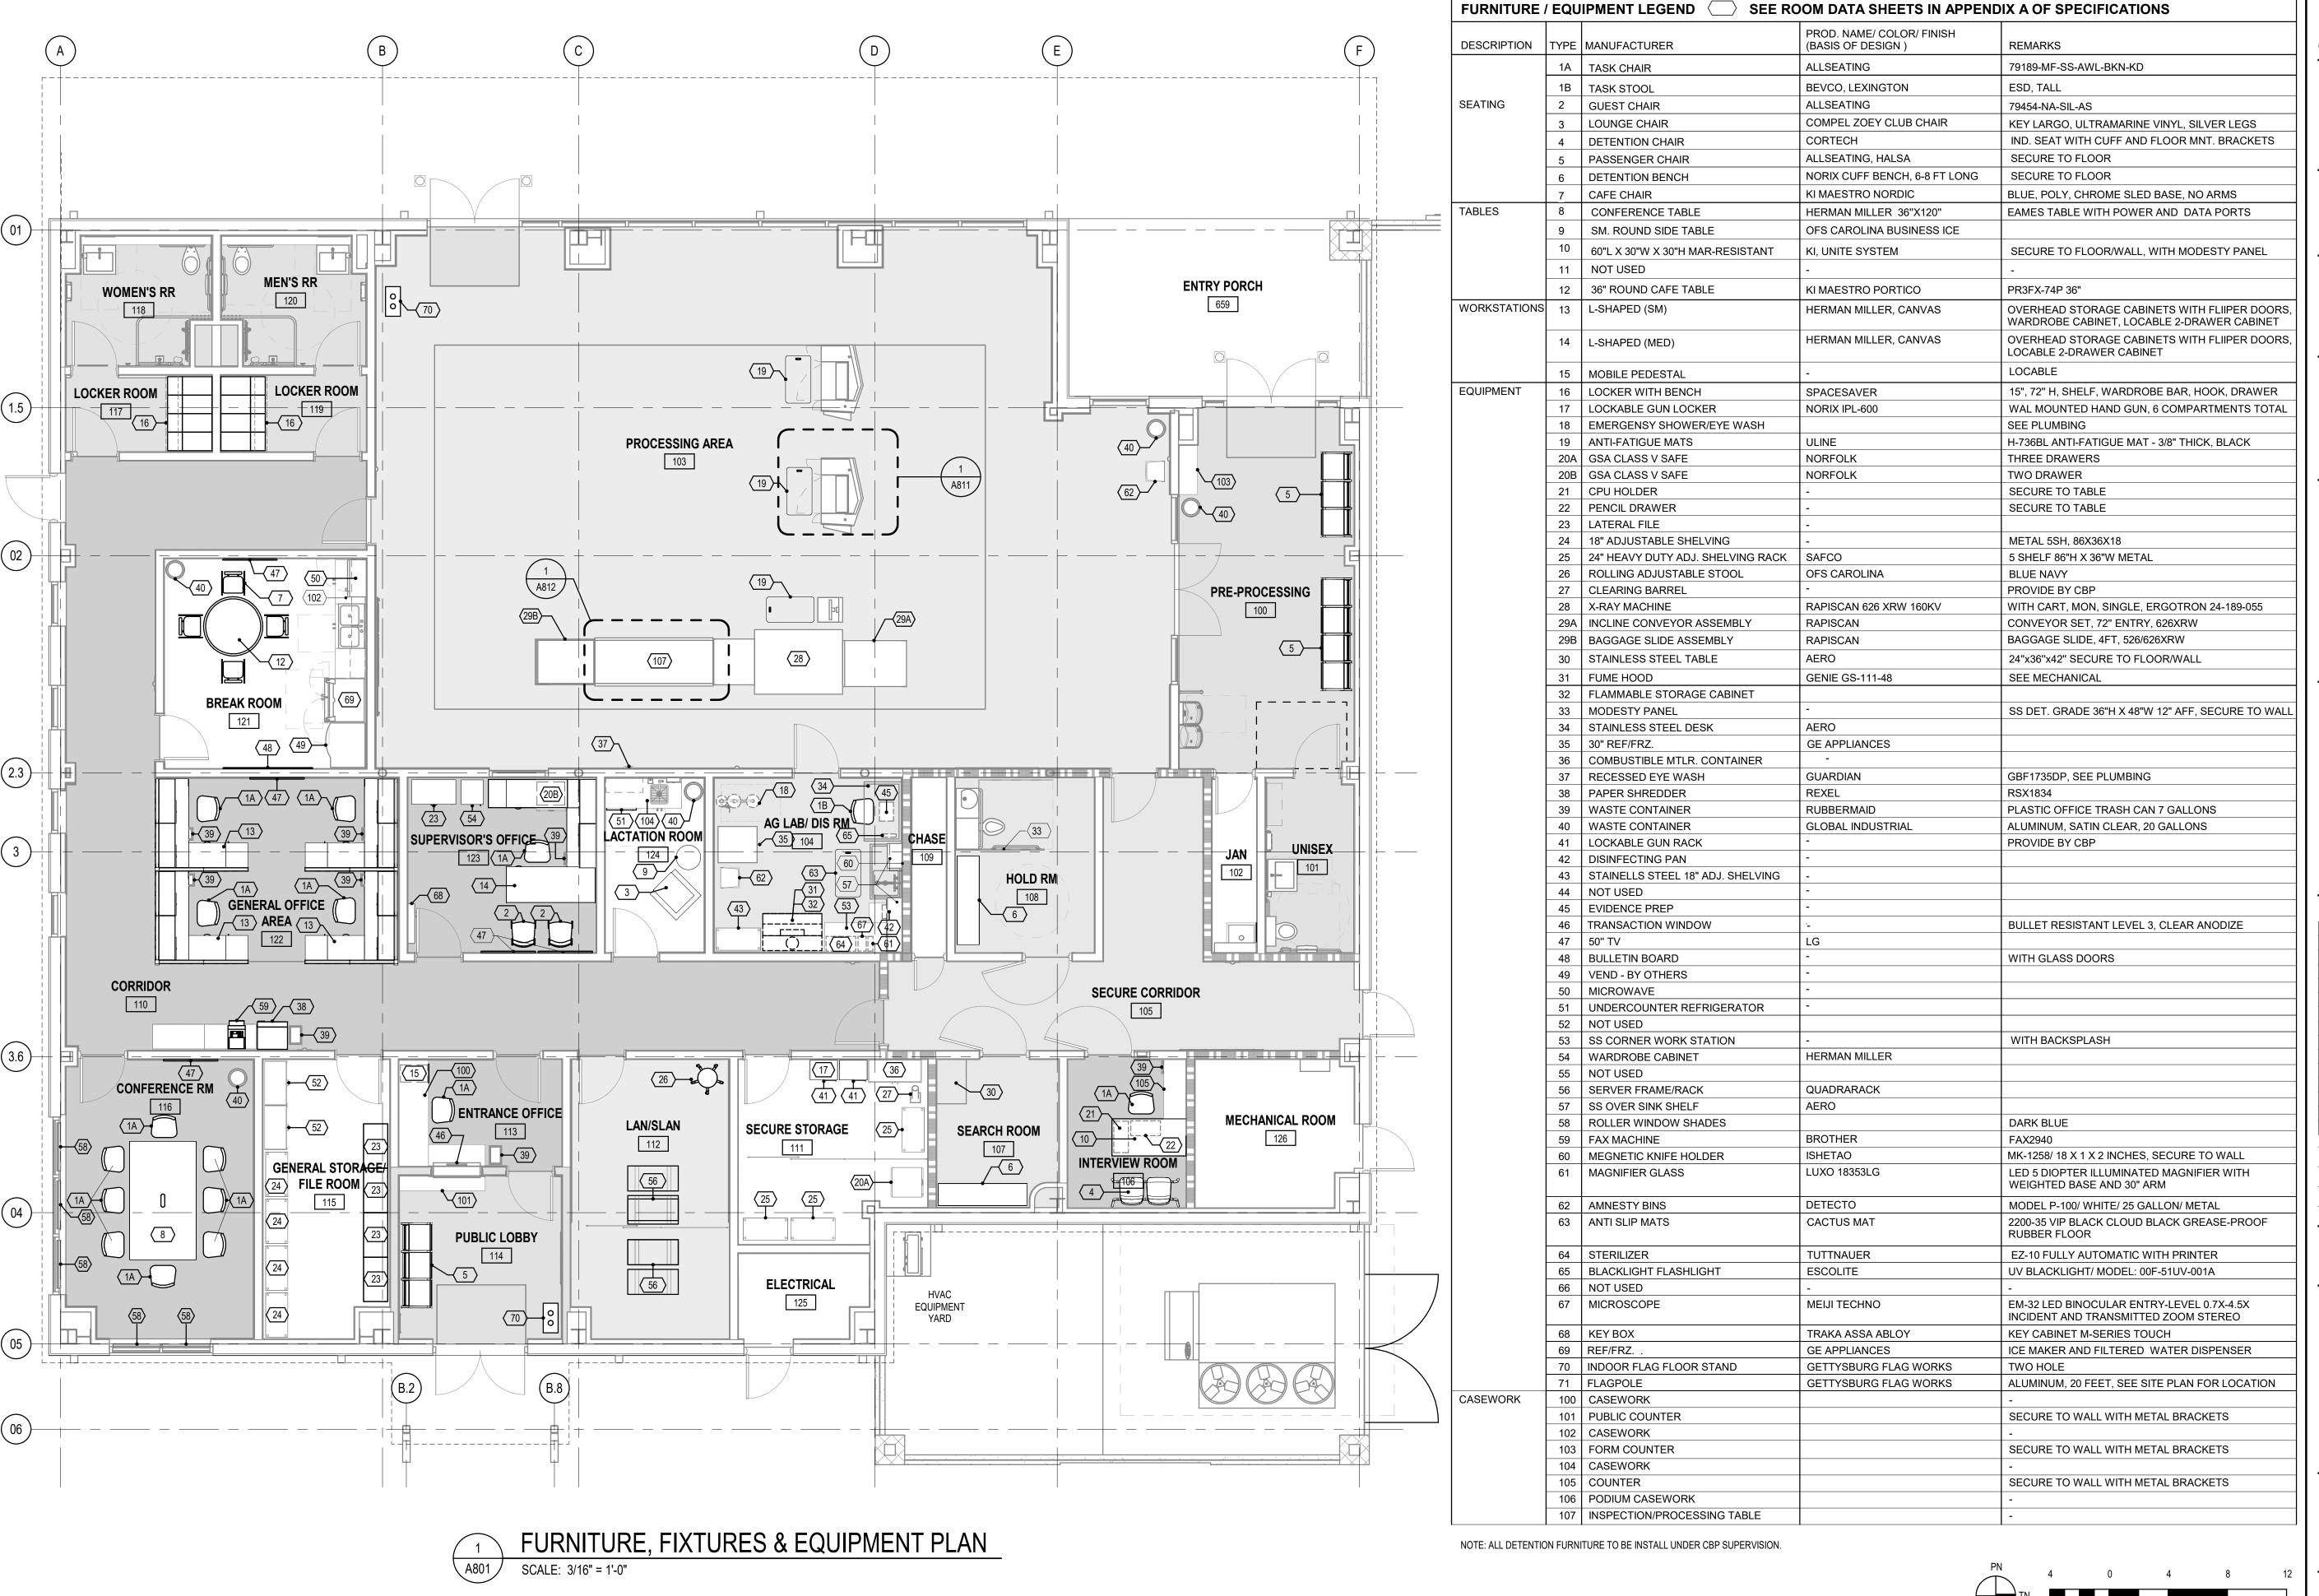
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SHEET TITLE

FLOOR FINISH PLAN

SHEET NUMBER

A702



SCALE: 3/16" = 1'-0"

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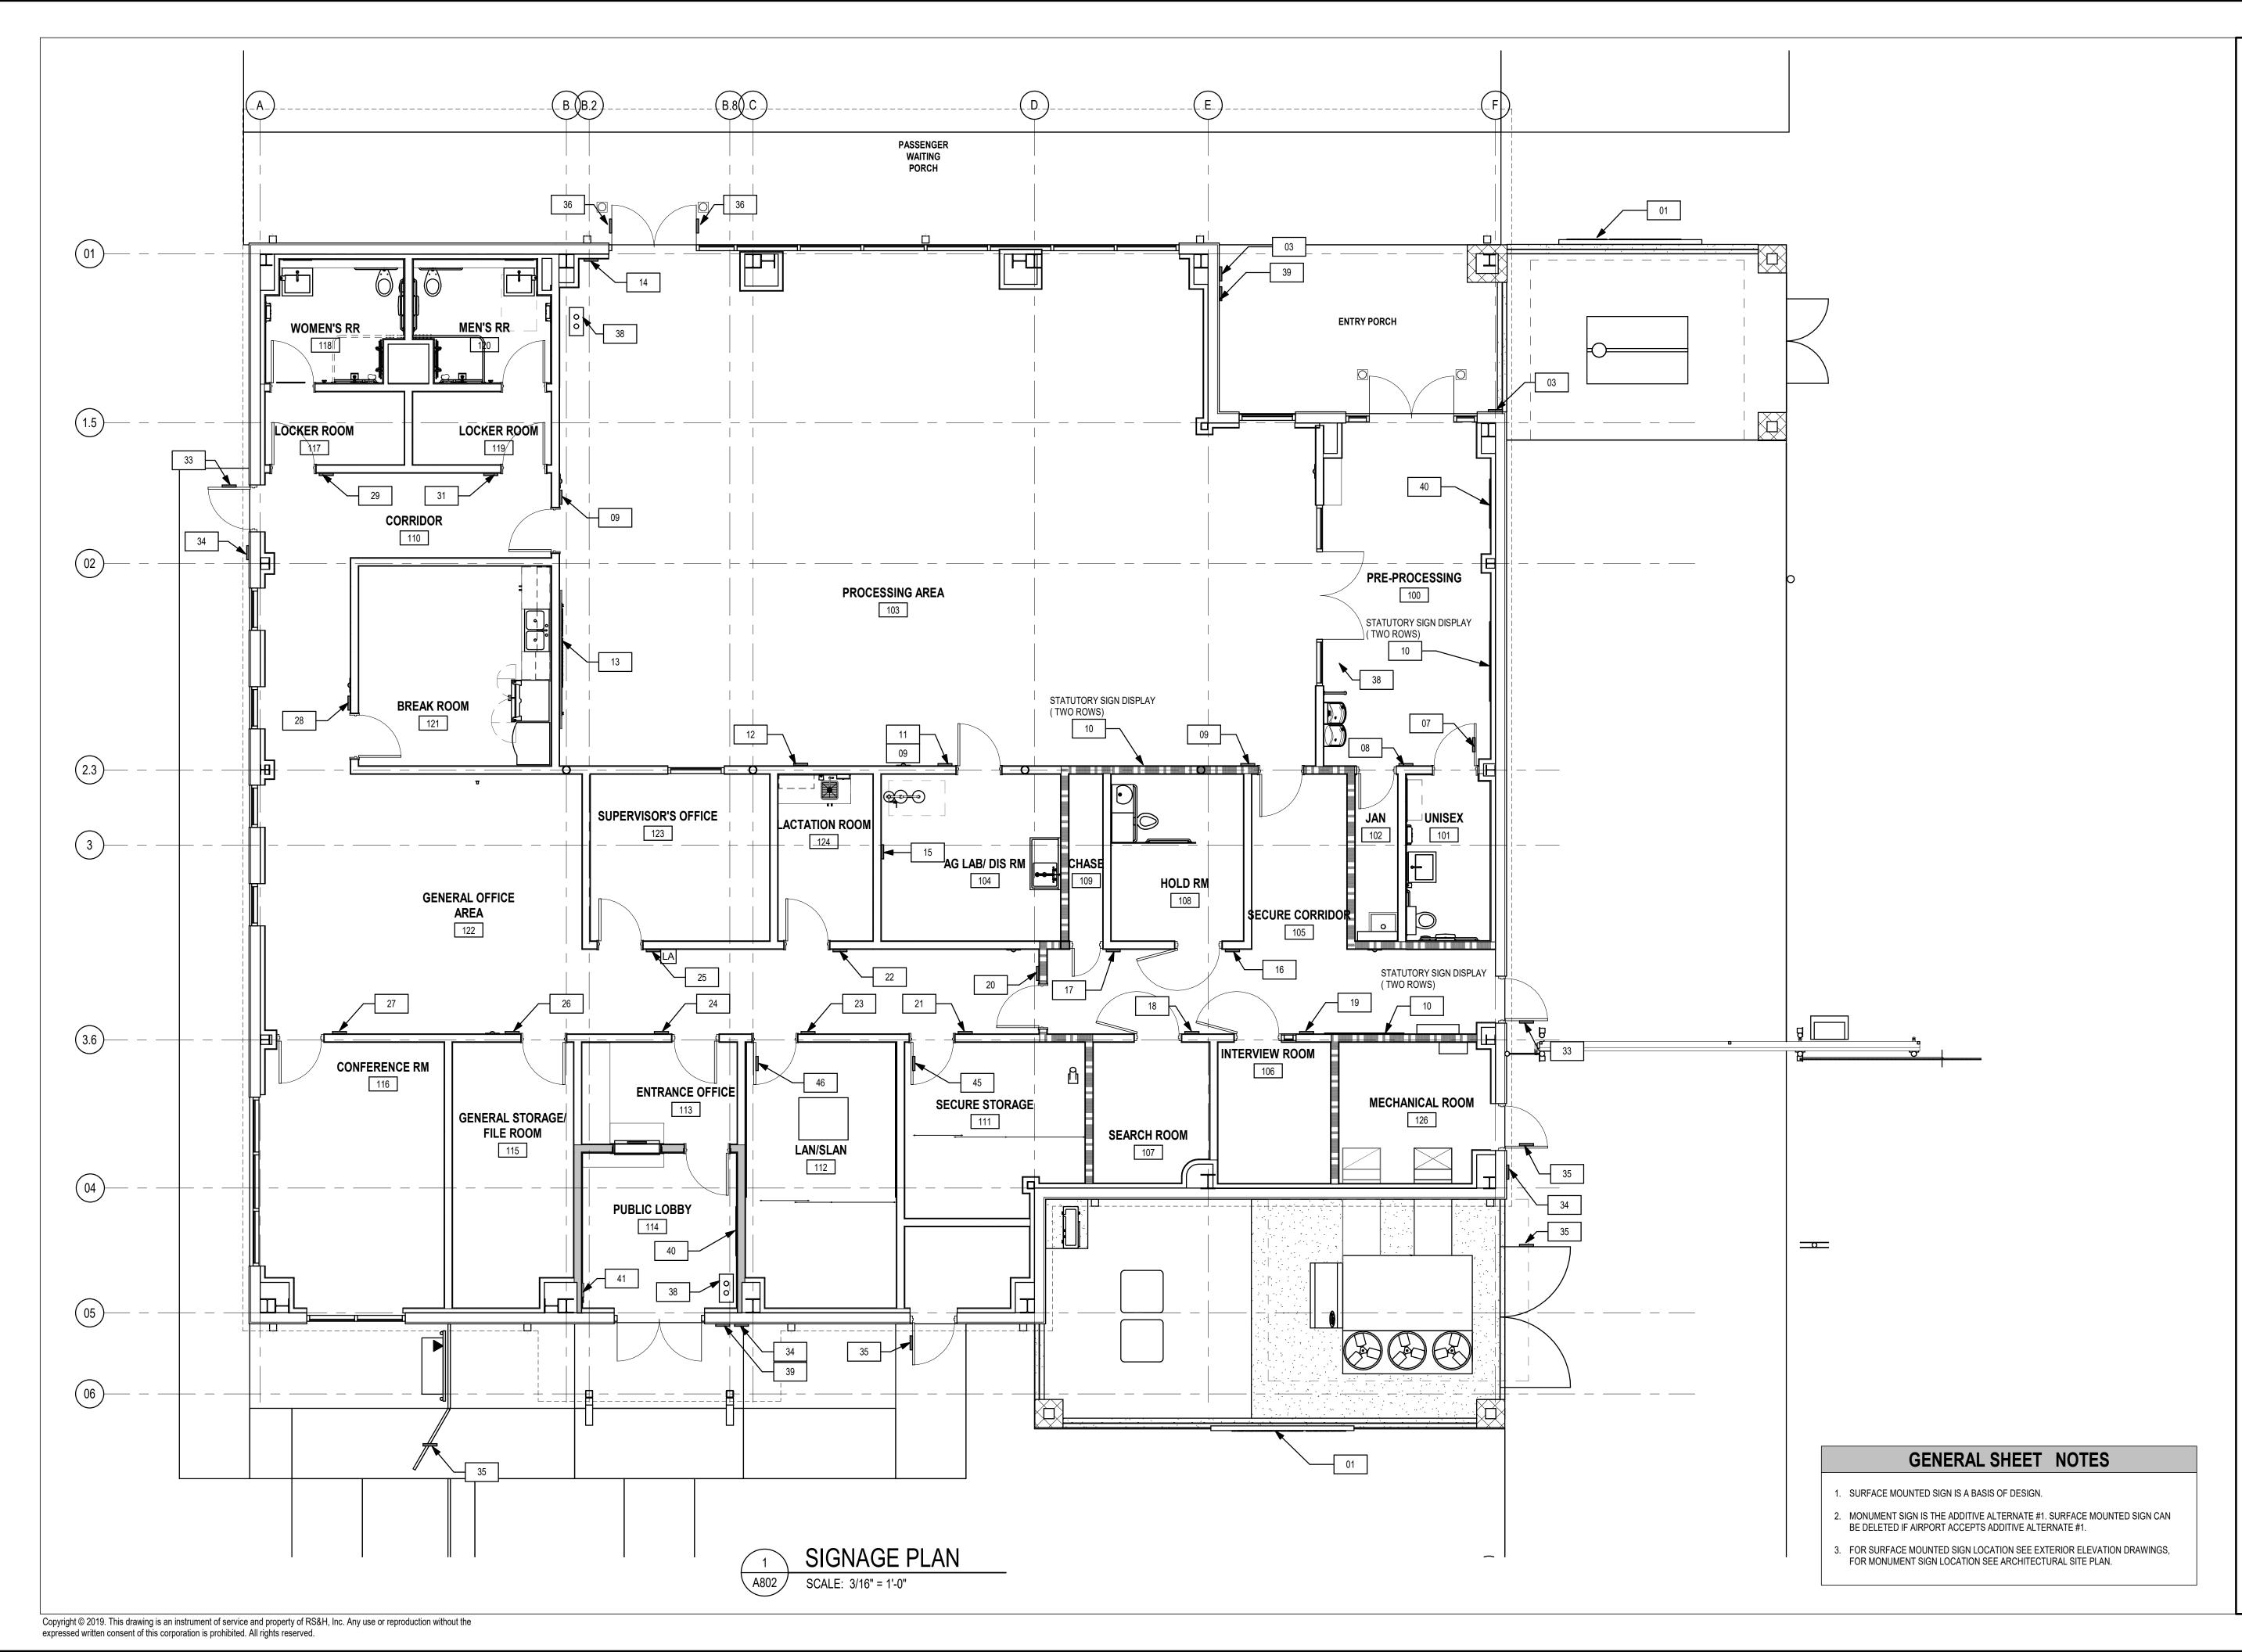
MWR

SHEET TITLE

FURNITURE, FIXTURES & **EQUIPMENT PLAN**

SHEET NUMBER

A801



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03/03/2020 DATE ISSUED:

Checker

Author

DRAWN BY: **DESIGNED BY:** Designer PROJECT NUMBER:

REVIEWED BY:

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SHEET TITLE


SIGNAGE PLAN

SHEET NUMBER

A802

				<u>SIGNAGE</u>	
ITEM	TYPE	LOCATION	QUANTITY	MESSAGE	REMARKS
0.1	El 0004	CITE CIONACE (CEE ADCLUTECTUDAL CITE	0	U.S. CUSTOMS AND BORDER PROTECTION, PENSACOLA, FLORIDA + SEAL	MESSAGE TO BE VERIEIED BY CRD
01	FI-0001	SITE SIGNAGE (SEE ARCHITECTURAL SITE PLAN)	2	U.S. CUSTOMS AND BORDER PROTECTION, PENSACOLA, FLORIDA + SEAL	MESSAGE TO BE VERIFIED BY CBP
02	NOT USED	,			
03	SS-160	EXTERIOR BY THE ENTRY DOORS	2	NO SMOKING	MESSAGE TO BE VERIFIED BY CBP
04	FI-004	NOT USED	0	PENSACOLA, FLORIDA + CBP SEAL AND SIGNATURE	
05	FI-002	EXTERIOR	1	U.S. CUSTOMS AND BORDER PROTECTION, PENSACOLA, FLORIDA + SEAL	MESSAGE TO BE VERIFIED BY CBP
06	FI-002	NOT USED	0	U.S. CUSTOMS AND BORDER PROTECTION, PENSACOLA, FLORIDA + SEAL	MESSAGE TO BE VERIFIED BY CBP
07	RI-006	RESTROOM 101	1	RESTROOM + MEN AND WOMEN PICTOGRAM (BRAILLE)	MESSAGE TO BE VERIFIED BY CBP
80	RI-002	JANITOR 102	1	ROOM # 102 (BRAILLE)	MESSAGE TO BE VERIFIED BY CBP
09	NS-003	PROCESSING AREA 103	3	AUTHORIZED PERSONEL ONLY + CBP SEAL AND SIGNATURE	PROVIDED BY CBP
10	SS DISPLAY	PROCESSING AREA 103	1	INSERTS PROVIDED BY CBP	STATUTORY PROVIDED BY CBP, SEE DETAIL 9/A804
11	RI-002	AG LAB/DIS ROOM 104	1	ROOM # 104 (BRAILLE)	MESSAGE TO BE VERIFIED BY CBP
12	OS-002	PROCESSING AREA 103	1	EMERGENCY EYE WASH	MESSAGE TO BE VERIFIED BY CBP
13	FI-002	PROCESSING AREA 103	1	U.S. CUSTOMS AND BORDER PROTECTION, PENSACOLA, FLORIDA + SEAL	MESSAGE TO BE VERIFIED BY CBP, SEE DETAIL 1/A803
14	WF-124	PROCESSING AREA 103	1	EXIT (BRAILLE)	MESSAGE TO BE VERIFIED BY CBP
15	OS-001	AG LAB/DIS ROOM 104	1	EMERGENCY SHOWER	MESSAGE TO BE VERIFIED BY CBP
16	RI-001	HOLD ROOM 108	1	ROOM # 108 HOLD (BRAILLE)	MESSAGE TO BE VERIFIED BY CBP
17	RI-002	CHASE 109	1	ROOM # 109	MESSAGE TO BE VERIFIED BY CBP
18	RI-001	SEARCH ROOM 107	1	ROOM # 107 SEARCH (BRAILLE)	MESSAGE TO BE VERIFIED BY CBP
19	RI-001	INTERVIEW ROOM 106	1	ROOM # 106 INTERVIEW (BRAILLE)	MESSAGE TO BE VERIFIED BY CBP
20	NS-005	CORRIDOR 110	1	AUTHORIZED PERSONEL ONLY + CBP SEAL AND SIGNATURE	PROVIDED BY CBP
21	RI-001/NS-003	SECURE STORAGE 111	1	ROOM # 111 (BRAILLE)	MESSAGE TO BE VERIFIED BY CBP
22	RI-001	LACTATION ROOM 124	1	ROOM # 124 LACTATION ROOM (BRAILLE)	MESSAGE TO BE VERIFIED BY CBP
23	RI-001/NS-003	LAN/SLAN 112	1	ROOM # 112 (BRAILLE)	MESSAGE TO BE VERIFIED BY CBP
24	RI-001	ENTRANCE OFFICE	1	ROOM # 113 ENTRANCE OFFICE (BRAILLE)	MESSAGE TO BE VERIFIED BY CBP
25	RI-001	SUPERVISOR'S OFFICE	1	ROOM # 123 OFFICE (BRAILLE)	MESSAGE TO BE VERIFIED BY CBP
26	RI-001	GENERAL STORAGE/FILE ROOM	1	ROOM # 115 STORAGE (BRAILLE)	MESSAGE TO BE VERIFIED BY CBP
27	RI-001	CONFERENCE ROOM 116	1	ROOM #116 CONFERENCE ROOM (BRAILLE)	MESSAGE TO BE VERIFIED BY CBP
28	RI-001	BREAK ROOM 121	1	ROOM # 121 BREAK ROOM (BRAILLE)	MESSAGE TO BE VERIFIED BY CBP
29	RI-009	LOCKER ROOM 117	1	WOMEN'S LOCKER ROOM (BRAILLE) + PICTOGRAM	MESSAGE TO BE VERIFIED BY CBP
30	RI-005	NOT USED	0	WOMEN (BRAILLE) + PICTOGRAM	MESSAGE TO BE VERIFIED BY CBP
31	RI-008	LOCKER ROOM 119	<u>-</u> 1	MEN'S LOCKER ROOM (BRAILLE) + PICTOGRAM	MESSAGE TO BE VERIFIED BY CBP
32	RI-004	NOT USED	0	MEN (BRAILLE) + PICTOGRAM	MESSAGE TO BE VERIFIED BY CBP
33	NS-006	EXTERIOR DOOR	2	DO NOT ENTER AUTHORIZED PERSONEL ONLY + SYMBOL	PROVIDED BY CBP
34	NS-011	EXTERIOR		NO SMOKING WITHIN 25 FEET BUILDING ENTRANCE	MESSAGE TO BE VERIFIED BY CBP
35	NS-003	EXTERIOR DOOR	4	AUTHORIZED PERSONEL ONLY + CBP SEAL AND SIGNATURE	PROVIDED BY CBP
36	NS-006	EXTERIOR	2	DO NOT ENTER AUTHORIZED PERSONEL ONLY (SMALL SIZE)	PROVIDED BY CBP
37	FLAG	EXTERIOR FLAGS	3		U.S.A., DHS, CBP, SIZE TO BE VEIRY
38	FLAG	INTERIOR FLAGS	6		U.S.A., DHS
39		EXTERIOR ENTRY DOORS	2	NO WEAPONS	MESSAGE TO BE VERIFIED BY CBP
40	SS DISPLAY	PUBLIC LOBBY 114	 1	INSERTS PROVIDED BY CBP	PHOTOGRAPHY PROVIDED BY CBP, SEE DETAIL 10/A804
41	SS DISPLAY	PUBLIC LOBBY 114	<u>.</u> 1	INSERTS PROVIDED BY CBP	STATUTORY PROVIDED BY CBP, SEE DETAIL 11/A804
42	NOT USED	, oblic lobbi 114	•	THE THE PROPERTY OF THE PROPER	CITATORAL TROVIDED DI ODI, GLE DETAIL TI/A004
43	NOT USED				
44	NOT USED				
45	NS-003	SECURE STORAGE 111	1	AUTHORIZED PERSONEL ONLY + CBP SEAL AND SIGNATURE	MESSAGE TO BE VERIFIED BY CBP
46	NS-003	LAN/SLAN 112	1	AUTHORIZED PERSONEL ONLY + CBP SEAL AND SIGNATURE AUTHORIZED PERSONEL ONLY + CBP SEAL AND SIGNATURE	MESSAGE TO BE VERIFIED BY CBP

NOTE:
1. CBP TO PROVIDE VARIOUS SIGNAGE NOT LISTED OR SHOWN ON SIGNAG PLAN. THOSE SIGNES TO BE INSTALLED BY CONTRACTOR.

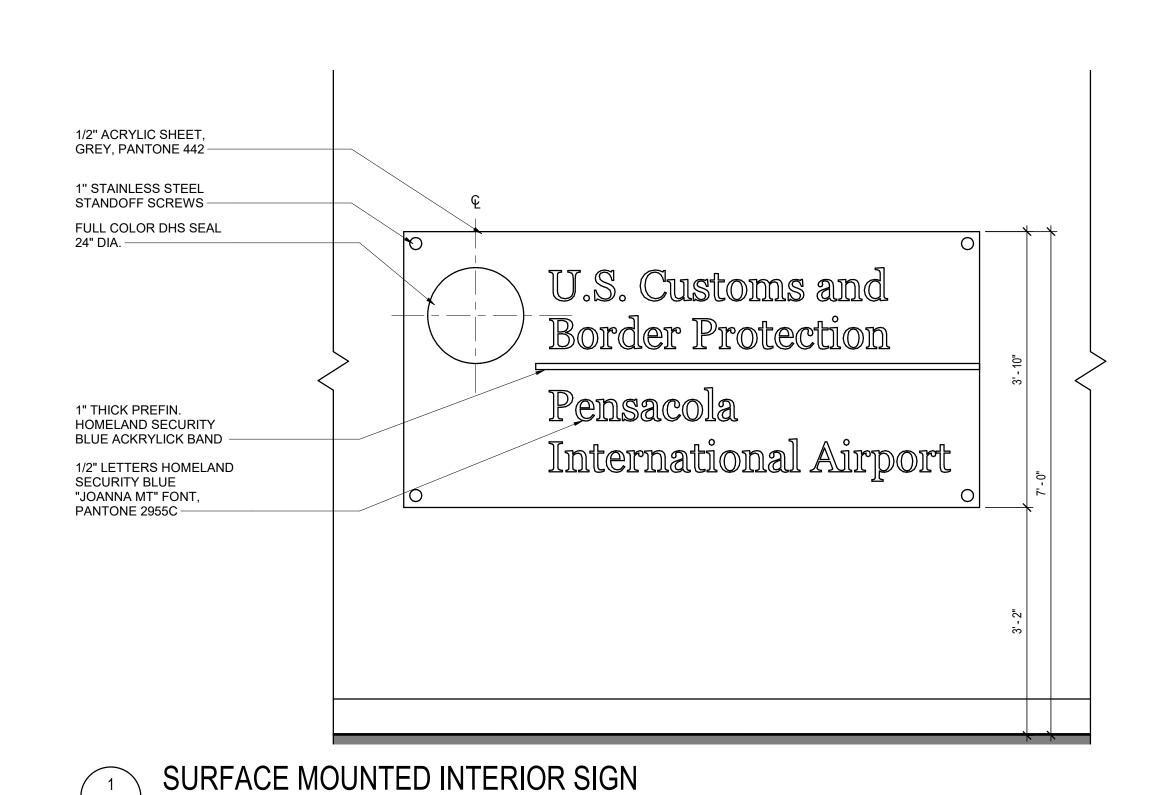

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NO. DESCRIPTION DATE

1. PROGRESS DRAWINGS 11/19/19

DATE ISSUED: 03/03/2020

REVIEWED BY: Checker

DRAWN BY: Author

DESIGNED BY: Designer

PROJECT NUMBER: 201-0052-002

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SHEET TITLE

SIGNAGE SCHEDULE


SHEET NUMBER

A803

BID DOCUMENTS

SCALE: 3/4" = 1'-0"

A803

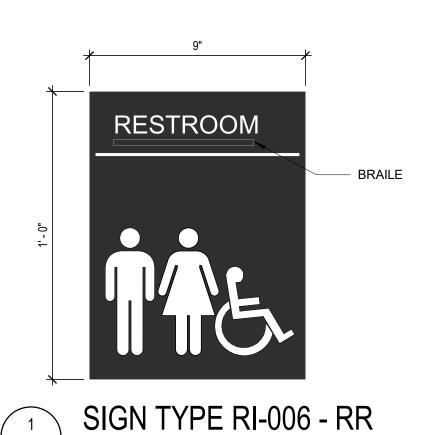


A804

A804


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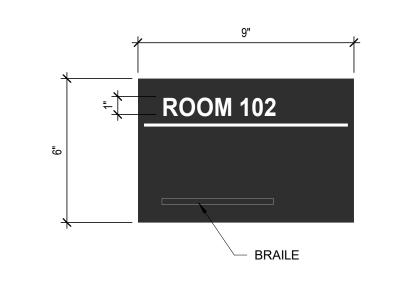
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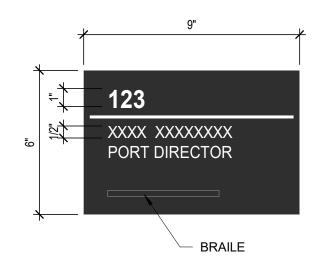


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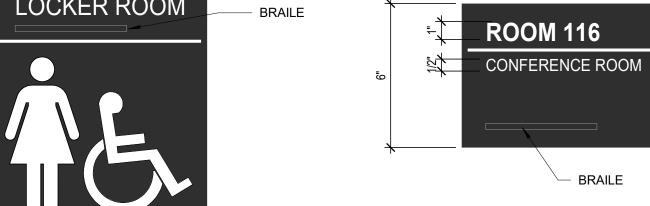


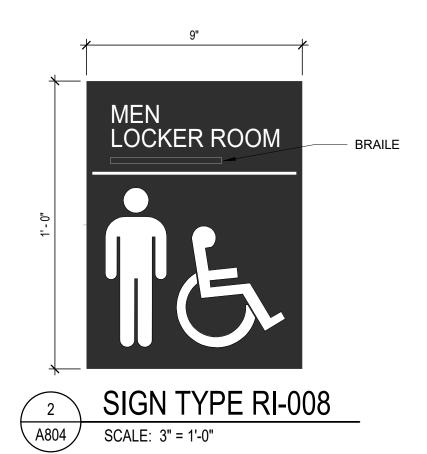






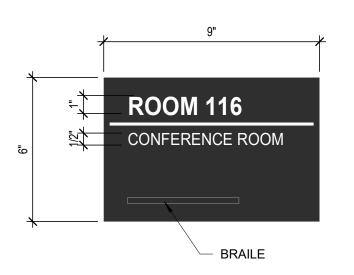






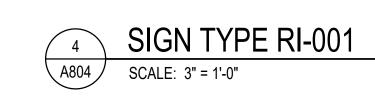










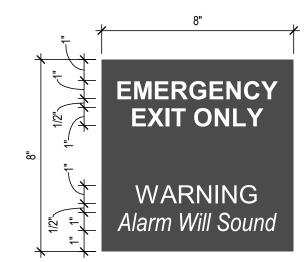




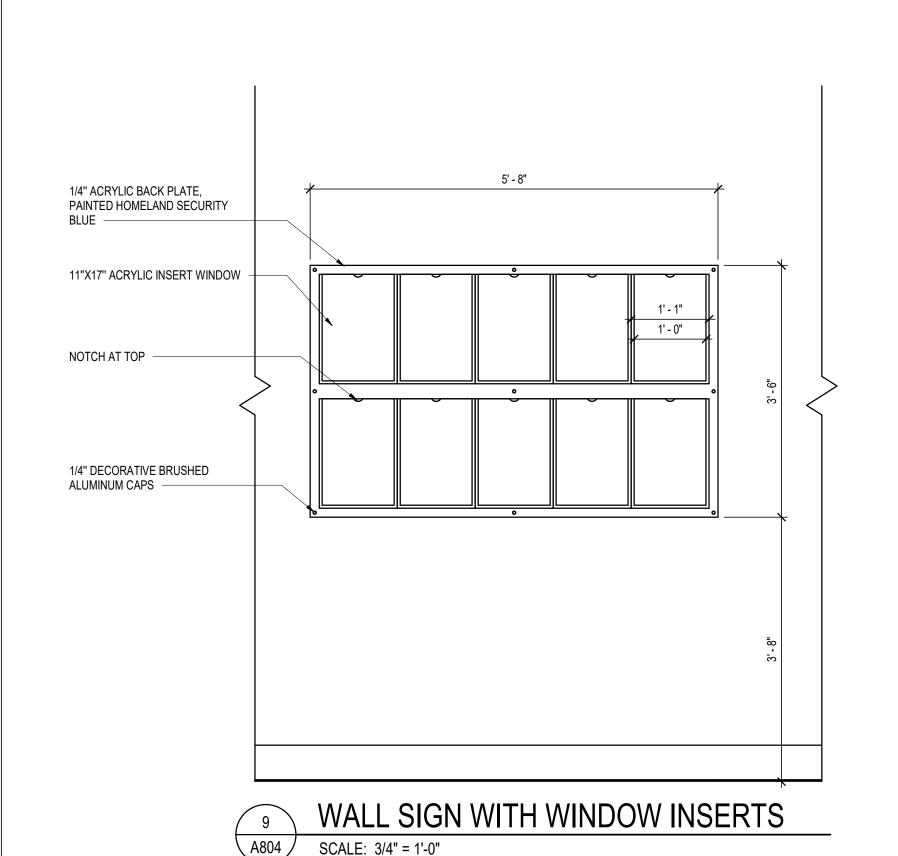

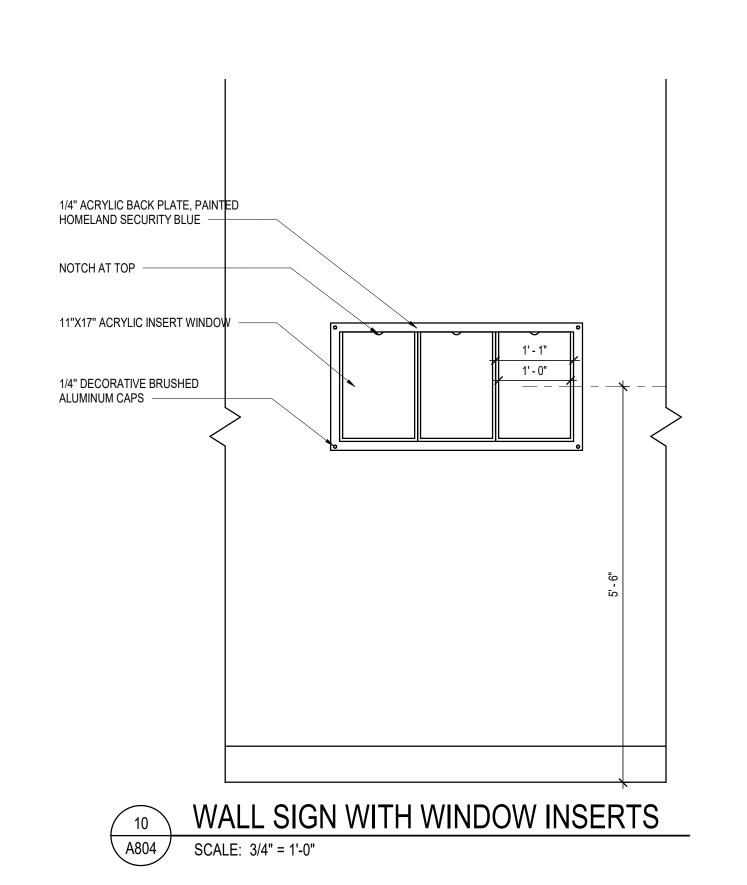

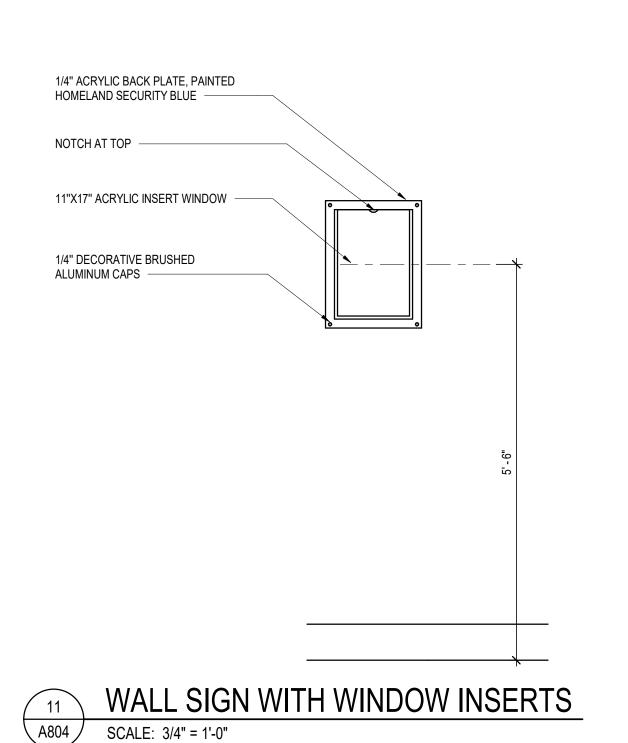

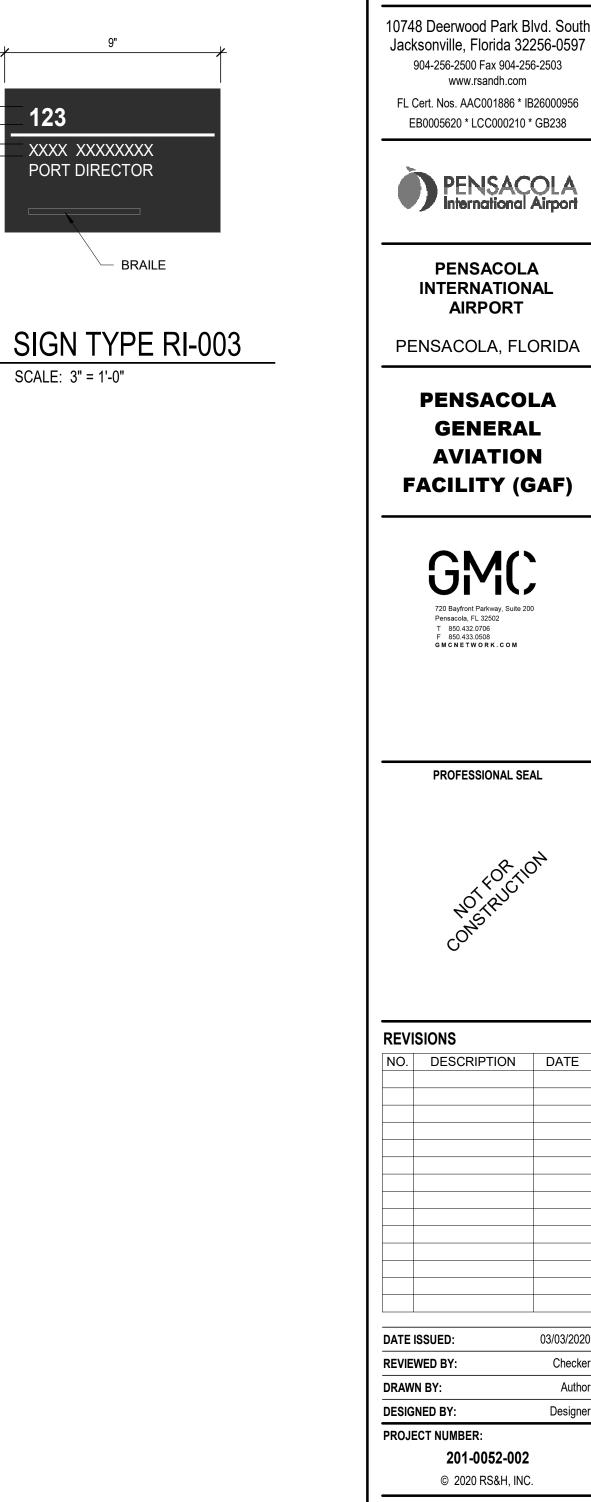

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DRAW	N BY:	Author				
DESIGNED BY: Designer						
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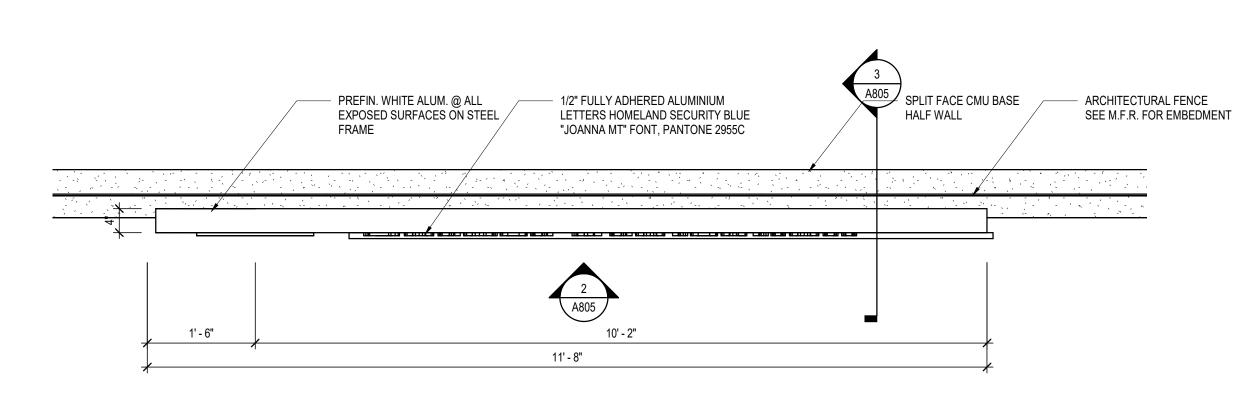
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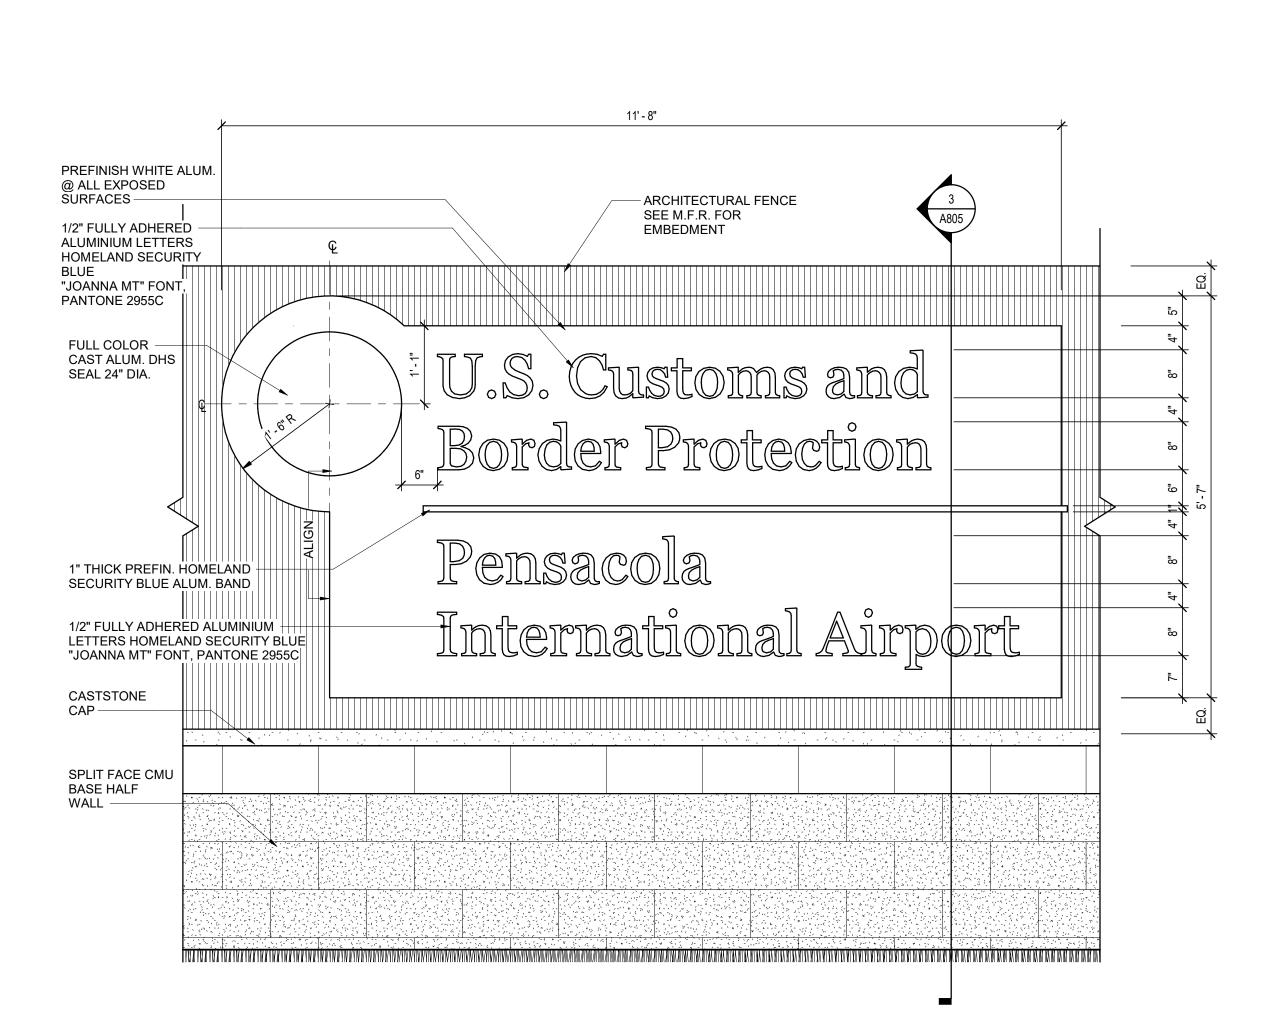
SIGNAGE TYPES


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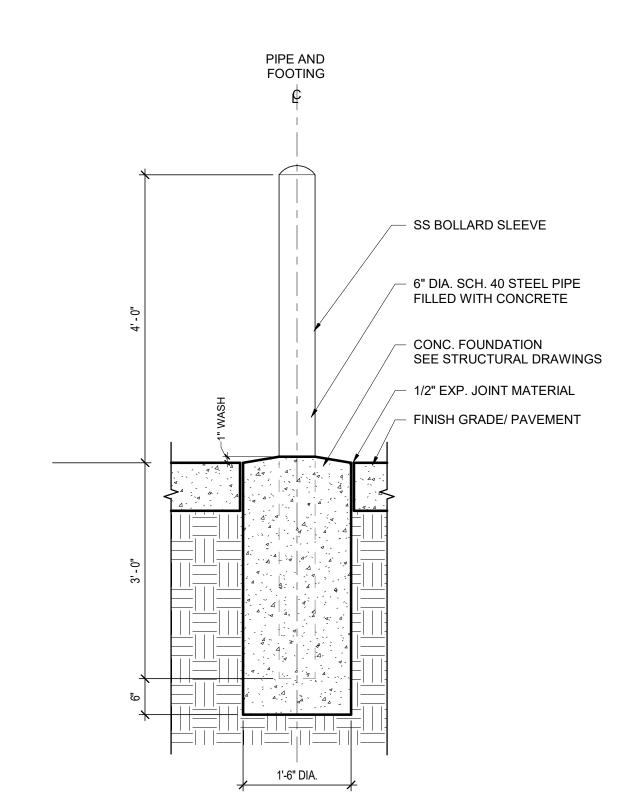
A804









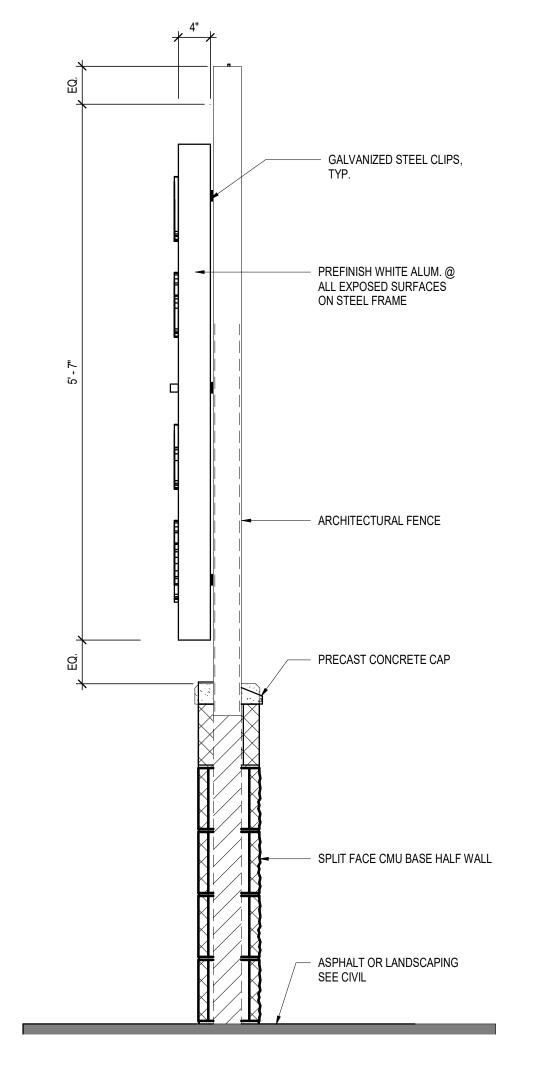

3 SURFACE MOUNTED SITE SIGN
SCALE: 1" = 1'-0"

4 BOLLARD, TYP.

SCALE: 3/4" = 1'-0"

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SITE DETAILS


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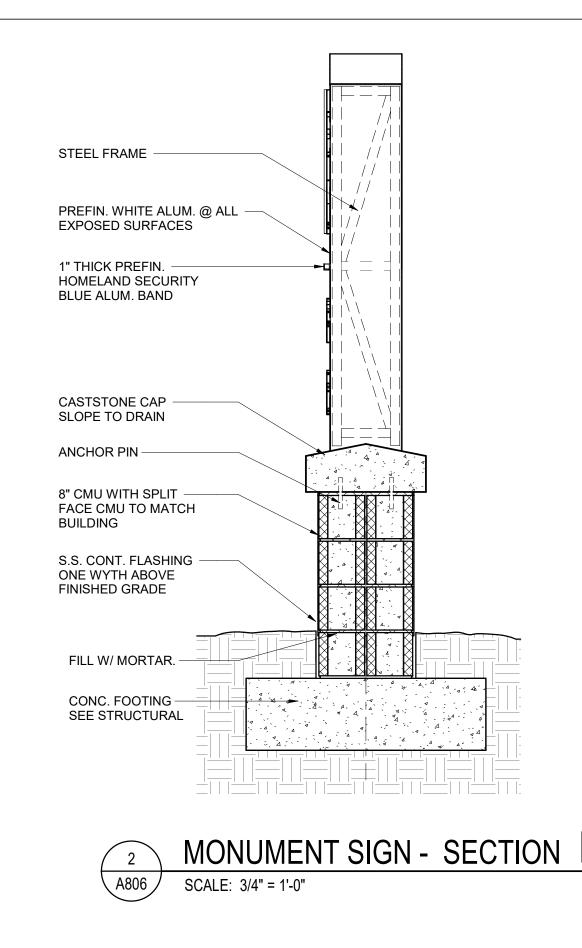
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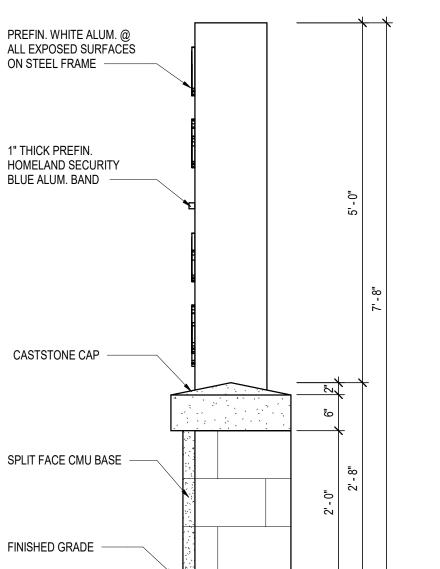
BID DOCUMENTS

SCALE: 3/4" = 1'-0"

SURFACE MOUNTED SITE SIGN





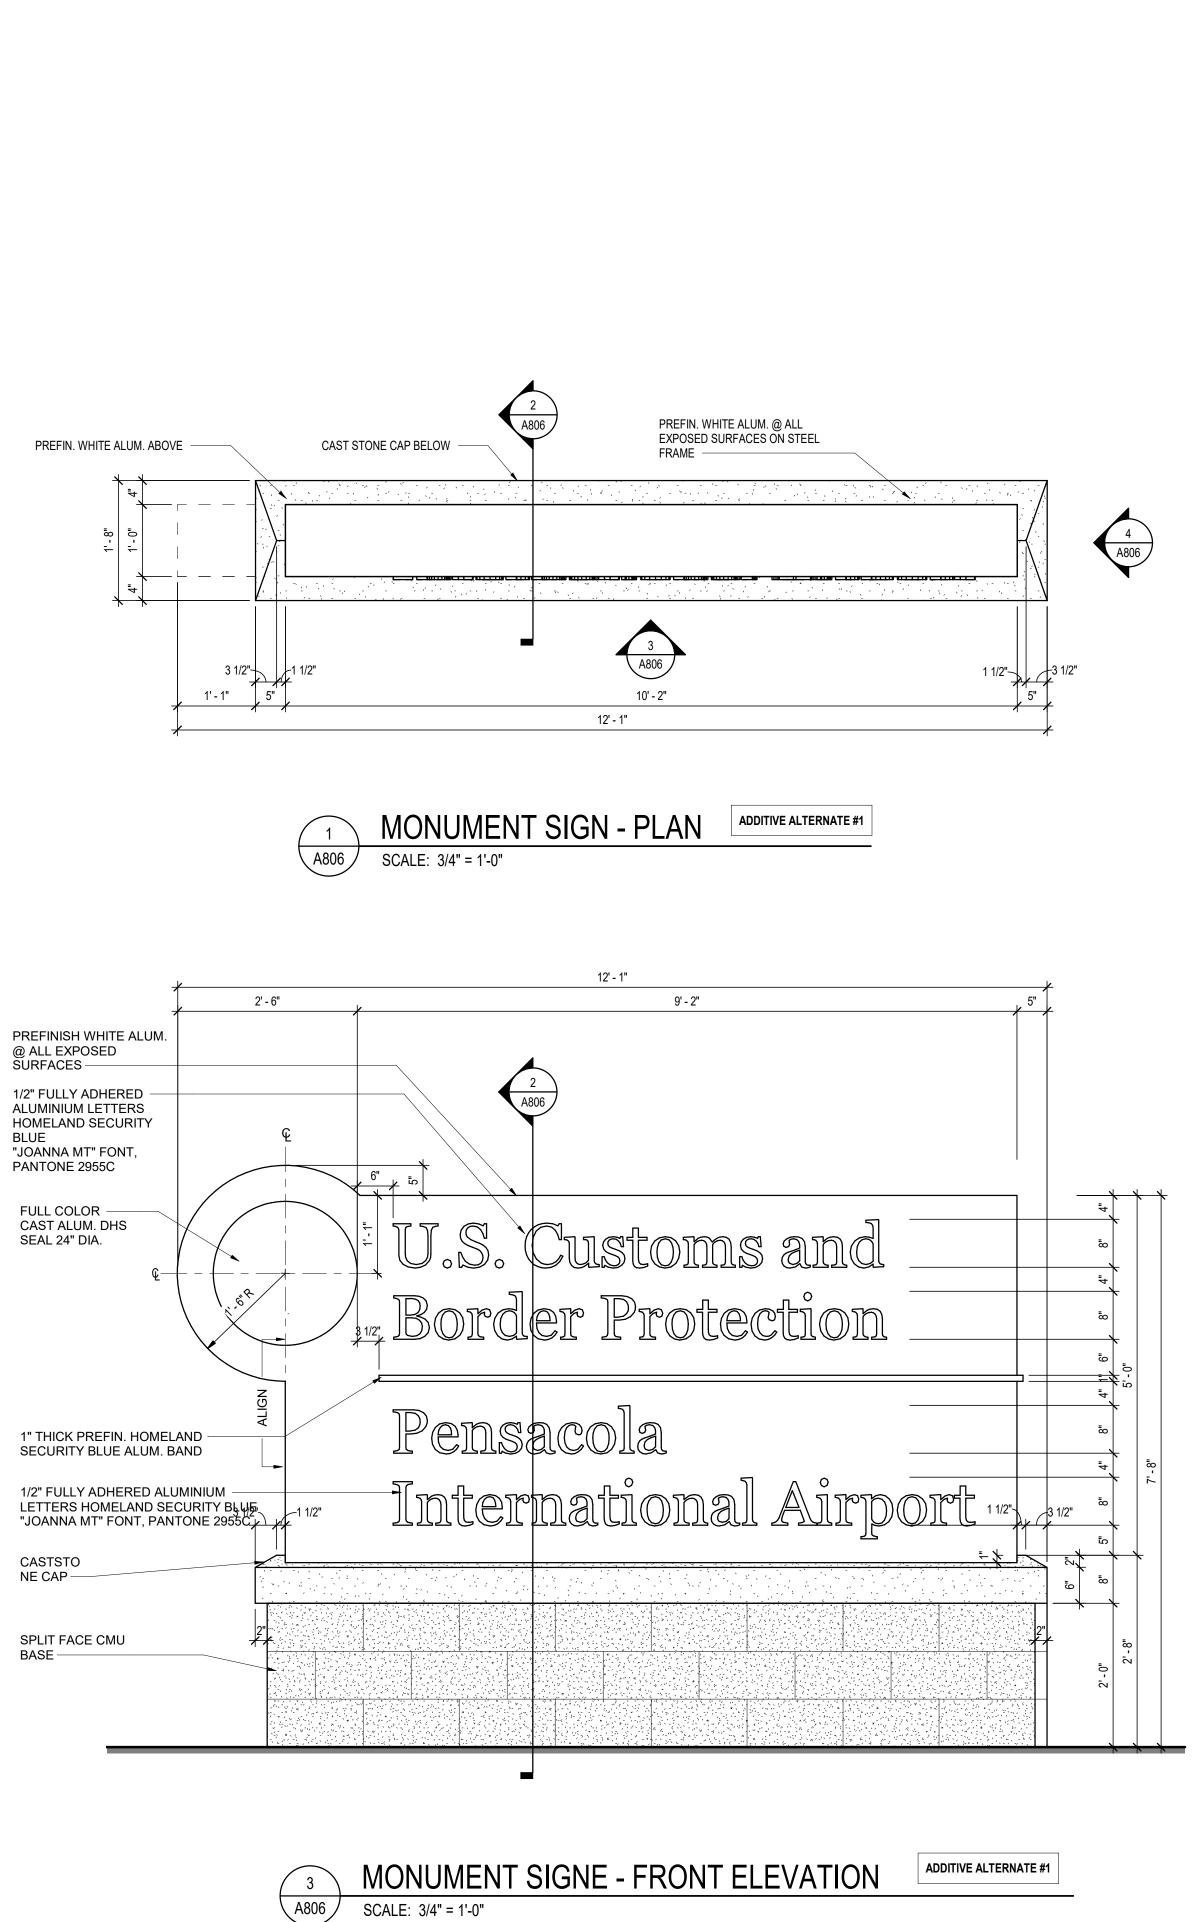

MONUMENT SIGN - SIDE ELEVATION ADDITIVE ALTERNATE #1 SCALE: 3/4" = 1'-0"

- 2. MONUMENT SIGN IS THE ADDITIVE ALTERNATE #1. SURFACE MOUNTED SIGN CAN BE DELETED IF AIRPORT ACCEPTS ADDITIVE ALTERNATE #1.
- 3. FOR SURFACE MOUNTED SIGN LOCATION SEE EXTERIOR ELEVATION DRAWINGS, FOR MONUMENT SIGN LOCATION SEE ARCHITECTURAL SITE PLAN.

SHEET NUMBER

A806

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ADDITIVE GENERAL SHEET NOTES ALTERNATE #1 1. SURFACE MOUNTED SIGN IS A BASIS OF DESIGN.

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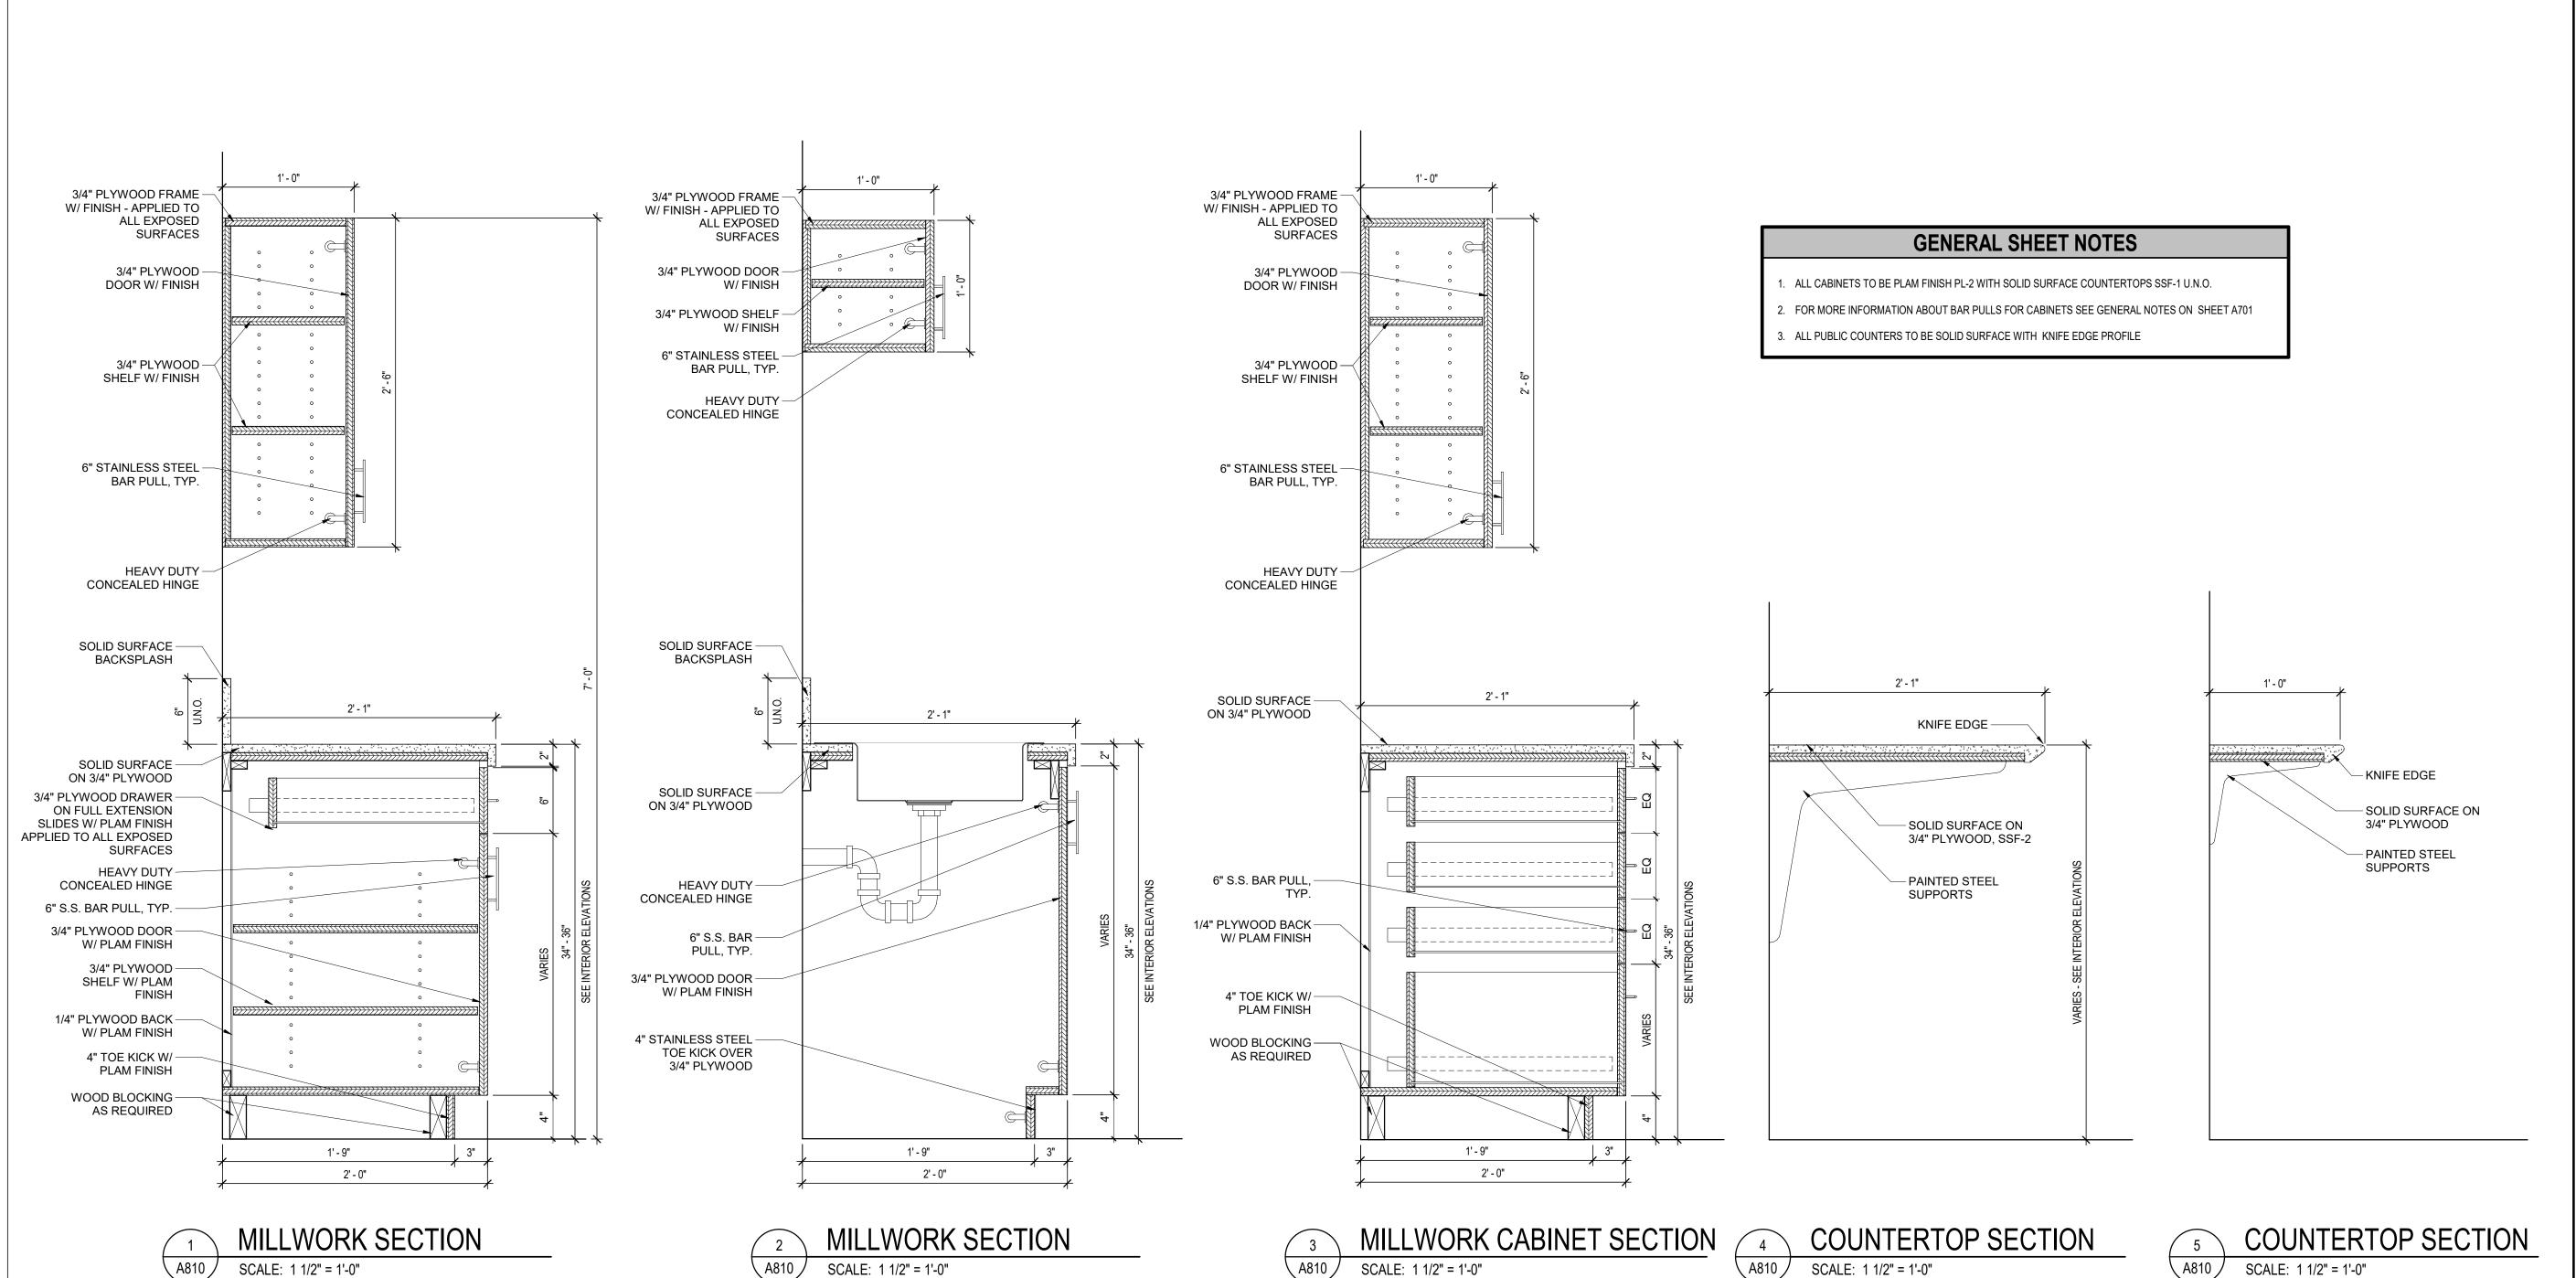
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SHEET TITLE

SITE DETAILS



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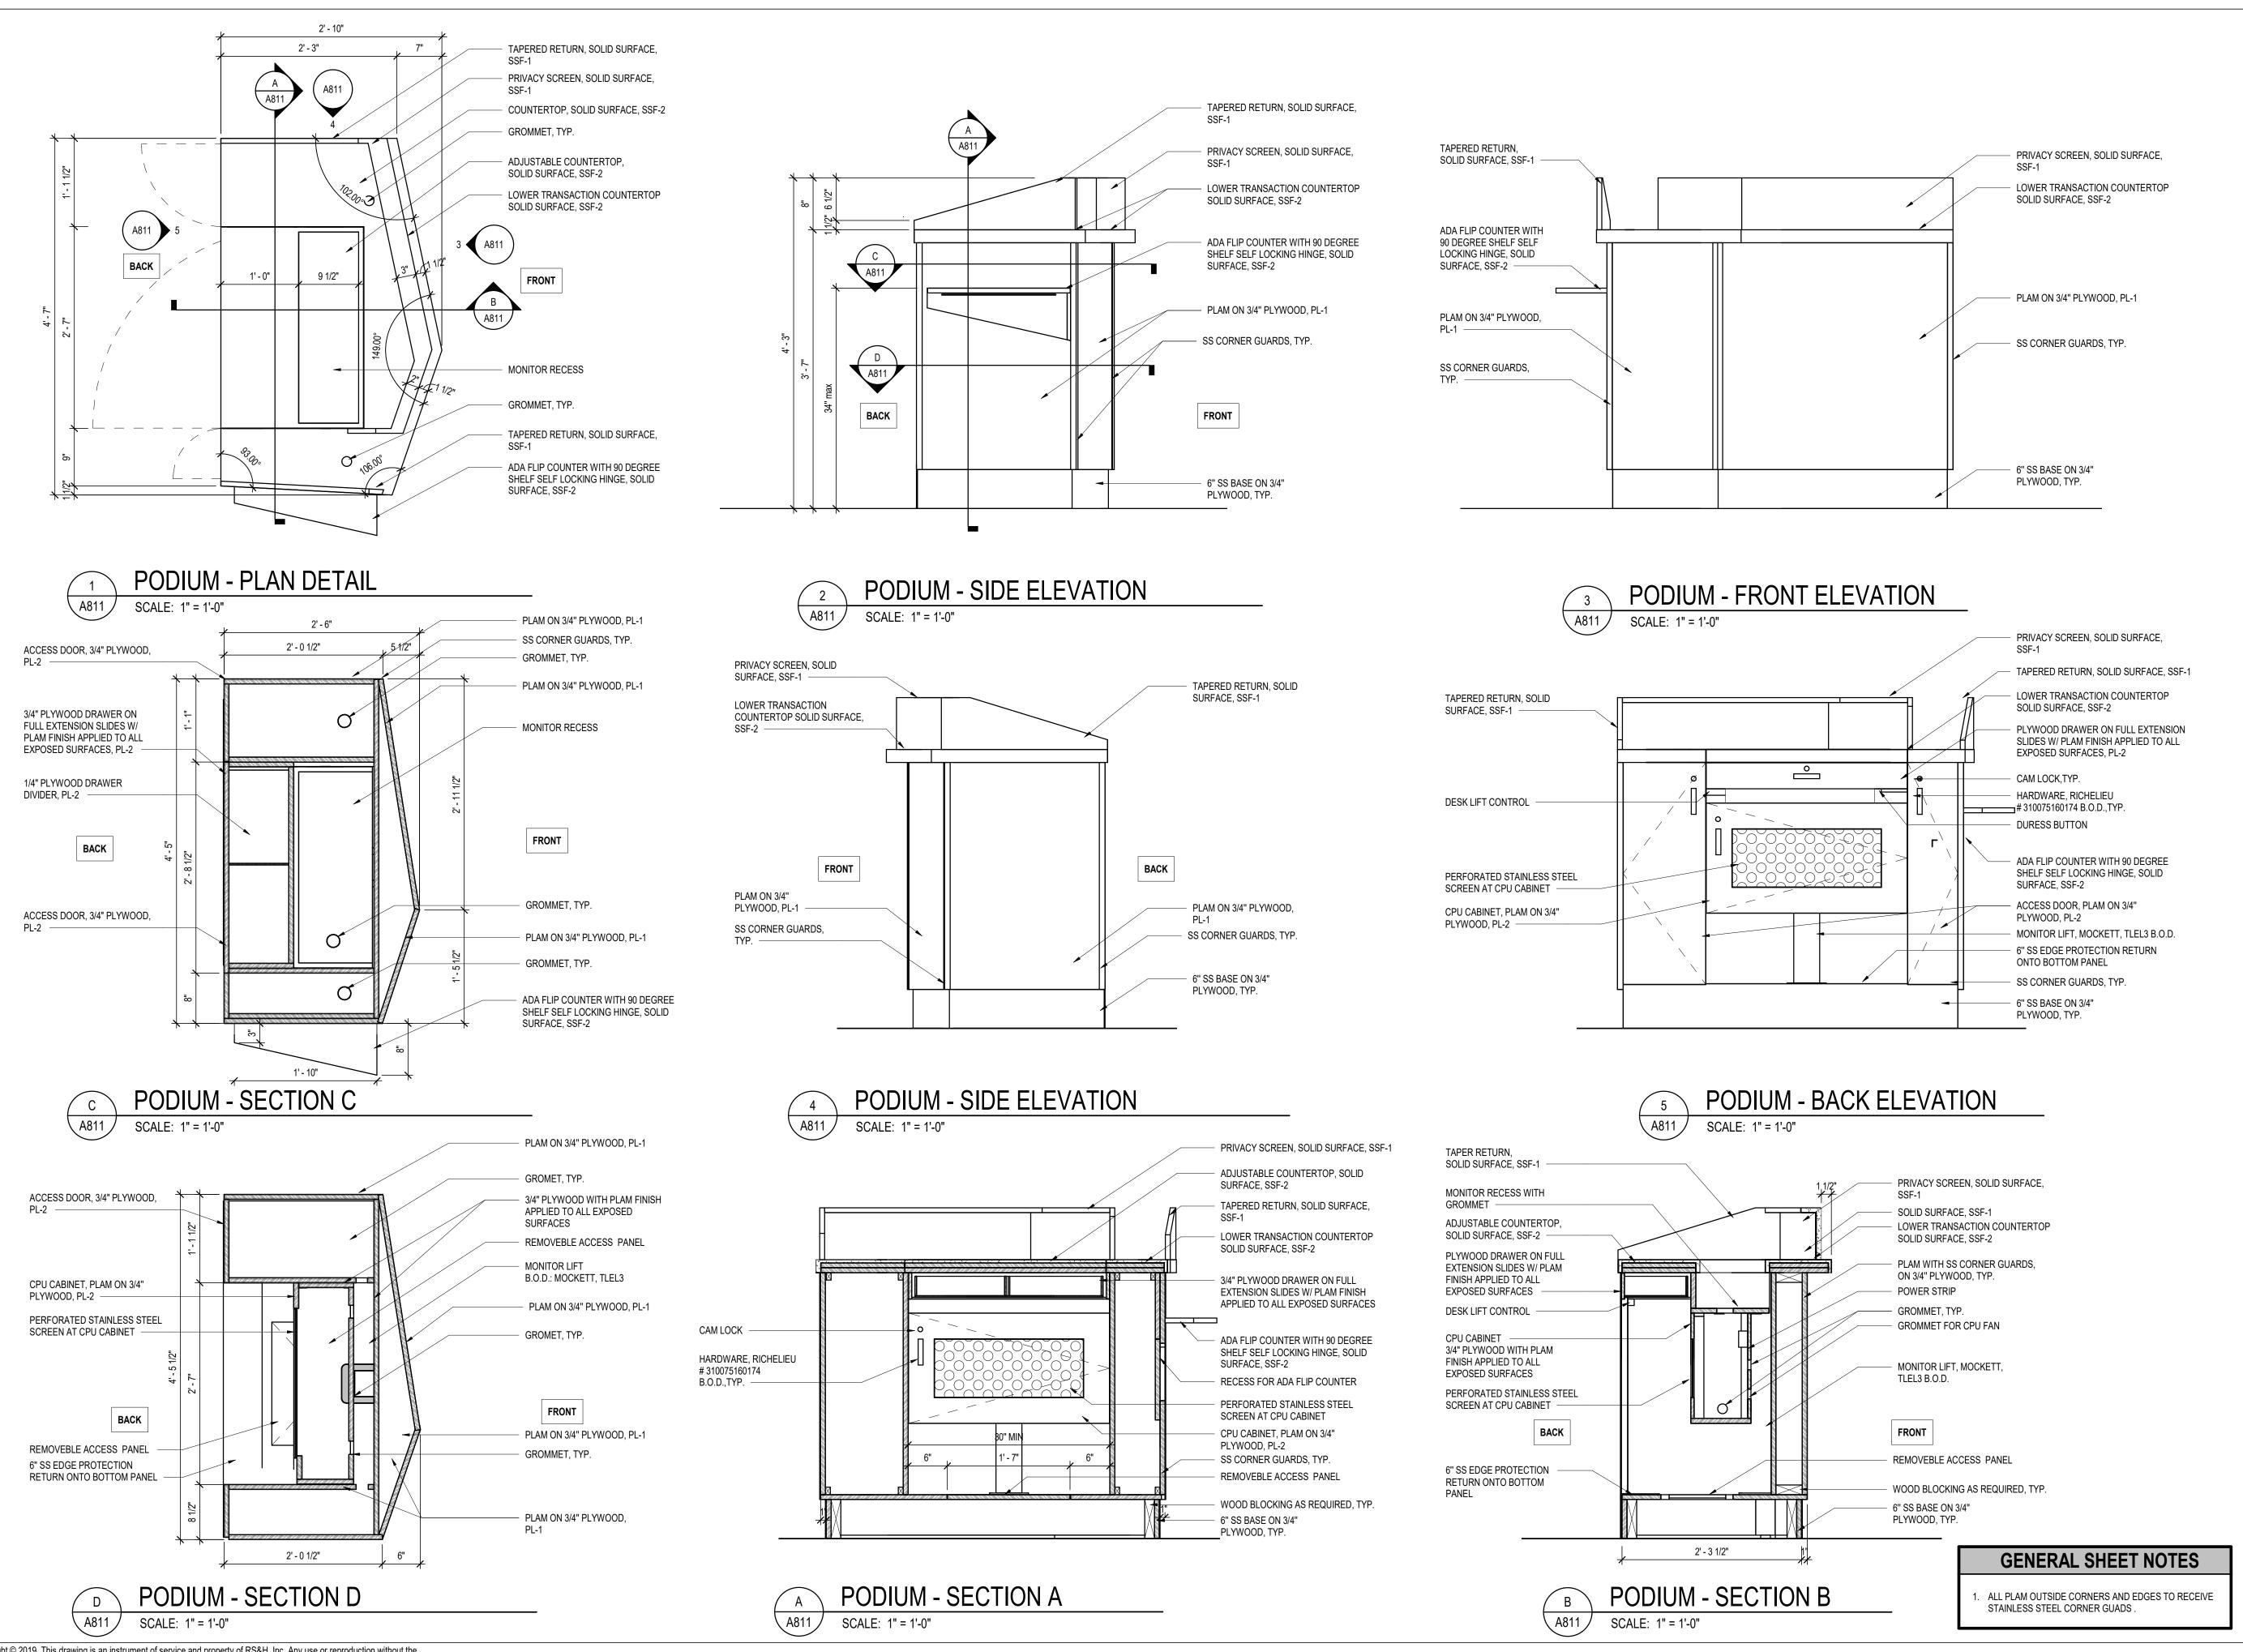
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MILLWORK DETAILS

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A810



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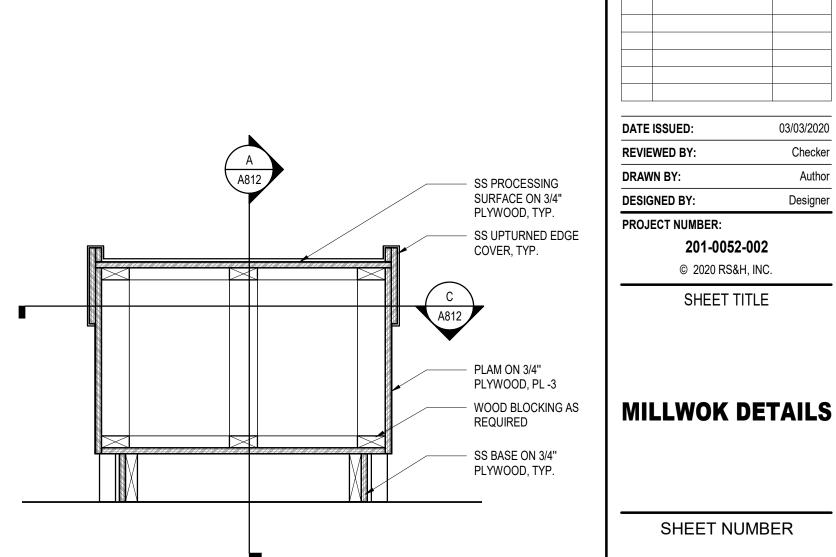
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MILLWORK

SHEET NUMBER

DETAILS

A811



PROCESSING TABLE - SECTION B

- SS PROCESSSING SURFACE ON 3/4" PLYWOOD, TYP.

SS UPTURNED EDGE

PLAM ON 3/4" PLYWOOD

SS BASE ON 3/4" PLYWOOD, TYP.

A812

SCALE: 1" = 1'-0"

WOOD BLOCKING AS

REQUIRED

COVER, TYP.

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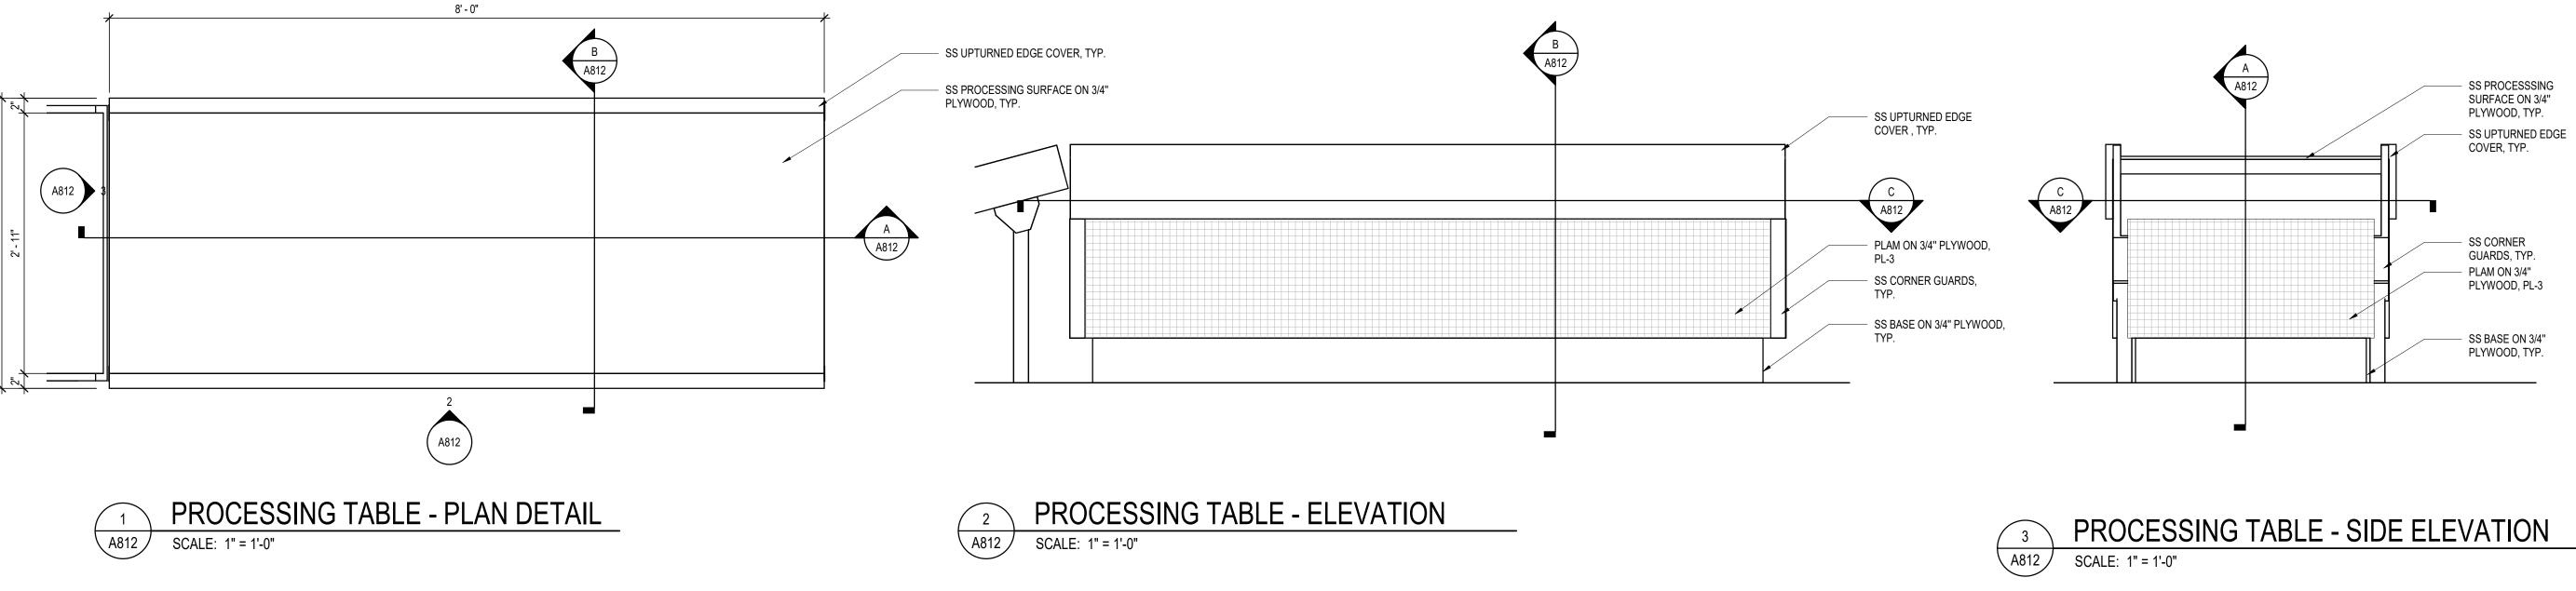
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Author

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RISER ASSEMBLY

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FLORIDA ADMISTRATIVE CODE 61G15 NOTES

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REVIEWED BY: SD

DRAWN BY: KMD

DESIGNED BY: KMD/AR

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FIRE PROTECTION FLOOR PLAN

SHEET NUMBER

F100

BID DOCUMENTS

SCALE: 3/16" = 1'-0"

PLUMBING GENERAL NOTES:

1. THE CONTRACTOR SHALL FIELD VERIFY ALL EXISTING AND PROPOSED CONDITIONS AND UTILITIES, PIPE SIZES, LOCATIONS, MATERIALS, ETC., BEFORE BID, STARTING WORK OR ORDERING MATERIALS AND INCLUDE MINOR ADJUSTMENTS TO ADAPT DESIGN TO ACTUAL FIELD CONDITIONS AT NO ADDITIONAL COST TO THE OWNER.

2. THE CONTRACTOR SHALL COORDINATE THE PLUMBING SYSTEMS INSTALLATION WITH WORK OF STRUCTURE, HVAC, ELECTRICAL, CASEWORK, LAB SERVICE EQUIPMENT AND RELATED TRIM, ETC.,

3. EQUIPMENT AND MATERIALS, ETC., SPECIFIED OR SCHEDULED OR NOTED ON THE DRAWINGS, METHODS DETAILED AND PIPING MATERIALS INDICATED ON THE DRAWINGS SUPERCEDE ONLY ANY CONFLICTING SPECIFICATION ARTICLES AND/OR REQUIREMENTS OF DIVISION 22 REGARDING PLUMBING MATERIALS, METHODS, ETC. THIS INCLUDES MATERIALS SPECIFIED, LEGEND ITEMS REPRESENTED SYMBOLICALLY ON THE DRAWINGS AND IDENTIFIED IN THE LEGEND DESCRIPTIONS OR ABBREVIATIONS DESCRIPTIONS.

4. ADJUST FLOW & TEMPERATURE TO SPECIFIED FLOW & TEMPERATURE FOR ALL FIXTURES PER 2017 FLORIDA BUILDING CODE - PLUMBING, SIXTH EDITION; ADJUST SENSOR / METERING FAUCET TO OPERATE FOR 15 SECONDS AND MAXIMUM MIXED WATER TEMPERATURE TO BE 110 DEGREES FAHRENHEIT AT EVERY SENSOR / MIXING FAUCET EXCEPT JANITOR AND FOOD SERVICE FAUCETS.

5. INSTALL ALL PLUMBING MATERIALS, TRIM ACCESSORIES AND RELATED ITEMS IN ACCORDANCE WITH THE MANUFACTURERS WRITTEN INSTRUCTIONS AND RECOMMENDATIONS AND AS SHOWN ON THE PLUMBING DRAWINGS.

6. DIRECTIONAL CHANGES IN THE HORIZONTAL PLANE OF S, W, GW, ESD AND SD (ALL DRAINAGE) PIPING SYSTEMS SHALL NOT USE QUARTER BENDS OR SHORT SWEEP QUARTER BENDS AND SHALL NOT EXCEED 45 DEGREES UNLESS AN FCO OR WCO IS PROVIDED. PIPING IS INSTALLED AND COORDINATED WITH ALL BUILDING ELEMENTS IN THE FIELD, PROVIDE FCO'S OR WCO'S FOR HORIZONTAL ROUTES OR BRANCHES OF ALL DRAINAGE PIPING SYSTEMS WITH MORE THAN ONE OFFSET OR CHANGE IN DIRECTION EVERY 40 FEET (MAXIMUM SPACING FOR MULTIPLE OFFSETS) OF DEVELOPED LENGTH OF DRAINAGE PIPING.

7. UON ON THE PLUMBING DRAWINGS, REFER TO ARCHITECTURAL DRAWINGS FOR DIMENSIONAL LAYOUTS AND EXACT LOCATIONS OF PLUMBING FIXTURES, FLOOR DRAINS, FLOOR SINKS, ROOF DRAINS, EMERGENCY ROOF DRAINS, DOWNSPOUT NOZZLES, AREA DRAINS, ETC. WHERE DIMENSIONS ARE NOT GIVEN CENTERLINE FIXTURE PLACEMENT, MOUNTING HEIGHTS, SPOUT HEIGHTS, ETC., SHALL BE IN COMPLIANCE WITH THE FLORIDA BUILDING CODE (2017) AND FLORIDA PLUMBING CODE (2017).

8. THE CONTRACTOR SHALL PAY ALL REQUIRED WATER, GAS AND SANITARY PERMITS, TAPS (UTILITY CONNECTIONS), METERS, CROSS-CONNECTIONS (BACKFLOW PREVENTERS) PERMIT, INSPECTION AND TEST FEES AND OTHER FEES AS MAY BE REQUIRED BY THE LOCAL AUTHORITY HAVING JURISDICTION.

9. PROVIDE CAST IRON DEEP SEALING TRAPS BELOW FLOOR DRAINS AND FLOOR SINKS REGARDLESS WHETHER PIPING MATERIAL IS PVC OR CAST IRON.

10. PROVIDE CAST IRON CLEANOUT TEES FOR WCO AND CAST IRON COOG AND FCO INCLUDING CLEANOUT BODY, PIPING AND FITTINGS EXTENDED TO PIPING SERVED.

11. SANITARY OR WASTE BRANCHES IN WALLS SERVING LAVATORIES, SINKS, URINALS, HANDSINKS AND SIMILAR FIXTURES SHALL BE COPPER DWV OR PVC TUBE AND FITTINGS. WYES, TEES, CROSSES AND COMBINATION WYE AND 1/8 BENDS AT SANITARY OR WASTE STACKS SHALL BE PROVIDED WITH WASTE ARM ELBOWS IN WALL, ALL OF WHICH SHALL NOT PENETRATE FACE OF WALL; PROVIDE ELBOWS IN WALL ON WASTE ARM TO ENSURE STACK FITTING CONCEALMENT.

12. ALL PLUMBING WORK SHALL BE IN ACCORDANCE WITH THE FLORIDA BUILDING CODE (BUILDING, PLUMBING & MECHANICAL 2017 EDITIONS) AND NFPA 101 LIFE SAFETY CODE (LATEST EDITION). ALL CENTERLINE FIXTURE PLACEMENT, MOUNTING HEIGHTS, SPOUT HEIGHTS, ETC., SHALL BE IN COMPLIANCE WITH THE FLORIDA BUILDING CODE (BUILDING & PLUMBING 2017 EDITIONS).

13. ALL PLUMBING WORK SHALL BE INSTALLED IN A PROFESSIONAL, NEAT AND WORKMANLIKE MANNER FOR COMMERCIAL CONSTRUCTION.

14. ALL MODIFICATIONS TO THE PLUMBING WORK SHALL BE RECORDED IN DETAIL ON THE AS-BUILT DRAWINGS AS REQUIRED PER THE PROJECT SPECIFICATIONS IN THE PROJECT MANUAL.

15. DIELECTRIC UNIONS SHALL BE PROVIDED ON ONE SIDE OF THREADED BALL VALVES, GATE VALVES, CHECK VALVES AND CIRCUIT BALANCING VALVES. PROVIDE DIELECTRIC UNION ON THE UPSTREAM SIDE OF BRAZED OR SOLDERED VALVES. DIELECTRIC UNIONS ARE NOT BE REQUIRED ON THREE PIECE, UNION, FULL PORT, BALL VALVES.

18. ALL PIPING BELOW FLOOR AND BELOW GRADE SHALL BE INSTALLED WITH 4.5 MIL FOIL DETECTABLE UNDERGROUND WARNING AND IDENTIFICATION TAPE INSTALLED A MAXIMUM OF 8" ABOVE TOP OF PIPING. FOR PIPING DEEPER THAN 32" BELOW FLOOR / GRADE PROVIDE ADDITIONAL WARNING AND IDENTIFICATION TAPE(S) AT 24" DEPTH INTERVALS ALONG ENTIRE LENGTH OF PIPING. WHERE PIPING RISES TO ABOVE GRADE OR FLOOR SECURELY TERMINATE TAPE AND PROVIDE ENGRAVED PHENOLIC NAMEPLATES PERMANENTLY SECURED ADJACENT TO PENETRATION. NAMEPLATE TEXT SHALL IDENTIFY PIPING SERVICE, MATERIAL AND WHERE PIPING EXTENDS TO.

19. INSTALL CAST IRON SANITARY AND VENT PIPING AND COPPER WATER PIPING IN RETURN AIR PLENUMS. PLASTIC OR PVC PIPING SHALL NOT BE INSTALLED IN RETURN AIR PLENUMS.

20. WHERE VALVES ARE INSTALLED ABOVE CEILING, PROVIDE VISUAL IDENTIFICATION AT CEILING GRID ACCESS OR AT ACCESS PANELS. IDENTIFICATION SHALL BE VISIBLE FROM BELOW CEILING. THIS IS IN ADDITION TO MECHANICAL IDENTIFICATION REQUIREMENTS SPECIFIED IN THE PROJECT MANUAL. PROVIDE AP AT HARD (GYPSUM BOARD OR PLASTER) CEILINGS TO ACCESS AND MAINTAIN VALVES.

21. ALL EQUIPMENT AND MATERIALS NEED TO COMPLY TO BAA - BUY AMERICAN ACT.

PLUMBING ABBREVIATIONS

<u>ABBREVIATION</u>	DESCRIPTION
AAV	AIR ADMITTANCE VALVE, INSTALLED ACCESSIBLE WITH FRESH AIR LOUVER
AC	ABOVE CEILING (GENERALLY INDICATES NOTED PIPING INSTALLED ABOVE CEILING
ACT	REMOVABLE LAY-IN ACOUSTICAL CEILING TILE ASSEMBLY
AF	ABOVE FLOOR - REFERENCE TO TOP OF FINISHED FLOOR ELEVATION (UON)
BF	BELOW FLOOR (GENERALLY INDICATES NOTED PIPING INSTALLED BELOW FLOOR)
BG	BELOW GRADE (GENERALLY INDICATES NOTED PIPING INSTALLED BELOW GRADE, APRON AND / OR Ist FLOOR)
BTSP	SINGLE FLOOR DRAIN BATTERY OPERATED TRAP SEAL PRIMER
CI	CAST IRON PIPING, FITTINGS AND COUPLINGS, ETC., (CAST IRON MATERIAL)
СР	CHROME PLATED FINISH ON SPECIFIED PIPING, MATERIAL OR EQUIPMENT
CU	COPPER PIPING, MATERIAL OR EQUIPMENT; TYPE OF COPPER INDICATED
CWV	COMBINATION WASTE AND VENT; ENGINEERED PIPING SYSTEM
DI	DUCTILE IRON PIPING, FITTINGS AND COUPLINGS, ETC., (DUCTILE IRON MATERIAL)
ETSP	MULTIPLE ELECTRONIC FLOOR DRAIN TRAP SEAL PRIMER
GPM	GALLONS PER MINUTE (UNITED STATES)
ΙE	PIPING INVERT ELEVATION - REFERENCE TO FINISHED GROUND LEVEL FLOOR SLAB ELEVATION 0.00', UON
PVC	POLYVINYL CHLORIDE PIPING, FITTINGS AND COUPLINGS, ETC., (POLYVINYL CHLORIDE MATERIAL)
SF	SQUARE FEET OF HORIZONTALLY PROJECTED ROOF SURFACE AREA INCLUDING VERTICAL WALLS
SS	STAINLESS STEEL PIPING, FITTINGS AND COUPLINGS, ETC., (STAINLESS STEEL MATERIAL)
TPRV	ASME APPROVED COMBINATION TEMPERATURE AND PRESSURE RELIEF VALVE
TSP	SINGLE FLOOR DRAIN TRAP SEAL PRIMER (ADDED SUFFIX LETTERS INDICATE MULTIPLE DRAINS)
TYP	TYPICAL AND TYPICAL AS SHOWN
UON	UNLESS OTHERWISE NOTED
<u>VTR</u>	VENT-THRU-ROOF; VANDAL-PROOF, WITH SKIRT, BOOT, FLASHING AND HOOD
X OR XW	"EXISTING" OR "EXISTING WATER CLOSET" (OR OTHER) PREFIX STANDARD. PIPING ABBREV. WITH "X" FOR EXISTING PIPING

PLUMBING LEGEND

	<u>ABBREVIATION</u>	DESCRIPTION
	S	SANITARY DRAINAGE PIPING (HUMAN WASTE)
	W	WASTE DRAINAGE PIPING (NON-HUMAN WASTE)
	V	SANITARY OR WASTE DRAINAGE VENT PIPING
	SD	STORM DRAINAGE PIPING (PRIMARY)
	ESD	EMERGENCY STORM DRAINAGE PIPING (SECONDARY)
	CW	DOMESTIC COLD WATER PIPING
	HW	DOMESTIC HOT WATER PIPING (110 DEGREES F)
	HWR	DOMESTIC HOT WATER RECIRCULATION PIPING (110 DEGREES F)
	G	NATURAL GAS PIPING
——————————————————————————————————————	BV	BALL VALVE; THREE PIECE, FULL PORT, SS BALL AND STEM; MSS-SP-10, ASTM B62 BRONZE, THREADED WITH UNION
* ***********************************		VALVE (BV, UON) LOCATED IN VERTICAL RISER; PROVIDE GATE VALVE AND SPECIFIED TRIM AT MAIN RISER.
\\\\]/	CBV	CAST BRONZE THREADED CIRCUIT BALANCING VALVE (WITH MEMORY STOP & CHECK VALVE): 0.66 - 12 GPM
	CV	HORIZONTAL SWING CHECK VALVE WITH THREADED ENDS; MSS-SP-80, ARROW INDICATES DIRECTION OF FLOW
——————————————————————————————————————	UN	DIELECTRIC UNION
<u>WA</u>	<u>WA</u>	WATER HAMMER ARRESTER (LETTER INDICATES PDI RATING)
		ELBOW, PLAN VIEW
		ELBOW, PLAN VIEW (45 DEGREES)
		ELBOW, TURNING DOWNWARD
		ELBOW, TURNING UPWARD
101		BRANCH TEE OUT OF TOP OF PIPING
131		BRANCH TEE OUT OF BOTTOM OF PIPING
		BRANCH TEE OUT OF SIDE OF PIPING
		DRAINAGE WYE, PLAN VIEW
		DRAINAGE COMBINATION WYE AND ONE-EIGHTH BEND, PLAN VIEW
FCO	<u>FCO</u>	CAST IRON FLOOR CLEANOUT, BRONZE PLUG, SQUARE STAINLESS STEEL TOP TO MATCH FLOOR FINISHES
$\frac{\text{WCO}}{\text{HOHI}}$ OR $\frac{\text{WCO}}{\text{CO}}$	<u>wco</u>	CAST IRON WALL CLEANOUT TEE, BRONZE PLUG, WITH CHROME PLATED BRONZE FRAME & ACCESS COVER
COOG	COOG	CAST IRON CLEANOUT ON GRADE IN 12"x12"x4" CONCRETE PAD, TRACTOR COVER AND BRONZE PLUG
	<u>VTR</u>	VENT THRU ROOF, STONEMAN VANDAL PROOF VENT FLASHING ASSEMBLY WITH SKIRT
<u>FD1</u> <u>FD2</u> <u>FD3</u> <u>FD4</u> →•■ →•●	FD1	FLOOR DRAINS WITH CAST IRON DEEP SEALING TRAP & PRIMER TAP (NUMBER INDICATES TYPE)
<u>−+∞+</u> - o		FLOOR DRAIN, FLOOR SINK OR HUB DRAIN DRAINED THROUGH RUNNING TRAP PROVIDED WITH FCO
		HUB DRAIN (HD) OR EQUIPMENT DRAIN (ED) WITH DEEP SEALING TRAP & PRIMER TAP
	TP	TRAP PRIMER PIPING - TYPE L SOFT COPPER TUBING - NO FITTINGS BELOW FIRST FLOOR
<u>AP</u> OR <u>AP</u>	<u>AP</u>	ACCESS PANEL, RECESSED, FLUSH ENAMELED STEEL, LOCKING, FIRE RATED IN RATED CONSTRUCTION
	PG	PRESSURE GAUGE AND SNUBBER; LARGE DIAL; METRIC (kPa) AND ENGLISH (PSIG) UNITS
$-\overline{\mathbb{T}}$	GC	GAUGE COCK; IN PRESSURE SENSING TUBING TO GAUGE(S)
Į.	Т	THERMOMETER AND THERMOMETER WELL; 9" TALL MINIMUM; ADJUSTABLE; METRIC (kPa) AND ENGLISH (PSIG) UNITS
SWR1		— PLAN / SECTION LETTER OR DETAIL NUMBER / RISER DIAGRAM IDENTIFICATION
P201		— SHEET NUMBER WHERE PLAN, SECTION, DETAIL OR RISER DIAGRAM IS DRAWN



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PENSACOLA INTERNATIONAL **AIRPORT**

PENSACOLA, FLORIDA

PENSACOLA GENERAL AVIATION FACILITY (GAF)



PROFESSIONAL SEAL



REVISIONS

NO.	DESCRIPTION	DATE				
DATE IS	SSUED:	03/03/2020				
REVIEWED BY: J						
DRAWN	N RY·	KMD				

JB/KMD DESIGNED BY: PROJECT NUMBER:

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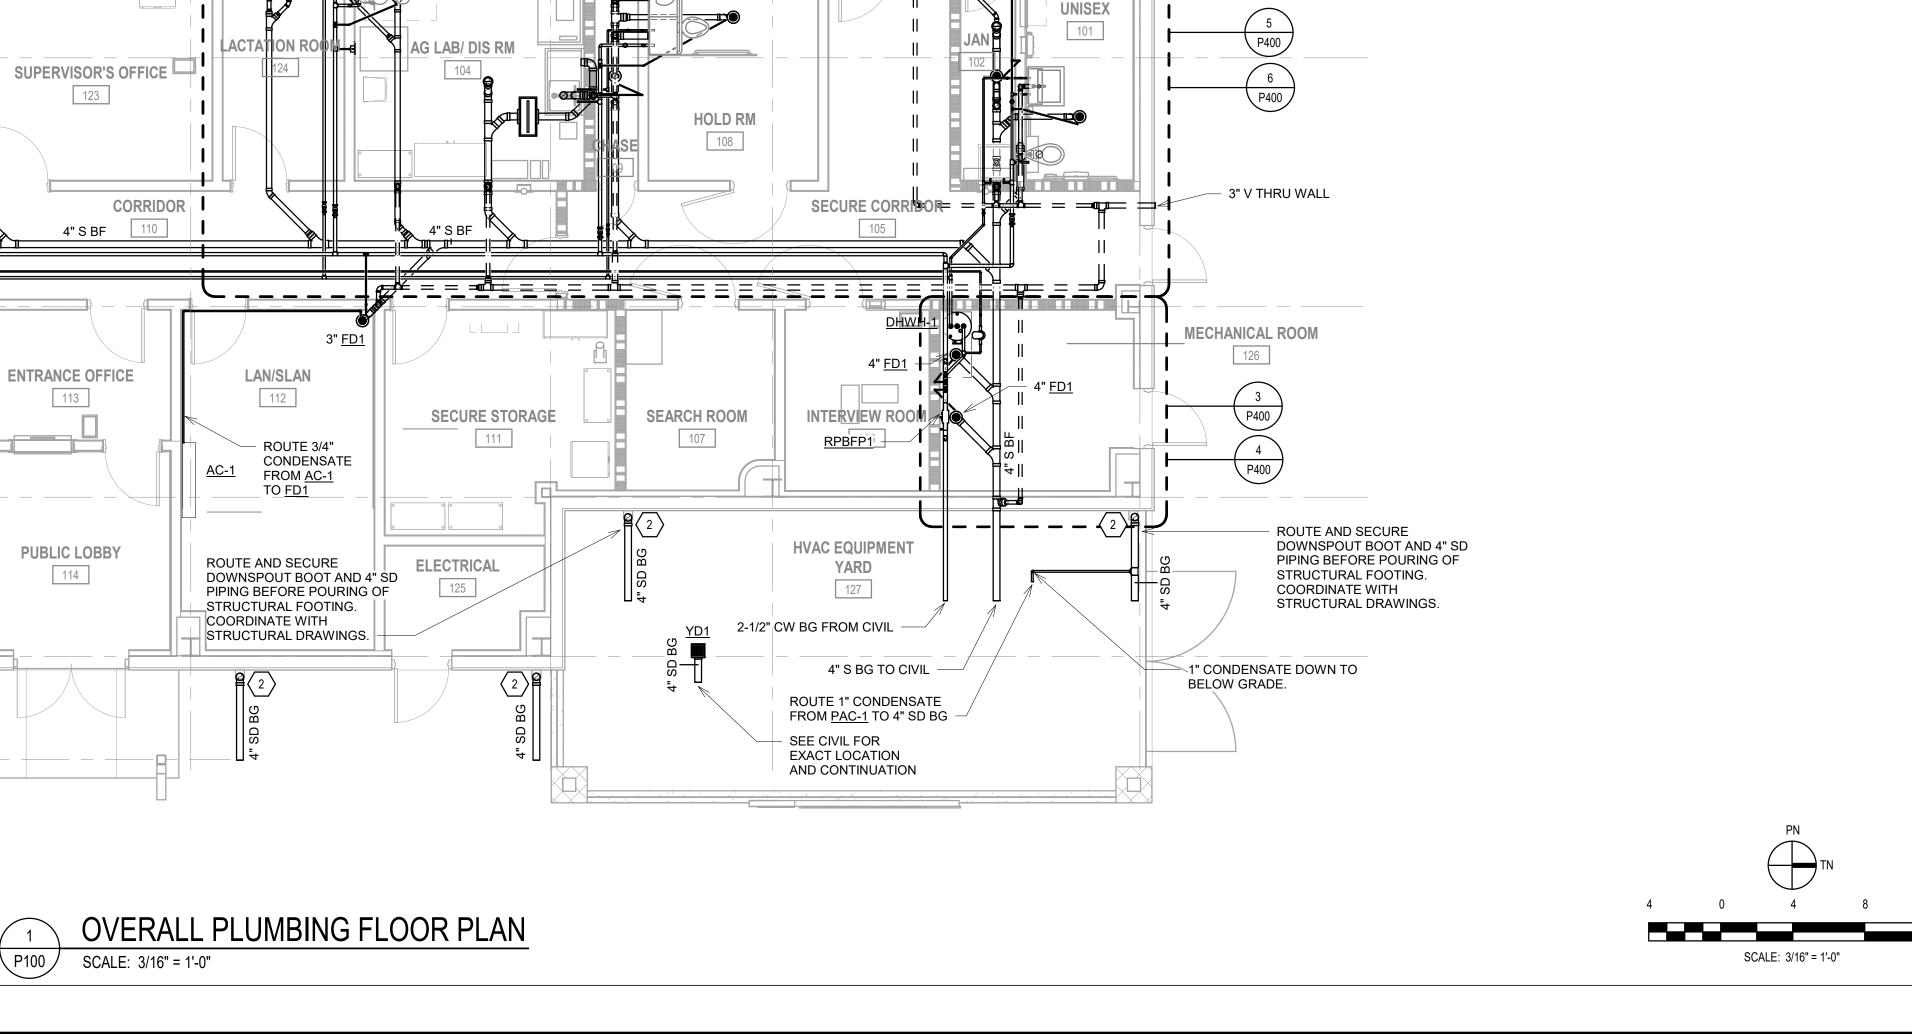
> > SHEET TITLE

PLUMBING GENERAL NOTES, SYMBOLS AND

SHEET NUMBER

ABBREVIATIONS

P001





KEYED NOTES: $\left\langle 0 \right\rangle$

APPROVED EQUAL.

SEE CIVIL SITE PLAN FOR

ABOVE

GRADE

CONTINUATION.

2" GAS DOWN TO BELOW GRADE

1" GAS UP TO SERVE INCINERATOR.

PRE-PROCESSING

100

PROVIDE REGULATOR BEFORE

INCINERATOR CONNECTION.

INCINERATOR SHALL BE ECO

CONCEPTS MODEL ECO-500F STANDARD OR APPROVED EQUAL.

2" G BG

1. GAS METER AND REGULATOR LOCATION. CONTRACTOR SHALL BE RESPONSIBLE FOR COORDINATING GAS METER AVAILABLE PRESSURE AND GAS LINE WITH

LOCAL GAS UTILITY. LOCAL GAS UTILITY TO INSTALL

APPROVED EQUAL. 24" LENGTH AND 5.875" OUTLET.

THE MAINTENANCE OF THE METER.

AND MAINTAIN ALL PIPE UP TO THE METER INCLUDING

2. PROVIDE J.R. HOE AND SONS 6" x 6" OFFSET DOWNSPOUT BOOT WITH RUBBER ADAPTER CONNECTION, OR

CONTINUE 4" STORM PIPING AFTER THE BOOT TO BELOW

3. 2" GAS UP TO SERVE GENERATOR. PROVIDE REGULATOR BEFORE GENERATOR CONNECTION. GENERATOR SHALL BE CAT DG250 GC SPARK-IGNITED GENERATOR SET OR

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PENSACOLA GENERAL AVIATION FACILITY (GAF)

> 720 Bayfront Parkway, Suite 200 Pensacola, FL 32502 T 850.432.0706 F 850.433.0508 G M C N E T W O R K . C O M

> PROFESSIONAL SEAL

REVISIONS NO. DESCRIPTION DATE

DATE ISSUED: 03/03/2020

REVIEWED BY: KMD DRAWN BY: JB/KMD **DESIGNED BY:**

PROJECT NUMBER: 201-0052-002 © 2020 RS&H, INC.

SHEET TITLE

OVERALL PLUMBING FLOOR PLAN

SHEET NUMBER

P100

BID DOCUMENTS

SCALE: 3/16" = 1'-0"

SEE CIVIL FOR

(TYP. OF 11) -

2" G BG

OCKER RO

BREAK ROOM

GENERAL OFFICE

122

CONFERENCE RM

116

GENERAL STORAGE

FILE ROOM

115

LOCKER ROOM

CORRIDOR

110


EXACT LOCATION AND CONTINUATION

PROCESSING AREA

3" V THRU WALL

GENERATOR

WOMEN'S RR

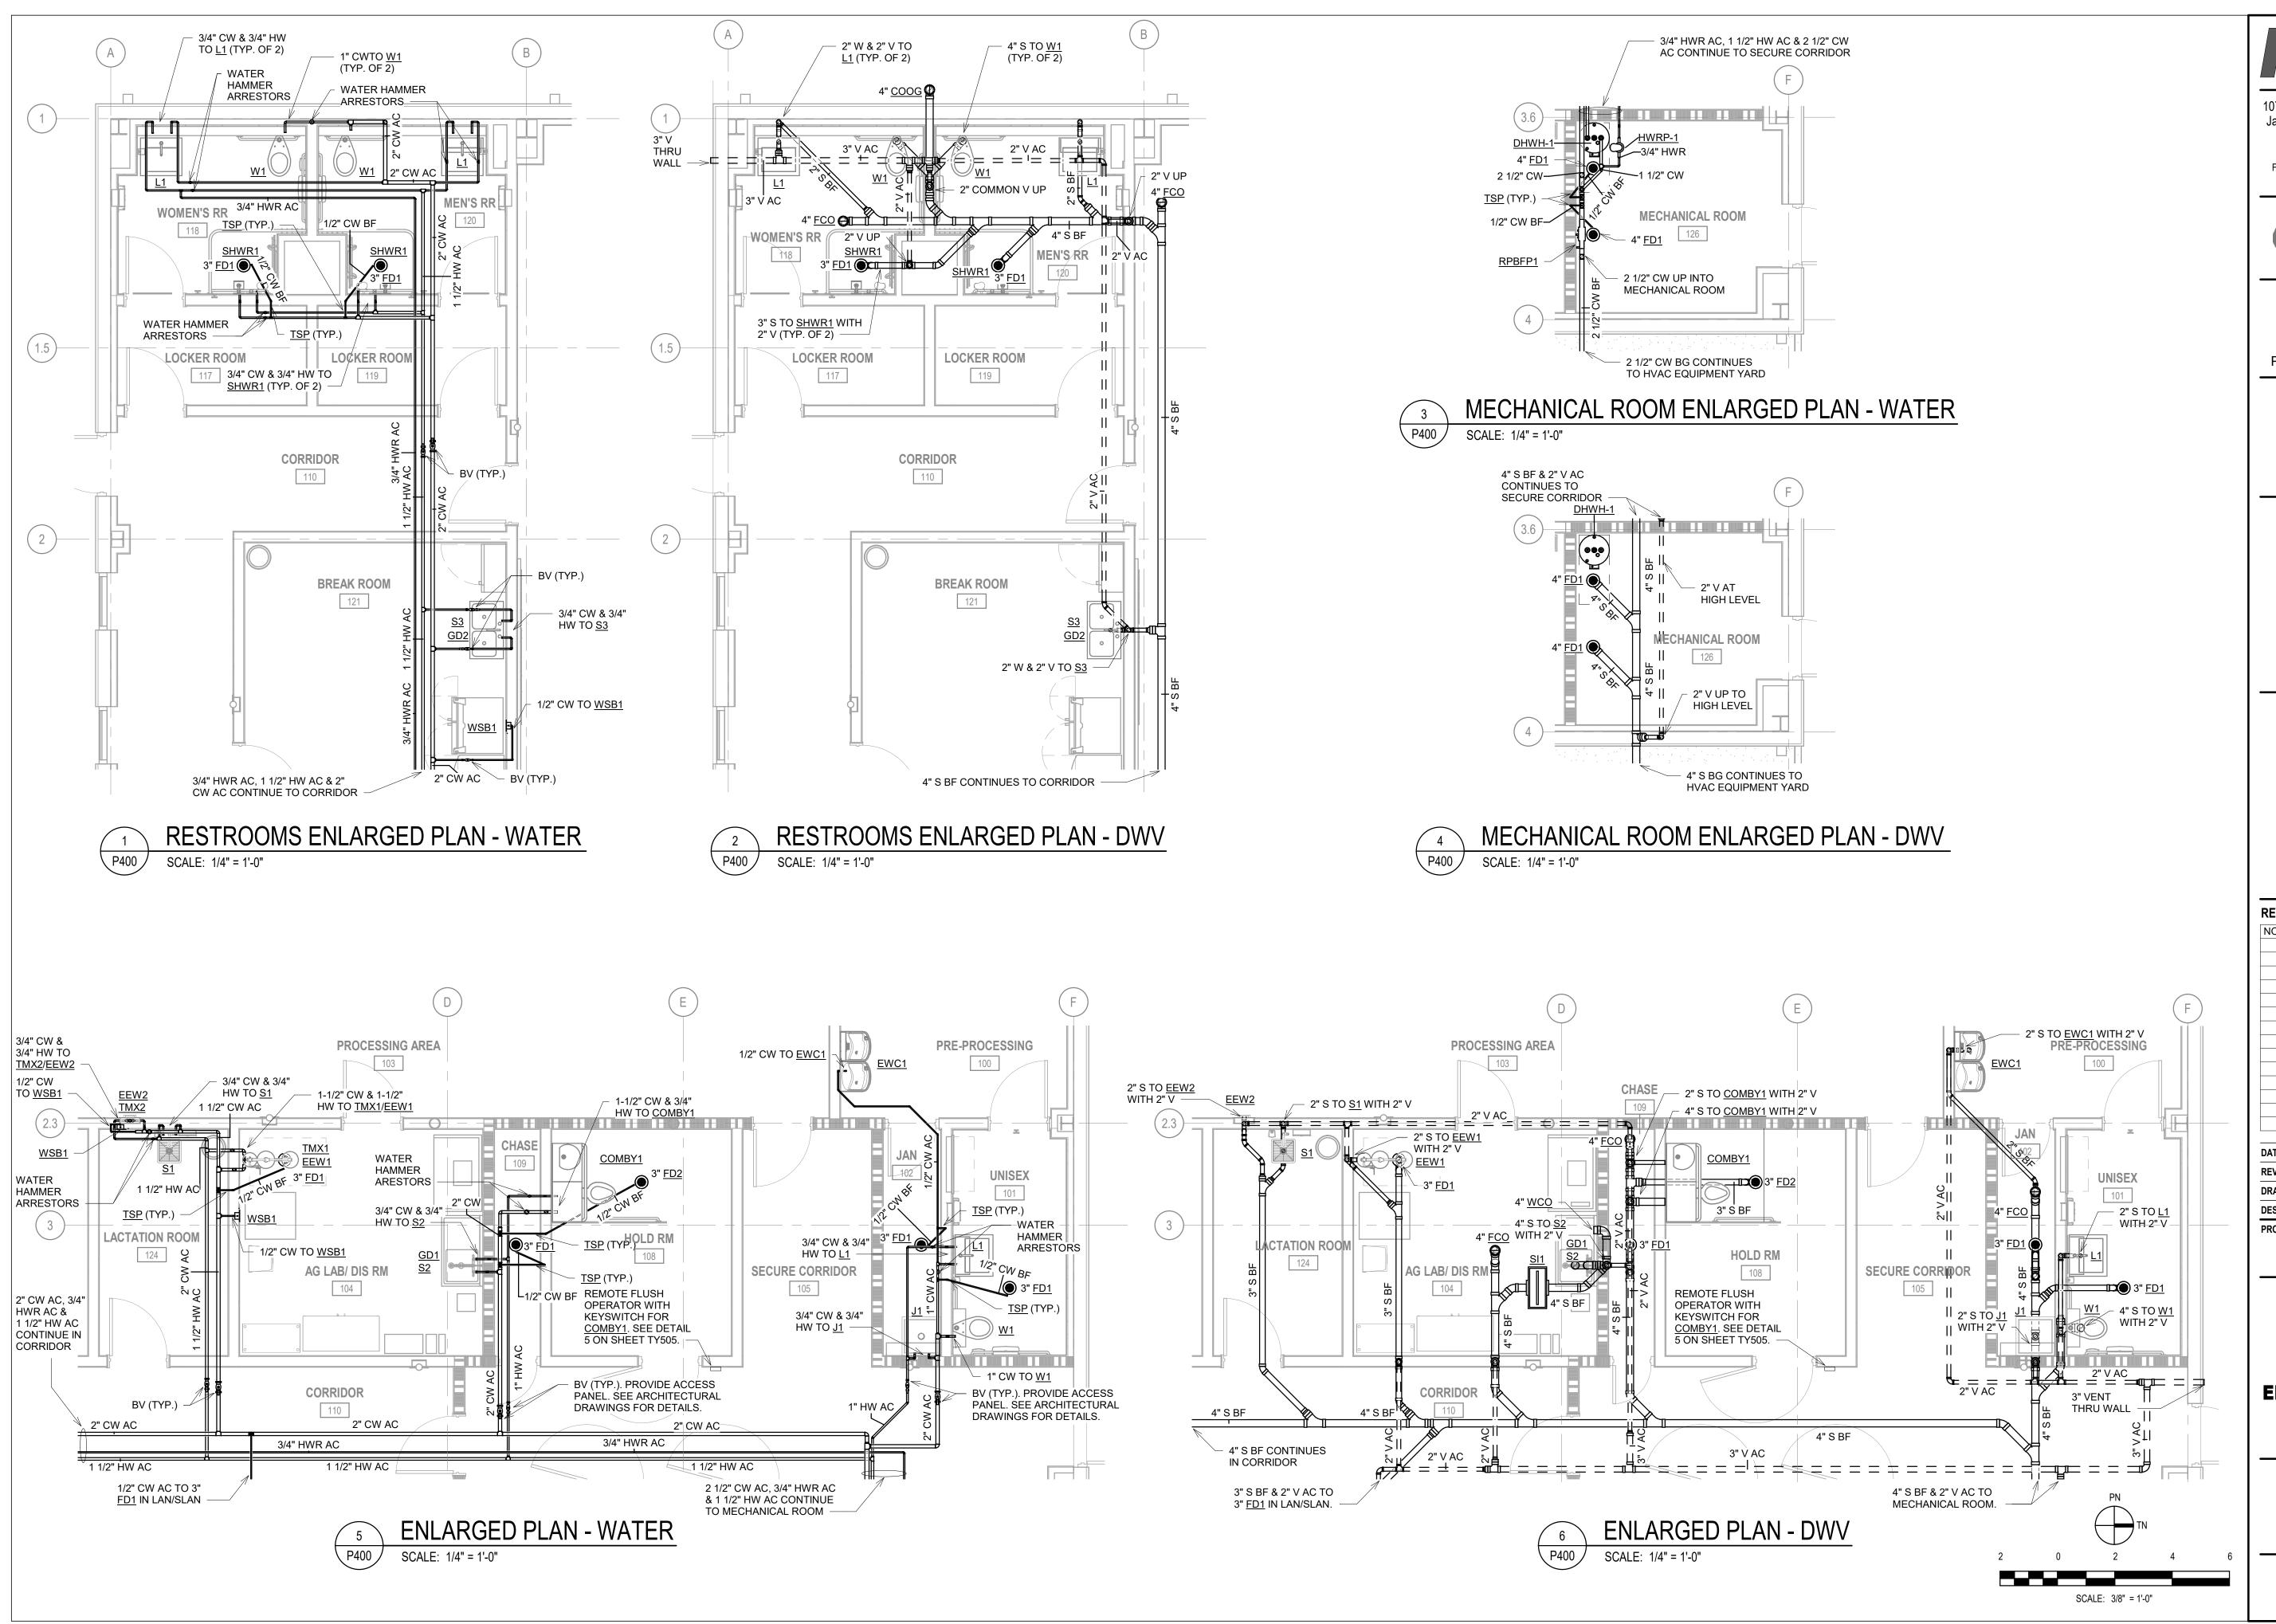

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PENSACOLA International Airport

INTERNATIONAL **AIRPORT**

PENSACOLA

PENSACOLA, FLORIDA

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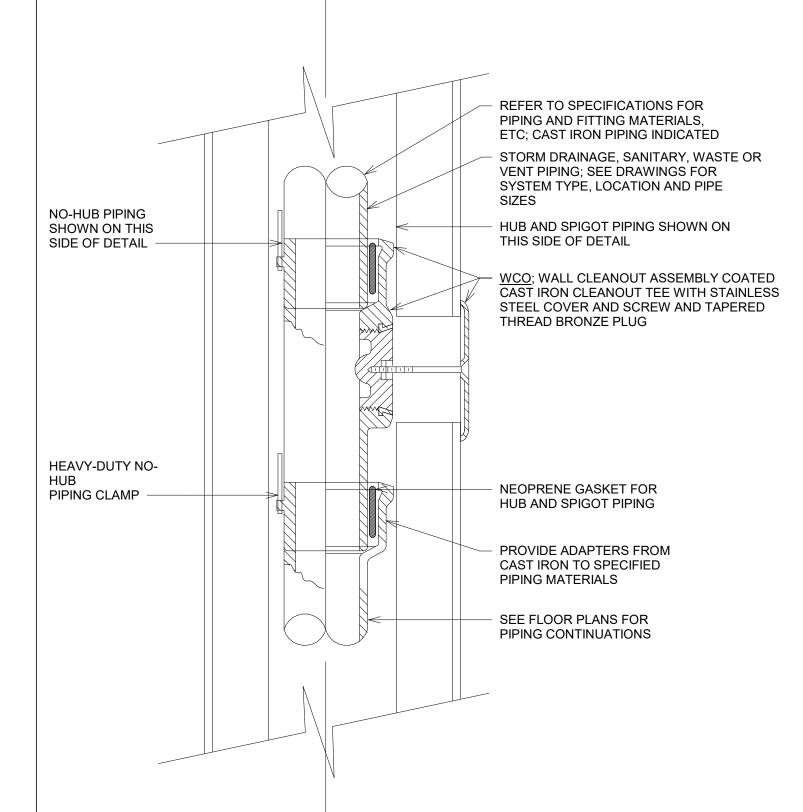
PLUMBING ENLARGED PLANS

SHEET NUMBER


P400


NOTE: ALL TSP IN ACCESSIBLE LOCATION. FOR CONCELAED CEILING SPACES, PROVIDE ACCESS PANEL

TRAP PRIMER DETAIL P500 SCALE: NONE




WALL CLEANOUT (WCO) ASSEMBLY
P500 SCALE: NONE

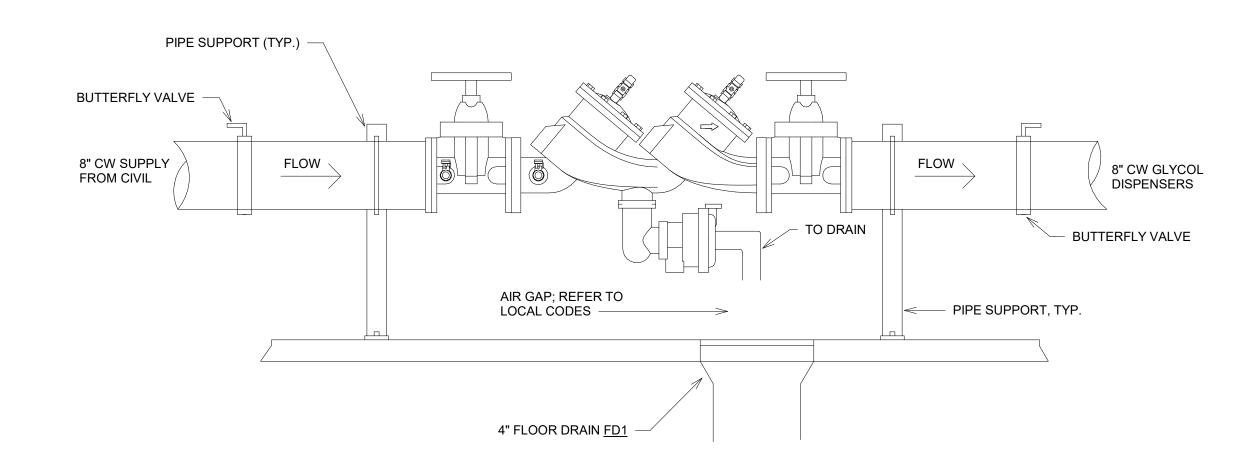

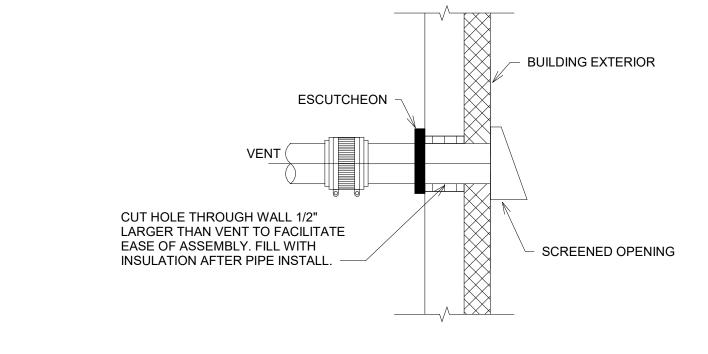


BACKFLOW PREVENTER DETAIL P500 SCALE: NONE

3 VENT THRU WALL
P500 SCALE: NONE

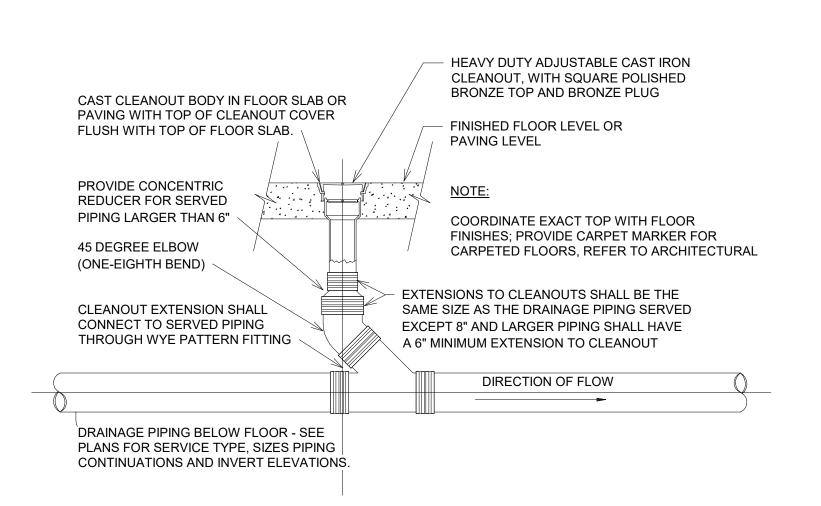



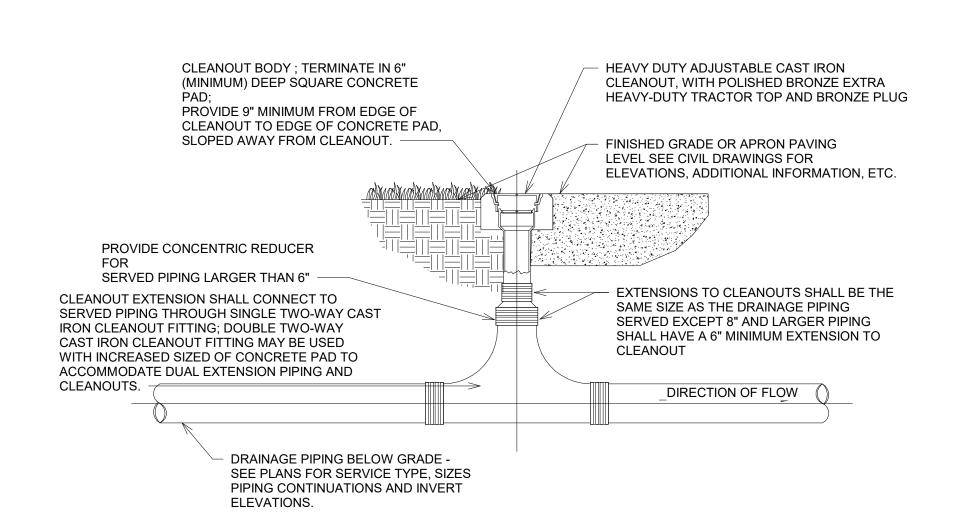

6 SCALE: NONE

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DATE ISSUED: 03/03/2020
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SHEET TITLE

PLUMBING DETAILS

SHEET NUMBER

P500


2" VENT TO CONNECT TO CENTRAL VENT PIPING <− WALL COUNTERTOP COORDINATE MOUNTING INSTALL OF GRINDER 4" CLEANOUT WITH SINK/MILLWORK. LOCATE SEDIMENT BUCKET MAY BE REMOVED -- GRINDER <u>GD-1</u> FLOOR 4" W BF SOLIDS INTERCEPTOR SI1

NATURAL GAS BRANCH FROM CIVIL SIZED FOR EQUIPMENT - NATURAL GAS VALVE (TYPICAL) TO EQUIPMENT - UNION - DRIP LEG PRESSURE REGULATOR

WATER HEATER PIPING DIAGRAM P501 SCALE: NONE

SOLIDS INTERCEPTOR DETAIL

NATURAL GAS CONNECTION DETAIL

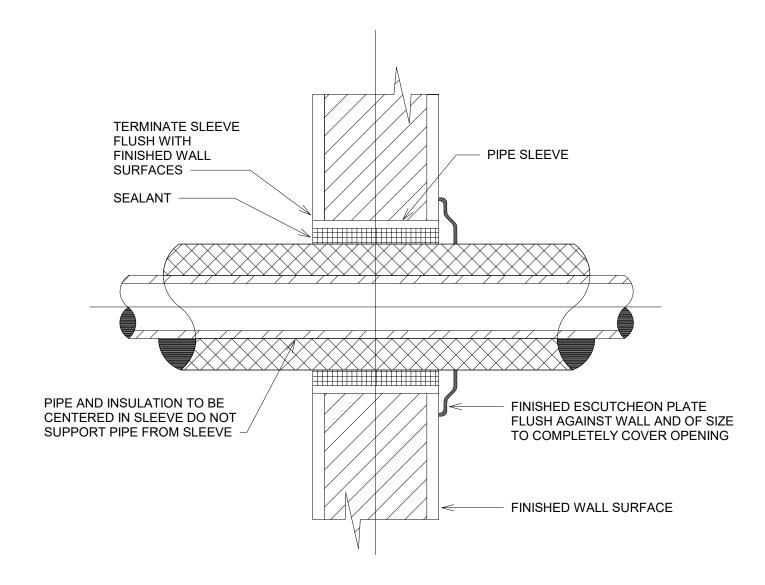

CAULK WITH USG ACOUSTICAL SEALANT PIPE SLEEVE (SCH. 40 PIPE) TIGHTLY PACK THE PIPE INSULATION ANNULAR SPACE WITH A FIRE SAFING MATERIAL 4" (TYP) → <− WALL

> PIPE INSULATION THROUGH CORRIDOR WALLS, SMOKE PARTITIONS, OR FIRE RATED WALLS SHALL BE NONCOMBUSTIBLE OR SHALL BE FIRE STOPPED.

PIPE SLEEVE THRU WALL

FIPE SLEEVE THRU FIRE RATED WALL



03/03/2020

KMD

JB/KMD

PLUMBING

DETAILS

SHEET NUMBER

P501

PLUMBING FIXTURE AND EQUIPMENT SCHEDULE

W1; KOHLER K-96057-0, ELONGATED, VITREOUS FLOOR MOUNTED WATER CLOSET WITH EXPOSED 1-1/2" REAR SPUD; CHURCH 295SSCT SOLID PLASTIC OPEN FRONT SEAT WITH SELF SUSTAINING STAINLESS STEEL CHECK HINGE; SLOAN ROYAL OPTIMA MODEL 110/111 ES-S SENSOR OPERATED 1.6 GPF WC FLUSH VALVE WITH 1-1/2" TOP SPUD COUPLING AND TWO WALL BUMPERS, SOLID RING PIPE SUPPORT IN CHASE. TOP OF BOWL IS 17" AFF. COLOR:

L1; LOVAIR LS MAXI SLAB SERIES 24"x24"x5" SOLID TROUGH SINK, SEE ARCHITECTURAL DRAWINGS FOR MORE INFORMATION. PROVIDE SLOAN OPTIMA PLUS EBF85-4 BATTERY POWERED WITH PLUG IN TRANSFORMER ADA ELECTRONIC SENSOR MIXING FAUCET 0.5 GPM, BOBRICK B-824 LIQUID SOAP DISPENSER WITH POWERS LM495-1 LAVATORY THERMOSTATIC MIXING VALVE, 2.2 GPM AERATOR, SLOAN ETF-460A 1-1/2" CHROME PLATED BRASS GRID STRAINER WITH OFFSET TAILPIECE; PROVIDE McGUIRE PW 2125 SEAMLESS PRE-WRAPPED DRAIN ASSEMBLY WITH 1-1/2"x8-1/2" WALL BEND, CHROME PLATED CAST BRASS 1-1/2" TRAP WITH CLEANOUT AND (2) SUPPLY COVERS AND (2) H2165LK-F-N3-HC1-R20 HEAVY DUTY, POLISHED CHROME PLATED SUPPLY VALVES (2) WITH LOOSE KEY OPERATOR, HEAVY CAP, 3" CAST BRASS NIPPLE, HEAVY BRASS FLANGE WITH SET SCREW AND 20" LONG CHROME PLATED ANNEALED TUBE OFFSET RISERS (CUT TO LENGTH BY CONTRACTOR PER MANUFACTURERS PUBLISHED DATA). ADJUST FAUCET TO OPERATE FOR 15 SECONDS UPON ACTIVATION. INSTALL FAUCET WITHOUT TRIM PLATE FOR SINGLE HOLE INSTALLATION. PROVIDE ASSE 1070 TEMPERATURE LIMITING DEVICE SET AT A MAX 105° F.

<u>J1</u>; FIAT TSB-3000, 24"x24"x12" DEEP PRECAST TERRAZO MOP SERVICE BASIN WITH SS STRAINER DRAIN, SS CAPS ON ALL CURBS, MSG-2424 SS WALL GUARD ON WALLS IN CONTACT WITH BASIN; T&S BRASS B-0665-BSTR ROUGH CHROME PLATED SERVICE FAUCET WITH INTEGRAL STOPS, VACUUM BREAKER, WALL BRACE, PAIL HOOK AND 3/4" HOSE THREADS ON OUTLET WITH HOSE AND HOSE BRACKET; SILICONE SEALANT; SS STRAINER; ALUMINUM BUMPERGUARD PLATE WITH VINYL INSERT; 24"x3" SS 3-STATION MOP HANGER; PROVIDE WITH SMITH 7230S 3" CAST IRON DEEP SEAL TRAP & QUICK DRAIN CONNECTOR FOR SERVICE WEIGHT CAST IRON.

EWC1; ELKAY EZSTL8WSLK WITH EZH20 BOTTLE FILLER STATION WITH FILTERED BI-LEVEL LZ COOLER; ADA COMPLIANT, CERTIFIED TO ANSI./NSF SECTION 9, BARRIER FREE, LEAD FREE, CFC FREE, WALL MOUNTED ELECTRIC WATER COOLER WITH WATERSENTRY VII WATER & LEAD FILTER SYSTEM. PROVIDE WITH McGUIRE H2165LK-F-N3-HC1-R20 HEAVY DUTY, POLISHED CHROME PLATED SUPPLY VALVE WITH LOOSE KEY OPERATOR, HEAVY CAP, 3" CAST BRASS NIPPLE, HEAVY BRASS FLANGE WITH SET SCREW AND 20" LONG CHROME PLATED ANNEALED TUBE OFFSET RISER (CUT TO LENGTH BY CONTRACTOR PER MANUFACTURERS PUBLISHED DATA) AND (2) 11/4" CAST BRASS TRAP WITH CLEANOUT ADN SEMI-CAST TAILPIECE. PROVIDE WITH WATER AND LEAD FILTERS; MINIMUM CAPACITY OF 8.0 GPH OF 50° F WATER WITH A 70° F AMBIENT TEMPERATURE.

S1; KOHLER K-5287 COUNTERTOP UNDERMOUNT BAR SINK WITH K-8801 SINK STRAINER. PROVIDE WITH K-22034 SIMPLICE BAR SINK FAUCET SWING SPOUT. PROVIDE ASSE 1070 TEMPERATURE LIMITING DEVICE SET AT A MAX 105° F.

S2; AERO MF1L SERIES MODEL NUMBER MF1-2020-20L, ONE COMPARMENT WITH LEFT DRAINBOARD. PROVIDE T&S BRASS AND BRONZE WORKS FAUCET MODEL NUMBER B-0133-CR-B8SWX; PRE-RINSE UNIT: EASY INSTALL 8" WALL MOUNT MIXING FAUCET, 32" FLEXIBLE STAINLESS STEEL HOSE, 4" DRAIN OUTLET. PROVIDE ASSE 1070 TEMPERATURE LIMITING DEVICE SET AT A MAX 105° F.

S3: KOHLER VERSE K-5267-3 DOUBLE BOWL STAINLESS STEEL SINK. PROVIDE AMERICAN STANDARD MONTERREY TWO-HANDLE TOP-MOUNT KITCHEN FAUCET WITH RIGID/SWIVEL GOOSENECK SPOUT WITH 8" REACH (MODEL NUMBER 6409.170). PROVIDE ASSE 1070 TEMPERATURE LIMITING DEVICE SET AT A MAX 105° F.

GD1; INSINKERATOR SS-300 LARGE CAPACITY FOOD WASTE DISPOSER WITH #5 SINK FLANGE KIT, 3HP, 480V, 3 PHASE. PROVIDE EMERGENCY STOP FOR DISPOSER WITHIN CLOSE PROXIMITY.

<u>GD2;</u> INSINKERATOR EVOLUTION SERIES FOOD WASTE DISPOSER, 3/4 HP, 120V, 1 PHASE. PROVIDE EMERGENCY STOP FOR DISPOSER WITHIN CLOSE PROXIMITY.

SHWR1; MOEN POSI-TEMP SHOWER SYSTEM INCLUDING THE FOLLOWING MOEN SHOWER PRODUCTS: S3879EP HAND SHOWER WITH SLIDE BAR, TS2712 SHOWER HEAD WITH PRESSURE BALANCED VALVE TRIM, TS4172 DIVERTER VALVE TRIM, A721 WALL SUPPLY ELBOW, 2570 PRESSURE BALANCED ROUGH-IN VALVE, AND 3372 DIVERTER VALVE. RATED FOR 2.5 GPM. SHALL FEATURE A WALL SUPPLY WITH 3/4" NPT FEMALE INLETS AND 3/4" NPSM MALE OUTLET. USE 3" FD1 FOR SHOWER DRAIN.

COMBY1; WILLOUGHBY 3696 SERIES ADA COMPLIANT COMBINATION UNIT INCLUDING THE FOLLOWING OPTIONS: ECW WALL OUTLET, OFFSET LEFT, 1.6 GPF, PZPB LIGATURE-RESISTANT PIEZO ELECTRONIC PUSH BUTTON, PT INTEGRAL 'P'-TRAP (1-1/2" PLAIN END), TWE TOILET WASTE EXTENSION, GB4296 42" ADA GRAB BAR: ASGB AND LVCP AND EFVP ELECTRONIC FLUSH VALVE WITH (PZPB) (PICK CONTROL) OPTION. REAR ACCESS WITH REMOTE MANUAL PIEZO ELECTRIC TYPE FLUSH VALVE CONTROL TO BE INSTALLED OUTSIDE OF THE ROOM IN SECURE CORRIDOR ADJACENT TO HOLD ROOM

<u>FD1</u>; STANDARD FLOOR DRAIN, SMITH 2005YB-G-L-B-P050-U-SS FLOOR DRAIN WITH 5" SQUARE STAINLESS STEEL ADJUSTABLE STRAINER HEAD SECTION; GALVANIZED GRAY IRON BODY WITH FLASHING COLLAR, SERVICE WEIGHT GASKET (UNDERGROUND CONNECTION) OR NO-HUB OUTLET (ABOVEGROUND CONNECTION), SEDIMENT BUCKET, VANDAL PROOF SCREWS AND 1/2" TRAP PRIMER TAP. WITH 3" OR 4" OUTLET (OUTLET PIPE SIZE INDICATED FOR EACH DRAIN ON THE DRAWINGS). PROVIDE WITH SMITH 7222S-03(4)-BP-ARI 3" OR 4" DIAMETER CAST IRON TRAP WITH ACID RESISTANT COATING INSIDE, BRONZE CLEANOUT PLUG AND 5" DEEP WATER SEAL.

FD2; SMITH 2410-U TRAFFIC FLOOR DRAIN WITH SQUARE TOP AND FREE STANDING SEDIMENT BUCKET. VANDAL PROOF GRATE.

COOG; WADE 800-12 ADJUSTABLE FLOOR & GRADE CLEANOUT WITH 4" OUTLET.

<u>EEW1</u>; GUARDIAN GBF1994 OR APPROVED EQUAL. ALL STAINLESS STEEL BARRIER-FREE SAFETY STATION WITH WIDE AREA EYE/FACE WASH. ADA COMPLIANT. 10" DIAMETER STAINLESS STEEL SHOWER HEAD. PROVIDE ANSI-COMPLIANT IDENTIFICATION SIGN. PROVIDE THERMOSTATIC MIXING VAVLE <u>TMX1</u>. SET WATER TEMPERATURE TO 90 DEGREES F (TEPID) TO SATISFY ANSI/ISEA Z358.1 TEPID WATER REQUIREMENTS.

<u>EEW2</u>; GUARDIAN GBF1735DP SWING-DOWN EYE/FACE WASH WITH DRAIN PAN, RECESSED MOUNTED. PROVIDE THERMOSTATIC MIXING VAVLE <u>TMX2</u>. SET WATER TEMPERATURE TO 90 DEGREES F (TEPID) TO SATISFY ANSI/ISEA Z358.1 TEPID WATER REQUIREMENTS.

TMX1; GUARDIAN G3800 LF THERMOSTATIC MIXING VAVLE.

TMX2; GUARDIAN G3600 LF THERMOSTATIC MIXING VAVLE.

RPBFP1; FEBCO LEAD FREE SERIES LF860 2-1/2" REDUCED PRESSURE BACKFLOW PREVENTER.

WSB1; GUY GRAY #BIM875AB OR APPROVED EQUAL (LEAD-FREE VALVE) GALVANIZED STEEL WALL BOX WITH ANGLE VALVE FOR REFRIGERATOR SUPPLY. MOUNT IN CONCEALED ACCESSIBLE LOCATION (1/2" CW INLET, 3/8" COMPRESSION FITTING OUTLET).

<u>FCO;</u> ZURN NO. ZN-1400-X OR APPROVED EQUAL CAST IRON CLEANOUT WITH ROUND NICKEL BRONZE TOP WITH TILE RECESS VERIFY TOP FINISHES WITH AN ARCHITECT.

WCO; ZURN Z1446 DURA-COATED CAST IRON BODY WITH COUNTER-SUNK PLUG. PROVIDE STAINLESS STEEL ACCESS COVER.

SI1; MIFAB MODEL MI-SOLID-TA-8-SS SOLID INTERCEPTOR, 18 GAUGE TYPE 304 STAINLESS STEEL BODY, INTERNAL PERFORATED SEDIMENT BUCKET ANDE GASKETED TOP ACCES LID.

YD1; NDS 900MTLKIT 9" x 9" CATCH BASIN KIT WITH GALVANIZED STEEL GRATE, 4" OUTLET.

MX1; THERMOSTATIC MIXING VALVE ASSEMBLY CAPABLE OF 25 GPM RECIRCULATION AT 10 PSI PRESSURE DROP. VALVE SUPPLIED PRE-PIPED WITH HOT INLET, COLD INLET, MIXED WATER OUTLET, SIGHT FLOW INDICATOR AND OUTLET THRMOMETER.

PLUMBING FIXTURE AND EQUIPMENT SCHEDULE AND ROUGH-IN SCHEDULE

		ROUGH	-IN SIZE	S IN INC	CHES(1)	
MARK	TYPE OF PLUMBING FIXTURE	CW	HW	V	s	DESCRIPTION OF FIXTURE AND ACCESSORIES (2)
<u>W1</u>	WATER CLOSET	1	-	2	4	WALL MOUNT, ELONGATED, FLUSH VALVE
COMBY1	WATER CLOSET/LAV	1-1/2	3/4	2	4	COMBINATION TOILET/LAVATORY W/ REMOTE FLUSHING
<u>L1</u>	LAV, SENSOR FAUCET / SOAP DISPENSER COMBO	3/4	3/4	2	2	SOLID POLYMER ADA COMPLIANT LAV WITH SPLASHGUARD
<u>J1</u>	TERRAZO MOP SERVICE BASIN	3/4	3/4	2	2	SS STRAINER DRAIN AND SS CAPS ON ALL CURBS, SS WALL GUARD
EWC-1	WALL MOUNTED ELECTRIC WATER COOLER	1/2	-	2	2	ADA COMPLIANT
<u>S1</u>	BAR SINK	3/4	3/4	2	2	ADA COMPLIANT, SINGLE COMPARTMENT
<u>S2</u>	316 STAINLESS STEEL 18 GA. SINK	3/4	3/4	4	2	ADA COMPLIANT, DOUBLE COMPARTMENT, WITH DRAINBOARDS
<u>S3</u>	316 STAINLESS STEEL 18 GA. SINK	3/4	3/4	2	2	ADA COMPLIANT, DOUBLE COMPARTMENT
EEW1	EMERGENCY EYEWASH AND SHOWER	1-1/2"	1"	-	-	EYEWASH AND SHOWER
EEW2	EMERGENCY EYEWASH	3/4	3/4	-	-	EYEWASH
SHWR1	SHOWER	3/4	3/4	2	3	SHOWER VALVE SYSTEM WITH HAND HELD ADA COMPLIANT SHOWER HEAD
NOTE	<u> </u>	•			•	

NOTES

- 1. SIZE GIVEN IS MINIMUM UNLESS OTHERWISE NOTED OR SHOWN ELSEWHERE.
- 2. REFER TO P001 AND SPECIFICATIONS FOR ADDITIONAL INFORMATION AND MODEL NUMBERS AND ARCHITECTURAL ELEVATIONS FOR ADDITIONAL MOUNTING HEIGHT INFORMATION.

WATER HAMMER ARRESTER SCHEDULE

MARK	P.D.I. RATING	FIXTURE UNITS CAPACITY	MINIMUM PIPE SIZE	PCN/FIG. NO.	NOTES
<u>WA</u>	Α	1 - 11	3/4"	5005	1,2,3
<u>WB</u>	В	12 - 32	1"	5010	1,2,3
<u>WC</u>	С	33 - 60	1"	5020	1,2,3
<u>WD</u>	D	61 - 113	1"	5030	1,2,3
<u>WE</u>	E	114 - 154	1"	5040	1,2,3
<u>WF</u>	F	155 - 330	1"	5050	1,2,3

NOTES:

- 1. PROVIDE ARRESTERS ETC., AS NOTED HEREIN AND PER STANDARD PDI WH201 AT EACH FIXTURE GROUP AND INDIVIDUAL FIXTURE. ARRESTERS SHALL BE AS MANUFACTURED BY JAY R. SMITH, OR APPROVED EQUAL. INSTALL ARRESTERS WHERE SHOWN, IF INDICATED. ARRESTERS MAY NOT BE GRAPHICALLY INDICATED. INSTALL ARRESTERS, ETC., CONCEALED BEHIND WALLS UNLESS OTHERWISE NOTED. INTALL WATER HAMMER ARRESTOR AT LOCATION PER MANUFACTURER STANDARD.
- 2. ARRESTERS SHALL BE STAINLESS STEEL BELLOWS TYPE CERTIFIED UNDER STANDARDS PDI-WH201 & ASSE-1010, SUPERSEDING SPECIFICATIONS; PISTON TYPE ARRESTERS ARE UNACCEPTABLE. ARRESTERS SHALL BE CONSTRUCTED ENTIRELY OF STAINLESS STEEL AND BE PRECHARGED AND PERMANENTLY SEALED AT THE FACTORY.
- 3. PROVIDE BALL VALVE (BV) BETWEEN SUPPLY PIPE & ARRESTER. ARRESTERS AND BV SHALL BE ACCESSIBLE. PROVIDE AP WHERE REQUIRED TO ACHIEVE ACCESS. ACCESS PANELS SHALL BE AS MANUFACTURED BY MIFAB OR APPROVED EQUAL, SERIES CAD-DW, CAD-PL OR MPFR FOR WALLS OR CEILINGS.

TRAP SEAL PRIMER AND DISTRIBUTION UNIT SCHEDULE

	I			I	
MARK	DRAINS	MIFAB MODEL NUMBER	INLET NPT	OUTLET NPT	NOTES
		/ 1		00.12	
TSP	1	M2-500-RFS	1/2	1/2	1,2,3,4
101		IVIZ-300-IXI O	1/2	1/2	1,2,5,4
TSPDU3	2	M2-500-RFS AND MI-DU	1/2	1/2	1 2 2 4
135003	3	IVIZ-300-RES AIND IVII-DU	1/2	1/2	1,2,3,4
TODDIJE	6	MD 500 DEC AND (2) MI DII	1/2	1/2	1 2 2 4
TSPDU6	O	MR-500-RFS AND (2) MI-DU	1/2	1/2	1,2,3,4

NOTE

- 1. ALL FLOOR DRAINS (EXCEPT MOP BASINS AND FLOOR SINKS) SHALL BE PRIMED. INSTALL ALL COMPONENTS OF PRIMING SYSTEM IN STRICT ACCORDANCE WITH THE FLRODA BUILDING CODE 2017- SIXTH EDITION. DRAINS IN TOILET ROOMS SHALL BE PRIMED VIA FLUSH VALVE TYPE PRIMER (UON) LOCATED IN SAME SPACE AS DRAIN. OTHER DRAINS SHALL BE PRIMED VIA PRIMING VALVES AND DISTRIBUTION UNITS (UON), AS INDICATED OR AS REQUIRED WHERE NOT SHOWN. UON PRIMERS SHALL BE ACTIVATED BY A PRESSURE DROP OF 3 PSI MINIMUM. PRIMERS SHALL BE TESTED AND CERTIFIED TO ASSE STANDARD 1018 AND LISTED WITH IAPMO. DISTRIBUTION UNITS SHALL BE LISTED WITH IAPMO. INSTALL IN STRICT COMPLIANCE WITH MANUFACTURERS WRITTEN INSTRUCTIONS. INSTALL PRIMERS IN EASILY ACCESSIBLE LOCATIONS. PRIMERS SHALL NOT REQUIRE ANY FIELD ADJUSTMENTS.
- 2. UNITS SHALL BE CAPABLE OF PROPER FUNCTION WHEN INSTALLED OUT OF PLUMB OR LEVEL. A METERED AMOUNT OF WATER SHALL BE DISTRIBUTED TO SINGLE AND MULTIPLE DRAINS EQUALLY AND UNIFORMLY. PROVIDE WITH REMOVABLE FILTER SCREEN. OPERATING RANGE 20 PSI TO 80 PSI.
- PRIMER OPERATION SHALL BE VERIFIABLE VIA INSPECTION THROUGH PORTS AT THE DISCHARGE SECTION WHICH PASS THROUGH THE ENTIRE DEVICE TO ALLOW LIGHT TO PASS THROUGH TO EASE VERIFICATION OF OPERATION. SECURE AND PROTECT PIPING FROM DAMAGE AND THE ENTRANCE OF DEBRIS DURING CONSTRUCTION. THOROUGHLY FLUSH ALL PIPING AND PRE-CYCLE PRIMERS AT LEAST SIX TIMES AND VERIFY PROPER OPERATION.
- 3. ALL FLOOR DRAINS SHALL BE PRIMED UNLESS OTHERWISE NOTED. TRAP SEAL PRIMERS AND DISTRIBUTION UNITS SHALL BE AS MANUFACTURED BY MIFAB OR APPROVED EQUAL MEETING ALL THE REQUIREMENTS HEREIN. EXPOSED PIPING BELOW LAVATORIES AND IN FINISHED SPACES SHALL BE CHROMIUM PLATED OR STAINLESS STEEL TUBING.

ELECTRIC WATER HEATER SCHEDULE

MARK	SHEET#	ROOM#	STORAGE CAP GALLONS	RECOVERY GPH/ 1st HOUR	EWT °F	LWT °F	TEMP. RISE	# OF ELEMENTS	TOTAL KW	INLET SIZE	OUTLET SIZE	ELECT. V/PH/HZ	SEE NOTES
DHWH-1	P100	126/MECH.	120	68	66° F	140° F	74° F	2	12	3/4"	3/4"	480/3/60	1

NOTES

- 1. BASIS OF DESIGN AO SMITH DEN-120, 12 kW TOTAL SIMULTANEOUS OPERATION 120 GALLON COMMERCIAL ELECTRIC WATER HEATER, ELEMENT WATTAGE (UPPER/LOWER): 6000/6000. GLASSLINED TANK RATED AT 150 PSI WORKING PRESSURE; SURFACE MOUNTED THERMOSTAT, TWO ANODE RODS FOR MAXIMUM CORROSION PROTECTION; BRASS DRAIN VALVE; SINGLE PANEL CONTROL BOX; FOAM INSULATION; 3 YEAR LIMITED TANK/1 YEAR LIMITED PARTS WARRANTY.
- 2. PROVIDE DRAIN PAN WITH FLOAT SWITCH THAT SENDS ALARM TO BAS TO SHUT DOWN THE WATER HEATER.

PLUMBING RECIRC PUMP SCHEDULE

MARK	SERVICE	CONTROL ON	CONTROL OFF	GPM	TDH (FT)	RATED OPERATION PRESSURE	HP	VOLTAGE	PHASE	CYCLES	NOTES
HWRP-1	RECIRC.	AQUASTAT (110° F)	AQUASTAT (120° F)	5	32	145	1/6	115	1	60	1

1. ALL BRONZE CONSTRUCTION. BASIS OF DESIGN: GRUNFOS #UP26-99BF. REFER TO SPECIFICATIONS.

ACCEPTABLE MANUFACTURERS OF EQUIVALENT PRODUCTS

THIS SCHEDULE TAKES PRECEDENCE WHEN CONFLICTING WITH SPECIFICATIONS

SUBJECT TO COMPLIANCE WITH REQUIREMENTS, PROVIDE SUBMITTAL DATA FOR APPROVAL OF EQUIVALENT PRODUCTS BY ONE OF THE FOLLOWING MANUFACTURERS FOR EACH ITEM GROUP LISTED:

VITREOUS CHINA AND ENAMELED CAST IRON PLUMBING FIXTURES: KOHLER

SOLID POLYMER LAVATORY AND COUNTERTOP: CORIAN

FLUSH VALVES: SLOAN ROYAL. LAVATORY FAUCETS: SLOAN.

SINK FAUCETS AND DRAIN TRIM: KOHLER

MOP BASIN FAUCET, MOP HANGER, HOSE & CLAMP: FIAT.

TERRAZO JANITOR'S MOP BASINS: FIAT.

ADA, 18 GAUGE TYPE 316 STAINLESS STEEL SINKS: JUST TYPE 316 STAINLESS STEEL WITH OVERFLOW

ELECTRIC WATER COOLERS: HALSEY TAYLOR

FIXTURE SUPPLY VALVES, AND CAST BRASS TRAPS: McGUIRE

FLOOR DRAINS, FLOOR SINKS, ROOF DRAINS, CLEANOUTS, CAST IRON TRAPS AND DRAINAGE SPECIALTIES: SMITH, JOSAM

WATER HAMMER ARRESTERS: SMITH, JOSAM, WADE

VALVES: CRANE VALVE CO., MILWAUKEE, STOCKHAM, HONEYWELL

FIXTURE CARRIERS AND SUPPORTS: SMITH, JOSAM, WADE PRE-WRAPPED HANDICAPPED LAVATORY AND SINK DRAIN AND SUPPLY INSULATION KITS: McGUIRE.

ADA VINYL SHIELDS FOR WALL MOUNT LAVATORIES & SINK WHEELCHAIR SAFETY PROTECTION ASSEMBLIES: SLOAN. WATER HEATERS: PVI, AO SMITH (SEE SCHEDULE RQMTS.), BRADFORD WHITE (SEE SCHEDULE RQMTS.)

WATER HEATERS: PVI, AO SMITH (SEE SCHEDULE RQMTS.), BRADFORD WHITE (SEE SCHEDULE RQMTS.)
DIGITAL ELECTRONIC MIXING VALVE ASSEMBLIES WITH INTEGRAL RECIRCULATION PUMP: ARMSTRONG.

ELECTRIC HEATING CABLES, TRIM AND ACCESSORIES: RAYCHEM, THERMON.

UTILITY HYDRANTS, WALL HYDRANTS AND YARD HYDRANTS: SMITH, JOSAM, WOODFORD

BELOW COUNTER THERMOSTATIC MIXING VALVES: POWERS, LEONARD VENT THRU ROOF AND FLASHING ASSEMBLIES: STONEMAN

VENT THRU ROOF AND FLASHING ASSEMBLIES: STONEMAN FIRESTOPPING SYSTEMS: RECTORSEAL, METACAULK FIRESTOPPING PRODUCTS, OR APPROVED EQUAL.

PIPING HANGERS AND SUPPORT SYSTEMS: B-LINE OR APPROVED EQUAL.

ACCESS PANELS (AP): MIFAB CAD-DW, CAD-PL, MPFR SERIES, OR APPROVED EQUAL.

VALVE BOXES (<u>VB</u>): MIFAB MI-VB-SM-SS.

PRE-INSULATED, PRE-FABRICATED UNDERGROUND COPPER PIPING; BRAZED WITH PVC JACKETING: THERMACOR PROCESS INC.

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PROFESSIONAL SEAL



NO. DESCRIPTION D

DATE ISSUED:	03/03/2020
REVIEWED BY:	JB
DRAWN BY:	KMD
DESIGNED BV:	IR/KMD

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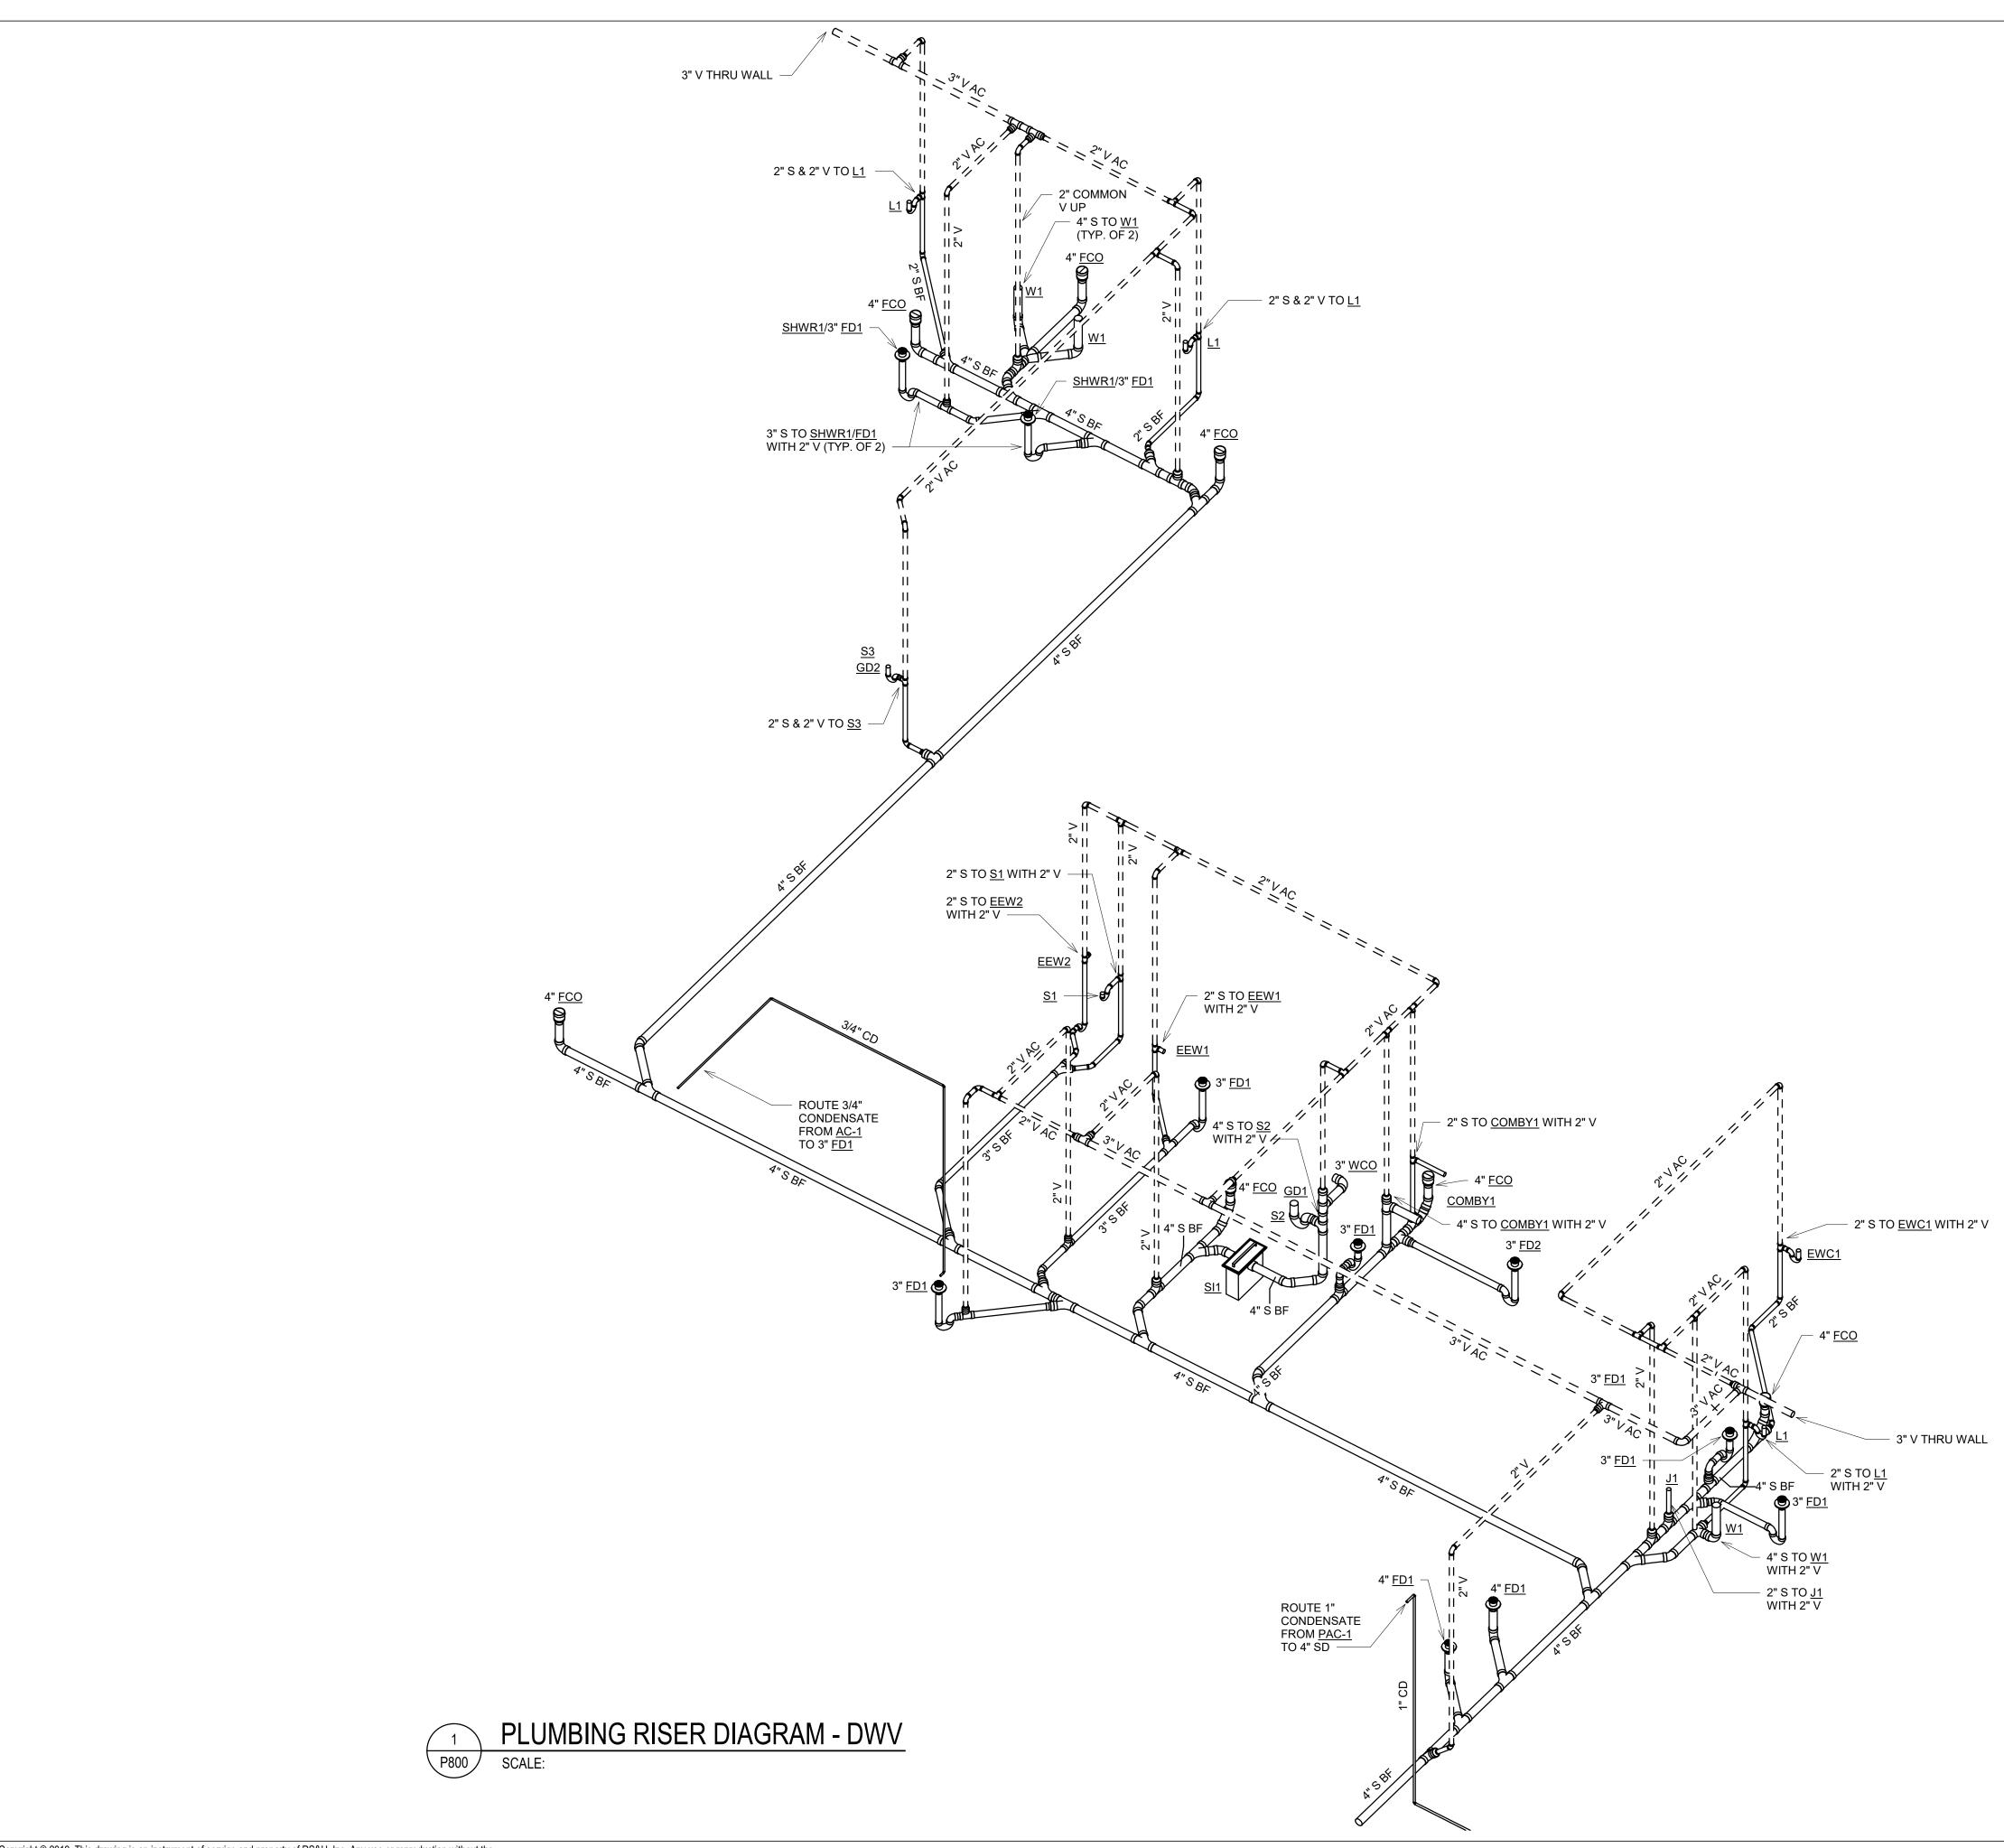
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SHEET TITLE

PLUMBING SCHEDULES

SHEET NUMBER

P600





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DRAW	N BY:	KMD

REVISIONS

DESIGNED BY:
PROJECT NUMBER:
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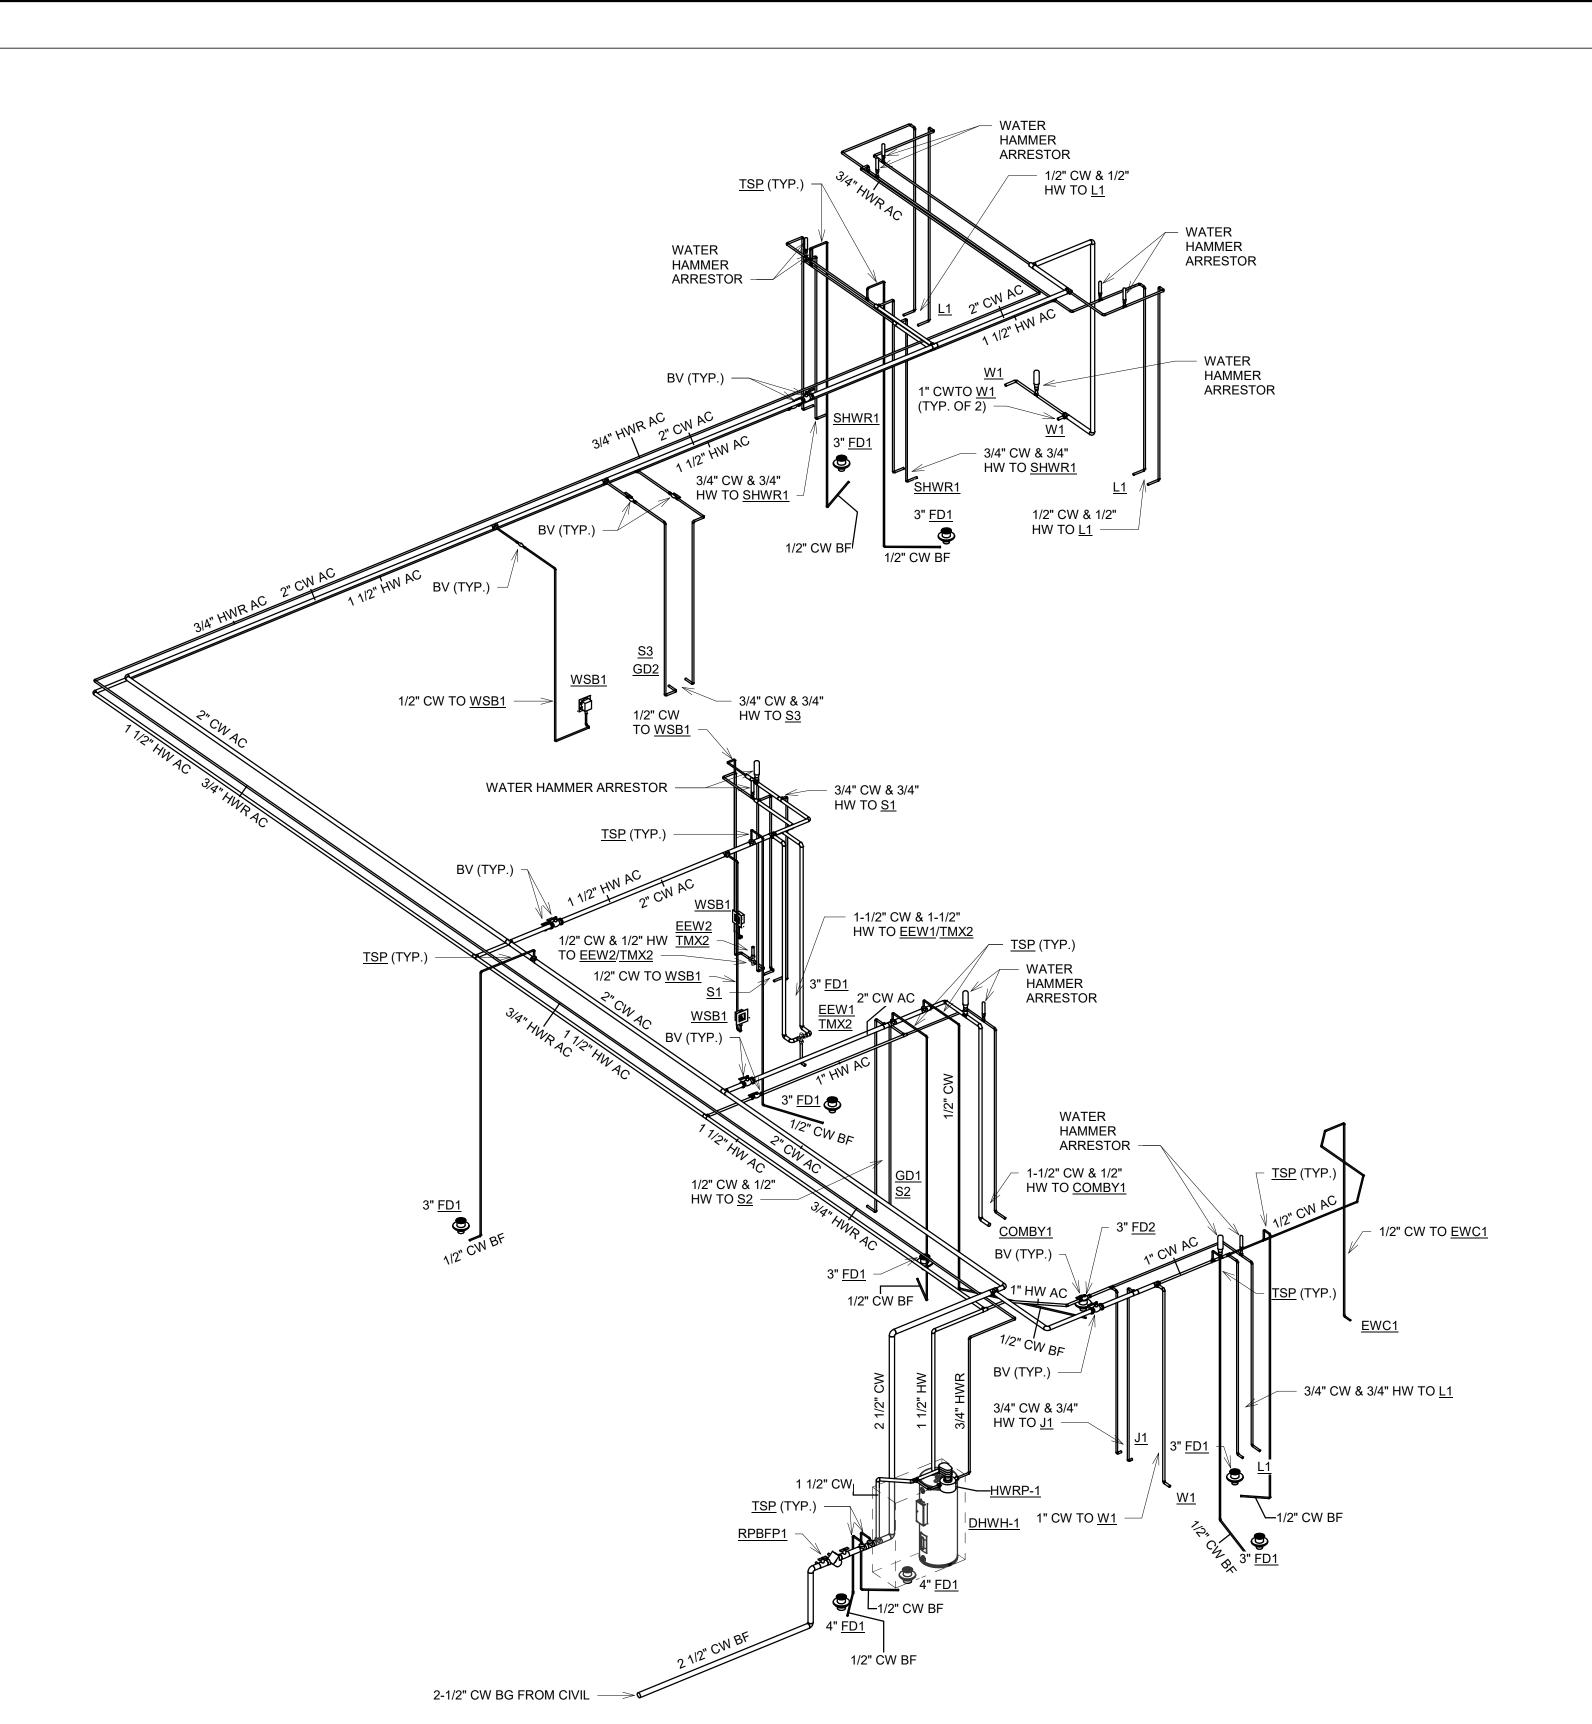
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PLUMBING RISER

DIAGRAM - DWV

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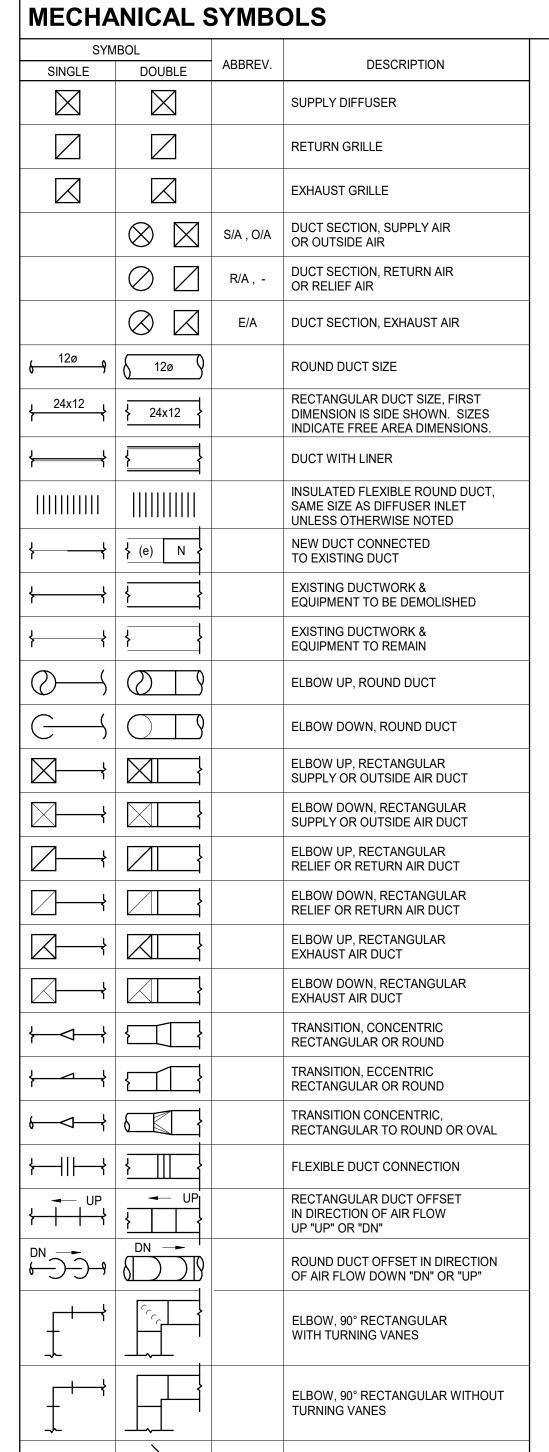
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SHEET TITLE

PLUMBING RISER DIAGRAM - WATER

SHEET NUMBER

P801



SYMBOL DESCRIPTION SINGLE DOUBLE TEE WITH SINGLE THICKNESS AIRFOIL TYPE TURNING VANES TEE, BRANCH TAKE-OFF (RECTANGULAR TO RECTANGULAR) (RETURN & EXHAUST ONLY) SIDEWALL SUPPLY REGISTER WITH EXTRACTOR DAMPER, MANUAL VOLUME DAMPER MD DAMPER, MOTORIZED **∤FSD** ∖FSD FSD - COMBINATION FIRE & SMOKE DAMPER, SD - SMOKE DAMPER, NO LABEL - FIRE DAMPER WITH ACCESS PANEL ACCESS DOOR, DUCT SPIN IN BELLMOUTH TAP WITH **VOLUME DAMPER RECTANGULAR** MAIN, ROUND OR FLAT OVAL BRANCH. SPIN IN, STRAIGHT TAP WITH **VOLUME DAMPER RECTANGULAR** MAIN, ROUND OR FLAT OVAL BRANCH. TAKE OFF RECTANGULAR MAIN & BRANCH DUCT CONNECTION WITH VOLUME DAMPER. BRANCH, 45° RECTANGULAR TAKE-OFF TO DIFFUSER (DIFFUSER TAP OUT OF BOTTOM OF BRANCH DUCT) BRANCH, 45° RECTANGULAR TAKE-OFF TO DIFFUSER (NECK SIZE OF DIFFUSER DETERMINES SIZE OF BRANCH, UNLESS NOTED OTHERWISE). BRANCH, SPIN-IN ROUND TAKE-OFF TO DIFFUSER (NECK SIZE OF DIFFUSER DETERMINES

ABBREVIATIONS:

ABV	ABOVE	HC	HEATING COIL
AC	AIR CONDITIONING UNIT	HP	HORSEPOWER
ACC	AIR COOLED CONDENSER	HRC	HEAT RECOVERY UNIT
ACS	AIR CONDITIONING SYSTEM	HVAC	HEATING VENTILATION AND AIR CONDITION
ACU	AIR CONDITIONING UNIT	HVU	HEATING AND VENTILATING UNIT
ADJ	ADJUSTABLE	HWC	HOT WATER COIL
AF	AIRFOIL	IN WC	INCH OF WATER COLUMN
AFD	ADJUSTABLE FREQUENCY DRIVE	IN WG	INCH OF WATER GAUGE
AFF	ABOVE FINISHED FLOOR	ISOTR	ISOLATION TRANSFORMER
AHU	AIR HANDLING UNIT	KW	KILOWATTS
AMB	AMBIENT	LAT	LEAVING AIR TEMPERATURE
AS	AIR SEPARATOR	LD	LINEAR DIFFUSER
BAS	BUILDING AUTOMATION SYSTEM	LWT	LEAVING WATER TEMPERATURE
BD	BELT DRIVE	MAX	MAXIMUM
BI	BACKWARD INCLINED	MCA	MINIMUM CIRCUIT AMP
BLDG	BUILDING	MCC	MOTOR CONTROL CENTER
BHP	BRAKE HORSEPOWER	MD	MOTORIZED DAMPER
BTUH	BRITISH THERMAL UNIT/HOUR	MIN	MINIMUM
C	CONDENSATE	MZ	MULTI-ZONE
CAV	CONSTANT AIR VOLUME	NC	NOISE CRITERIA
CC	COOLING COIL	NEC	NATIONAL ELECTRIC CODE (NFPA-70)
CD	CONDENSATE DRAIN	No	NUMBER
CDL	CONDENSATE DRAIN LINE	OA	OUTSIDE AIR
CFF	CAPPED FOR FUTURE	OPNG P	OPENING
CFM	CUBIC FEET PER MINUTE		PUMP
CLG	CEILING	PD	PRESSURE DROP
CONC CONT	CONCRETE	PF PH	PRE-FILTER
COP	CONTINUOUS COEFFICIENT OF PERFORMANCE	PHWP	PREHEAT COIL PRIMARY HOT WATER PUMP
CP	CONDENSATE PUMP	PRV	PRESSURE REDUCING VALVE
CS	CURRENT SENSOR	PSIA	POUNDS PER SQUARE INCH ABSOLUTE
CT	CONTROL TRANSFORMER	PSIG	POUNDS PER SQUARE INCH ABSOLUTE
CU	CONTROL TRANSPORMER CONDENSING UNIT	QTY	QUANTITY
CUH	CABINET UNIT HEATER	RAF	RETURN AIR FAN
CV	CONSTANT VOLUME	RELA	RELIEF AIR
CW	COLD WATER	REQD	REQUIRED
CWR	CONDENSOR WATER RETURN	RG	RETURN AIR GRILLE
CWS	CONDENSOR WATER SUPPLY	RH	RELATIVE HUMIDITY
DB	DRYBULB	RLA	RUNNING LOAD AMP
DD	DIRECT DRIVE	RPM	REVOLUTIONS PER MINUTE
DIFF	DIFFUSER	RR	RETURN REGISTER
DL	DOOR LOUVER	RS	REFRIGERANT SENSOR
DMPR	DAMPER	RTS	ROOM TEMPERATURE SENSOR
DNII IX	DOWN	RTU	ROOF TOP UNIT
DPS	DIFFERENTIAL PRESSURE SWITCH	SA	SOUND ATTENUATOR
DPT	DIFFERENTIAL PRESSURE TRANSMITTER	SF	SUPPLY FAN
DTS	DUCT TEMPERATURE SENSOR	SG	SECURITY GRILLE
DWDI	DOUBLE WIDTH, DOUBLE INLET	SHWP	SECONDARY HOT WATER PUMP
DWG	DRAWING	S	SMOKE DETECTOR
DX	DIRECT EXPANSION	SF	SQUARE FEET
(e)	EXISTING	SP	STATIC PRESSURE
EF	EXHAUST FAN	SR	SUPPLY REGISTER
EA	EACH	SS	STAINLESS STEEL
EAT	ENTERING AIR TEMPERATURE	ST	STRAINER
EDH	ELECTRIC DUCT HEATER	STR	STARTER
EER	ENERGY EFFICIENCY RATIO	SW	SWITCH
EF	EXHAUST FAN	T	TEMPERATURE SENSOR
EG	EXHAUST GRILLE	TA	TRANSFER AIR
ELEC	ELECTRICAL	TAO	TRANSFER AIR OPENING
ENT	ENTERING	TG	TRANSFER GRILLE
EQ	EQUAL	TEFC	TOTALLY ENCLOSED FAN COOLED
FRU	ENERGY RECOVERY LINIT	TELE	TELEPHONE
ESP	EXTERNAL STATIC PRESSURE	TEMP	TEMPERATURE
ET	EXPANSION TANK	TOAC	TRANSFER OPENING ABOVE CEILING
EUH		TSTAT	THERMOSTAT
EWT	ENTERING WATER TEMPERATURE	TUX	TERMINAL UNIT CONTROLLER
EXH	EXHAUST	TYP	TYPICAL
FC	FORWARD CURVED	UC	UNDERCUT DOOR
FD	FIRE DAMPER	UH	UNIT HEATER
FF	FINAL FILTER	UTR	UP THROUGH ROOF
FLR	FLOOR	VAV	VARIABLE AIR VOLUME
FLA	FULL LOAD AMPS	VAF	VENTILATION AIR FAN
FLEX	FLEXIBLE CONNECTION	VAFC	VENTILATION AIR FAN CONTROLLOR
FOT	FLAT ON TOP	VFD	VARIABLE FREQUENCY DRIVE
FPM	FEET PER MINUTE	VP	VACUUM PUMP
GA	GAUGE	V-PH-HZ	VOLTS-PHASE-HERTZ
GAL	GALLON	VTR	VENT THRU ROOF
GALV	GALVANIZED	W	WATTS
GH	GRAVITY HOOD	WB	WET BULB
ווכו		WP	WEATHER PROOF
	GALLONS PER MINITIE	V V F	
GPM GUV	GALLONS PER MINUTE GRAVITY UNIT VENTILATOR	WWF	WOVEN WIRE FABRIC

GENERAL NOTES:

- 1. PROVIDE COMPLETE PRODUCT DATA (SIZE, WEIGHT, OPERATING CHARACTERISTICS, WIRING DIAGRAMS, ETC.) FOR ALL EQUIPMENT AND DEVICES SPECIFIED ON THE DRAWINGS.
- 2. SMOKE DETECTORS ARE FURNISHED BY DIVISION 26 AND INSTALLED IN DUCTWORK AND AHU'S BY DIVISION 23.
- 3. PROVIDE OFFSETS IN NEW DUCT AND PIPING SYSTEMS AS REQUIRED TO FACILITATE INSTALLATION OF NEW WORK AT NO ADDITIONAL COST TO THE CONTRACT.
- 4. PROVIDE 45 DEGREE ENTRANCE AND EXIT TAPS AT DUCT BRANCH CONNECTIONS.
- 5. ALL NON-GALVANIZED SUPPORTS AND HANGERS FOR DUCTWORK, PIPING, AND EQUIPMENT SHALL BE CLEANED OF DEBRIS AND RUST, PROPERLY PREPPED, PRIMED, AND PAINTED. REFER TO DIVISION 9 OF SPECIFICATIONS FOR ADDITIONAL INFORMATION AND REQUIREMENTS.
- 6. THE INSIDE OF DUCTWORK THAT IS VISIBLE THROUGH A DIFFUSER, REGISTER OR GRILLE, SHALL BE PAINTED FLAT BLACK.
- 7. PROVIDE SECURE, LOCKABLE, FIRE-RATED CEILING ACCESS PANEL IN HARD/SECURE CEILING TO ACCESS ALL MECHANICAL EQUIPMENT. SEE SHEET A121 REFLECTED CEILING PLAN FOR
- 8. IN ADDITION TO THE SPECIFICATION REQUIREMENTS AND PRIOR TO ORDERING EQUIPMENT AND INSTALLATION OF NEW WORK, SUBMIT A COMPOSITE SHOP DRAWING (1/4" MIN. SCALE PLAN AND SECTIONS) SHOWING DUCTWORK, PIPING AND EQUIPMENT LAYOUT OF EQUIPMENT ROOMS.
- 9. CONCRETE PADS FOR MECHANICAL EQUIPMENT SHALL BE SIZED, LOCATED AND PROVIDED BY DIVISION 23. PROVIDE 4" HIGH x UNIT LENGTH PLUS 4" ON EACH SIDE x UNIT WIDTH PLUS 4" ON EACH SIDE CONCRETE PADS FOR ALL HVAC EQUIPMENT.
- 10. MANUAL VOLUME DAMPERS SHALL HAVE OPPOSED BLADE TYPE DAMPERS WITH LOCKABLE QUADRANT TYPE STAND-OFF HANDLES. LOCATE DAMPER AT EACH BRANCH DUCT TAKE-OFF FROM MAIN OR SUBMAIN DUCT, AND AT EACH BRANCH DUCT RUNOUT TO AN AIR DEVICE.
- 11. WALL LOUVERS ARE INDICATED FOR INFORMATION ONLY. FOR ADDITIONAL INFORMATION REGARDING LOUVER SIZE, REFER TO SPECIFICATION SECTION 10 AND THE ARCHITECTURAL DRAWINGS.
- 12. VERIFY ALL EQUIPMENT WITH MANUFACTURERS' CERTIFIED DRAWINGS. VERIFY AND PROVIDE DUCT TRANSITIONS TO FURNISHED EQUIPMENT. FIELD VERIFY AND COORDINATE ALL DIMENSIONS BEFORE FABRICATION.
- 13. ALL DIFFUSER, GRILLE, AND REGISTER LOCATIONS IN SUSPENDED CEILINGS SHALL BE COORDINATED WITH REFLECTED CEILING PLANS, SPRINKLER PLANS, AND ELECTRICAL PLANS BEFORE
- 14. ALL DUCTWORK SHALL BE INSTALLED IN A CONCEALED MANNER AS CLOSE AS POSSIBLE TO WALLS AND UNDERSIDE OF BEAMS UNLESS OTHERWISE NOTED.
- 15. PROVIDE ACCESS PANELS IN DUCTWORK FOR OPERATION, ADJUSTMENT AND MAINTENANCE OF ALL FANS, VALVES, FIRE DAMPERS, CONTROL DAMPERS, SMOKE DETECTORS, AND AIRFLOW MEASURING STATIONS.
- 16. FLEXIBLE DUCT CONNECTING MAIN DUCT TO SUPPLY DIFFUSER SHALL NOT EXCEED 8 FEET IN LENGTH. IF THIS DISTANCE EXCEEDS THIS LIMIT, AN INSULATED METAL DUCT OF REQUIRED LENGTH AND EQUAL DIAMETER SHALL BE INSTALLED WITH DAMPER AT MAIN DUCT TO REDUCE FLEXIBLE DUCT TO MAXIMUM LENGTH OF 8 FEET.
- 17. ALL DUCT SHALL BE GROUNDED ACROSS FLEXIBLE CONNECTIONS WITH FLEXIBLE COPPER BRAIDED GROUNDING STRAP. PROVIDE FLEXIBLE DUCT CONNECTOR AT ALL DUCT CONNECTIONS TO SUPPLY FAN, AIR HANDLING UNIT, OR EXHAUST FAN.
- 18. ALL DUCT SIZES SHOWN ARE CLEAR INSIDE DIMENSIONS.
- 19. UNLESS OTHERWISE INDICATED ALL CONDENSATE DRAIN LINES FROM EACH AHU SHALL BE PIPED FULL SIZE OF DRAIN OUTLET, WITH P-TRAP TO FLOOR DRAIN OR JANITOR SINK.
- 20. ALL EQUIPMENT, PIPING, DUCTWORK, ETC., SHALL BE SUPPORTED AS DETAILED AND SPECIFIED. ADDITIONAL SUPPORTS SHALL BE PROVIDED AS REQUIRED TO PROPERLY SUPPORT ALL HVAC SYSTEM COMPONENTS.
- 21. MANUFACTURERS LISTED IN SCHEDULES WERE USED AS A BASIS FOR DESIGN. REFER TO THE SPECIFICATIONS FOR OTHER ACCEPTABLE MANUFACTURERS.
- 22. ALL FLEXIBLE DUCTWORK SHALL BE SAME NOMINAL SIZE AS THE NECK OF THE AIR DEVICE (DIFFUSERS, GRILLES, REGISTERS, AND LINEARS) IT SERVES
- 23. PROVIDE SINGLE THICKNESS, TRAILING EDGE TURNING VANES INSIDE ALL 90 AND 45 DEGREE SHEET METAL ELBOWS EXCEPT THOSE USED IN TRANSFER AIR DUCTS AND NON-DUCTED ELBOWS
- 24. CAPPED DUCTS SHALL BE BLANKED OFF WITH 18 GAUGE GALVANIZED SHEET METAL, CAULKED TO PROVIDE AN AIR TIGHT SEAL, AND EXTERNALLY INSULATED.
- 25. VFDs IF REQUIRED ARE INDICATED ON THE HVAC EQUIPMENT SCHEDULES AND ARE PROVIDED BY DIVISION 23. UNLESS OTHERWISE NOTED, FIELD LOCATE EACH VFD IN THE SAME ROOM THAT THE EQUIPMENT IT SERVES IS LOCATED. VFDs SHALL BE LOCATED SO THEY CAN EASILY BE ACCESSED, HAVE PROPER MAINTENANCE SPACE, AND COMPLY WITH THE NATIONAL ELECTRICAL CODE (NEC) REQUIREMENTS. GROUND VFDs IN ACCORDANCE WITH NEC. VFDs SHALL NOT BE MOUNTED ON HVAC EQUIPMENT UNLESS FACTORY MOUNTED.
- 26. COORDINATE ROUTING OF DUCTWORK WITH THE REFLECTED CEILING PLANS, LIGHT FIXTURES, HVAC PIPING, PLUMBING PIPING, AND SPRINKLER PIPING. WHEREVER POSSIBLE PROVIDE OFFSETS AND TRANSITIONS TO ROUTE DUCTWORK BETWEEN CEILING MOUNTED LIGHT FIXTURES IN LIEU OF ABOVE THEM.
- 27. LOUVERS ARE PROVIDED BY GENERAL CONTRACTOR. APPROXIMATE LOUVER PLENUM SIZES ARE INDICATED ON THE DRAWINGS. FIELD VERIFY THE ACTUAL PHYSICAL DIMENSIONS PRIOR TO FABRICATION OF PLENUMS AND CONNECTING DUCTWORK.
- 28. ALL HEATING, VENTILATION, AND AIR CONDITIONING SYSTEMS SHOWN ON THE CONTRACT DRAWINGS SHALL BE NEW UNLESS OTHERWISE INDICATED.
- 29. SUBMIT COMPLETE SHOP DRAWINGS AND PRODUCT DATA FOR ALL EQUIPMENT AND DEVICES SPECIFIED ON THE HVAC DRAWINGS.
- 30. CONSTRUCT LOUVER PLENUMS OF 16 GAUGE GALVANIZED STEEL WITH BOTTOM AT 15 DEGREE SLOPE TOWARD LOUVER. PROVIDE 12"x12" INSULATED ACCESS DOOR. INSULATE PLENUM WITH 2" THICK, 3 POUND DENSITY, RIGID BOARD INSULATION AND SEAL ALL JOINTS AND SEAMS WITH 4" WIDE GLASS FABRIC BETWEEN TWO LAYERS OF MASTIC. REFER TO SPECIFICATIONS, FLOOR PLANS, AND DETAILS FOR ADDITIONAL REQUIREMENTS.
- 31. DISCREPANCIES AND CONFLICTS BETWEEN MECHANICAL SYSTEMS AND OTHER DISCIPLINE (ARCHITECTURAL, STRUCTURAL, ELECTRICAL, PLUMBING AND FIRE PROTECTION) DRAWINGS SHALL BE BROUGHT TO THE ATTENTION OF THE A/E PRIOR TO CONSTRUCTION OF SUBJECT SYSTEMS. FAILURE TO NOTIFY A/E OF THE SUBJECT PROBLEMS SHALL CONSTITUTE ACCEPTANCE OF ALL CONDITIONS AND ANY CORRECTIVE WORK REQUIRED, AS DIRECTED BY A/E. THE SUBJECT CORRECTIVE WORK SHALL BE PERFORMED BY THE CONTRACTOR AT NO ADDITIONAL COST TO THE
- 32. ALL FURNISHED EQUIPMENT MUST FIT THE ALLOCATED SPACE. PROVIDE ALL MODIFICATIONS TO THE OPENINGS, IN ROOF OR SLAB, STEEL SUPPORTS, ELECTRICAL REQUIREMENTS, AND ANY OTHER BUILDING COMPONENTS REQUIRED TO FACILITATE THE INSTALLATION OF SUBJECT EQUIPMENT.
- 33. PRIOR TO FINAL INSPECTION OF EQUIPMENT BY A/E, EACH PIECE OF MECHANICAL EQUIPMENT SHALL BE CLEANED AND ALL FOREIGN MATERIALS REMOVED. ALL PENETRATIONS THROUGH UNIT CASINGS SHALL BE PROPERLY SEALED AND ALL CONTROL DEVICES SHALL BE OPERATIONAL AND CALIBRATED.
- 34. COORDINATE LOCATION OF HVAC EQUIPMENT AND SYSTEM ROUTINGS SO THAT HVAC EQUIPMENT, PIPING, AND DUCTWORK ARE NOT LOCATED ABOVE ELECTRICAL EQUIPMENT OR PANELS.
- 35. UNUSED PORTIONS OF LOUVERS SHALL BE BLANKED OFF WITH 20 GAUGE GALVANIZED STEEL. DUCTWORK SHALL BE CAPPED OR BLANKED OFF WITH ONE SIZE GREATER THAN THE DUCT IT SERVES. ALL BLANK-OFFS AND CAPS SHALL BE CAULKED TO PROVIDE AN AIR AND WATER TIGHT SEAL, LOUVER BLANK-OFFS SHALL BE INSULATED WITH RIGID BOARD INSULATION, WELD PENS. GLASS CLOTH, AND MASTIC AS SPECIFIED FOR DUCTWORK INSIDE EQUIPMENT ROOMS. DUCTWORK BLANK-OFFS SHALL BE INSULATED TO MATCH ADJACENT INSULATION OF THE SUBJECT DUCT.
- 36. REFER TO CONTROL DRAWINGS FOR BOTH DUCT AND EQUIPMENT DAMPERS (CONTROL, MANUAL BALANCING, BACKDRAFT, AND ADJUSTABLE WEIGHTED) THAT MAY NOT BE SHOWN ON THE FLOOR PLANS BUT ARE REQUIRED.
- 37. FOR ALL THREE-PHASE MOTORS POWERING MECHANICAL EQUIPMENT IN CONSTANT SPEED APPLICATIONS: PROVIDE FULL VOLTAGE, COMBINATION MAGNETIC TYPE, THREE-PHASE POWER MOTOR STARTER/CONTROLLERS WITH UNDER VOLTAGE RELEASE, MOTOR CIRCUIT PROTECTOR TYPE DISCONNECT WITH SHORT-CIRCUIT PROTECTION, OVERLOAD RELAY IN EACH PHASE, 120 VAC CONTROL POWER VOLTAGE WITH CONTROL POWER TRANSFORMER, AND HANDS-OFF-AUTOMATIC SWITCH AND GREEN PILOT LIGHT IN CONTROL PANEL COVER. PROVIDE THE APPROPRIATE NUMBER OF NORMALLY OPEN (N.O.) AND NORMALLY CLOSED (N.C.) CONTACTS REQUIRED TO OPERATE AND CONTROL THE EQUIPMENT IN ACCORDANCE WITH THE SEQUENCES OF OPERATION AS SPECIFIED. REFER TO ELECTRICAL SPECIFICATIONS FOR ADDITIONAL REQUIREMENTS.
- 38. FOR ALL SINGLE-PHASE MOTORS POWERING MECHANICAL EQUIPMENT: PROVIDE ELECTRICAL DISCONNECT AND THE APPROPRIATE NUMBER OF NORMALLY OPEN (N.O.) AND NORMALLY CLOSED (N.C.) CONTACTS REQUIRED TO OPERATE AND CONTROL THE EQUIPMENT IN ACCORDANCE WITH THE SEQUENCES OF OPERATION AS SPECIFIED. REFER TO ELECTRICAL SPECIFICATIONS FOR

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PENSACOLA INTERNATIONAL **AIRPORT**

PENSACOLA, FLORIDA

PENSACOLA GENERAL **AVIATION** FACILITY (GAF)



PROFESSIONAL SEAL



REVIS	SIONS	_
NO.	DESCRIPTION	DATE
DATE IS	SSUED:	03/03/2020
REVIEW	/ED BY:	JEB

REVIEWED BY: HPM DRAWN BY: HPM **DESIGNED BY:** PROJECT NUMBER: 201-0052-002

SHEET TITLE

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MECHANICAL **GENERAL NOTES,** SYMBOLS AND **ABBREVIATIONS**

SHEET NUMBER

BID DOCUMENTS

SEISMIC & WIND LOAD REQUIREMENTS:

SIZE OF BRANCH, UNLESS NOTED

OTHERWISE).

ALL SUSPENDED HVAC PIPING, DUCTWORK AND EQUIPMENT SHALL BE PROVIDED WITH SEISMIC SWAY (RESTRAINT) BRACING IN ACCORDANCE WITH THE BELOW GUIDELINES AND STANDARDS. THE SEISMIC SYSTEM SHALL BE DESIGNED BY A PROFESSIONAL ENGINEER, REGISTERED IN THE STATE WHERE SERVICES ARE BEING PERFORMED, AND HAVING 5 YEARS OF SUCCESSFUL DESIGN EXPERIENCE ON SIMILAR TYPE PROJECTS.

SUBMIT QUALIFICATIONS TO A/E FOR APPROVAL PRIOR TO PERFORMING ANY OF THE SUBJECT WORK. SUBMIT SHOP DRAWINGS THAT INCLUDE FLOOR PLANS AND REFERENCED ALL RESTRAINT POINT LOCATIONS TO THE CALCULATIONS AND INSTALLATION DETAILS.

PROVIDE SHOP DRAWINGS, CALCULATIONS, DETAILS, MATERIALS (GALVANIZED STEEL ROOF SUPPORT FRAMES) AND LABOR TO SECURE THE ROOF MOUNTED PIPING, DUCTWORK AND EQUIPMENT TO WITHSTAND THE SPECIFIED WIND SPEEDS.

- 1. STANDARD FOR DESIGN: ASCE 7-10
- 2. SEISMIC DESIGN CATEGORY: B
- 3. RISK CATEGORY: II
- 4. ULTIMATE WIND SPEED: 150 MPH (3 SECOND GUST)
- 5. REFER TO STRUCTURAL DRAWING S001 FOR ADDITIONAL INFORMATION REQUIREMENTS

TEST & BALANCE NOTES:

- 1. THE CONTRACTOR HAS 30 DAYS AFTER AWARD OF THE CONTRACT TO SUBMIT THE NAME AND QUALIFICATIONS OF THE ORGANIZATION HE PROPOSES TO EMPLOY FOR THIS PROJECT. FAILURE TO COMPLY WITH THIS REQUIREMENT WILL RESULT IN T&B FIRM BEING ASSIGNED TO THE CONTRACTOR.
- 2. REFER TO SPECIFICATION SECTION 230593 WITH REGARDS TO WORK ASSOCIATED WITH LUBRICATION OF MOTOR AND FAN BEARINGS, AND COORDINATING THE LOCATION OF AIR FLOW MEASURING STATIONS AND WATER FLOW MEASURING/BALANCING VALVES.
- 3. COORDINATE WITH THE GENERAL CONTRACTOR AND SCHEDULE THE PRE-BALANCE CONFERENCE PER SPECIFICATION SECTION 230593.
- 4. FOR ADDITIONAL T&B WORK REQUIREMENTS NOT ADDRESSED BY THESE NOTES, REFER TO THE CONTRACT DRAWINGS AND SPECIFICATIONS.
- 5. REFER TO THE EQUIPMENT SCHEDULES, FLOOR PLANS AND SPECIFICATION SECTION 230593 FOR ADDITIONAL DESCRIPTION OF T&B WORK.
- 6. REPAIR DUCT AND PIPE INSULATION THAT WAS DAMAGED WHILE PERFORMING T&B WORK. THE REPAIRED INSULATION SHALL BE NEW AND BE OF SAME MATERIALS TYPE, THICKNESS AND JACKET AS ADJACENT INSULATION.

OUTSIDE CONDITIONS FROM ASHRAE FUNDAMENTALS 2013 CLIMATE DATA

DESIGN CONDITIONS & SETPOINTS:

COOLING SEASON (SUMMER CONDITIONS):

HEATING SEASON (WINTER CONDITIONS):

INDOOR SETPOINT (°F): 70

INDOOR SETPOINT (°F):

OUTSIDE AIR DB / WB (°F): 94 / 77 (AT 0.4%)


OUTSIDE AIR DB (°F): 29 (AT 99.6%)

ELBOW, 45° WITH SINGLE

ELBOW, STANDARD RADIUS

ELBOW, SHORT RADIUS

THICKNESS TYPE TURNING VANES

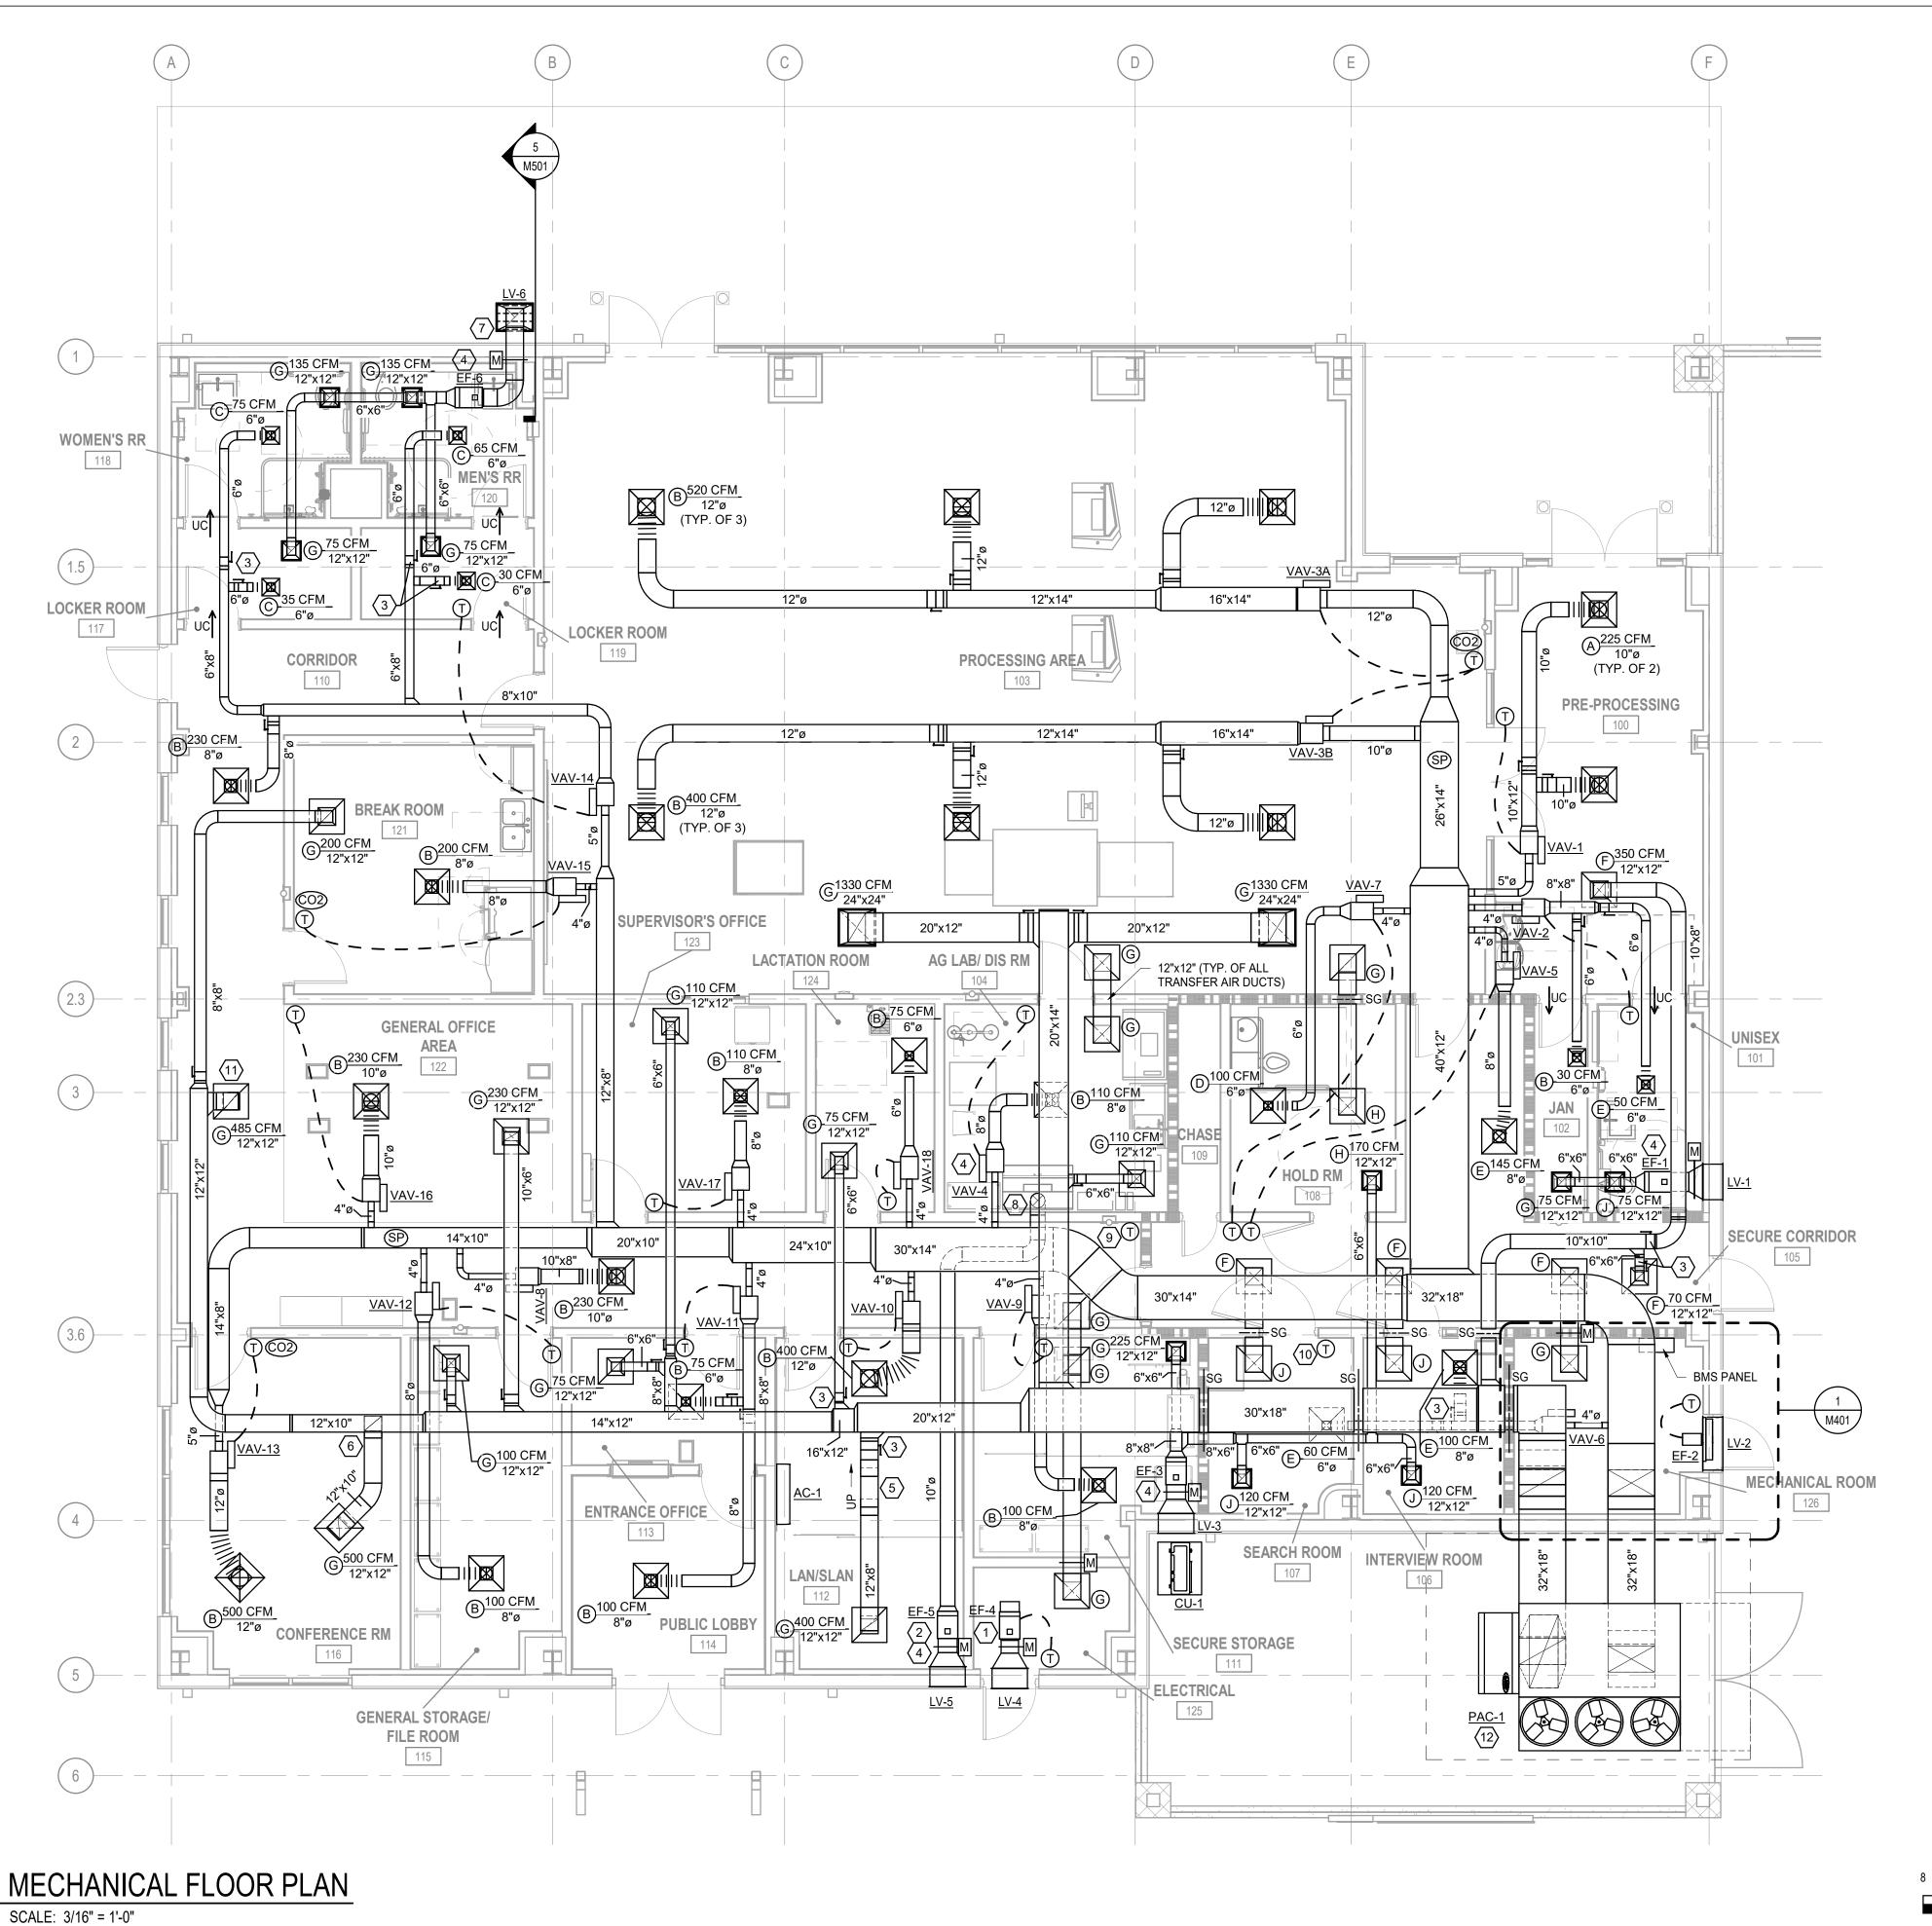

KEY NOTES:

- 1. INTERLOCK EXHAUST FAN WITH MOTORIZED DAMER IN TRANSFER AIR DUCT.
- 2. INTERLOCK EXHAUST FAN WITH SWITCH TO BE PROVIDED ON FUME HOOD.
- 3. PROVIDE REMOTE DAMPER CABLE CONTROL SYSTEM. SEE SHEET M504 FOR DETAIL.
- 4. PROVIDE HARD CEILING ACCESS PANEL.
- 5. TRANSITION 12"x8" RETURN DUCT FROM B.O.D. 14' 2" AFF TO B.O.D. 11' 10" AFF TO AVOID STRUCTURE.
- 6. TAP OFF 12"x10" RETURN DUCT FROM BOTTOM OF MAIN. TRANSITION DUCT TO B.O.D. 11' 9" AFF. PROVIDE MANUAL BALANCING DAMPER IN VERTICAL TAKEOFF.
- 7. LV-6 TO BE LOCATED IN SOFFIT. SEE SHEET M501 FOR DUCT ROUTING DETAIL.
- 8. CONNECT TO FUME HOOD. SEE ARCHITECTURAL DRAWINGS FOR FUME HOOD INFORMATION.
- 9. THERMOSTAT TO BE WIRED TO <u>VAV-8</u>.
- 10. THERMOSTAT TO BE WIRED TO <u>VAV-6</u>.
- 11. PROVIDE MANUAL BALANCING DAMPER IN VERTICAL DUCT.
- 12. PROVIDE UNIT WITH 32" HIGH STAINLESS STEEL PLENUM CURB WITH HURRICANE TIE-DOWN. CURB BY MGM PRODUCTS, INC OR APPROVED EQUAL.



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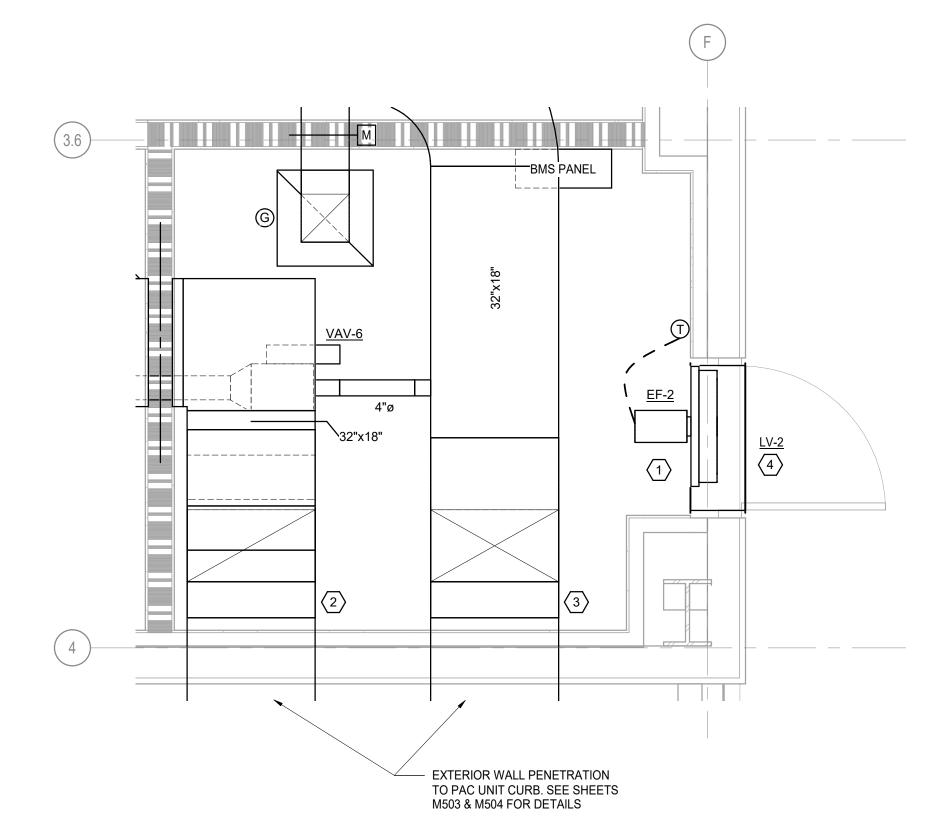
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SHEET TITLE

MECHANICAL FLOOR PLAN

SHEET NUMBER

M101



MECHANICAL ROOM ENLARGED PLAN

M401

SCALE: 1/2" = 1'-0"

KEY NOTES:

- 1. INTERLOCK EXHAUST FAN WITH MOTORIZED DAMER IN TRANSFER AIR DUCT.
- 2. PROVIDE FITTINGS AS NEEDED TO TRANSITION 32"x18" RETURN MAIN DUCT FROM VERTICAL RISER TO HORIZONTAL RUN WITH B.O.D. 13' 9" AFF.
- 3. PROVIDE FITTINGS AS NEEDED TO TRANSITION 32"x18" SUPPLY MAIN DUCT FROM VERTICAL RISER TO HORIZONTAL RUN WITH B.O.D. 12' 3" AFF.
- 4. LV-2 TO BE PROVIDED WITH BACKDRAFT DAMPER.

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SHEET TITLE


MECHANICAL ENLARGED PLANS

SHEET NUMBER

M401

BID DOCUMENTS


SCALE: 1/8" = 1'-0"

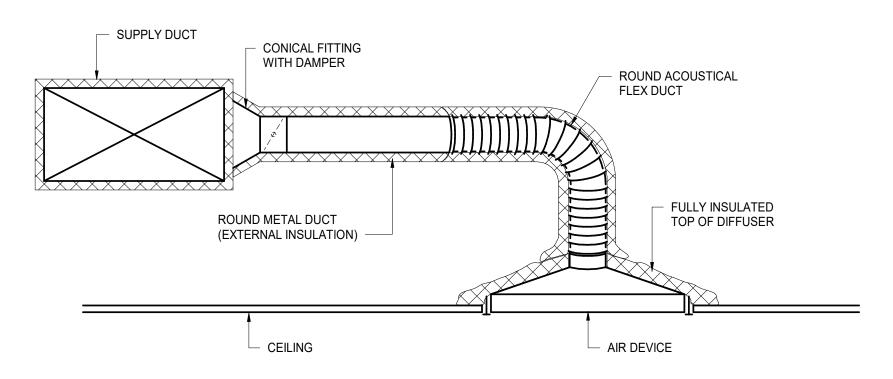


NOTES:

M501

- 1. SUPPORT DIFFUSERS OR GRILLES FROM STRUCTURE, NOT CEILING GRID SYSTEM.
- 2. INSTALLATION SIMILAR FOR SLOT DIFFUSERS.
- 3. 3'-0" MAXIMUM SPACING FOR HANGERS ON FLEX DUCT.
- 4. PROVIDE VOLUME DAMPER AT TAKEOFF FROM MAIN DUCT. VOLUME DAMPERS ARE NOT PERMITTED AT THE AIR DEVICE.

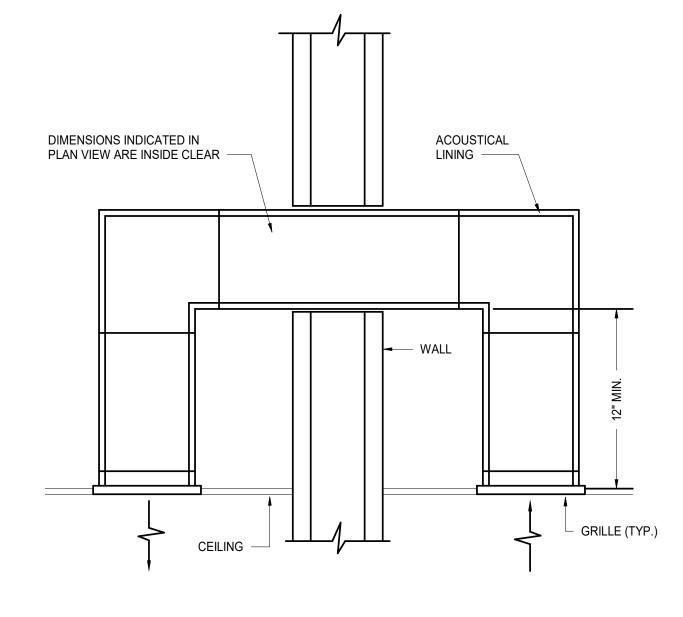


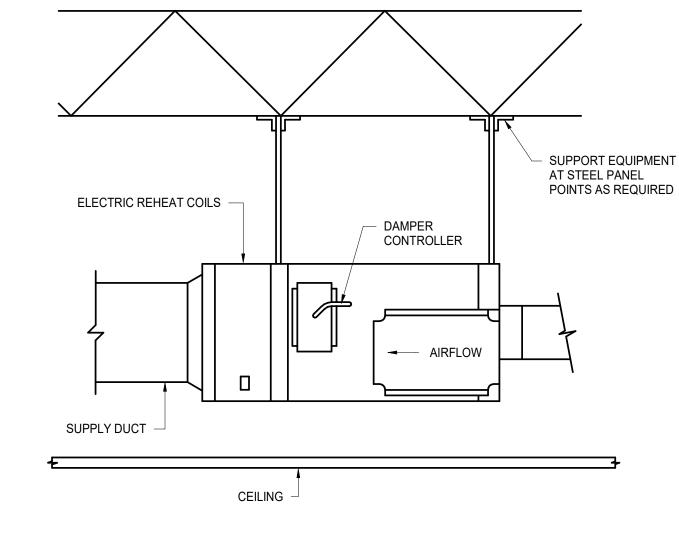








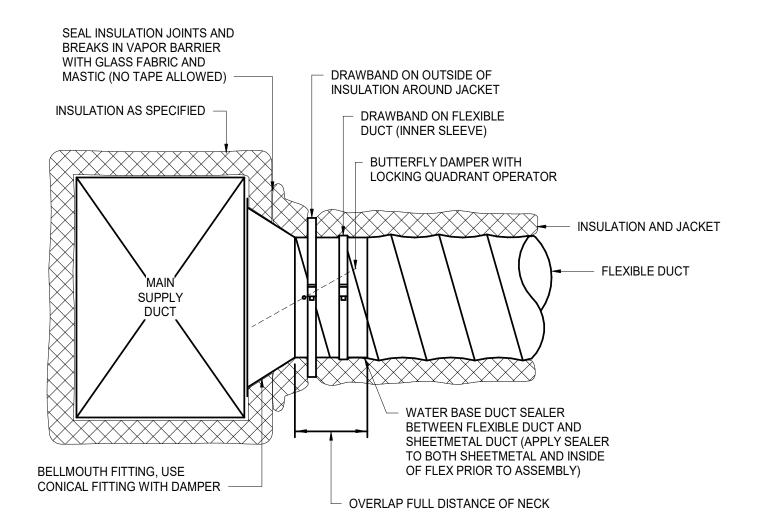


NOTES:

 TYPICAL FOR: LOW PRESSURE AND HIGH PRESSURE CONNECTION TO MAIN DUCT, FAN TERMINAL UNITS, VARIABLE AIR VOLUME UNITS, AND DIFFUSERS.
 DRAWBANDS SHALL BE EQUIVALENT TO PANDUIT PLT-H.



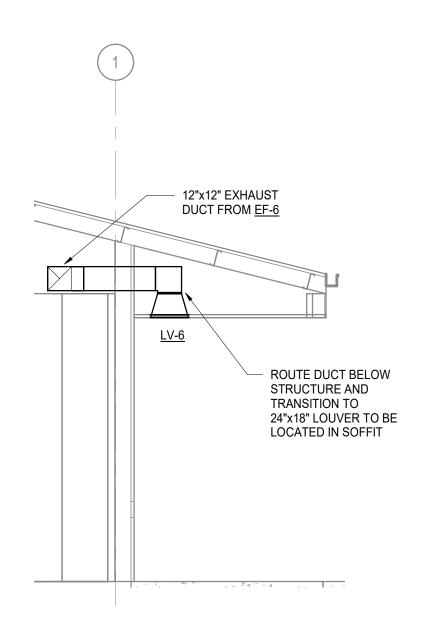



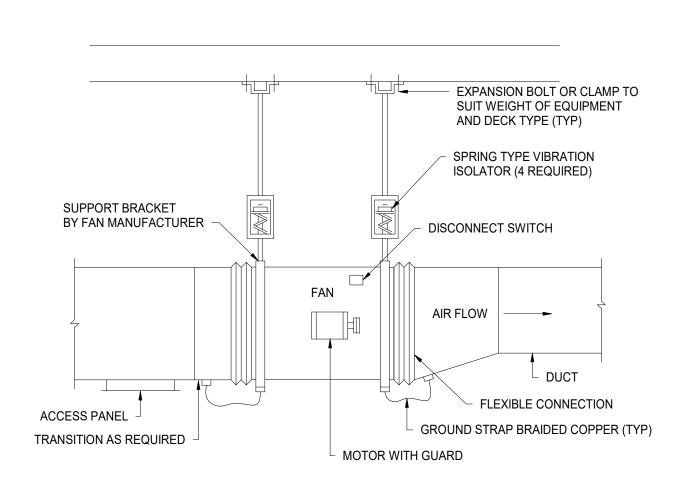





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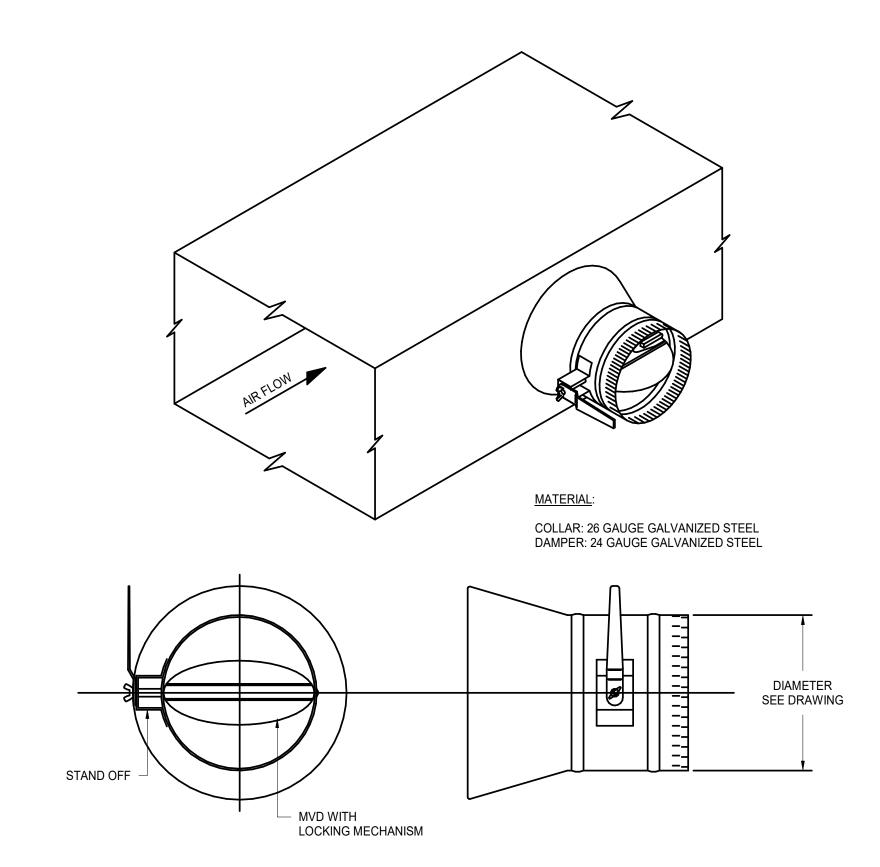
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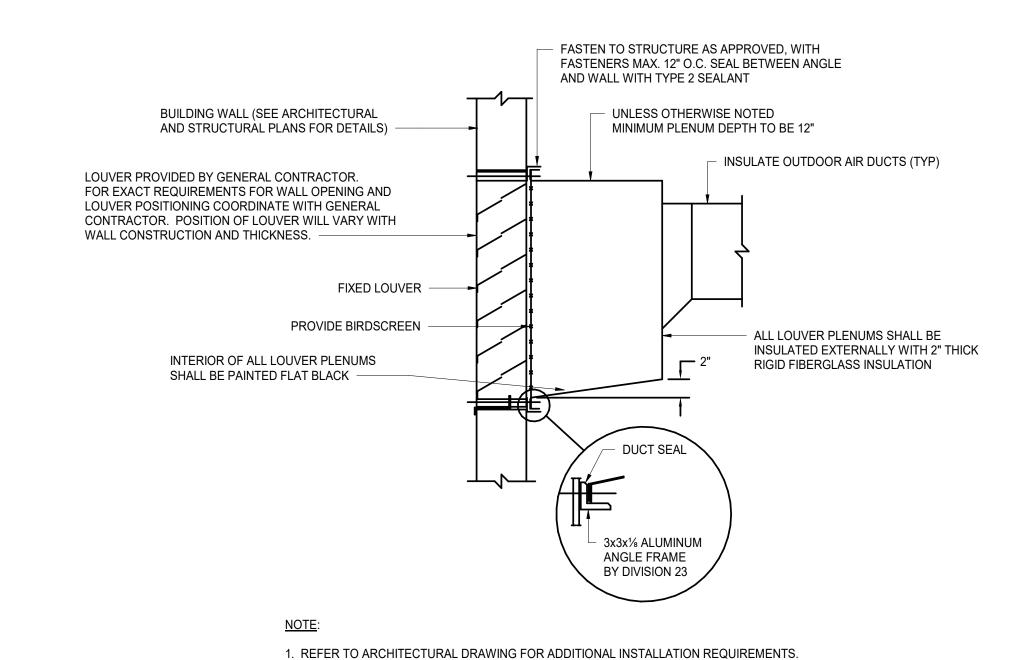
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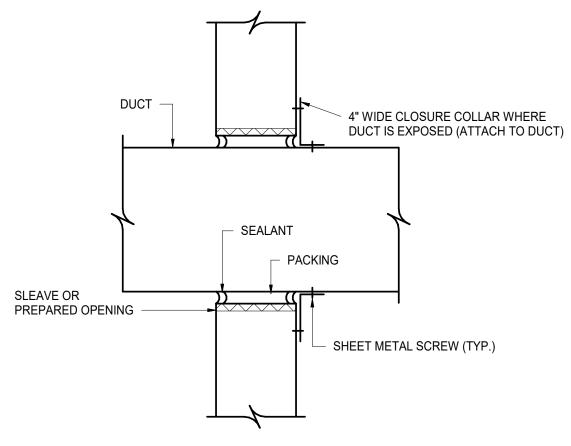
MECHANICAL DETAILS

SHEET NUMBER

M501











CONICAL SPIN-IN CONNECTION M502

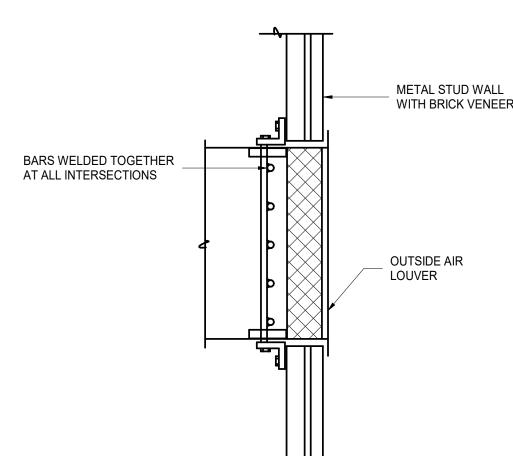


1/2" STEEL BARS @ 6" C/C WELDED TO A 3/8"x4" STEEL PLATE FRAME TO FIT INSIDE DUCT. PROVIDE A 3/8"x4" STEEL PLATE TO FIT OUTSIDE DUCT. FASTEN FRAMES AND 3/8"x4"x6" ANGLE TOGETHER WITH 3.8" CARRIAGE BOLTS 16" C/C BOLT FROM INSIDE DUCT AND BOLT TO INSIDE OF EXTERIOR WALL USING 3/8" BOLTS. BURGLAR BARS SHALL RUN IN BOTH DIRECTIONS.

ONLY REQUIRED FOR OPENINGS 12"x12" AND LARGER

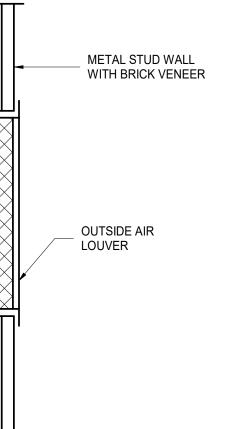

EXTERIOR WALL LOUVER SECURITY BAR DETAIL

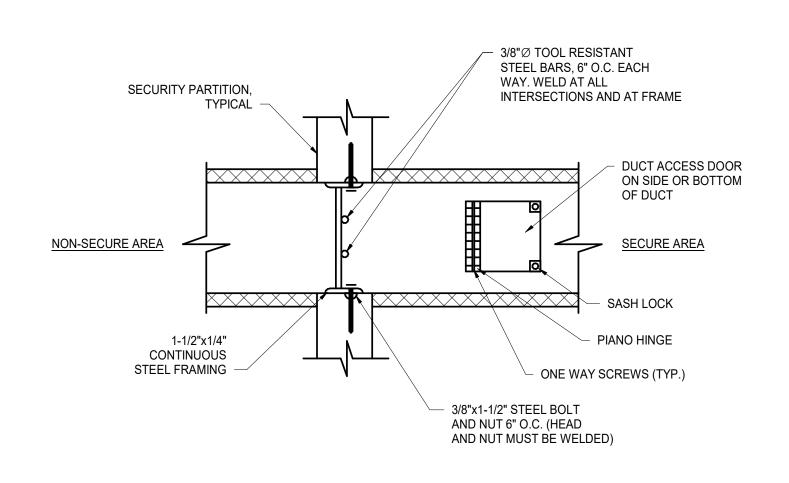


DUCT CONNECTION TO LOUVER

1. SECURITY BARRIER CONFIGURATION SHALL MATCH THE WALL CONFIGURATION AT





THE WALL PENETRATION.

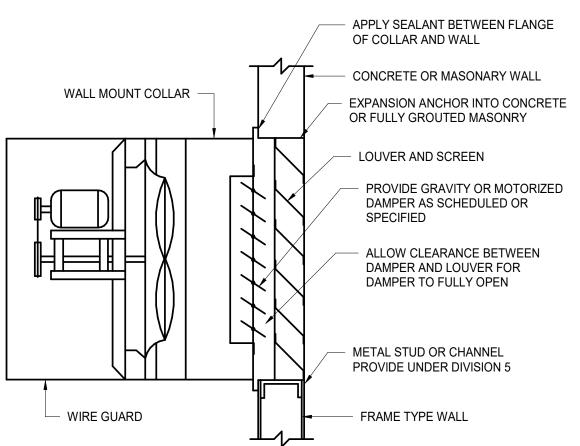

IF LOUVER OPENING IS LARGER THAN FAN HOUSING PROVIDE STEEL ANGLE BOLTED THROUGH TO STEEL STUD OR CHANNEL WITH 1/2" BOLTS @ 2'-0" O.C. MAX



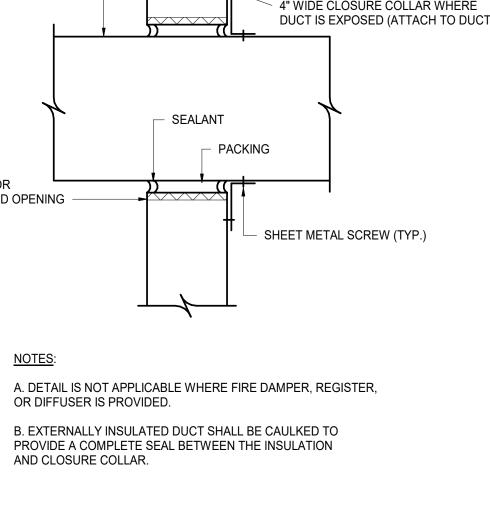

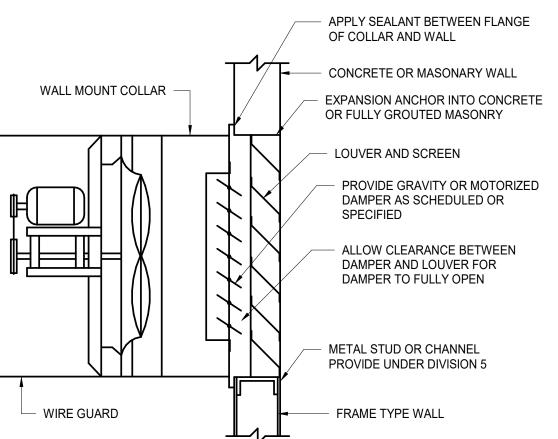

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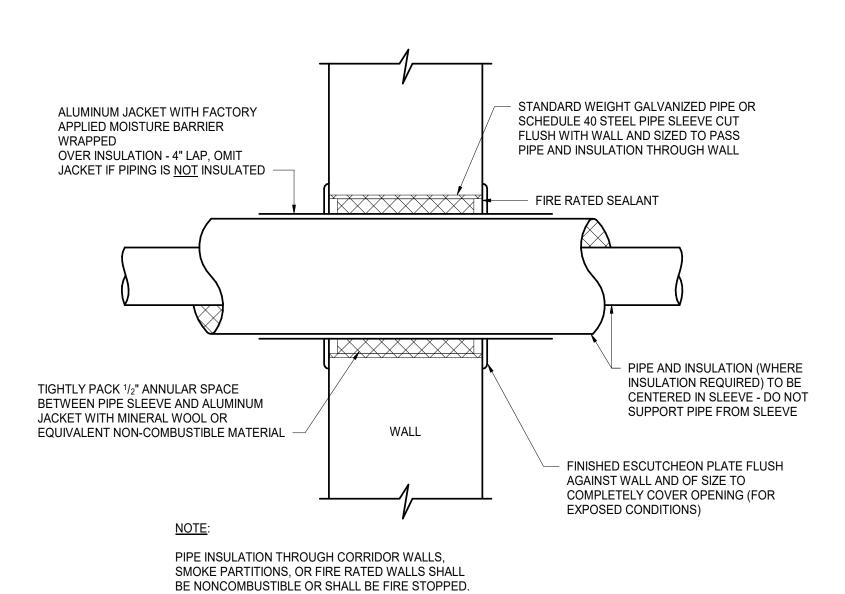
SHEET TITLE


MECHANICAL


DETAILS

DRAWN BY:

M502



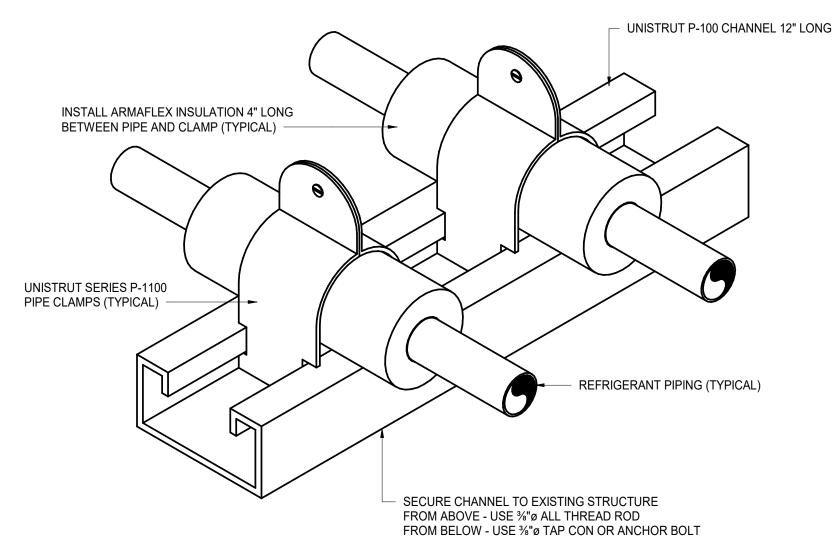

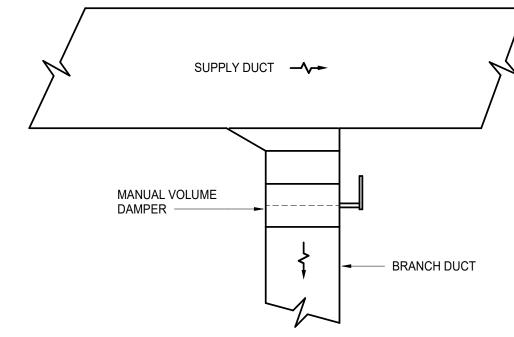


MAIN DUCT CFM ANYTIME AND UP TO 40% WHEN THE MAIN DUCT VELOCITY IS 1000 FPM OR LESS.


SUPPLY BRANCH DUCT TAKE-OFF


PIPE PENETRATION THROUGH WALL M503

FIBERGLASS INSULATION IS NOT ALLOWED.

REFRIGERANT PIPE SUPPORT M503

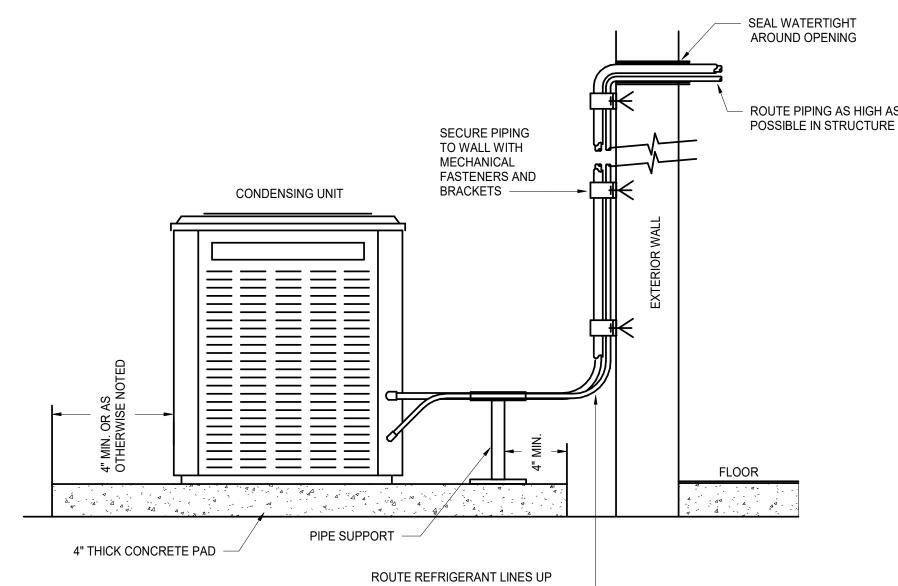

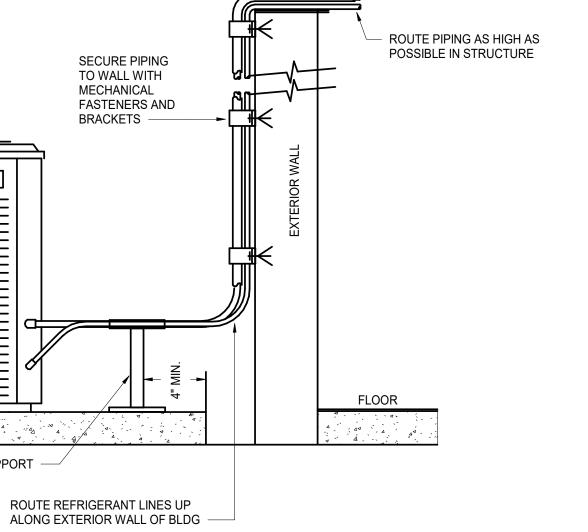

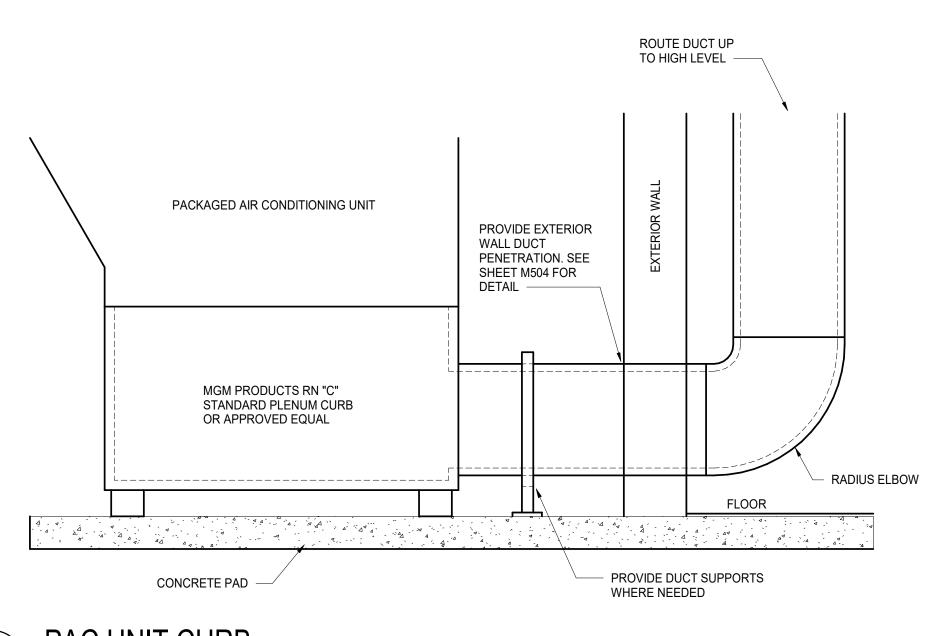

PAC UNIT CURB

CONDENSING UNIT

SHEET NUMBER

BID DOCUMENTS

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AIRPORT PENSACOLA, FLORIDA **PENSACOLA GENERAL AVIATION** FACILITY (GAF)

NOTES:

1. BRANCH DUCT TAKE-OFF MAY BE USED FOR UP TO 15% OF THE

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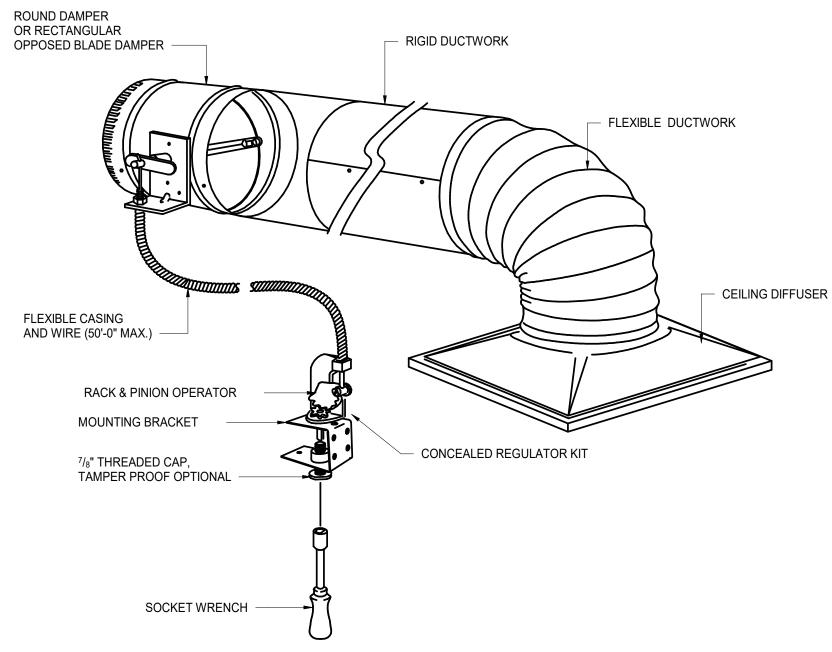
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MECHANICAL DETAILS

M503




NOTES:


- 1. COORDINATE EXACT LOCATION OF CEILING MOUNTED CONCEALED REGULATOR WITH ARCHITECT PRIOR TO INSTALLATION.
- 2. THE CABLE CONTROL SYSTEM IS DESIGNED TO BE IMBEDDED IN THE CEILING FLUSH WITH THE FINISHED SURFACE.
- 3. CABLE SHALL CONSIST OF BOWDEN CABLE .054" STAINLESS STEEL CONTROL WIRE ENCAPSULATED IN 1/16" FLEXIBLE GALVANIZED SPIRAL WIRE SHEATH.
- 4. LOCKING RACK AND PINION GEAR DRIVE SHALL BE CONSTRUCTED OF 14 GAUGE STEEL AND SHALL BE USED TO CONVERT ROTARY MOTION INTO PUSH-PULL MOTION.
- 5. CONTROL SHAFT SHALL BE "D"-STYLE FLATTENED 1/4"Ø WITH 265° ROTATION PROVIDING 1 1/2" LINEAR TRAVEL CAPABILITY.



REMOTE DAMPER CABLE CONTROL

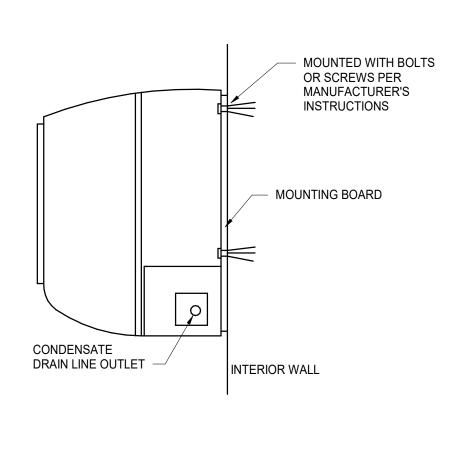

NOTE: PROVIDE MANUFACTURER RECOMMENDED MINIMUM CLEARANCES AROUND UNIT.

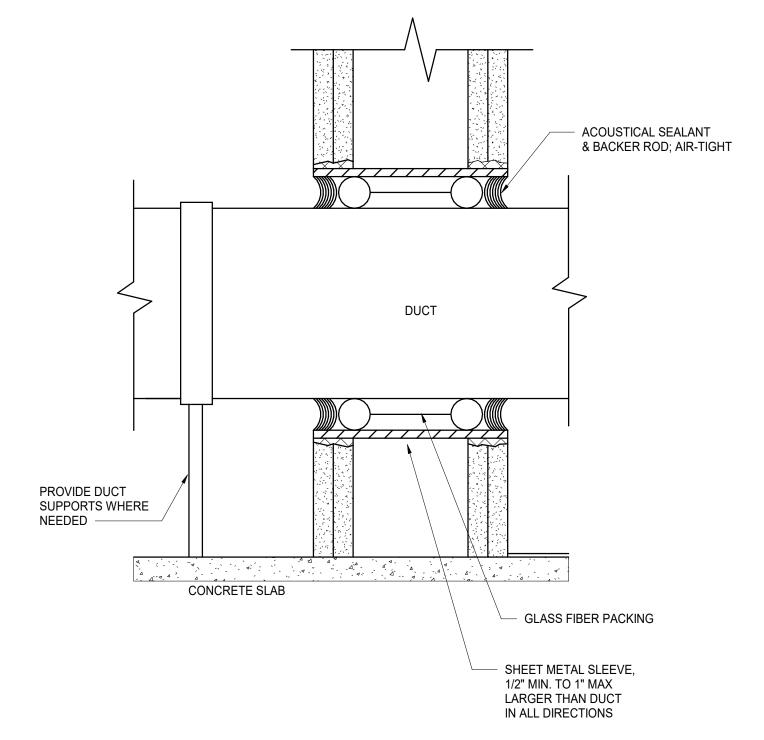



DUCT WALL PENETRATION DETAIL





SPLIT SYSTEM INDOOR UNIT MOUNTING DETAIL

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MECHANICAL DETAILS

SHEET NUMBER

M504

SECURITY GRILLE SCHEDULE		
MARK	SG	
DESCRIPTION	DUCT BARRIER GRILLE	
SIZE, W x L (in.)	TO MATCH DUCT - SEE PLANS	
MANUFACTURER	PRICE	
MODEL	MSBG	
NOTES	1	

1. PROVIDE WITH EITHER 3/8" STEEL BARS WELDED VERTICALLY AND HORIZONTALLY ON 6" CENTERS OR 9-GAUGE WIRE MESH.

EXHAUST FAN SCHEDU	JLE					
MARK	<u>EF-1</u>	<u>EF-2</u>	<u>EF-3</u>	<u>EF-4</u>	<u>EF-5</u>	<u>EF-6</u>
FAN TYPE	INLINE	SIDEWALL PROPELLER	INLINE	INLINE	INLINE	INLINE
AREA SERVED	UNISEX & JAN	MECHANICAL	DETENTION SUITE	ELECTRICAL	FUME HOOD	RESTROOM BANK
DESIGN FLOWRATE (CFM)	150	135	515	75	760	420
AIR TEMPERATURE (°F)	70	70	70	70	70	70
DESIGN PRESSURE DROP (in. w.g.)	0.2	0.2	0.25	0.2	0.22	0.35
DRIVE TYPE	DIRECT	DIRECT	DIRECT	DIRECT	DIRECT	DIRECT
HORSEPOWER	1/50	1/50	1/10	1/80	1/3	1/10
RPM	1300	1350	1550	1300	1770	1550
VOLTAGE	115	115	115	115	460	115
PHASE	1	1	1	1	3	1
FREQUENCY	60	60	60	60	60	60
MANUFACTURER	GREENHECK	GREENHECK	GREENHECK	GREENHECK	GREENHECK	GREENHECK
MODEL	SQ-70-G	SE1-8-440-G	SQ-90-D	SQ-60-G	AX-36-160-0406-A3	SQ-90-D
NOTES	1, 2, 3, 4, 5	1, 2, 3, 4, 6, 8	1, 2, 3, 4, 5	1, 2, 3, 4, 5, 6	1, 2, 3, 4, 5, 7	1, 2, 3, 4, 5

1. PROVIDE FACTORY MOUNTED NEC COMPLIANT DISCONNECT.

2. INTERLOCK WITH PAC-1.

3. THERMAL OVERLOAD MOTOR.

4. PROVIDE VIBRATION ISOLATORS.

5. INTERLOCK WITH CORRESPONDING MOTORIZED DAMPER IN EXHAUST AIR DUCT.

6. INTERLOCK WITH MOTORIZED DAMPER IN TRANSFER AIR DUCT.

7. TO BE ACTIVATED BY MANUAL POWER SWITCH LOCATED AT FUME HOOD.

8. PROVIDE WITH BACKDRAFT DAMPER TO BE LOCATED AT CORRESPONDING LOUVER.

AIR DEVICE SCHEDULE									
MARK	A	В	С	D	Е	F	G	Н	J
DESCRIPTION	PERFORATED PLATE DIFFUSER	SQUARE CEILING DIFFUSER	SUPPLY GRILLE	SECURITY GRILLE	SECURITY DIFFUSER	PERFORATED RETURN GRILLE	RETURN GRILLE	SECURITY RETURN GRILLE	SECURITY EXHAUST GRILLE
FACE SIZE, W x L (in.)	24" x 24"	SEE PLANS	SEE PLANS	24" x 24"	SEE PLANS	24" x 24"	SEE PLANS	SEE PLANS	SEE PLANS
MANUFACTURER	PRICE	PRICE	PRICE	PRICE	PRICE	PRICE	PRICE	PRICE	PRICE
MODEL	PDF	SCD	520	MSPG	MSD	PDDR	510Z	MSPG	MSL
NOTES	1, 2, 5	1, 5	1, 5	1, 4, 5	1, 3, 5	1, 2, 5	1, 5	1, 4, 5	1, 3, 5

1. PROVIDE BORDER TYPE SUITABLE FOR INDIVIDUAL LOCATIONS.

2. PROVIDE WITH PERFORATED FACE WITH 3/16" DIAMETER HOLES ON 1/4" STAGGERED CENTERS.

3. PROVIDE WITH 12-GAUGE STEEL LATTICE FACE WITH 13/16" SQUARE HOLES ON 1" CENTERS.

4. PROVIDE WITH 3/16" THICK STEEL FACE WITH 5/16" DIAMETER HOLES ON 7/16" STAGGERED CENTERS.

5. SELECT AND INSTALL ACCORDING TO SPECIFICATION SECTION 233713.

1, 2, 4

VARIABLE AIR VOLUME	TERMINA	L UNIT SCI	HEDULE																
MARK	VAV-1	<u>VAV-2</u>	VAV-3A	VAV-3B	VAV-4	<u>VAV-5</u>	<u>VAV-6</u>	VAV-7	<u>VAV-8</u>	VAV-9	<u>VAV-10</u>	<u>VAV-11</u>	<u>VAV-12</u>	<u>VAV-13</u>	<u>VAV-14</u>	<u>VAV-15</u>	<u>VAV-16</u>	<u>VAV-17</u>	<u>VAV-18</u>
INLET SIZE (in.)	5	4	12	10	4	4	4	4	4	4	4	4	4	5	5	4	4	4	4
DESIGN COOLING AIRFLOW (CFM)	450	80	1560	1200	110	145	160	100	280	100	400	175	100	500	485	200	230	110	75
MINIMUM AIRFLOW (CFM)	140	35	470	360	35	45	50	35	85	35	120	55	35	150	150	60	70	35	35
ELECTRIC COIL CAPACITY (kW)	1.0	0.5	2	1.5	0.5	0.5	0.5	0.5	0.5	0.5	0.5	0.5	0.5	1.0	1.0	0.5	0.5	0.5	0.5
VOLTAGE	277	277	277	277	277	277	277	277	277	277	277	277	277	277	277	277	277	277	277
PHASE	1	1	1	1	1	1	1	1	1	1	1	1	1	1	1	1	1	1	1
FREQUENCY	60	60	60	60	60	60	60	60	60	60	60	60	60	60	60	60	60	60	60
MAX STATIC PRESSURE DROP (in. w.g.)	0.01	0.01	0.01	0.01	0.01	0.01	0.01	0.01	0.01	0.01	0.01	0.01	0.01	0.01	0.01	0.01	0.01	0.01	0.01
MAXIMUM NC VALUE	<20	<20	<20	<20	<20	<20	<20	<20	<20	<20	<20	<20	<20	<20	<20	<20	<20	<20	<20
MANUFACTURER	PRICE	PRICE	PRICE	PRICE	PRICE	PRICE	PRICE	PRICE	PRICE	PRICE	PRICE	PRICE	PRICE	PRICE	PRICE	PRICE	PRICE	PRICE	PRICE
MODEL	SDV 5	SDV 4	SDV 12	SDV 10	SDV 4	SDV 4	SDV 4	SDV 4	SDV 4	SDV 4	SDV 4	SDV 4	SDV 4	SDV 5	SDV 5	SDV 4	SDV 4	SDV 4	SDV 4

1, 2, 3

1, 2, 3

1, 2, 3

1, 2, 3

1, 2, 3

1, 2, 4

1, 2, 4

1, 2, 3

1, 2, 3

1, 2, 3

1, 2, 3

NOTES

1. PROVIDE FULL INSTALLATION COMPLETE WITH FIELD FURNISHED/FACTORY INSTALLED WIRELESS DDC CONTROLS, DUCTWORK, POWER, AND SUPPORTS.

1, 2, 3

2. PROVIDE EACH UNIT WITH SINGLE POINT CONNECTION, STEP DOWN TRANSFORMER FOR CONTROL VOLTAGE POWER REQUIREMENTS, AND INTEGRAL POWER DISCONNECT SWITCH.

1, 2, 5

1, 2, 3

1, 2, 3

1, 2, 3

1, 2, 3

1, 2, 5

3. PROVIDE 1 STAGE ELECTRIC REHEAT COIL.

4. PROVIDE 2 STAGE ELECTRIC REHEAT COIL.

5. PROVIDE 3 STAGE ELECTRIC REHEAT COIL.

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PENSACOLA INTERNATIONAL **AIRPORT**

PENSACOLA, FLORIDA

PENSACOLA GENERAL AVIATION FACILITY (GAF)



PROFESSIONAL SEAL



REV	ISIONS					
NO.	DESCRIPTION	DA				

03/03/2020 DATE ISSUED: JEB **REVIEWED BY:** HPM DRAWN BY: HPM

PROJECT NUMBER: 201-0052-002 © 2020 RS&H, INC.

DESIGNED BY:

SHEET TITLE

MECHANICAL SCHEDULES

SHEET NUMBER

M601

LOUVER SCHEDUL	_E					
MARK	<u>LV-1</u>	<u>LV-2</u>	<u>LV-3</u>	<u>LV-4</u>	<u>LV-5</u>	<u>LV-6</u>
TYPE	DRAINABLE STATIONARY					
LOCATION	UNISEX	MECHANICAL ROOM	SECURE STORAGE	ELECTRICAL ROOM	LAN/SLAN	MEN'S RESTROOM
WIDTH (in.)	24	36	24	24	24	24
HEIGHT (in.)	12	12	18	12	24	18
FREE AREA (sqft)	0.67	1.04	1.28	0.67	1.89	1.28
FACE VELOCITY (ft/min)	225	130	400	110	400	330
PRESSURE DROP (in. w.g.)	0.01	0.01	0.03	0.01	0.03	0.02
MANUFACTURER	RUSKIN	RUSKIN	RUSKIN	RUSKIN	RUSKIN	RUSKIN
MODEL	ELF6375DXD	ELF6375DXD	ELF6375DXD	ELF6375DXD	ELF6375DXD	ELF6375DXD
NOTES	1, 2, 3	1, 2, 3, 4	1, 2, 3	1, 2, 3	1, 2, 3	1, 2, 3

NOTES

1. DRAINABLE STATIONARY LOUVER WITH 5/8"x0.40" ALUMINUM BIRDSCREEN IN REMOVABLE FRAME.

2. MAX FACE VELOCITY OF 500 FEET PER MINUTE.

3. PROVIDE WITH SECURITY GRILLE AT LOUVER. SEE SHEET M502 DETAIL 4.

4. PROVIDE WITH BACKDRAFT DAMPER.

INDOOR UNIT	
MARK	<u>AC-1</u>
AREA SERVED	LAN / SLAN
UNIT TYPE	WALL MOUNTED
TOTAL COOLING CAPACITY (MBH)	36000
COOLING DESIGN AIRFLOW (CFM)	705 - 810 - 920
SUPPLY FAN MOTOR POWER (W)	56
MCA	1
LENGTH x WIDTH x HEIGHT (in.)	46 x 12 x 14
OUTDOOR UNIT	
MARK	<u>CU-1</u>
CONDENSER FAN POWER (W)	74 (x2)
CONDENSER AIRFLOW (CFM)	3880
COMPRESSOR TYPE	INVERTER-DRIVEN TWIN ROTARY
MCA	25
MOCP	31
LENGTH x WIDTH x HEIGHT (in.)	41 x 16 x 53
GENERAL DATA	
VOLTAGE	208 / 230
PHASE	1
FREQUENCY	60
SEER	18.8
EER	10.8
REFRIGERANT TYPE	R-410A
MANUFACTURER	MITSUBISHI
MODEL (INDOOR/OUTDOOR)	PKA-A36KA7 / PUY-A36NKA7
NOTES	1 - 8
	

NOTES

1. PROVIDE SINGLE POINT POWER CONNECTION. IF ELECTRICAL DATA VARIES, PROVIDE ELECTRICAL SHOP DRAWING WITH HVAC SHOP DRAWING INDICATING CHANGES TO CIRCUIT, OVERCURRENT PROTECTION, PANEL, AND FEEDER.

2. PROVIDE INDOOR UNIT WITH MUTIPLE SPEED MOTOR AND DIRECT DRIVE FAN.

3. REFRIGERATION PIPING BETWEEN INDOOR AND OUTDOOR UNITS SHALL BE SIZED ACCORDING TO MANUFACTURER'S RECOMMENDATIONS.

4. PROVIDE CONDENSATE DRAIN FROM INDOOR UNIT TO NEAREST FLOOR DRAIN. PIPE SHALL BE FULL SIZE OF THE DRAIN CONNECTION OR 3/4", WHICHEVER IS LARGER.

5. PROVIDE COMPRESSOR SHORT CYCLE PROTECTION TO PREVENT COMPRESSOR RESTART FOR AT LEAST 5 MINUTES AFTER SHUT DOWN.

6. PROVIDE INDOOR UNIT WITH THERMAL EXPANSION VALVES.

7. PROVIDE OUTDOOR UNIT WITH REFRIGERANT SIGHT GLASS AND REFRIGERANT FILTER DRIER.

8. PROVIDE A REMOTE CONTROLLER WITH THE UNIT THAT INCLUDES ALL CONTROLS FOR COOLING MODES WITH BACNET INTERFACE CAPABILITY.

CKAGED AIR CONDITIONING UNIT SO	CHEDULE
	540.4

MARK	<u>PAC-1</u>
AREA SERVED	ENTIRE BUILDING
TOTAL COOLING CAPACITY (MBH)	262.29
COOLING DESIGN AIRFLOW (CFM)	6500
MINIMUM OUTSIDE AIRFLOW (CFM)	1720
SUMMER DESIGN OUTSIDE AIR TEMPERATURE (°F DB/WB)	94 / 77
WINTER DESIGN OUTSIDE AIR TEMPERATURE (°F DB)	29
HEAT PUMP CAPACITY (MBH)	225.3
AUXILIARY HEAT CAPACITY (kW)	20
HOT GAS REHEAT CAPACITY (MBH)	120
HOT GAS REHEAT LAT (°F DB/WB)	70 / 59
COOLING EAT (°F DB/WB)	80 / 67
COOLING LAT (°F DB/WB)	55 / 53
SUPPLY FAN MOTOR HORSEPOWER (HP)	7.5
SUPPLY FAN EXTERNAL STATIC PRESSURE (in. w.g.)	2.25
TOTAL STATIC PRESSURE (in. w.g.)	3.63
EXHAUST FAN HORSEPOWER (HP)	5
EXHAUST FAN EXTERNAL STATIC PRESSURE (in. w.g.)	0.75
VOLTAGE	460
PHASE	3
FREQUENCY	60
MCA	66
MOCP	80
EER	8.7
FLA	61
LENGTH x WIDTH x HEIGHT (in.)	138 x 101 x 59
OPERATING WEIGHT (LBS)	3079
REFRIGERANT TYPE	R-410A
MANUFACTURER	AAON
MODEL	RN-025-3-0-E609-122
NOTES	1 - 20

NOTES

1. UNIT TO BE A HEAT PUMP WITH AUXILIARY HEAT.

2. PROVIDE RACKS FOR 2" THICK (30% EFFICIENCY) PRE-FILTER AND 4" THICK (85% EFFICIENCY, MERV 13) FINAL FILTER.

3. UNIT SHALL BE DOUBLE WALL CONSTRUCTION DESIGNED AND BUILT FOR OUTDOOR INSTALLATION.

4. UNIT SHALL HAVE MOTORIZED OUTSIDE AIR DAMPER.

5. PROVIDE UNIT WITH VARIABLE FREQUENCY DRIVE CONTROL ON SUPPLY AND EXHAUST FANS.

6. PROVIDE BACNET COMPATIBLE BAS INTERFACE AND PAC CONTROLLER.

7. PROVIDE UNIT MOUNTED DISCONNECTS.

8. PROVIDE UNIT WITH MODULATING HOT GAS REHEAT.

9. PROVIDE UNIT WITH 32" HIGH STAINLESS STEEL PLENUM CURB WITH HURRICANE TIE-DOWN. CURB BY MGM PRODUCTS, INC OR APPROVED EQUAL.

12. PROVIDE UNIT WITH A SMOKE DETECTOR IN SUPPLY AND RETURN AIR PATHS.

13. PROVIDE UNIT WITH TEMPERATURE SENSOR, HUMIDISTAT, AND CO2 SENSORS MOUNTED IN THE RETURN AIR PATH.

15. PROVIDE UNIT WITH AIR FLOW MONITORING STATION INTEGRAL TO UNIT AND CONTROLLED BY CO2 SENSOR.

16. MAINTAIN MANUFACTURER'S RECOMMENDED CLEARANCES.

17. ESP ONLY INCLUDES LOSSES EXTERNAL TO THE UNIT.

18. ROUTE 1" CONDENSATE DRAIN LINE TO YARD DRAIN. SEE PLUMBING DRAWINGS FOR DETAILS.

19. PROVIDE UNIT WITH 115V 1-PHASE CONVENIENCE OUTLET.

20. PROVIDE UNIT WITH 100% OUTSIDE AIR ECONOMIZER AND MODULATING POWERED EXHAUST COMBINATION PACKAGE COMPLETE WITH ACTUATOR, CONTROLS, AND ALL NECESSARY PANELS AND HARDWARE.



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NO. DESCRIPTION DATE

	DATE	03/03/2020	
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REVISIONS

DRAWN BY:

DESIGNED BY:

PROJECT NUMBER:

201-0052-002

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SHEET TITLE

HPM

MECHANICAL SCHEDULES

SHEET NUMBER

M602


	CONTROL POINT LIST: <u>EF-1</u> - <u>EF-4</u> , <u>EF-6</u>	
POINT DESIGNATION	DESCRIPTION	CONTROLLED BY
ES1	EXHAUST FAN STARTER - START/STOP	BAS
ES2	EXHAUST FAN CURRENT TRANSDUCER	

CONTROL POINT LIST: <u>EF-5</u>						
POINT DESIGNATION	DESCRIPTION	CONTROLLED BY				
ES1	EXHAUST FAN STARTER - START/STOP	SWITCH				
ES2	EXHAUST FAN CURRENT TRANSDUCER					

FAN SEQUENCE:


EXHAUST FAN

EXHAUST FANS <u>EF-1</u> THROUGH <u>EF-4</u> & <u>EF-6</u> SHALL BE ACTIVATED BY BAS SYSTEM. EXHAUST FAN <u>EF-5</u> SHALL BE ACTIVATED BY MANUAL SWITCH TO BE PROVIDED AT THE FUME HOOD. <u>EF-1</u>, <u>EF-3</u>, <u>EF-4</u>, <u>EF-5</u>, & <u>EF-6</u> SHALL BE INTERLOCKED WITH CORRESPONDING MOTORIZED DAMPER IN EXHAUST AIR DUCT. IN ADDITION, EF-2 & EF-4 SHALL BE INTERLOCKED WITH MOTORIZED DAMPER IN TRANSFER AIR DUCT. WHEN THE EXHAUST FAN IS ACTIVATED, THE MOTORIZED DAMPER(S) SHALL OPEN. MOTORIZED DAMPER(S) SHALL CLOSE WHEN THE EXHAUST FAN IS DE-ACTIVATED. ALL EXHAUST FANS SHALL BE INTERLOCKED WITH <u>PAC-1</u>. WHENEVER THE EXHAUST FAN IS RUNNING, THE PAC UNIT SHALL BE ACTIVATED.

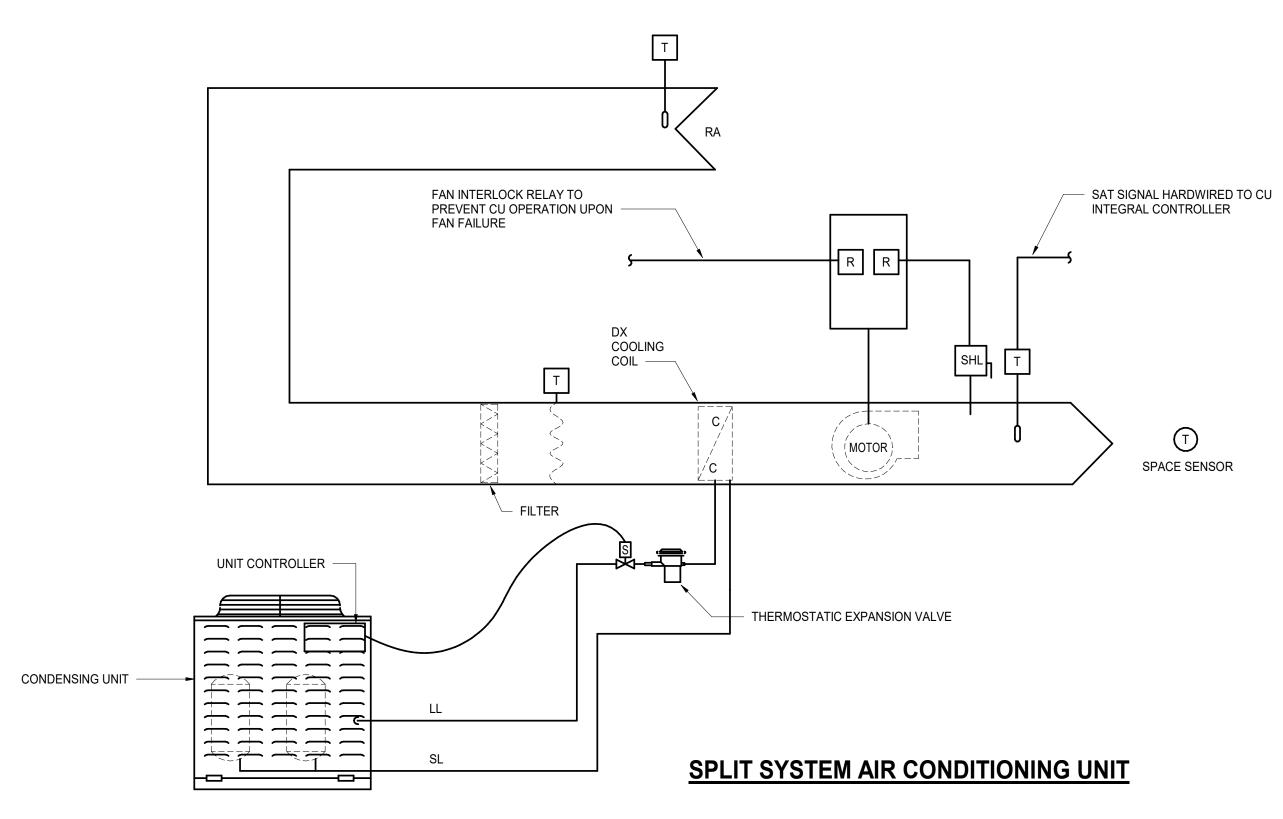

NOTES:

SEE SPECIFICATION SECTION 230993 FOR SEQUENCE OF OPERATIONS.

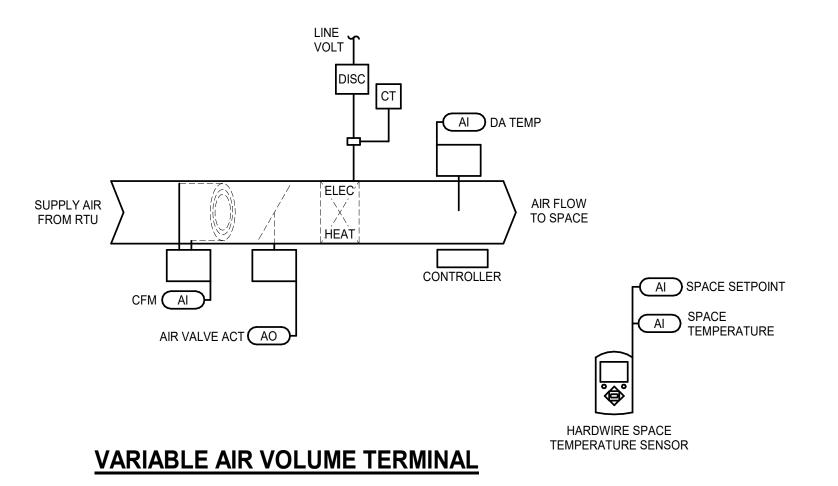

VAV TERMINAL WITH SENSOR SEQUENCE OF OPERATIONS:

SYSTEM CONTROLLER INTERFACE: THE BACNET COMPLIANT SYSTEM CONTROLLER (SC) SHALL SEND THE VAV CONTROLLER AN OCCUPIED OR UNOCCUPIED COMMAND. THE SC MAY ALSO SEND TEMPERATURE AND/OR SPACE TEMPERATURE SETPOINT TO THE VAV CONTROLLER. IF SPACE COMMUNICATION IS LOST WITH THE SC THE VAV CONTROLLER SHALL OPERATE USING ITS LOCAL OR DEFAULT SETPOINTS.

OCCUPANCY MODE: THE OCCUPANCY MODE SHALL BE HARDWIRED TO THE VAV VIA A BINARY INPUT. VALID OCCUPANCY MODES FOR THE VAV SHALL BE:

OCCUPIED: NORMAL OPERATING MODES FOR OCCUPIED SPACES OR DAYTIME OPERATION. WHEN THE VAV UNIT IS IN THE OCCUPIED MODE, THE SPACE TEMPERATURE WILL BE MAINTAINED AT THE SENSOR'S OCCUPIED COOLING SETPOINT OF 75°F (ADJ.). ON AN INCREASE IN SPACE TEMPERATURE ABOVE THE OCCUPIED SPACE TEMPERATURE SETPOINT (ADJ.), THE VAV CONTROLLERS WILL MODULATE THE VAV DAMPER BETWEEN THE MINIMUM AND MAXIMUM POSITION TO MAINTAIN THE OCCUPIED SETPOINT. IF COMMUNICATION TO THE SC IS LOST, THE SPACE TEMPERATURE SHALL BE CONTROLLED TO THE LOCAL SPACE SENSOR'S DEFAULT SETPOINT AS PROGRAMMED DURING COMMISSIONING.

ON A DECREASE IN ZONE SPACE TEMPERATURE BELOW THE SENSOR'S OCCUPIED SPACE TEMPERATURE SETPOINT (ADJ.), THE CONTROLLER SHALL MODULATE THE VAV DAMPER TOWARD THE MINIMUM POSITION TO MAINTAIN THE SPACE TEMPERATURE SETPOINT.

THE VAV SHALL USE THE MEASURED SPACE TEMPERATURE AND THE COOLING SETPOINT TO DETERMINE THE REQUESTED COOLING CAPACITY OF THE UNIT.

HEATING CONTROL: DURING ALL OCCUPIED MODES, AS THE SPACE TEMPERATURE FALLS BELOW THE SENSOR'S HEATING SETPOINT, THE VAV DAMPER SHALL MODULATE TO ITS MINIMUM HEATING AIRFLOW POSITION. UPON A CONTINUED DROP IN TEMPERATURE AND/OR UNIT AIRFLOW, THE ELECTRIC DUCT REHEAT SHALL BE CYCLED TO MAINTAIN THE SENSOR'S HEATING SETPOINT. THE VAV TERMINAL'S ELECTRIC DUCT REHEAT SHALL BE ENERGIZED BASED ON THE LENGTH OF TIME HEAT HAS BEEN REQUESTED AND TEMPERATURE DEVIATION FROM THE SETPOINT.

ON AN INCREASE IN SPACE TEMPERATURE THE REVERSE SHALL OCCUR.

APPLICABLE VENTILATION AND AIRFLOW SETPOINTS SHALL BE ENFORCED. THE OCCUPIED MODE SHALL BE THE DEFAULT MODE OF THE VAV.

UNOCCUPIED: NORMAL OPERATING MODE FOR UNOCCUPIED SPACES OR NIGHTTIME OPERATION. WHEN THE VAV UNIT IS IN THE UNOCCUPIED MODE THE VAV CONTROLLER SHALL MAINTAIN THE SPACE TEMPERATURE AT THE UNOCCUPIED TEMPERATURE SETPOINTS. WHEN THE SPACE TEMPERATURES FALL BELOW THE UNOCCUPIED HEATING SETPOINT OF 60°F (ADJ.), THE PAC UNIT SUPPLY FAN SHALL START AT THE MINIMUM CFM SETTING AND THE VAV UNIT SHALL MODULATE THE DAMPER TO ITS MINIMUM POSITION. THE VAV SHALL CYCLE ITS ELECTRIC DUCT HEAT STAGES TO MAINTAIN THE NIGHT SETBACK SPACE TEMPERATURE SETPOINT OF 60°F (ADJ.).

WHEN THE SPACE TEMPERATURES RISES ABOVE THE UNOCCUPIED HEATING SETPOINT 60°F (ADJ.) PLUS THE UNOCCUPIED DIFFERENTIAL 2°F (ADJ.), THE PAC UNIT'S SUPPLY FAN WILL STOP, THE VAV UNIT'S ELECTRIC DUCT REHEAT SHALL BE DISABLED AND THE VAV UNIT WILL RETURN TO THE UNOCCUPIED MODE.

WHEN THE SPACE TEMPERATURES RISE ABOVE THE UNOCCUPIED COOLING SETPOINT OF 85°F (ADJ.), THE PAC UNIT'S SUPPLY FAN WILL START, THE VAV UNIT SHALL OPEN THE DAMPER TO ITS MAXIMUM POSITION AND THE PAC UNIT'S STAGES OF DX COOLING WILL CYCLE TO MAINTAIN THE OCCUPIED DISCHARGE AIR TEMPERATURE SETPOINT (ADJ.). WHEN THE SPACE TEMPERATURE FALLS BELOW THE UNOCCUPIED COOLING SETPOINT OF 85°F (ADJ.) MINUS THE UNOCCUPIED DIFFERENTIAL 2°F (ADJ.), THE PAC UNIT'S SUPPLY FAN WILL STOP, THE DX COOLING STAGES WILL BE DE-ENERGIZED AND THE VAV UNIT SHALL RETURN TO THE UNOCCUPIED MODE.

SPACE SENSOR FAILURE: IF THERE IS A FAULT WITH THE OPERATION OF THE ZONE SENSOR, AN ALARM SHALL BE ANNUNCIATED AT THE LOCAL CONTROLLED PANEL. SPACE SENSOR FAILURE SHALL CAUSE THE VAV UNIT TO DRIVE THE DAMPER TO MINIMUM AIR FLOW IF THE VAV UNIT IS IN THE OCCUPIED MODE, OR DRIVE IT CLOSED AND DISABLE THE ELECTRIC REHEAT IF THE VAV UNIT IS IN THE UNOCCUPIED MODE.



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REVISIONS NO. DESCRIPTION DATE

DATE ISSUED: 03/03/2020
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HPM

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DESIGNED BY:
PROJECT NUMBER:
201-0052-002

DRAWN BY:

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SHEET TITLE

MECHANICAL CONTROLS SCHEMATICS

SHEET NUMBER

M801

2. SEE SPECIFICATION SECTION 230993 FOR SEQUENCE OF OPERATIONS.

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MECHANICAL CONTROLS SCHEMATICS

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SHEET TITLE

SHEET NUMBER

M802

ACP	 ACCESS CONTROL PANEL
AF	 AMP FUSE
AFF	 ABOVE FINISHED FLOOR
AFG	 ABOVE FINISHED GRADE
AHU ATS	 AIR HANDLING UNIT AUTOMATIC TRANSFER SWITCH
С	 CONDUIT
СВ	 CIRCUIT BREAKER
СКТ	 CIRCUIT
CFL	 COMPACT FLUORESCENT
CGB CH	COMMUNICATION GROUND BAR COUNTER HEIGHT
DDC/BAS	 DIRECT DIGITAL CONTROL PANEL (HVAC)
DHZ	 DAYLIGHT HARVESTING ZONE (SEE LIGHTING PLANS AND LIGHTING CONTROL NARRATIVE)
EPO EX	 EMERGENCY POWER OFF EXISTING
FAAP	 FIRE ALARM ANNUNCIATOR PANEL
FACP	FIRE ALARM CONTROL PANEL
FATC FPC	FIRE ALARM TERMINAL CABINET FUEL PUMP CONTROLLER
FRAP	 FIRE ALARM REMOTE ANNUNCIATOR PANEL
GB	 GROUND BAR
GCTC	 GATE CONTROL TERMINATION CABINET
GFCI	 GROUND FAULT CIRCUIT INTERRUPTER
GFGI	 GOVERNMENT FURNISHED GOVERNMENT INSTALLED
GND	 GROUND
INT	 INTERCOM
JB	 JUNCTION BOX
LT	 LIGHT
KVA	 KILOVOLT AMPERE
МВ	 MAIN BREAKER
MDF	 MAIN DISTRIBUTION FRAME
MNS	 MASS NOTIFICATION SYSTEM
MLO	 MAIN LUGS ONLY
MNT	 MOUNTED
NIC	 NOT IN CONTRACT
NL	 NIGHT LIGHT
ОН	 OVERHEAD
oc	AT COUNTER
os	 OCCUPANCY SENSOR
PA	
	 PUBLIC ADDRESS
PNL	PANEL
PROJ SCRN	PROJECTION SCREEN
REF	REFRIGERATOR
RECEPT	 RECEPTACLE
SEGB	SERVICE ENTRANCE GROUND BAR
SPD	 SURGE PROTECTIVE DEVICE
SWBD	 SWITCHBOARD
TYP	 TYPICAL
UDS	 UTILITY DISTRIBUTION SYSTEM
UNO	 UNLESS NOTED OTHERWISE
UTP	 UNSHIELDED TWISTED PAIR
V	 VOLT
VFD	VARIABLE FREQUENCY DRIVE
=	
WP	WEATHERPROOF

		LED 2' x 2' EMERGENCY LUMINAIRE. SEE LUMINAIRE SCHEDULE FOR ADDITIONAL INFORMATION.
		LED 2' x 2' LUMINAIRE. SEE LUMINAIRE SCHEDULE FOR ADDITIONAL INFORMATION.
		LED SUSPENDED 1' x 4' LUMINAIRE.
		SEE LUMINAIRE SCHEDULE FOR ADDITIONAL INFORMATION. LED WALL MOUNTED 1' x 4' LUMINAIRE.
		SEE LUMINAIRE SCHEDULE FOR ADDITIONAL INFORMATION RECESSED DOWN LIGHT, SEE LUMINAIRE SCHEDULE FOR ADDITIONAL INFORMATION.
		EXTERIOR WALL MOUNTED LUMINAIRE. HALF SHADED CENTER INDICATES EMERGENCY
-		BALLAST/DRIVER. MOUNTED AT 9'-0" ABOVE GRADE, UNO. WALL MOUNTED AND CEILING MOUNTED LED EXIT SIGN. SHADED AREA INDICATES
$lack \otimes$		DIRECTION OF FACE. ARROW POINTS IN DIRECTION OF CHEVRON.
\$	4'-0" TO ♀	SWITCH, SINGLE POLE. AMP 120/277 VOLT. (E) INDICATES EXISTING TO REMAIN (TYP.)
\$ ²	4'-0" TO ℚ	SWITCH, TWO POLE. 20 AMP 120/277 VOLT.
\$ ³	4'-0" TO ♀	SWITCH, THREE POLE. 20 AMP 120/277 VOLT.
\$ ⁴	4'-0" TO ♀	SWITCH, FOUR POLE. 20 AMP 120/277 VOLT.
\$ ^{LV}	4'-0" TO $^{\mathbb{Q}}$	LOW VOLTAGE SWITCH, CONNECTED TO OCCUPENCY SENSOR
\$os	4'-0" TO ℚ	SWITCH, OCCUPANCY SENSOR, 1000 SQ. FT. AND 180 DEGREE COVERAGE, ULTRASONIC AND INFRARED, MANUAL ON.
\$ ^D	4'-0" TO ♀	SWITCH, DIMMER.
\$ ^M	4'-0" TO ♀	MOTOR RATED SWITCH. (MANUAL MOTOR STARTER). COORDINATE POLE AND AMPACITY OF MOTOR BEING CONTROLLED.
\$OSD	4'-0" TO ℚ	SWITCH, OCCUPANCY SENSOR/DIMMER, WALL MOUNTED, ULTRASONIC AND INFRARED, 1000 SF AND 180 DEGREE COVERAGE, AUTOMATIC TO 50% LIGHT LEVEL WHEN OCCUPANCY IS SENSED, SWITCH MANUAL ON FROM SWITCH TO 100%. SWITCH MANUAL OFF, INCLUDES MANUAL ADJUSTMENT OF LIGHT LEVEL ONE STEP BETWEEN 50% AND 70% OF FULL LEVEL, AUTOMATICALLY TURN OFF 15 MINUTES AFTER NO ACTIVITY IS DETECTED, UTILIZES 0-10 V FOR DIMMING CONTROL.
\$ ^{30SD}	4'-0" TO ℚ	3-WAY SWITCH, OCCUPANCY SENSOR/DIMMER, THREE POLE. 20 AMP 120/277 VOLT. AND 180 DEGREE COVERAGE, AUTOMATIC TO 50% LIGHT LEVEL WHEN OCCUPANCY IS SENSED, SWITCH MANUAL ON FROM SWITCH TO 100%. SWITCH MANUAL OFF, INCLUDES MANUAL ADJUSTMENT OF LIGHT LEVEL ONE STEP BETWEEN 50% AND 70% OF FULL LEVEL, AUTOMATICALLY TURN OFF 15 MINUTES AFTER NO ACTIVITY IS DETECTED, UTILIZES 0-10 V FOR DIMMING CONTROL.
\$ ^{vs}	4'-0" TO ℚ	SWITCH, VACANCY SENSOR, WALL MOUNTED, ULTRASONIC AND INFRARED, 1000 SF AND 180 DEGREE COVERAGE, AUTOMATIC TO 50% LIGHT LEVEL WHEN OCCUPANCY IS SENSED, SWITCH MANUAL ON FROM SWITCH TO 100%. SWITCH MANUAL OFF, AUTOMATICALLY TURN OFF 15 MINUTES AFTER NO ACTIVITY IS DETECTED, UTILIZES 0-10 V FOR DIMMING CONTROL.
\$ ^{VSD}	4'-0" TO ℚ	SWITCH, VACANCY SENSOR/DIMMER, WALL MOUNTED, ULTRASONIC AND INFRARED, 1000 SF AND 180 DEGREE COVERAGE, AUTOMATIC TO 50% LIGHT LEVEL WHEN OCCUPANCY IS SENSED, SWITCH MANUAL ON FROM SWITCH TO 100%. SWITCH MANUAL OFF, INCLUDES MANUAL ADJUSTMENT OF LIGHT LEVEL ONE STEP BETWEEN 50% TO 70% OF FULL LEVEL, AUTOMATICALLY TURN OFF 15 MINUTES AFTER NO ACTIVITY IS DETECTED UTILIZES 0-10 V FOR DIMMING CONTROL.
OS		OCCUPANCY SENSOR, CEILING MOUNTED, ULTRASONIC AND INFRARED, 2000 SF COVERAGE, QUICK TO INSTALL CONNECTOR
TC		ELECTRONIC TIME CLOCK
D		PHOTOCELL, DAYLIGHTING SENSOR
POWE	<u>R</u>	
\ominus		RECEPTACLE, DUPLEX, NEMA 5-20R. 18" UNO TO CENTERLINE.
		FLOOR MOUNTED RECEPTACLE, QUADRUPLEX, NEMA 5-20R.
∌ 1	ı'-6" TO ℚ	RECEPTACLE, QUADRUPLEX, NEMA 5-20R.
·'		RECEPTACLE, SIMPLEX, NEMA 5-20R. 8'-0" TO CENTERLINE, UNO.
) ()		SPECIAL PURPOSE RECEPTACLE. COORDINATE NEMA CONFIGURATION WITH
	_	EQUIPMENT.
		ELECTRICAL CONNECTION POINT
J		JUNCTION BOX, 4" SQUARE MINIMUM, SEE PLANS FOR ADDITIONAL SIZES
J		JUNCTION BOX, 4" SQUARE MINIMUM, WALL MOUNTED.
		PANELBOARD, MOUNTED 6'-6" TO TOP OF OPERATING HANDLE, VOLTAGE AS INDICATED ON PANEL SCHEDULE, DASHED LINE ASSOCIATED TO PANELBOARD INDICATES 3' WORKING CLEARANCE
3 <u>30</u>		DISCONNECT SWITCH, MOUNTED 6'-6" TO TOP OF OPERATING HANDLE, SIZE AS INDICATED ON PLANS. 3 POLE, 30A RATED, 20A FUSED SHOWN, 30 A NF NEMA 1 UNO.
	'-0" TO ♀	VARIABLE FREQUENCY DRIVE
⊴ 4	יים TO ⊈	MOTOR STARTER, COMBINATION DISCONNECT. PROVIDE MOTOR OVERLOADS
Т		SIZED AS REQUIRED FOR THE MOTOR BEING SERVED, STARTER SHALL BE NEMA 1 UNO. DRY TYPE TRANSFORMER IN NEMA 1 ENCLOSURE, UNO.
)B		ELECTRICAL DUCT BANK (EDB)
		GENERATOR EMERGENCY SHUT OFF BUTTON. PROVIDE "BREAK GLASS" EMERGENCY POWER OFF BUTTON IN RED NEMA 3R ENCLOSURE WITH HAMMER. MOUNT BUTTON NO HIGHER THAN 78" ABOVE GROUND. PROVIDE PLACARD PER SPECIFICATIONS STATING "EMERGENCY POWER OFF".

 FIRE ALARM CONTROL PANEL.
 FIRE ALARM ANNUNCIATOR PANEL.
 FLOW SWITCH
 HIGH/LOW PRESSURE SWITCH (PRE-ACTION SYSTEM)
 TAMPER SWITCH
 FLUSH MOUNTED MANUAL FIRE ALARM PULL STATION, 48 INCH MOUNTING HEIGHT
 SEMI-FLUSH MOUNTED FIRE ALARM HORN STROBE DEVICE, MOUNT 80-96 INCH FROM FLOOR TO BOTTOM OF LENS OR 6" BELOW CEILING, WHICHEVER IS LESS. 15 INDICATES CANDELA RATING. DEVICES NOT LABELED SHALL BE 75 CANDELAS
 HORN, WEATHERPROOF, 90" MOUNTING HEIGHT
 SEMI-FLUSH FIRE ALARM VISUAL STROBE DEVICE, WALL MOUNT, 80-96 INCH FROM FLOOR BOTTOM OF LENS OR 6" BELOW CEILING, WHICHEVER IS LESS. XX INDICATES CANDELA RATING. DEVICES NOT LABELED SHALL BE 75 CANDELAS.
 CEILING MOUNTED FIRE ALARM HORN STROBE DEVICE. 15 INDICATES CANDELA RATING. DEVICES NOT LABELED SHALL BE 75 CANDELAS
 CEILING MOUNTED FIRE ALARM VISUAL STROBE DEVICE. 15 INDICATES CANDELA RATING. DEVICES NOT LABELED SHALL BE 75 CANDELAS.
 FLUSH WALL MOUNTED DOOR HOLDING DEVICE - MOUNT 70 INCH AFF.
 ADDRESSABLE CEILING MOUNTED SMOKE DETECTOR. FSD: FIRE SMOKE DAMPER, SD: SMOKE DAMPER
 ADDRESSABLE DUCT MOUNTED SMOKE DETECTOR, MOUNTED IN A/C DUCT
 ADDRESSABLE CEILING MOUNTED HEAT DETECTOR, COMBINATION FIXED TEMPERATURE/RATE OF RIS
 ADDRESSABLE CEILING MOUNTED HEAT DETECTOR, COMBINATION FIXED TEMPERATURE/RATE OF RISE. PROGRAM FOR FIXED TEMPERATURE ONLY COVERAGE.
 NON-ADDRESSABLE CEILING MOUNTED HEAT DETECTOR, FIXED TEMPERATURE TYPE, RATED FOR 200 DEGREES
 NON-ADDRESSABLE CEILING MOUNTED HEAT DETECTOR, EXPLOSION PROOF.
 EXHAUST FAN SHUT DOWN RELAY.
 GAS VALVE RESET SWITCH.
 GAS SOLENOID VALVE, NORMALLY-CLOSED, 24VDC
SURGE PROTECTION

SINGLE LINE DI	AGRAM SYMBOLS
——————————————————————————————————————	(PT) POTENTIAL TRANSFORMER GROUND FAULT TRIPPING MECHANISM WITH SENSING CO
	SURGE ARRESTER
	DISCONNECT SWITCH
	FUSE
	FUSED CUTOUT OR LOADBREAK FUSED SWITCH
 «>>	DRAWOUT DEVICE
	CIRCUIT BREAKER OR MOTOR CICUIT PROTECTOR
	POWER OR DISTRIBUTION TRANSFORMER
\	TRANSFER SWITCH
25	MOTOR (NUMBER DENOTES HP)
PANEL	SINGLE SECTION PANELBOARD (ADDITIONAL SECTIONS SHOWN, IF REQUIRED)
	LOAD BANK TAP BOX

<u>LIGHTN</u>	<u>IING PROT</u>	ECTION LEGEND
•		AIR TERMINAL ON ROOF
<u>—</u> II		GROUD ROD
•		ROOF/DOWN CONDUCTOR
		BARE COPPER COUNTERPOISE
•		EXOTHERMIC BOND

HORIZONTAL BUSDUCT (BUSWAY)

EMERGENCY GENERATOR

SURGE PROTECTION DEVICE

WYE CONNECTION

POWER METER

PM

ABBREVIATIONS

SHEET NUMBER

E001

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SHEET TITLE

ELECTRICAL

GENERAL NOTES,

SYMBOLS AND

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PENSACOLA, FLORIDA

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AVIATION

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NO. DESCRIPTION DATE

03/03/2020

WM/RB WM/RB

REVISIONS

DATE ISSUED: REVIEWED BY: DRAWN BY:

DESIGNED BY: PROJECT NUMBER:

	L	UMINAIRE S	CHEDULE					
Гуре Mark	Description	Manufacturer	Model	Voltage	Lamp	Initial Color Temperature	Wattage	Lumens
1	144 LEDS (2 BOARDS) 2x2'RECESSED TROFFER LUMINAIRE WHITE REFLECTOR w/PAT 12 LENS PRISMS DOWN 0-10 DRIVER	WILLIAMS	50G-S22-L26-940-SAF12125-xxx-xxx OR APPROVED EQUAL	277 V	LED	4000 K	21 W	2602 lm
1E	GENERAL PURPOSE LED TROFFER 2'X2' WITH 2600 NOMINAL LUMENS #A12 ACRYLIC LENS WITH BATTERY BACKUP	WILLIAMS	50G-S-22-L26/940-EM/10W OR APPROVED EQUAL	277 V	LED	4000 K	21 W	2602 lm
2	144 LEDS (2 BOARDS) 2x2'RECESSED TROFFER LUMINAIRE WHITE REFLECTOR w/PAT 12 LENS PRISMS DOWN 0-10V DRIVER	WILLIAMS	50G-S22-L43-940-SAF12125-xxx-xxx OR APPROVED EQUAL	277 V	LED	4000 K	21 W	4300 lm
2E	GENERAL PURPOSE LED TROFFER 2'X2' WITH 2600 NOMINAL LUMENS #A12 ACRYLIC LENS WITH A BATTERY BACKUP	WILLIAMS	50G-S-22-L43/940-EM/10W OR APPROVED EQUAL	277 V	LED	4000 K	21 W	4300 lm
3	2x2 F017T8 STEEL DOOR PATTERN-12	WILLIAMS	50G-S22-217-SA12125 OR APPROVED EQUAL	277 V	LED	4000 K	21 W	2800 lm
3E	GENERAL PURPOSE LED TROFFER 2'X2' WITH 2600 NOMINAL LUMENS #A12 ACRYLIC LENS WITH BATTERY BACKUP	WILLIAMS	50G-S-22-L26/940-EM/10W OR APPROVED EQUAL	277 V	LED	4000 K	21 W	2800 lm
1	RECESSED 6" ROUND DOWN LIGHT, CANOPY/WET LOCATION	WILLIAMS	6DR-TL-L10-840-DIM-UNV-OW-OF-CS-WET-CC	277 V	LED	4000 K	9 W	1000 lm
1E	RECESSED 6" ROUND DOWN LIGHT, CANOPY/WET LOCATION, BATTERY BACKUP	WILLIAMS	6DR-TL-L10-840-DIM-UNV-OW-OF-CS-WET-CC	277 V	LED	4000 K	9 W	1000 lm
I	RECESSED 6" ROUND DOWN LIGHT	WILLIAMS	6DR-TL-L10-840-DIM-UNV-OW-OF-CS	277 V	LED	4000 K	9 W	1000 lm
1E	RECESSED 6" ROUND DOWN LIGHT, BATTERY BACKUP	WILLIAMS	6DR-TL-L10-840-DIM-UNV-OW-OF-CS	277 V	LED	4000 K	9 W	1000 lm
1	4' ENCOLSED & GASKETED LED LUMINAIRE WITH SHALLOW ACRYLIC LINEAL RIBBED FROSTED LENS	WILLIAMS	96-4-L62/940-DCL OR APPROVED EQUAL	277 V	LED	4000 K	69 W	6200 lm
1E	4' ENCLOSED & GASKETED LED LUMINAIRE WITH SHALLOW ACRYLIC LINEAL RIBBED FROSTED LENS WITH BATTERY BACKUP	WILLIAMS	96-4-L62/940-DCL-EM/10W OR APPROVED EQUAL	277 V	LED	4000 K	69 W	6200 lm
2	4' ENCOLSED & GASKETED LED LUMINAIRE WITH SHALLOW ACRYLIC LINEAL RIBBED FROSTED LENS	WILLIAMS	96-4-L40-940-DCL OR APPROVED EQUAL	277 V	LED	4000 K	38 W	4000 lm
2E	4' ENCOLSED & GASKETED LED LUMINAIRE WITH SHALLOW ACRYLIC LINEAL RIBBED FROSTED LENS WITH BATTERY BACKUP	WILLIAMS	96-4-L40/940-DCL OR APPROVED EQUAL	277 V	LED	4000 K	38 W	4000 lm
	VSX-1 LED WITH 1 LIGHT ENGINE 32 LEDS 530mA DRIVER 4000K LED TYPE 4	VISIONAIRE	VSX-1-T4-32LC-5-4K-UNV-AM OR APPROVED EQUAL	277 V	LED	4000 K	52 W	6228 lm
1	WITH WHITE INTERIOR AND WHITE LENS OVER PERFORATIONS	WILLIAMS INDOOR.	AI3P33F-4-332 OR APPROVED EQUAL	277 V	LED	4000 K	20 W	3000 lm
2	LINEAR SURFACE MOUNT	FINELITE, INC.	HP-4-WM-WL-D-4ft-B-840-F OR APPROVED EQUAL	277 V	LED	4000 K	39 W	3500 lm
1	2X2 RECESSED MOUNTED, DETENTION GRADE, TAMPER PROOF	CERTOLUX	VRUI-2X2-LED840K035LUNV-P82P08 OR APPROVED EQUAL	277 V	LED	4000 K	24 W	5500 lm
1E	2X2 RECESSED MOUNTED, DETENTION GRADE, TAMPER PROOF, BATTERY BACKUP	CERTOLUX	VRU12X2A/PLED840K055LUNV-P48/P08-B39 OR APPROVED EQUAL	277 V	LED	4000 K	24 W	5500 lm
2	RECESSED VANDAL RESISTANT DOWNLIGHT	KIRLIN	LRV-07469-1500L-WFL OR APPROVED EQUAL	277 V	LED	4100 K	20 W	1500 lm
ΣE	RECESSED VANDAL RESISTANT DOWNLIGHT, BATTERY BACKUP	KIRLIN	LRV-07469-1500L-ERH OR APPROVED EQUAL	277 V	LED	4100 K	20 W	1500 lm
	LED EXIT LIGHTING, BATTERY BACKUP	BEGHELLI	ATX-HT-LR-1 OR APPROVED EQUAL	277 V	LED	0 K	2 W	
)	LED EXIT LIGHTING, BATTERY BACKUP	BEGHELLI	ATX-HT-LR-2 OR APPROVED EQUAL	277 V	LED	0 K	2 W	
1	PARKING LOT LIGHTING	SIGNIFY	ECF-L-80L-900MA-NW-G2-AR-4-UNV	277V	LED	3000 K	225 W	27138 lm



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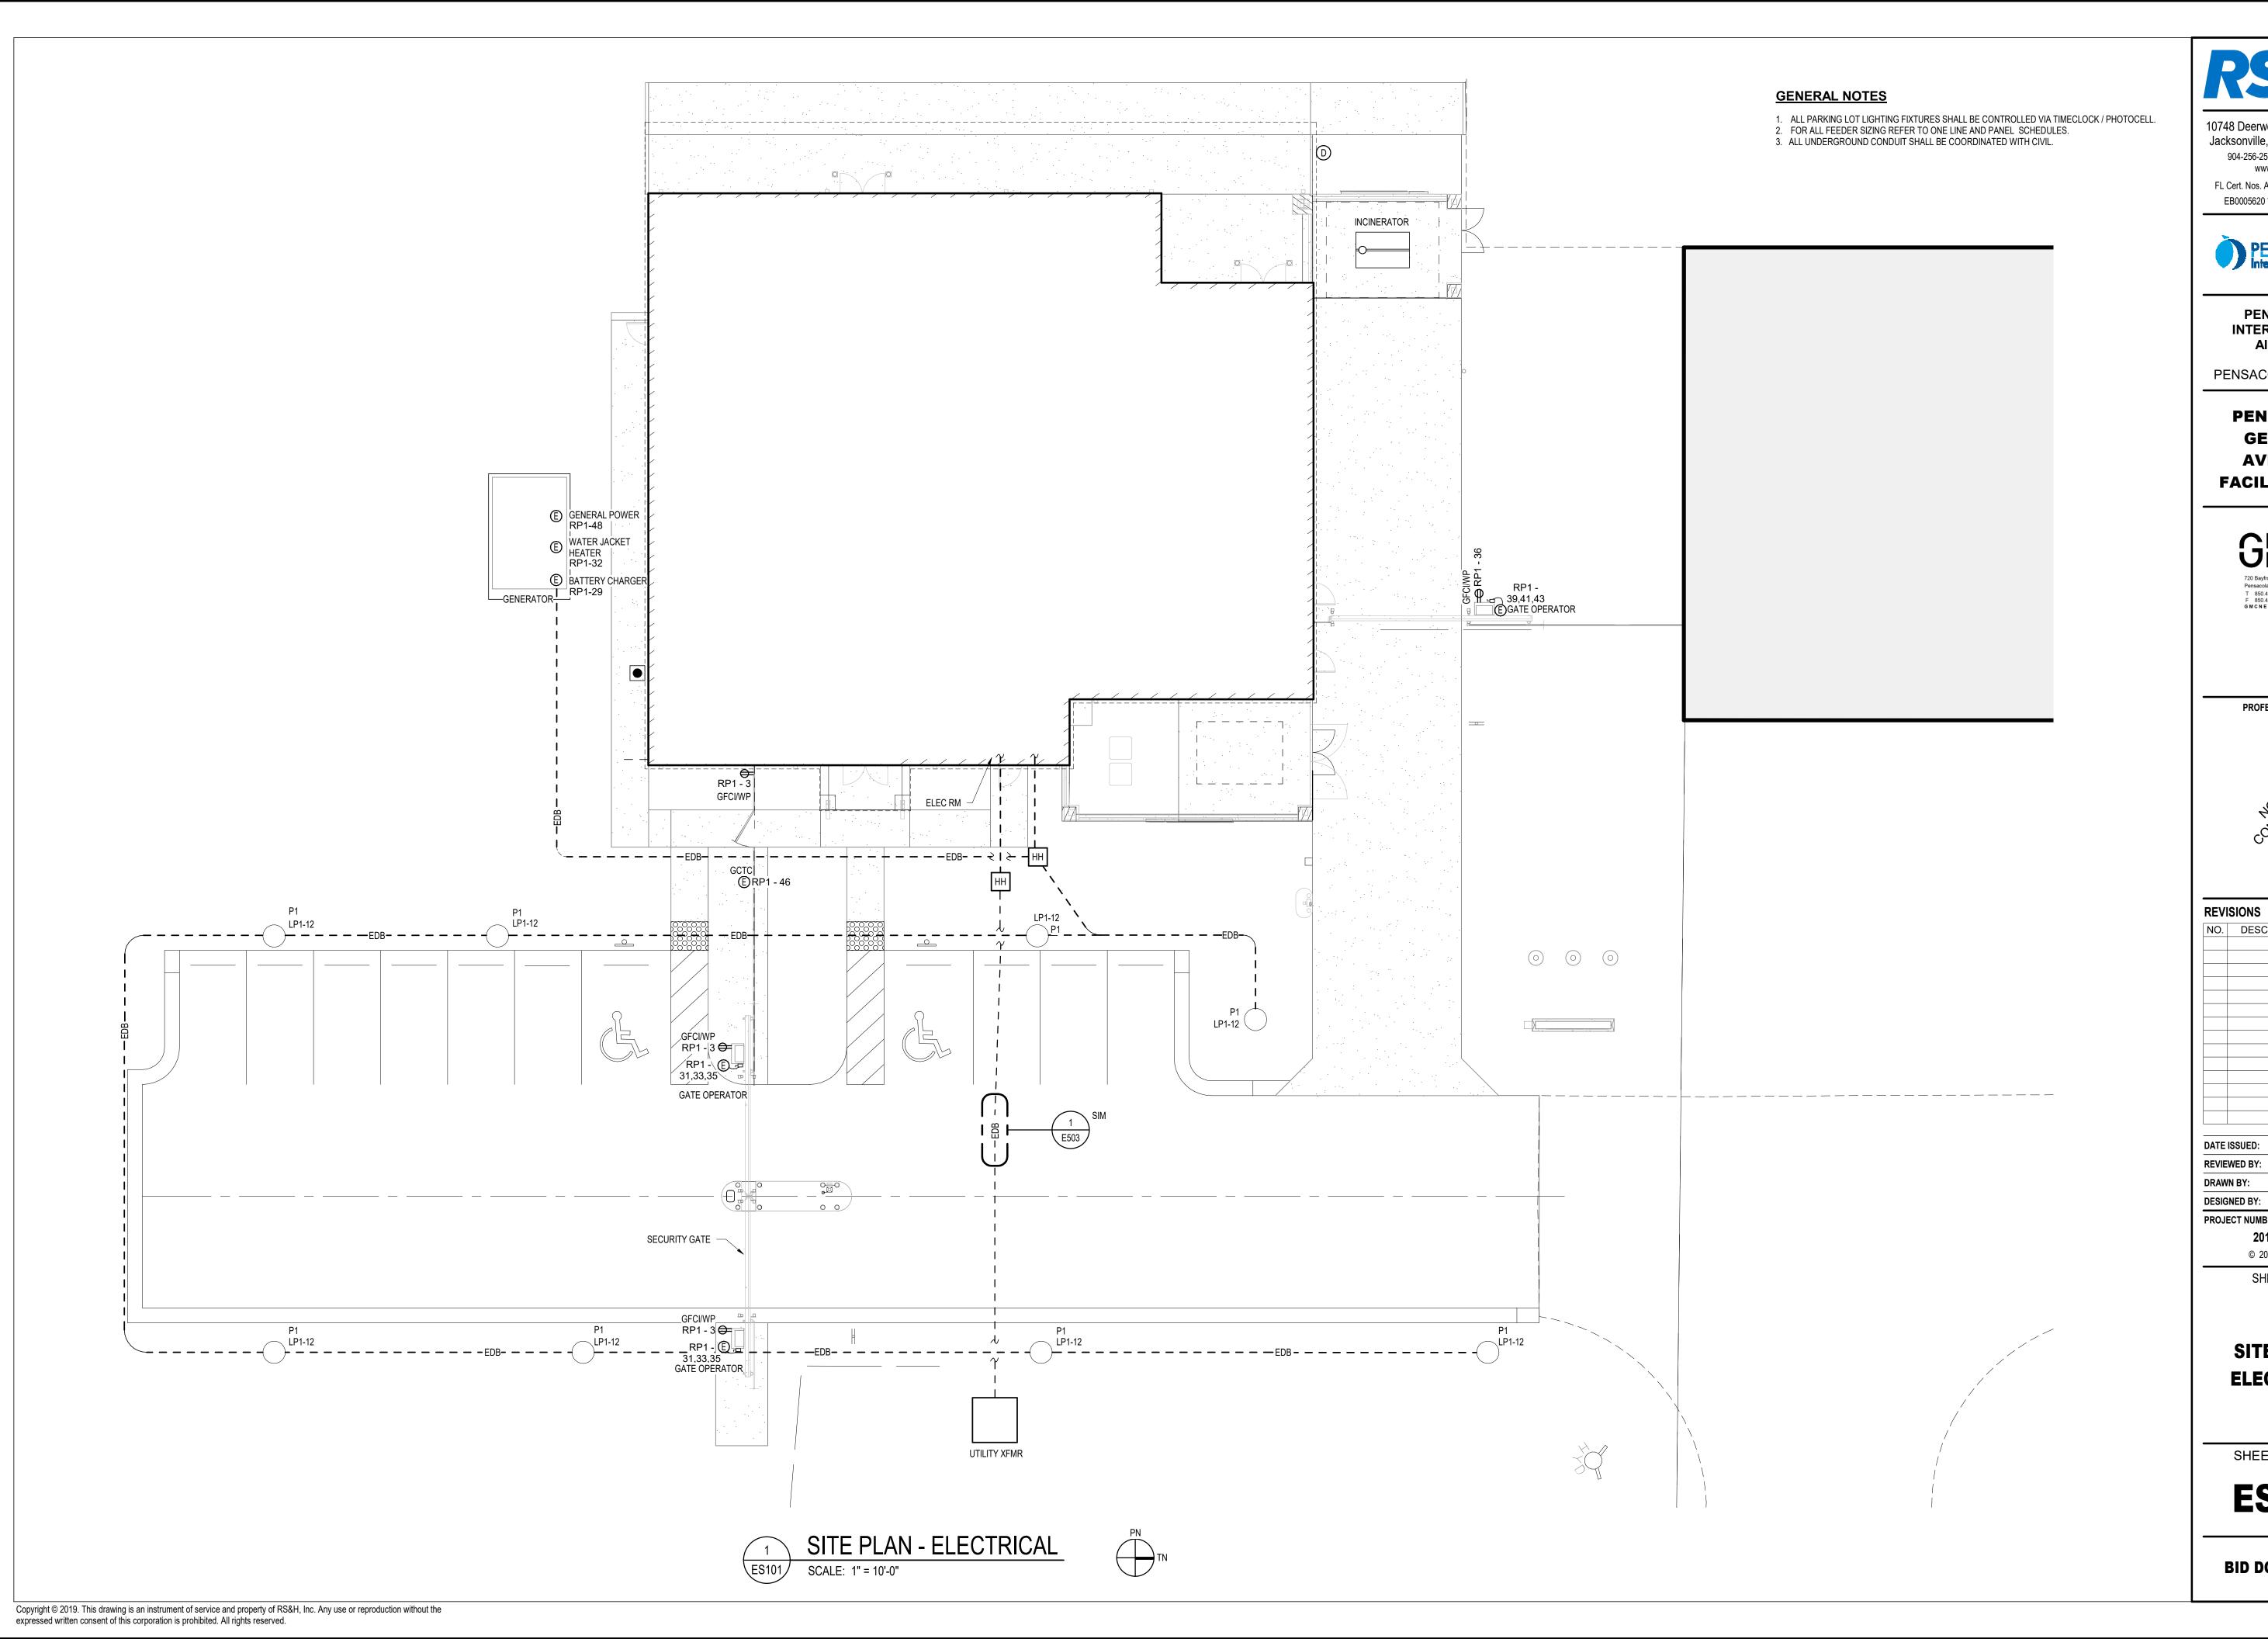
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LUMINAIRE SCHEDULE

SHEET NUMBER

E002

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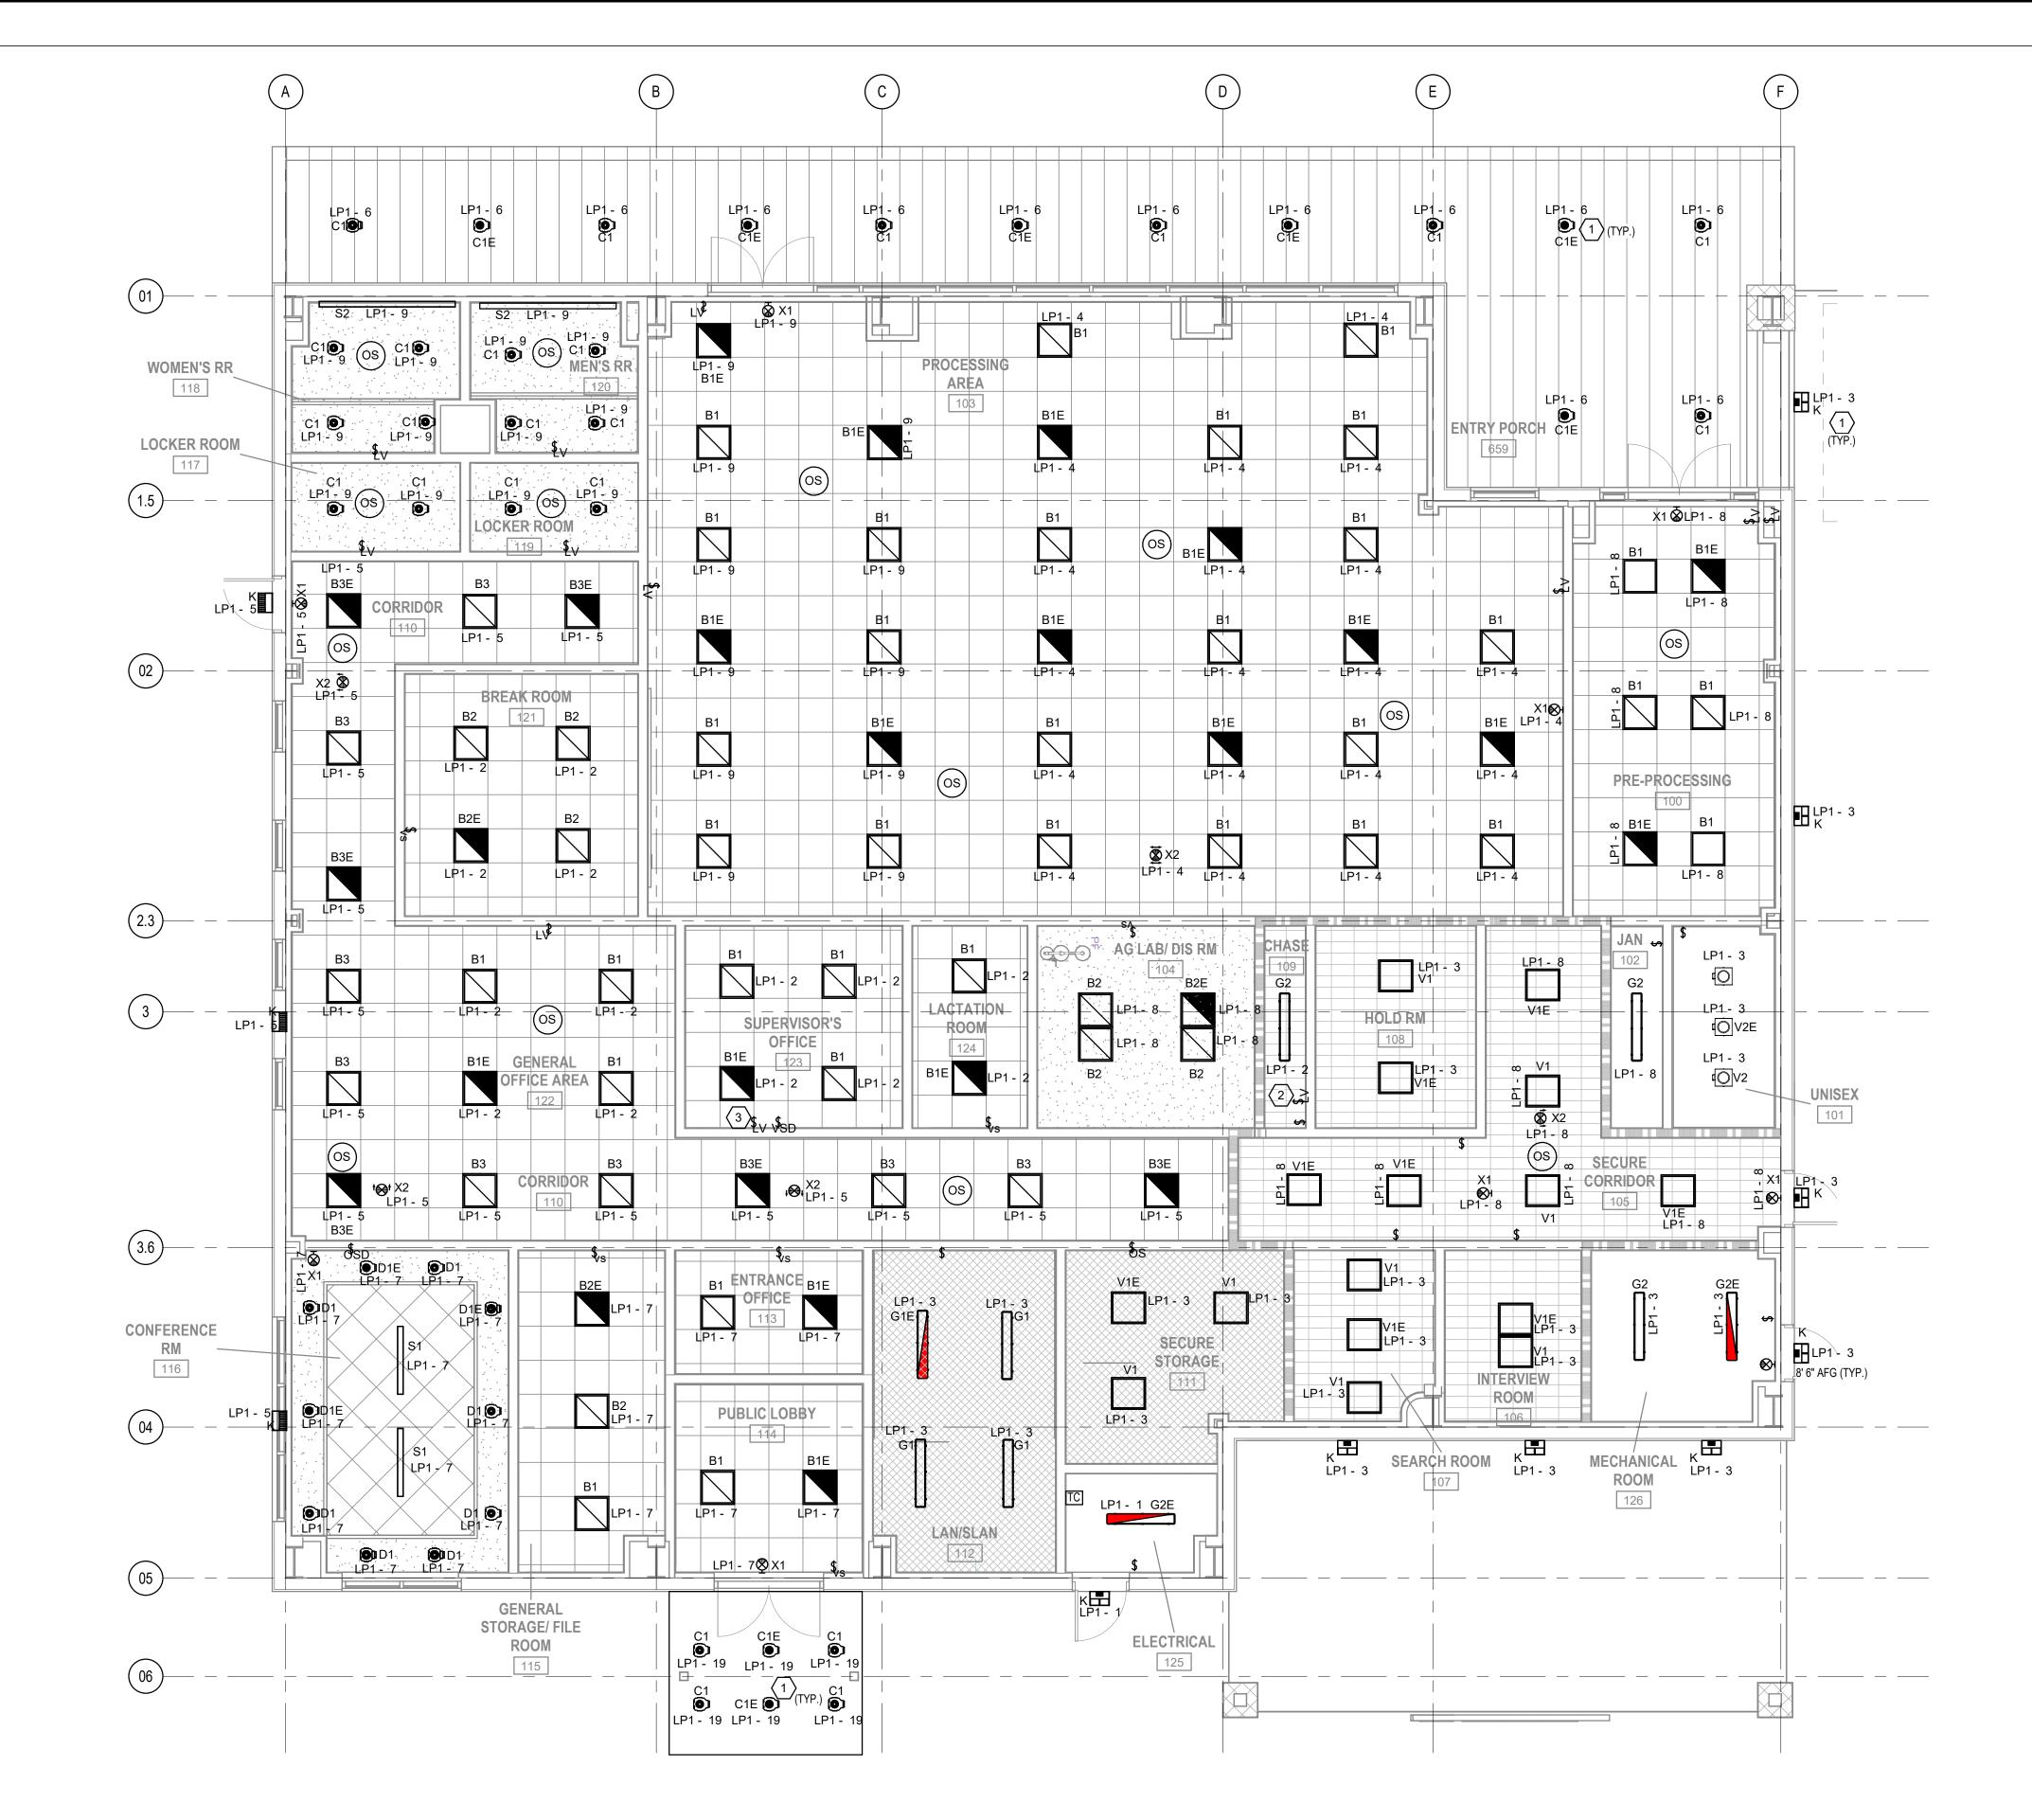
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SHEET TITLE

SITE PLAN -ELECTRICAL

SHEET NUMBER

ES101





- 1. LIGHTING FIXTURES SHALL BE CONTROLLED VIA TIMECLOCK / PHOTOCELL
- 2. LIGHT SWITCH CONTROLS SECURE CORRIDOR 105.
- 3. LIGHT SWITCH CONTROLS CORRIDOR 110.

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FIRST FLOOR -LIGHTING PLAN


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EL101


BID DOCUMENTS

SCALE: 3/16" = 1'-0"

FIRST FLOOR - LIGHTING PLAN SCALE: 3/16" = 1'-0"



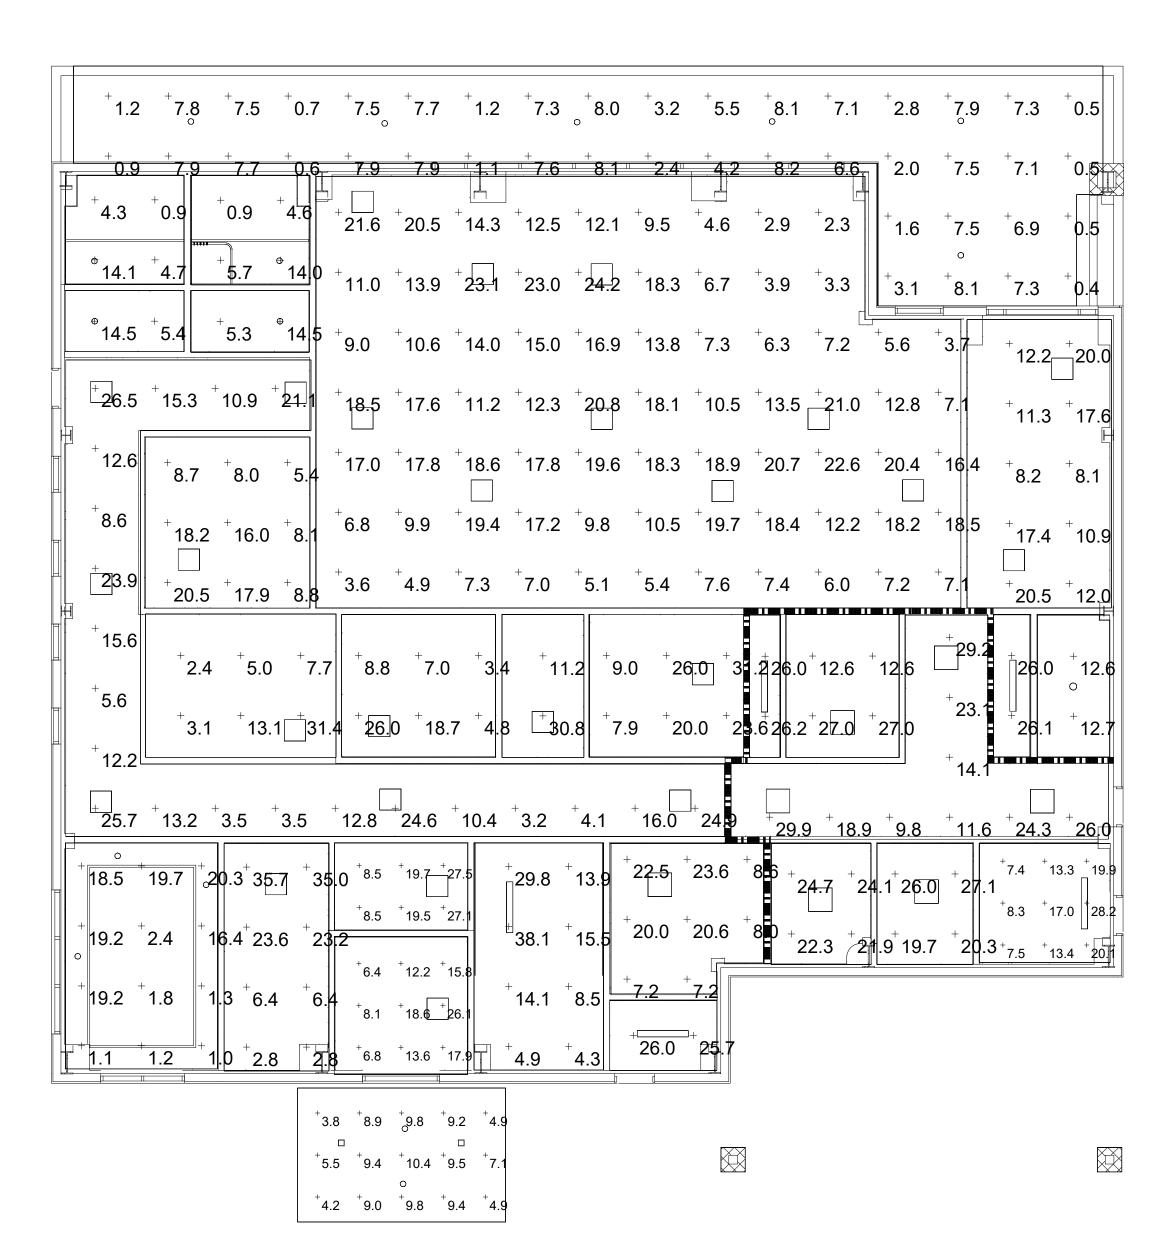

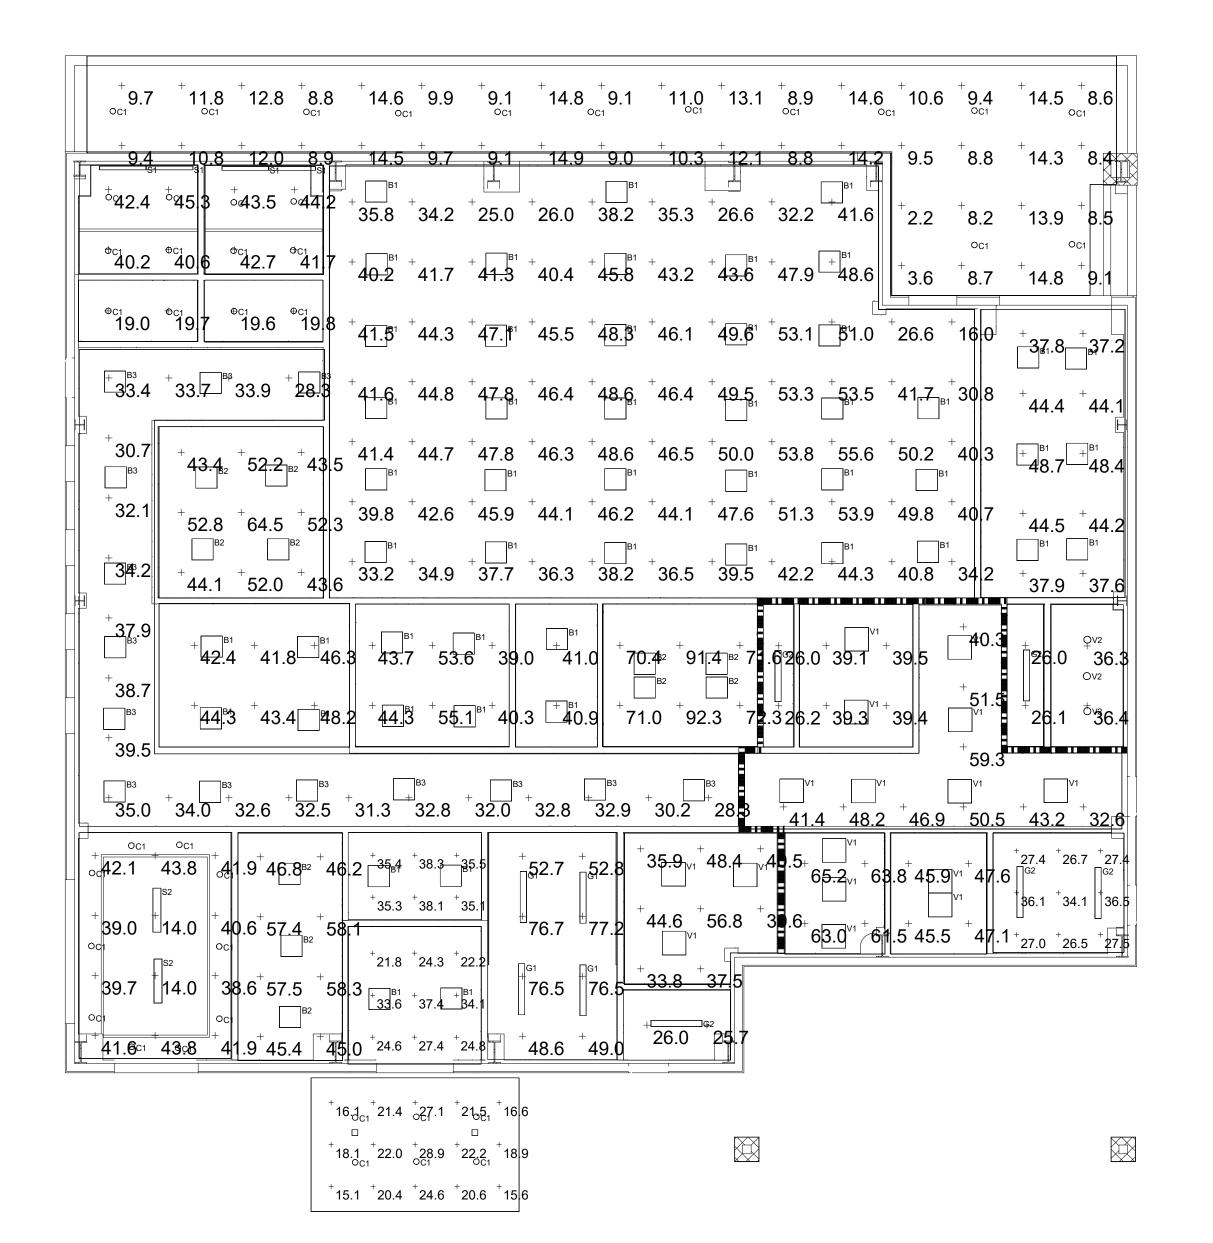

STATISTICS DRAWING

SCALE: 1 1/2" = 1'-0"



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LIGHTING CALCULATIONS

201-0052-002

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SHEET TITLE

PROJECT NUMBER:

SHEET NUMBER

EL102

EMERGENCY	LIGHTI	NG STATISTICS
DESCRIPTION	AVG	LEVEL
000 CANOPY	7.7 fc	FLOOR LEVEL
100 PRE-PROCESSING	13.8 fc	WORK SURFACE
101 UNISEX	12.7 fc	TASK HEIGHT
102 JANITOR	26.1 fc	TASK HEIGHT
103 PROCESSING AREA	12.8 fc	TASK HEIGHT
104 AG LAB / DIS. ROOM	19.6 fc	WORK SURFACE
105 CORRIDOR	20.8 fc	TASK HEIGHT
106 MECHANICAL ROOM	15.0 fc	TASK HEIGHT
107 INTERVIEW ROOM	23.3 fc	36" AFF
108 HOLD ROOM	19.8 fc	36" AFF
109/110 CORRIDOR	14.0 fc	TASK HEIGHT
111 SECURE STORAGE	14.7 fc	COUNTER LEVEL
112 ENTRANCE OFFICE	18.5 fc	TASK HEIGHT
113 PUBLIC LOBBY	13.9 fc	TASK HEIGHT
114 GEN. STORAGE / FILE RM	17.0 fc	TASK HEIGHT
115 CONF. ROOM	10.2 fc	WORK SURFACE
116 WOMEN'S LOCKEROOM	10.0 fc	TASK HEIGHT
117 WOMEN'S RESTROOM	6.0 fc	TASK HEIGHT
118 MEN'S LOCKEROOM	9.9 fc	TASK HEIGHT
119 MEN'S RESTROOM	6.3 fc	TASK HEIGHT
120 BREAK ROOM	12.4 fc	FLOOR LEVEL
121 GENERAL OFFICE AREA	10.4 fc	WORK SURFACE
122 SUPERVISOR OFFICE	11.5 fc	WORK SURFACE
123 LACTATION ROOM	21.0 fc	TASK HEIGHT
124 CHASE	26.1 fc	TASK HEIGHT
125 LAN / SLAN	16.1 fc	FLOOR LEVEL
126 ELECTRICAL ROOM	25.9 fc	TASK HEIGHT
127 SEARCH ROOM	23.3 fc	36" AFF
659 ENTRY PORCH	5.1 fc	FLOOR LEVEL

DESCRIPTION	AVG	REQUIRED	LEVEL
000 CANOPY	20.6 fc	20 fc	FLOOR LEVEL
100 PRE-PROCESSING	42.5 fc	45 fc*	WORK SURFACE
101 UNISEX	36.4 fc	30 fc	TASK HEIGHT
102 JANITOR	26.1 fc	30 fc	TASK HEIGHT
103 PROCESSING AREA	42.6 fc	50 fc	TASK HEIGHT
104 AG LAB / DIS. ROOM	78.2 fc	70 fc*	WORK SURFACE
105 CORRIDOR	46.0 fc	20 fc	TASK HEIGHT
106 MECHANICAL ROOM	29.9 fc	25 fc	TASK HEIGHT
107 INTERVIEW ROOM	46.5 fc	30 fc*	36" AFF
108 HOLD ROOM	39.3 fc	30 fc*	36" AFF
109/110 CORRIDOR	33.2 fc	20 fc	TASK HEIGHT
111 SECURE STORAGE	42.1 fc	40 fc*	COUNTER LEVEL
112 ENTRANCE OFFICE	36.3 fc	35 fc	TASK HEIGHT
113 PUBLIC LOBBY	27.8 fc	20 fc	TASK HEIGHT
114 GEN. STORAGE / FILE RM	51.8 fc	35 fc	TASK HEIGHT
115 CONF. ROOM	36.7 fc	30 fc*	WORK SURFACE
116 WOMEN'S LOCKEROOM	19.4 fc	20 fc	TASK HEIGHT
117 WOMEN'S RESTROOM	42.1 fc	20 fc	TASK HEIGHT
118 MEN'S LOCKEROOM	19.7 fc	20 fc	TASK HEIGHT
119 MEN'S RESTROOM	43.0 fc	20 fc	TASK HEIGHT
120 BREAK ROOM	49.8 fc	30 fc*	FLOOR LEVEL
121 GENERAL OFFICE AREA	44.4 fc	40 fc*	WORK SURFACE
122 SUPERVISOR OFFICE	46.0 fc	40 fc*	WORK SURFACE
123 LACTATION ROOM	41.0 fc	30 fc	TASK HEIGHT
124 CHASE	26.1 fc	15 fc	TASK HEIGHT
125 LAN / SLAN	63.7 fc	30 fc*	FLOOR LEVEL
126 ELECTRICAL ROOM	25.9 fc	25 fc	TASK HEIGHT
127 SEARCH ROOM	63.4 fc	50 fc*	36" AFF
659 ENTRY PORCH	10.6 fc	20 fc	FLOOR LEVEL



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REVIEWED BY: TSK

DRAWN BY: WM/RB

DESIGNED BY: WM/RB

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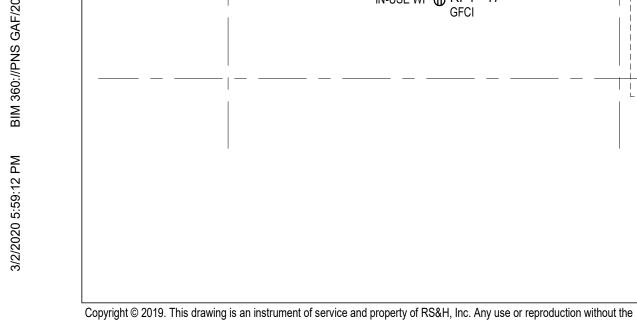
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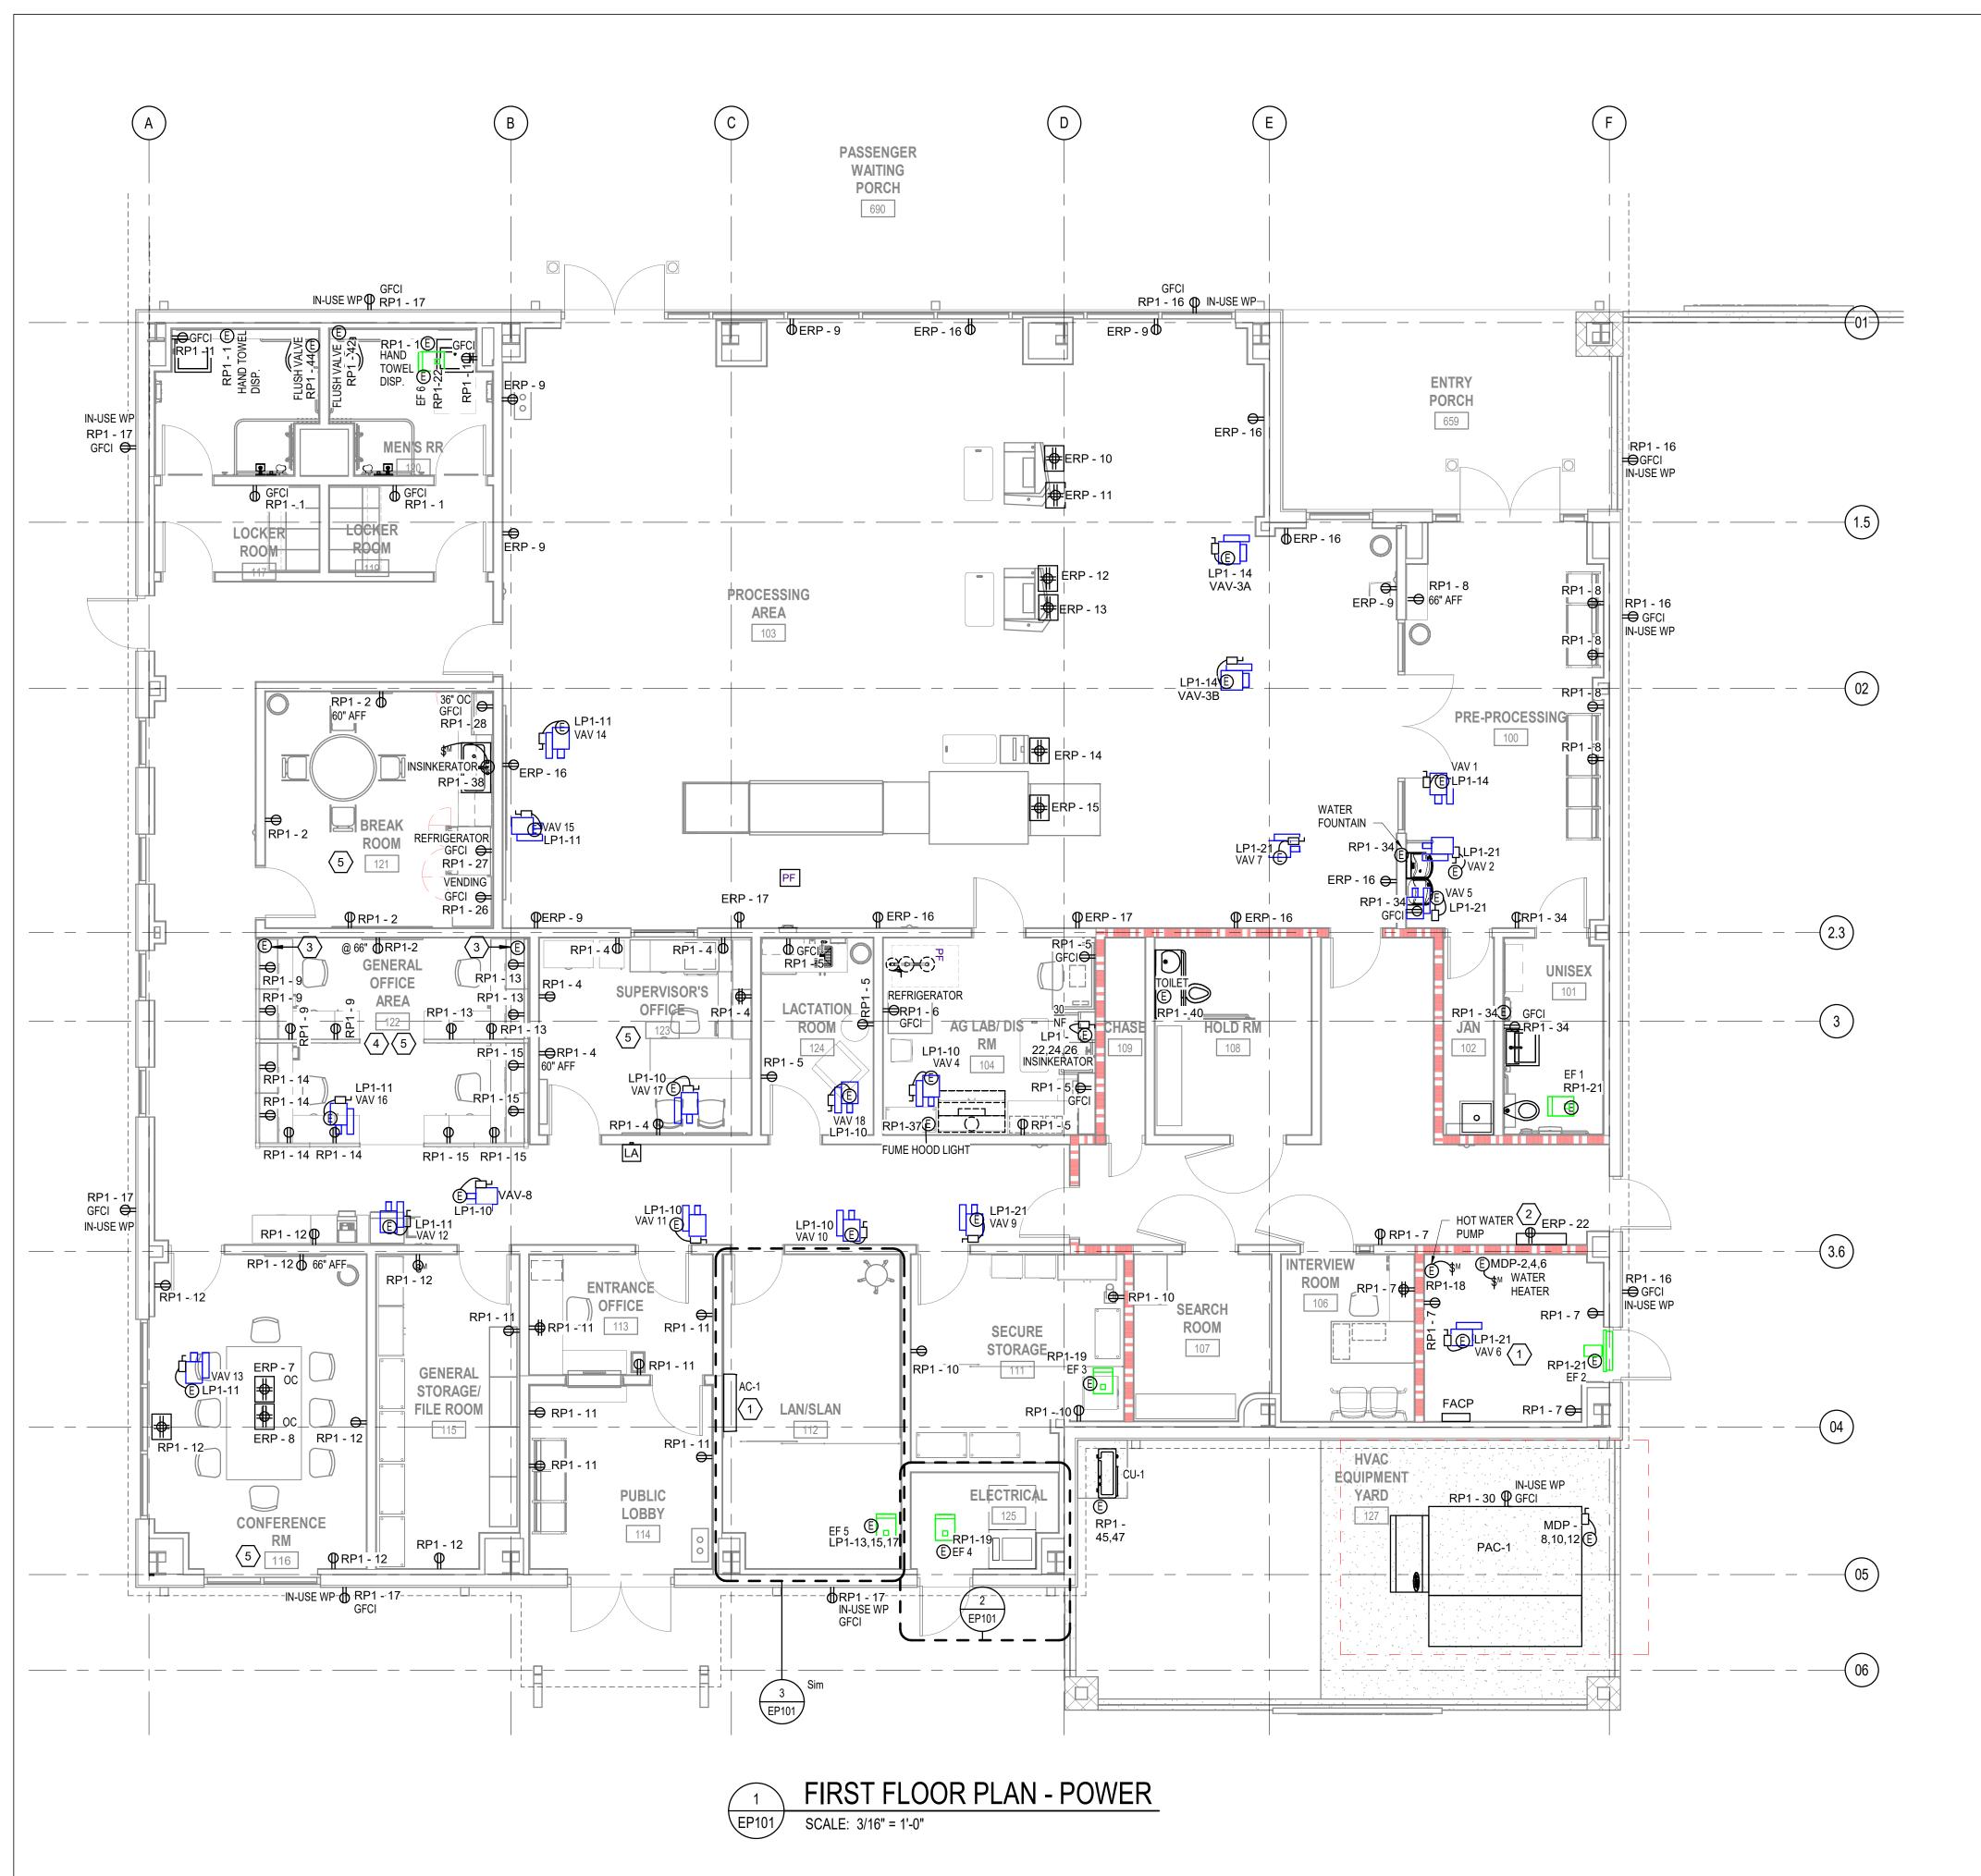
LIGHTING STATISTICS

SHEET NUMBER

EL103




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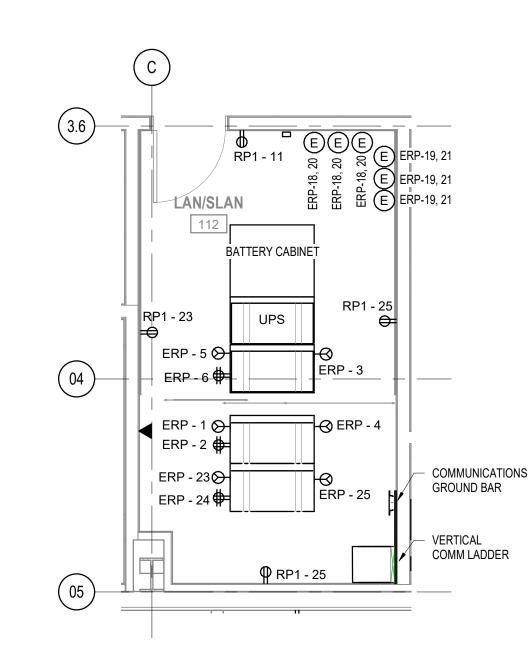


KEY NOTES 1. PROVIDE CONNECTION TO INDOOR UNIT PER MANUFACTURER REQUIREMENTS.


- 2. PROVIDE RECEPTACLE FOR VIDEO MONITOR INSIDE DETENTION GRADE HOUSING.
- 3. PROVIDE IN-WALL RACEWAY FOR CONNECTION TO FURNITURE-RECEPTACLES COORDINATE WITH FURNITURE SUPPLIER. 4. 25% OF FURNITURE-SYSTEM-RECEPTACLES SHALL BE AUTOMATICALLY TURNED OFF BY
- OCCUPANCY SENSOR WITHIN 20 MINUTES OF ALL OCCUPANCTS LEAVING THE SPACE, OR BY TIME SCHEDULE. (ASHRAE 90.1 8.4.2)
- 5. 50% OF ALL RECEPTACLES SHALL BE AUTOMATICALLY TURNED OFF BY OCCUPANCY/VACANCY SENSOR WITHIN 20 MINUTES OF ALL OCCUPANCTS LEAVING THE SPACE, OR BY TIME SCHEDULE. (ASHRAE 90.1 8.4.2)





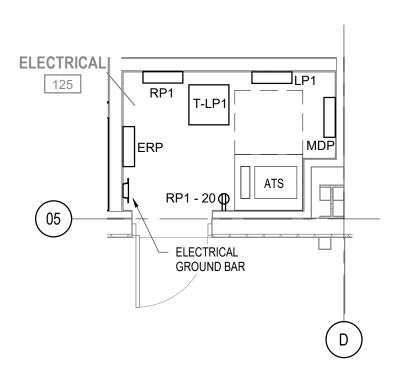



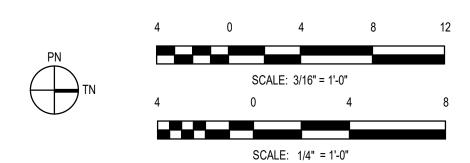

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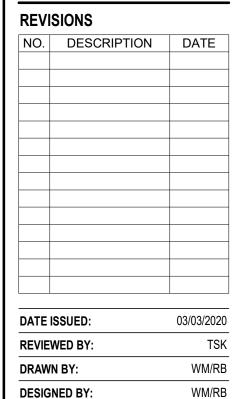
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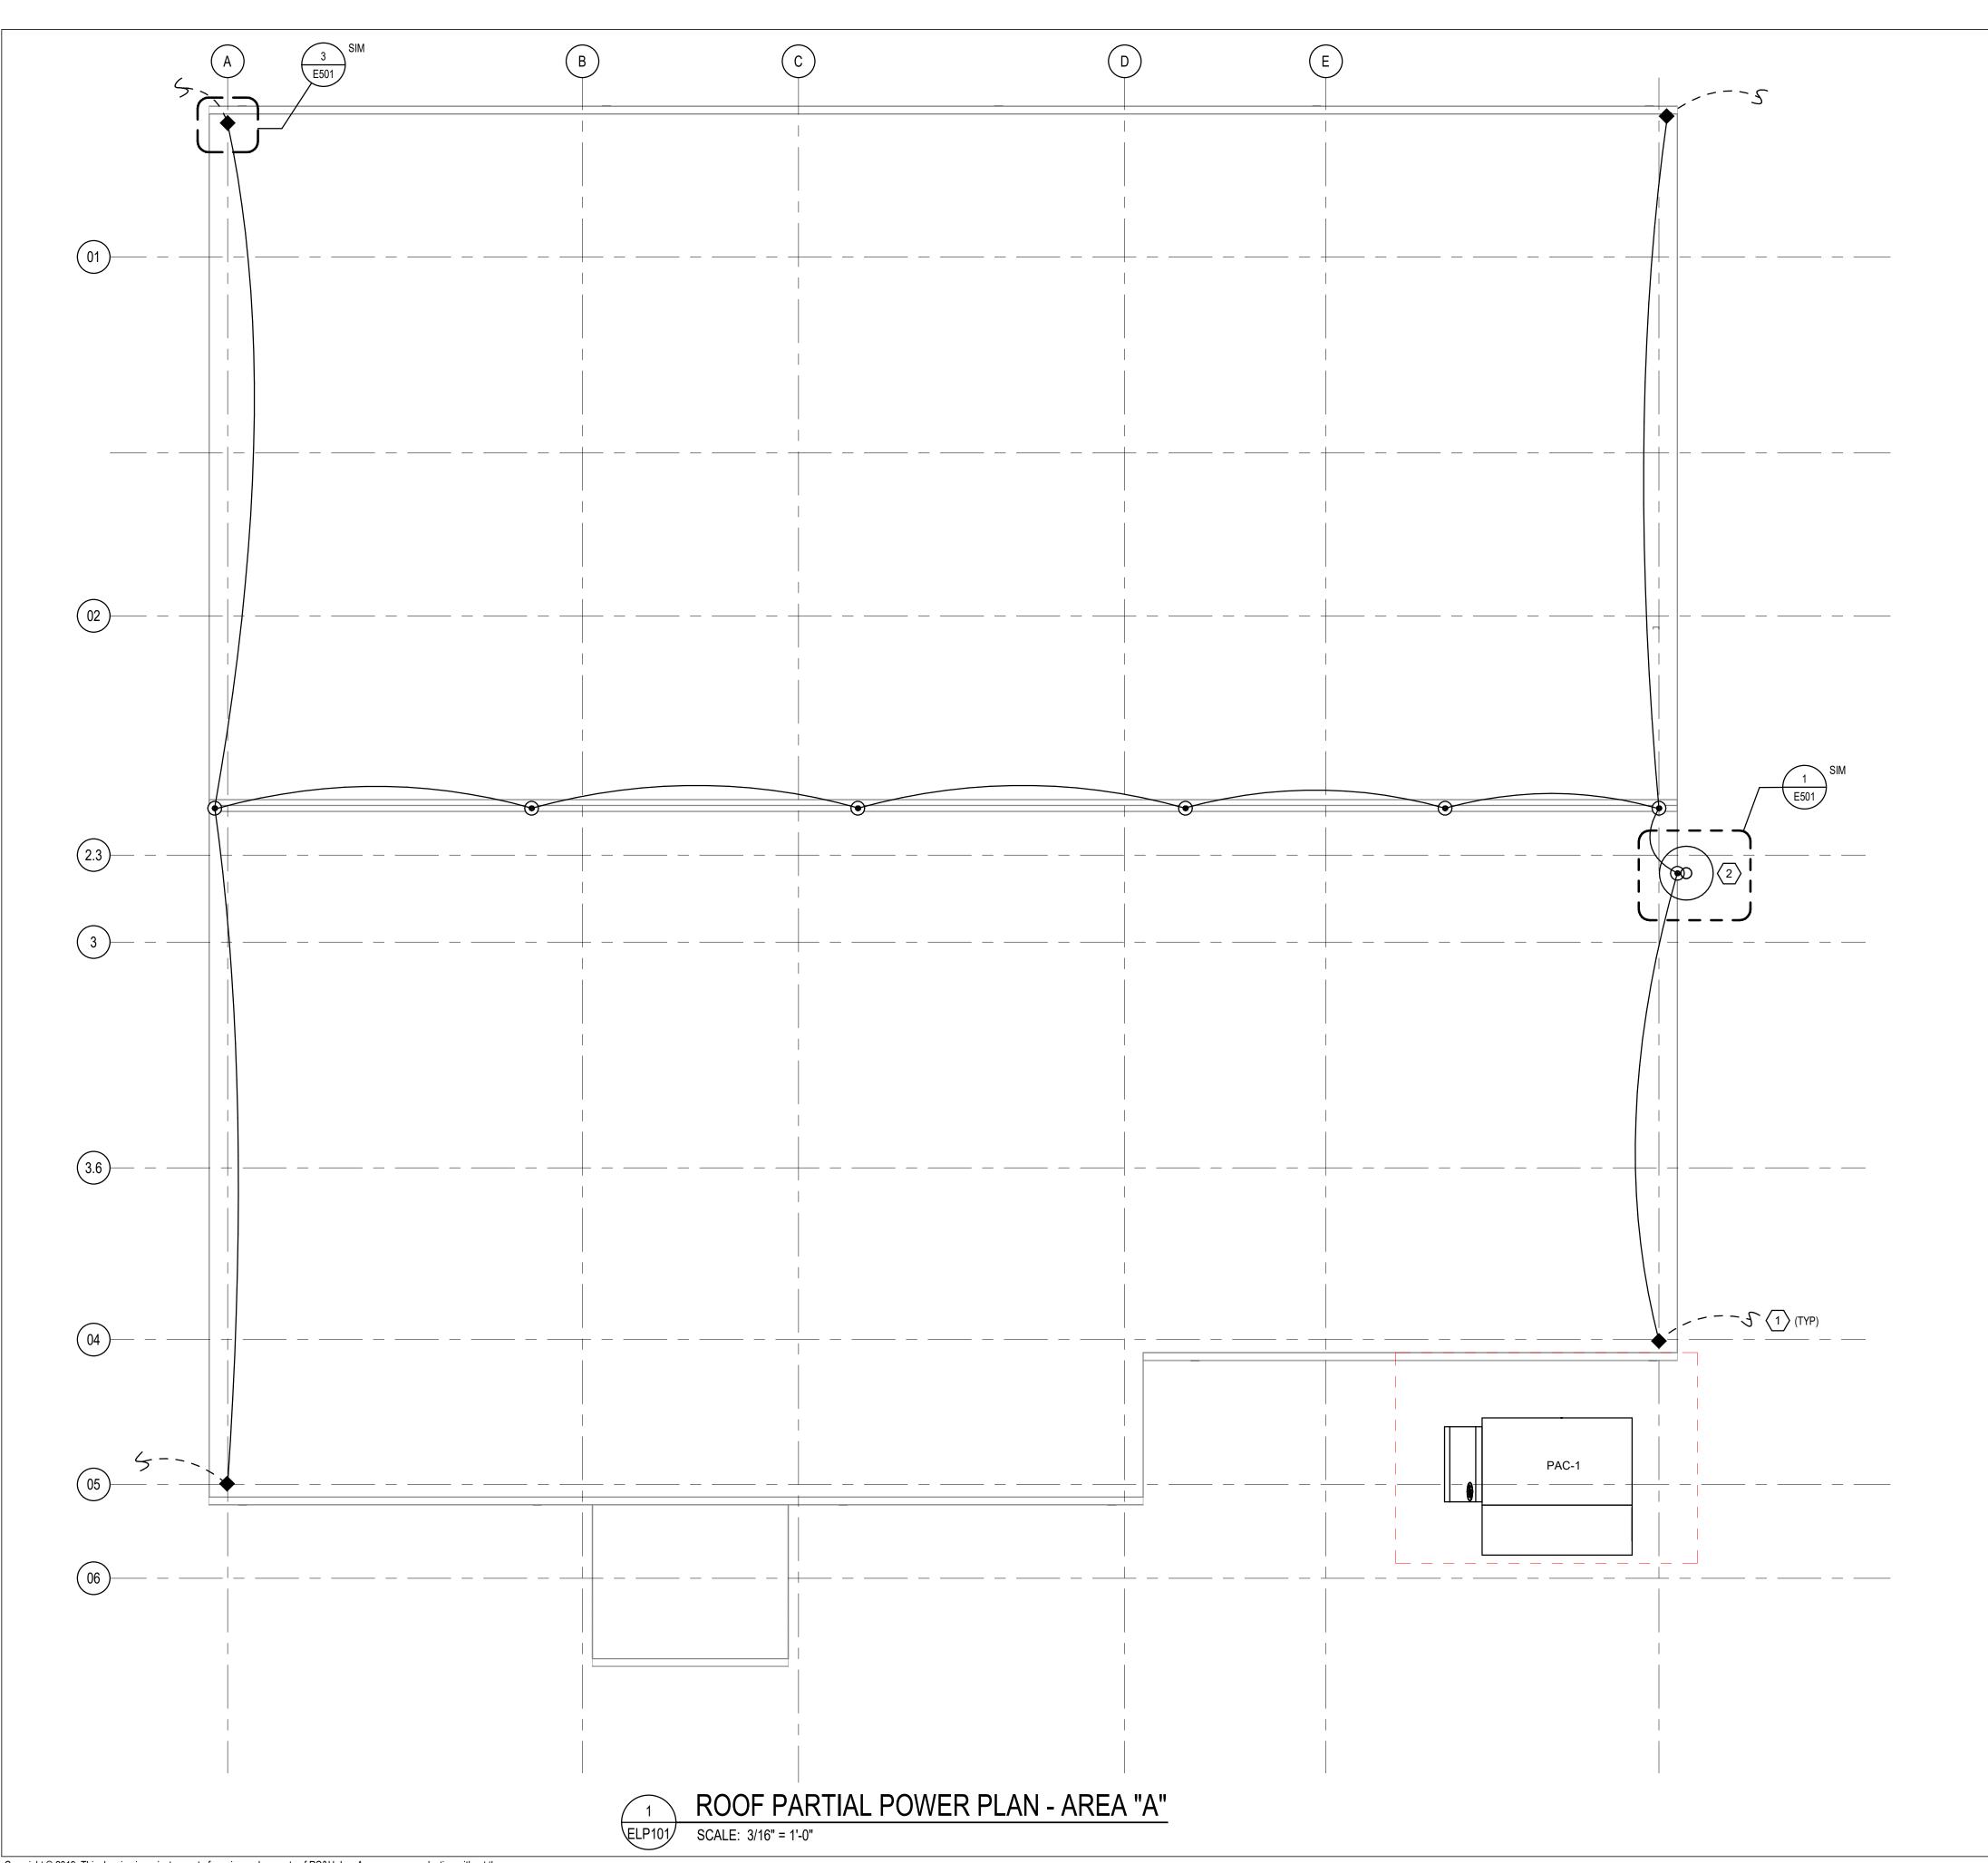
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SHEET TITLE

FIRST FLOOR **PLAN - POWER**

SHEET NUMBER

EP101



GENERAL NOTES

- 1. METALLIC BODIES OF INDUCTANCE AND CONDUCTANCE LOCATED ABOUT THE ROOF SUCH AS; METAL FLASHING, GRAVEL STOPS, ROOF DRAINS, SOIL PIPE VENTS, ROOF HATCHES, INSULATION VENTS, LOUVERS AND DOOR FRAMES SITUATED 6'-0" FROM A LIGHTNING CONDUCTOR OR BONDED METAL BODY SHALL BE INTERCONNECTED TO THE LIGHTNING CONDUCTOR SYSTEM.
- 2. LIGHTNING PROTECTION SYSTEM SHALL FOLLOW THE FOLLOWING
- STANDARDS:
- A. UL96A
 B. LPI OF STANDARDS 175
 C. NFPA 780 CURRENT EDITION
- 3. AIR TERMINALS SHALL BE PLACED AT ALL UNPROTECTED OUTSIDE CORNERS AND LOCATED INTERMEDIATELY AT 20'-0" MAXIMUM SPACING AROUND THE ROOF PERIMETER OR RIDGE AND WITHIN 2'-0" OF OUTSIDE
- 4. BOND ALL METALLIC PIPES INCLUDING WATER, FIRE, GAS, SEWER, STORM, ETC. WHICH ENTER THE STRUCTURE TO THE NEAREST DOWNLEAD. GROUND ROD OR GROUND LOOP.
- 5. REFER TO SHEET E07.03 GROUNDING RISER DIAGRAM FOR ADDITIONAL INFORMATION.

KEY NOTES

- 1 SEE SHEET ELP102 FOR CONTINUATION OF LIGHTNING PROTECTION SYSTEM.
- 2. CBP ANTENAE LOCATION, TIE INTO LIGHTNING PROTECTION SYSTEM. SEE SHEET T403 FOR DETAILS.



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LIGHTNING **PROTECTION**

SHEET NUMBER

ELP101

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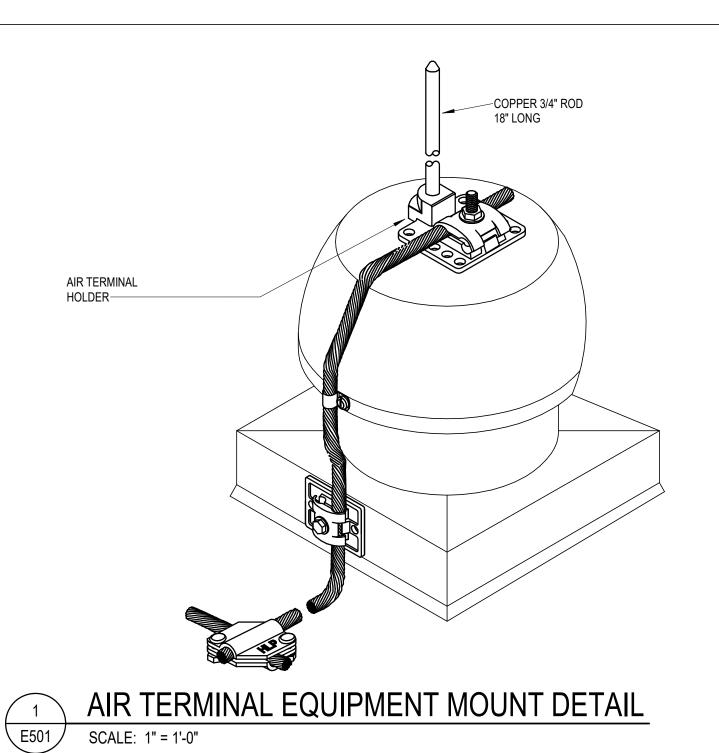
GROUNDING PLAN


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BID DOCUMENTS

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MOUNTING BRACKET

40' ROUND TAPERED ALUMINUM

LIGHT POLE, W/DARK BRONZE

#RTA-40-86-T25-USPOM-DDBXD

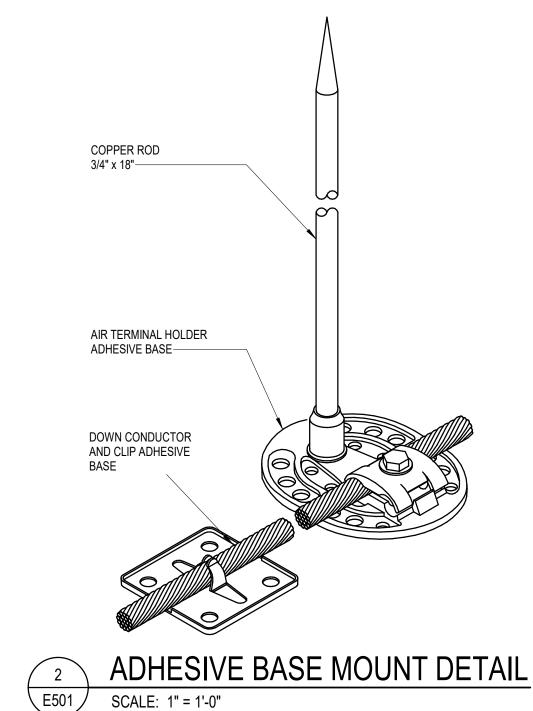FINISH, LITHONIA

HANDHOLE -


LIGHT POLE FOUNDATION,

REFER TO DETAIL 2, THIS

SHEET FOR ADDITIONAL

INFORMATION

OR APPROVED EQUAL

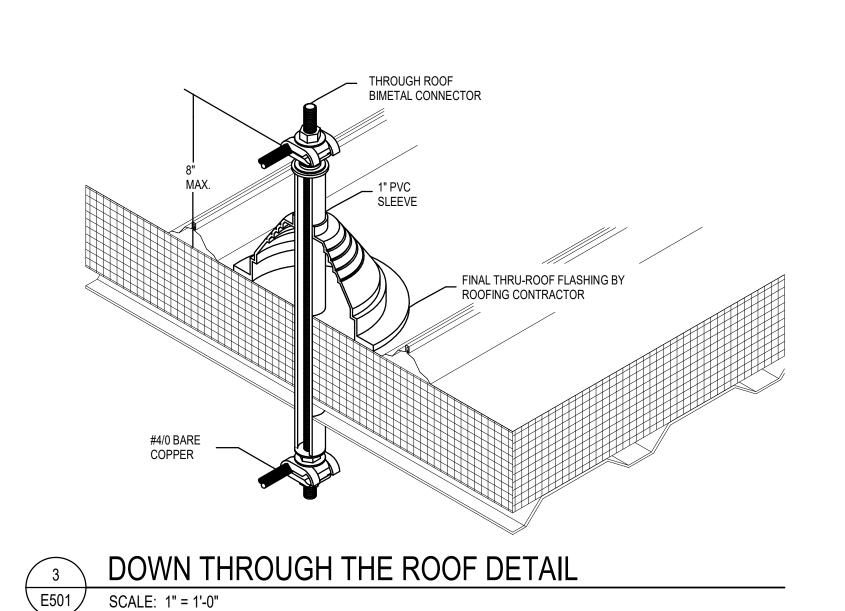


_ MOUNT FIXTURE AT 40'

LUMINAIRE SCHEDULE

FOR FIXTURE DETAILS

AFG, REFER TO

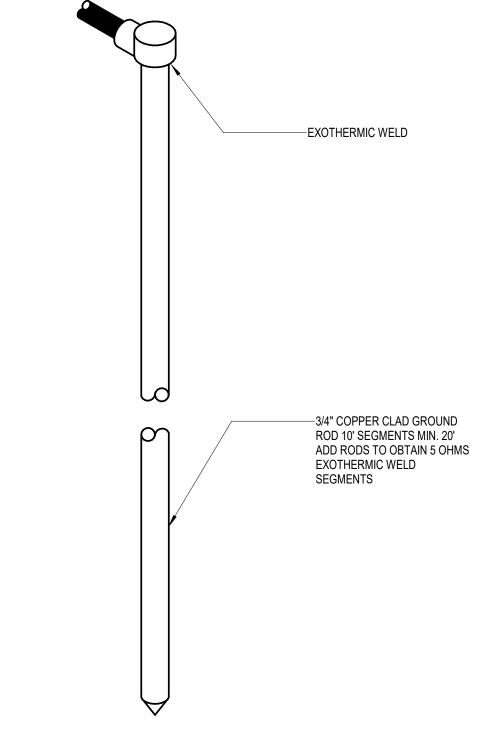



NOTES:

1. GULF POWER INC. SHALL MAKE ALL CONNECTIONS AT PADMOUNT AND METER SOCKET

2. METER SOCKET/CABINET AND PEDESTAL FURNISHED BY GPS AND INSTALLED BY THE CONTRACTOR

3. C.T.'S ON SECONDARY SPADES METER CONTROL CABLE FURNISHED AND INSTALLED BY GPS.


4. SEE SINGLE LINE DIAGRAM FOR FEEDER QUANTITIES AND AMPACITIES


5. REFER TO CIVIL DRAWING C17.02.01 FOR TRANSFORMER PAD DETAILS

6. INSTALLATION SHALL COMPLY WITH GPS REQUIREMENTS

7. FOR CONDUIT INSTALLED IN GREENFIELD/TURF AREAS. CONDUITS SHALL NOT REQUIRE CONCRETE ENCASEMENT, BUT SHALL MAINTAIN SPACING AS SHOWN ON DETAIL 3, SHEET E05.02.

8. COORDINATE TRANSFORMER INSTALLATION WITH GULF POWER INC.

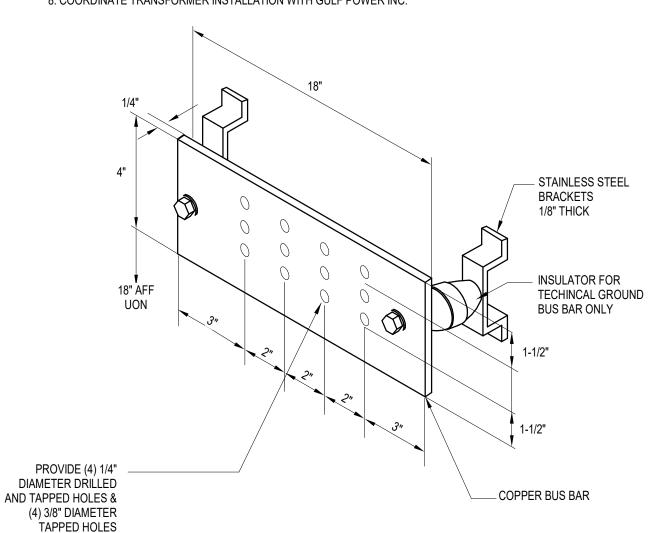

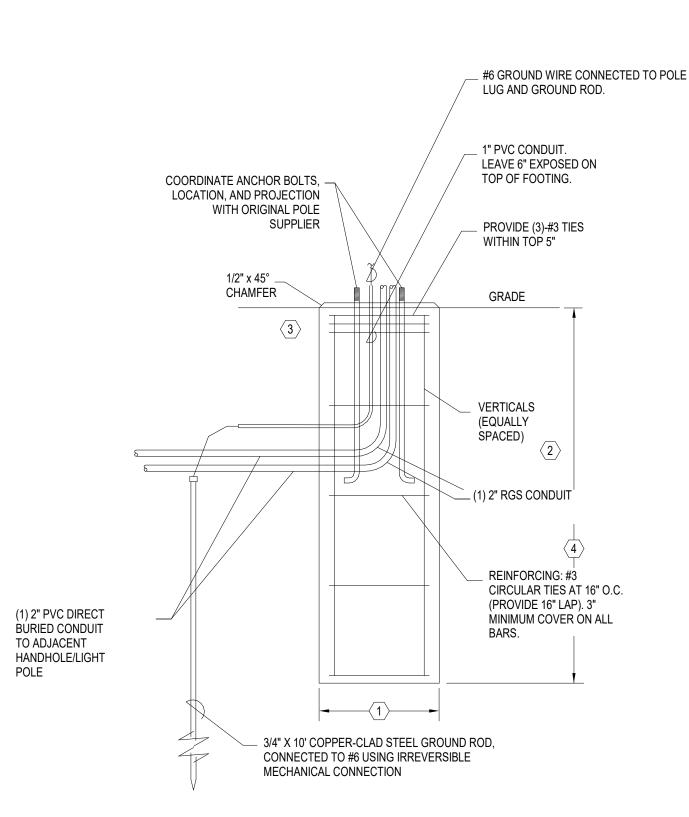

KEY NOTES	1	2	3	4
39' POLES	24" DIA	(6)#8'S	TURF	10'-0"

LIGHT POLE FOUNDATION DETAIL

NOTES:


- 1. ALL CONCRETE SHALL BE 4000 PSI (fc) AT 28 DAYS WITH A SLUMP OF 4"±1"
- ALL REINFORCING SHALL BE ASTM A615 GR. 60

SCALE: 12" = 1'-0"

3. CONSTRUCTION OF LIGHT POLE FOUNDATION MAY REQUIRE DEWATERING. ANY DEWATERING SHALL BE CONSIDERED INCIDENTAL TO THE LIGHT POLE FOUNDATION CONSTRUCTION. NO ADDITIONAL COMPENSATION WILL BE MADE FOR DEWATERING.





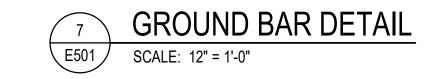



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RAW	N BY:	WM/RE				
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NO. DESCRIPTION DATE

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SHEET TITLE


ELECTRICAL DETAILS

SHEET NUMBER

E501


E502

SCALE: 12" = 1'-0"

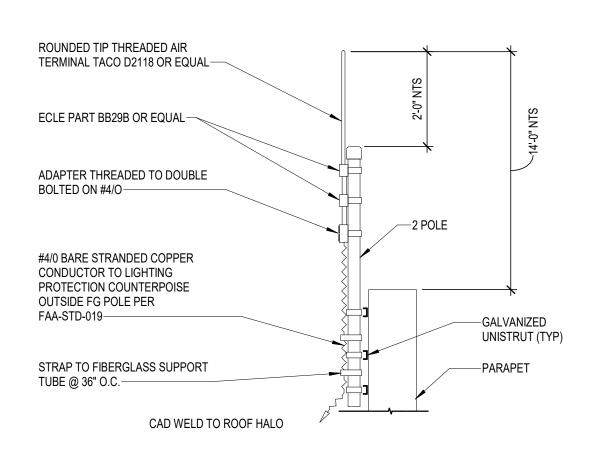


AIR TERMINAL DETAIL

SCALE: 6" = 1'-0"

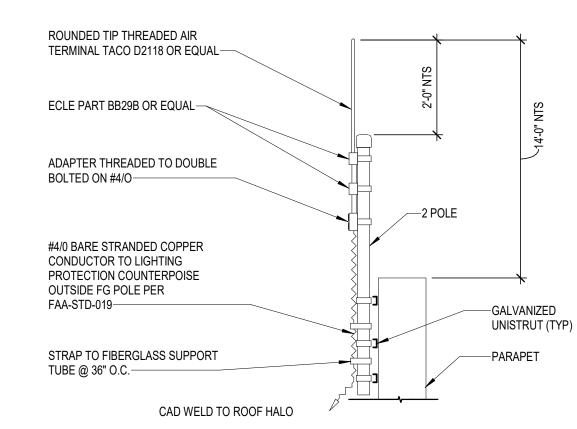




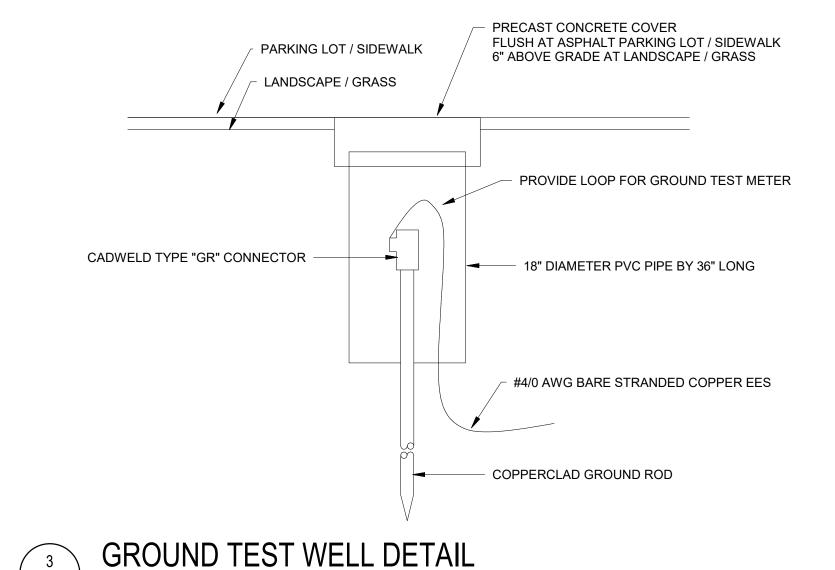

E502

SCALE: 1/8" = 1'-0"

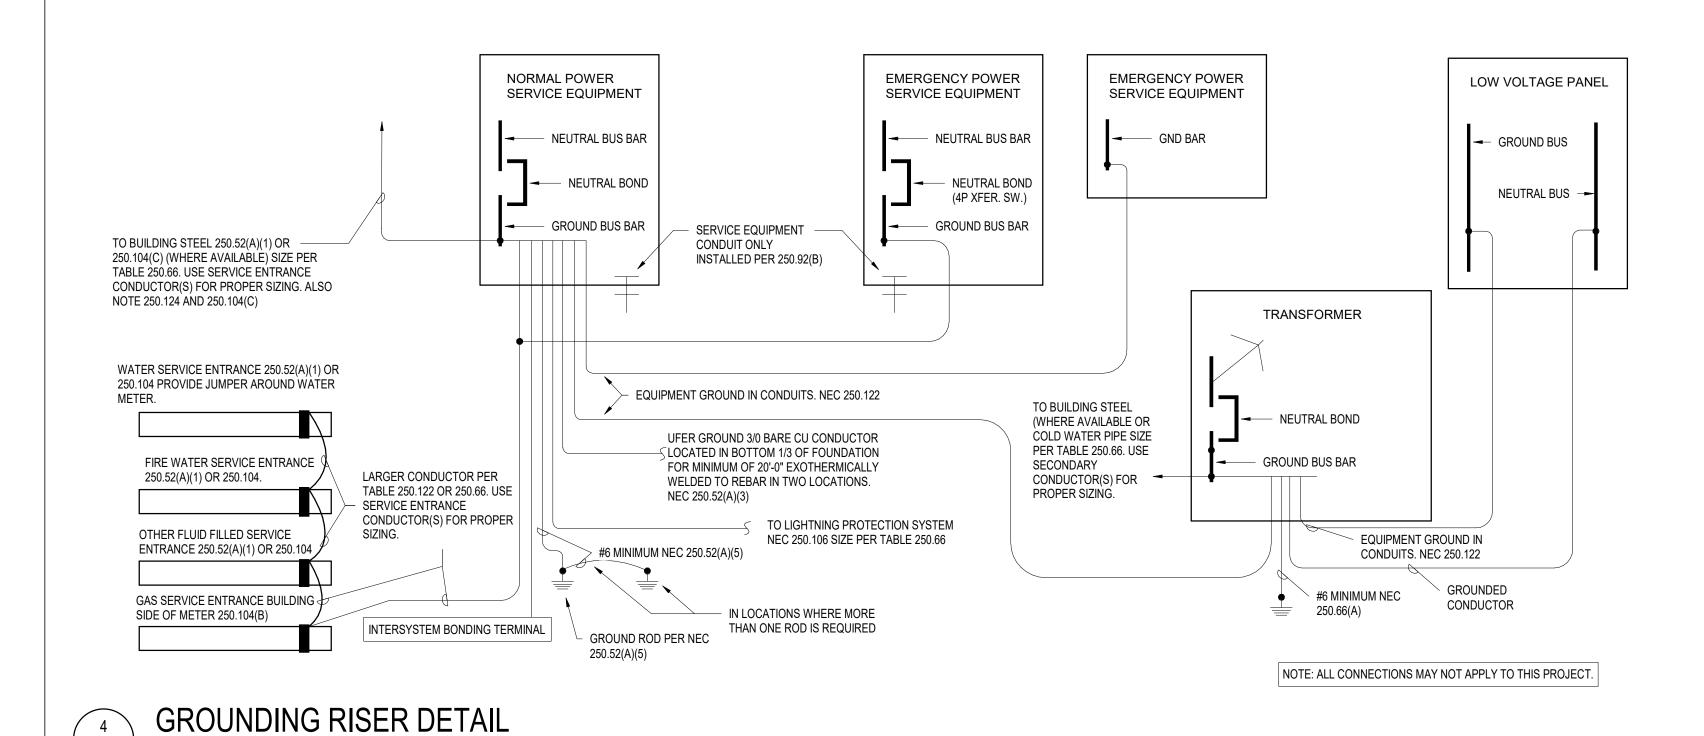



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DATE ISS	UED:	03/03/2

TSK REVIEWED BY: WM/RB DRAWN BY: WM/RB **DESIGNED BY:** PROJECT NUMBER:


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> > SHEET TITLE

ELECTRICAL DETAILS

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E502



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NO. DESCRIPTION DATE
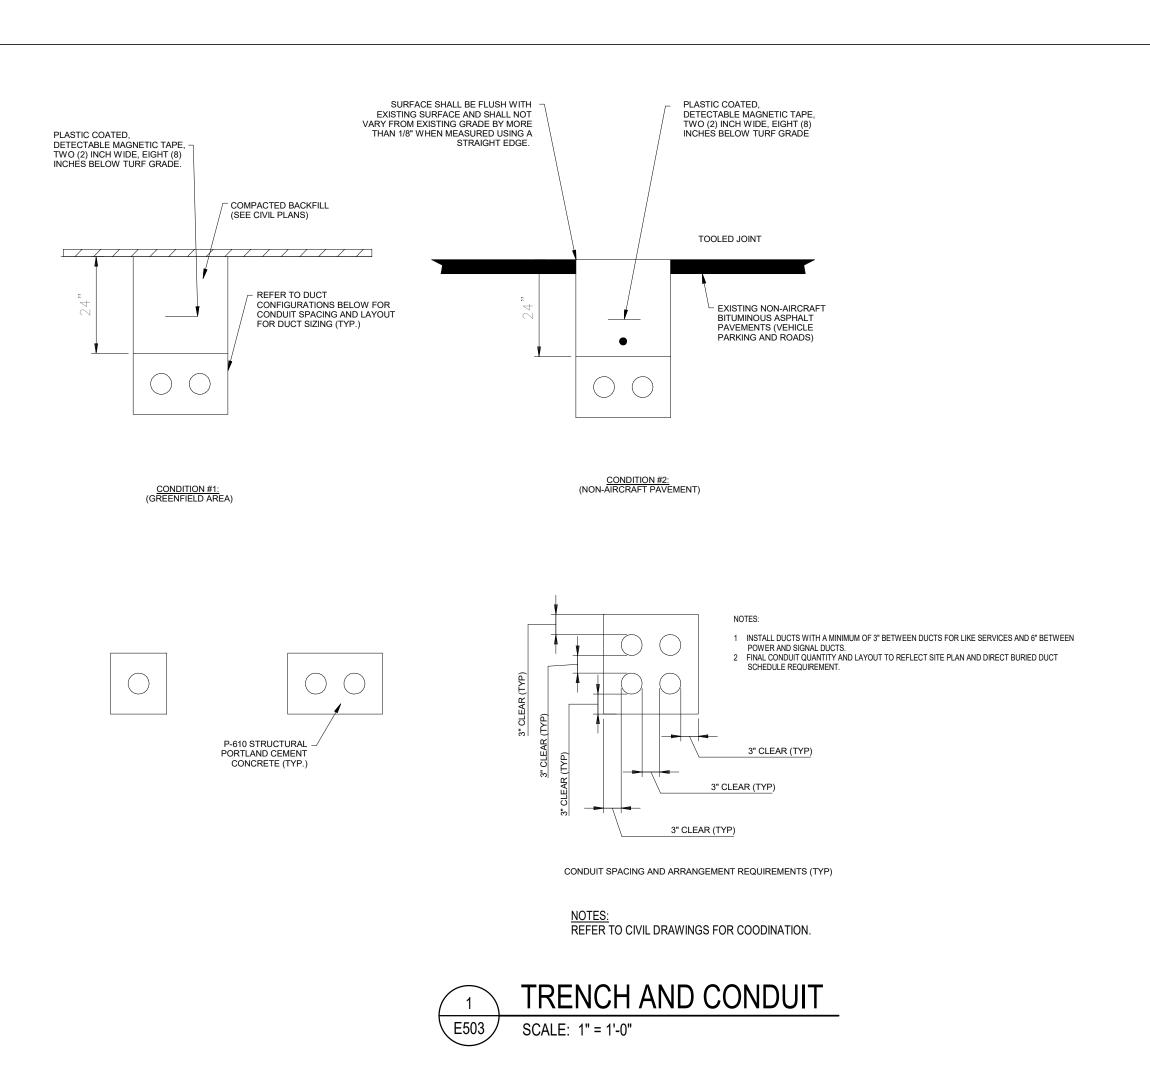
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DATE	DATE ISSUED: 03/03						
DEVIEWED BY:							

 DATE ISSUED.
 05/05/2020

 REVIEWED BY:
 TSK

 DRAWN BY:
 WM/RB

 DESIGNED BY:
 WM/RB

 PROJECT NUMBER:

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SHEET TITLE

ELECTRICAL DETAILS

SHEET NUMBER

E503

Location: ELEC ROOM 126 Supply From: MDP Mounting: Surface

A.I.C. Rating: 10000 Volts: 480/277 Wye Mains Type: MLO Phases: 3 Mains Rating: 250 A Wires: 4

СКТ	Poles	Trip	Circuit Description		Δ.	ı	В		С	Circuit Description	Trip	Poles	СКТ
1	1	20 A	(L) RM'S 126 - 127	0.1 kVA	0.5 kVA					(L) RM'S 120 - 124	20 A	1	2
3	1	20 A	(L) RM'S 106-108, 111, 125			0.4 kVA	0.6 kVA			(L) RM 103	20 A	1	4
5	1	20 A	(L) RM 109					0.5 kVA	0.6 kVA	(L) RM 659	20 A	1	6
7	1	20 A	(L) RM'S 110 - 115	0.8 kVA	0.4 kVA					(L) RM'S 100 - 105	20 A	1	8
9	1	20 A	(L) RM'S 103, 116 - 119			0.9 kVA	3.5 kVA			(E) VAV 4, 8, 10, 11, 17, 18	20 A	1	10
11	1	20 A	(E) VAV 12 - 16					4 kVA	0.2 kVA	(L) PARKING LOT LIGHTING	20 A	1	12
13				0.3 kVA	8 kVA					(E) VAV 1, 3	20 A	1	14
15	3	20 A	(E) EF 5			0.3 kVA	18.5 kVA						16
17								0.3 kVA	18.5 kVA	T-LP1 (NOTE 2)	100 A	3	18
19	1	20 A	(L) CANOPY ENTRANCE	0.3 kVA	17.9 kVA								20
21	1	20 A	(E) VAV 2, 5 - 7, 9			2.5 kVA	1.4 kVA						22
23									1.4 kVA	(E) INSINKERATOR - RM 104	20 A	3	24
25					1.4 kVA								26
27													28
29													30
31													32
33													34
35													36
37													38
39													40
41													42
	-	1	Total Load:	29.6	kVA	28.1	kVA	25.	5 kVA			-	

92 A Total Amps: 103 A 108 A **Load Classification** Connected Load (VA) **Demand Factor** Estimated Demand... Panel Totals Total Conn. Load: 83.3 kVA Equipment 100.00% 61140 VA 61140 VA Lighting 4768 VA 125.00% 5960 VA Total Conn. Current: 100 A Other 244 VA 100.00% 244 VA Total Est. Demand Load: 80.9 kVA Receptacle Total Est. Demand Current: 97 A 17100 VA 13550 VA 79.24%

1. ALL BRANCH CIRCUIT SIZES SHALL BE 2#12, 1#12 GND - 3/4"C UNO. 2. SEE SINGLE LINE DIAGRAM FOR FEEDER SIZE.

			PANEL: MDP										
Location: ELEC ROOM 126 Supply From: Mounting: Surface						Volts: Phases: Wires:	-	Vye	A.I.C. Rating: 65000 Mains Type: MCB Mains Rating: 400 A				
СКТ	Poles	Trip	Circuit Description		A	1	3		С	Circuit Description	Trip	Poles	скт
1				29.6 kVA	5 kVA					-			2
3	3	250 A	LP1 (NOTE 1)			28.1 kVA	5 kVA			(E) WATER HEATER (NOTE 2)	25 A	3	4
5								25.5 kVA	5 kVA				6
7				6.5 kVA	16.7 kVA								8
9	3	60 A	UPS (NOTE 1)			6.4 kVA	16.7 kVA			(E) PAC - 1 (NOTE 3)	80 A	3	10
11								6.6 kVA	16.7 kVA	4			12
13													14
15													16
17													18
19													20
21													22
23													24
25													26
27													28
29													30
31													32
33													34
35													36
37													38
39													40
41													42
			Total I	Load: 57.8	3 kVA	56.2	kVA	53.8	3 kVA				-
	Total Amps		mps: 21	0 A	20	4 A	19	94 A	·				
Load C	pad Classification Connected Load		nnected Load (VA) D	emand Fa	ctor	Estimated	d Demand	. Panel Totals				
Equipm	nent			126500 VA		100.00%)	1265	500 VA	Total Conn. Load: 164.8 k	VΑ		
_ighting	3			4768 VA		125.00%)	596	60 VA	Total Conn. Current: 198 A			
Other				244 VA		100.00%			4 VA	Total Est. Demand Load: 154.4 k	VΑ		
Recept	acle			33300 VA		65.02%		216	50 VA	Total Est. Demand Current: 186 A		_	

1. REFER TO THE SINGLE LINE DIAGRAM FOR FEEDER SIZE.

2. BRANCH CIRCUIT SIZE SHALL BE 3#8, 1#12 GND - 3/4"C. 3. BRANCH CIRCUIT SIZE SHALL BE 3#4, 1#8 GND - 1"C

PANEL: RP1

Location: ELECTRICAL 125 Supply From: T-LP1 Mounting: Surface

Volts: 120/208 Wye Phases: 3

A.I.C. Rating: 10000 Mains Type: MCB Mains Rating: 225 A

CKT	Poles	Trip	Circuit Description	А	\	I	В		С	Circuit Description	Trip	Poles	СКТ
1	1	20 A	(R) LOCKEROOM / RR - RM 117-120	1.72 kVA	0.72					(R) BREAKROOM - RM 121	20 A	1	2
3	1	20 A	(R) EXTERIOR GATE			0.54 kVA	1.26 kVA			(R) SUPERVISOR OFFICE - RM 123	20 A	1	4
5	1	20 A	(R) ROOMS 104, 124					1.08	0.18 kVA	(R) FRIDGE - AG LAB/ DIS RM 104	20 A	1	6
7	1	20 A	(R) ROOMS - 106, 107	1.08 kVA	0.90					(R) ROOMS - 100, 101	20 A	1	8
9	1	30 A	(R) GENERAL OFFICE AREA 122			0.72 kVA	0.54 kVA			(R) SECURE STORAGE - RM 111	20 A	1	10
11	1	20 A	(R) ROOMS - 113, 114					1.62	1.62 kVA	(R) ROOMS 115, 116	20 A	1	12
13	1	20 A	(R) GENERAL OFFICE AREA 122	0.72 kVA	0.72					(R) GENERAL OFFICE AREA 122	20 A	1	14
15	1	20 A	(R) GENERAL OFFICE AREA 122			0.72 kVA	0.72 kVA			(R) EXTERIOR GFCI	20 A	1	16
17	1	20 A	(R) EXTERIOR GFCI					0.90	0.85 kVA	(E) HOT WATER PUMP	20 A	1	18
19	1	20 A	(E) EF 3,4	1.70 kVA	0.18					(R) ELECTRIC - RM 125	20 A	1	20
21	1	20 A	(E) EF 1,2			1.70 kVA	0.85 kVA			(E) EF 6	20 A	1	22
23	1	20 A	(R) SLAN - RM 112					0.18	0.18 kVA	(R) SLAN - RM 112	20 A	1	24
25	1	20 A	(R) SLAN - RM 112	0.36 kVA	0.18					(R) BREAK RM - VENDING- RM 121	20 A	1	26
27	1	20 A	(R) BREAK RM - FRIDGE- RM 121			0.18 kVA	0.18 kVA			(R) BREAK RM - MICROWAVE - RM 121	20 A	1	28
29	1	20 A	(E) GENERATOR BATTERY CHARGER					1.20	0.18 kVA	(R) PAC MAINT RECEPTACLE	20 A	1	30
31,33,35				4.20 kVA	1.20					(E) WATER JACKET HEATER (GENERATOR	R) 20 A	1	32
	3	20 A	(E) GATE OPERATOR - CBP PARKING			4.20 kVA	1.54 kVA			(R) EWC - RM 100	20 A	1	34
								4.20	0.18 kVA	(E) GENERATOR BATTERY CHARGER	20 A	1	36
37	1	20 A	(E) FUME HOOD LIGHT - RM 104	0.50 kVA	1.70					(E) INSINKERATOR - RM 121	20 A	1	38
39,41,43						2.10 kVA	0.50 kVA			(R) TOILET - HOLD RM 108	20 A	1	40
	3	20 A	(E) GATE OPERATOR					2.10	0.50 kVA	(E) FLUSH VALVE MENS RR RM 120	20 A	1	42
				2.10 kVA	0.50					(E) FLUSH VALVE WOMENS RR RM 120	20 A	1	44
45,47	2	20.4	(F) CU 4 / AC 4 (NOTE 2)			2.60 kVA	0.10 kVA			(E) GCTC	20 A	1	46
	2	30 A	(E) CU-1 / AC - 1 (NOTE 2)					2.60	0.30 kVA	(E) GENERAL POWER FOR GENERATOR	20 A	1	48
49													50
51													52
53													54
55													56
57													58
59													60
			Total Load:				kVA		9 kVA				
			Total Amps:				4 A		49 A	-			
Load Clas		on	Connected	•) D	emand Fa			ed Deman				
Equipmen				00 VA 00 VA		100.00% 79.24%			700 VA 8550 VA	Total Conn. Load: 54.8 k Total Conn. Current: 152 A			
Receptacl	C		1710	UVA		19.24%		13	OOOU VA	Total Est. Demand Load: 51.3 k			
										Total Est. Demand Current: 142 A			

1. ALL BRANCH CIRCUIT SHALL BE 2#12 GND - 3/4"C UNO.

2. 2 #10, 1 #10 GND - 3/4"C.

Branch Panel: ERP

Location: ELEC ROOM 126125 Supply From: UPS Mounting: Surface

Volts: 120/208 Wye Phases: 3

Wires: 4

A.I.C. Rating: 10000 Mains Type: MCB Mains Rating: 100 A

СКТ	Circuit Description	Trip	Poles		4	ı	В		2	Poles	Trip	Circuit Description	СКТ
1	(R) LAN/SLAN 112	20 A	1	1200	1200					1	20 A	(R) LAN/SLAN 112	2
3	(R) LAN/SLAN 112	20 A	1			1200	1200			1	20 A	(R) LAN/SLAN 112	4
5	(R) LAN/SLAN 112	20 A	1					1200	1200	1	20 A	(R) LAN/SLAN 112	6
7	(R) CONF. RM 116	20 A	1	360 VA	360 VA					1	20 A	(R) CONF. RM 116	8
9	(R) PROCESSING AREA - RM 103	20 A	1			1080	360 VA			1	20 A	(R) PROCESSING AREA - RM 103	10
11	(E) XRAY - RM 103	20 A	1					360 VA	360 VA	1	20 A	(R) PROCESSING AREA - RM 103	12
13	(R) PROCESSING AREA - RM 103	20 A	1	360 VA	360 VA					1	20 A	(R) PROCESSING AREA - RM 103	14
15	(R) PROCESSING AREA - RM 103	20 A	1			360 VA	1260			1	20 A	(R) PRE PROCESSING AREA - RM 103	16
17	(R) PROCESSING AREA - RM 103	20 A	1					360 VA	750 VA	2	20. 4	(E) POWER SUPPLY - RM 112	18
19	(E) POWER SUPPLY - RM 112	20 A	2	750 VA	750 VA					2	20 A	(E) POWER SUPPLY - RIVI 112	20
21	(E) POWER SUPPLY - RIVI 112	20 A				750 VA	180 VA			1	20 A	(R) VIDEO MONITOR - DETENTION CORRIDOR	22
23	(R) LAN/SLAN 112	20 A	1					1200	1200	1	20 A	(R) LAN/SLAN 112	24
25	(R) LAN/SLAN 112	20 A	1	1200									26
27													28
29													30
31													32
33													34
35													36
37													38
39													40
41													42
		Tota	al Load:	654	VA	639	0 VA	6630	VA				
		Tota	l Amps:	55	iΑ	53	3 A	55	iΑ	,			

Panel Totals **Load Classification** Connected Load **Demand Factor Estimated Demand** 360 VA 100.00% 360 VA 16200 VA 80.86% 13100 VA Total Conn. Load: 16560 VA Total Est. Demand: 13460 VA Total Conn.: 46 A Total Est. Demand: 37 A

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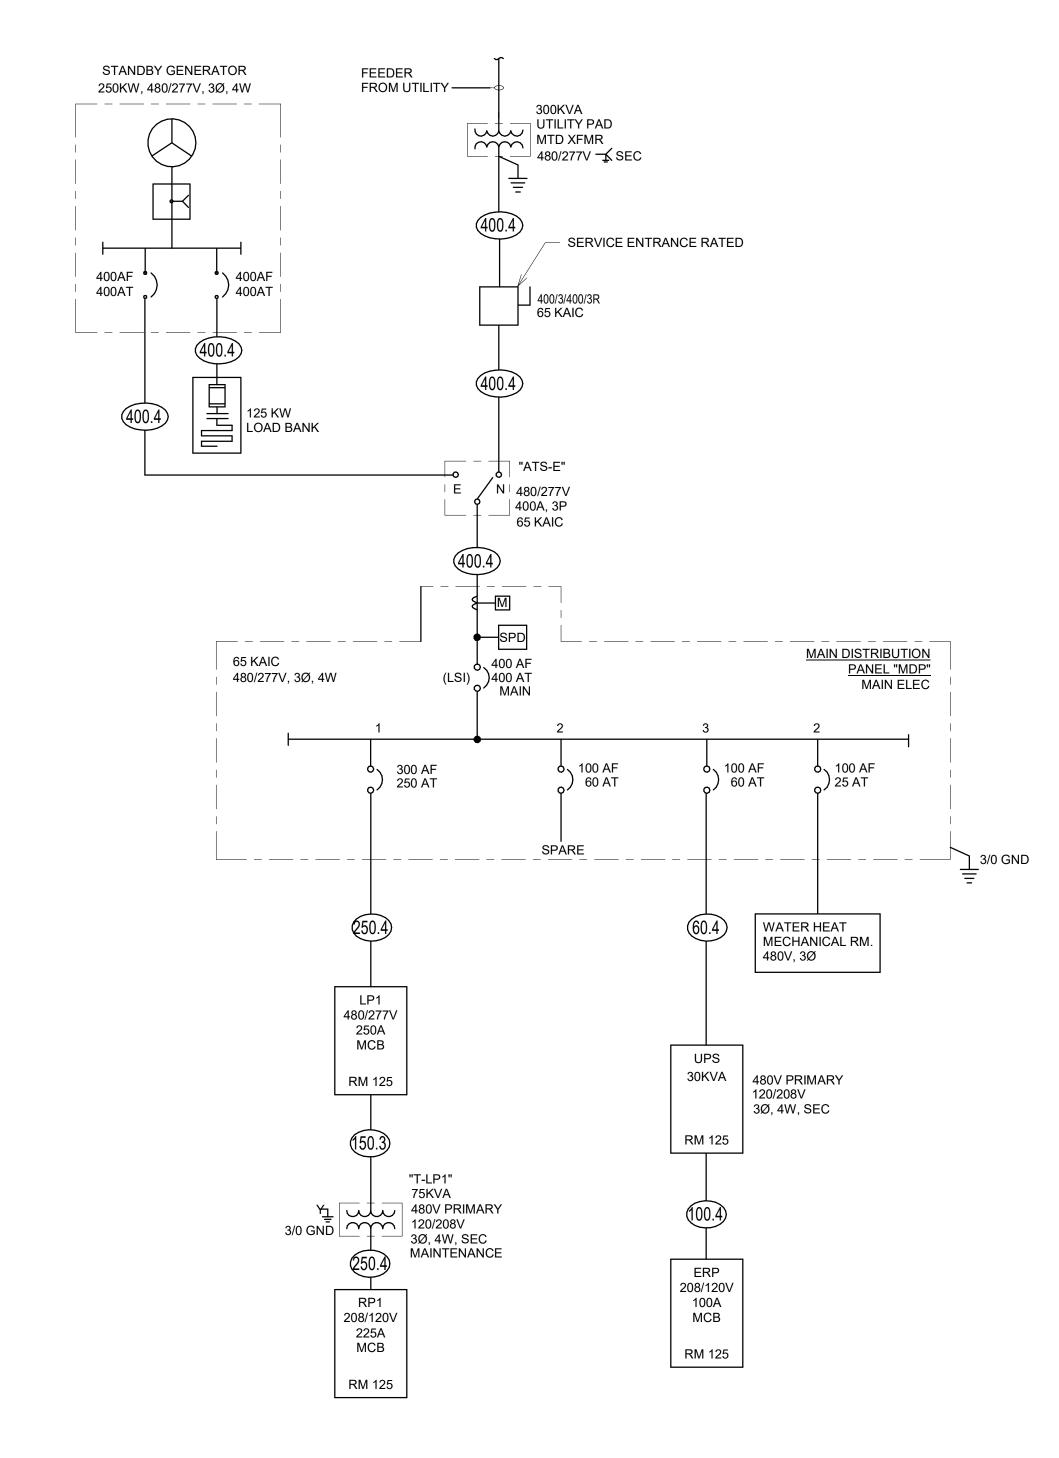
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201-0052-002

ELECTRICAL PANEL SCHEDULES

SHEET NUMBER

E601



1	PNS GAF - SINGLE LINE DIAGRAM
E701	SCALE: NOT TO SCALE

MADIA	CADACITY			ONDUCTOR SCHEDU WIRE	EQUIP GND	CONDUI
MARK 30.3	CAPACITY 30 AMP	SETS 1	PHASE/WIRE	(3) #10 CU	#10 CU	
30.3	30 AMP	1	3/3	(4) #10 CU	#10 CU	3/4"
			3/4	(4) #10 CU		3/4"
40.3	40 AMP	1	3/3	. ,	#10 CU	1"
40.4	40 AMP	1	3/4	(4) #6 CU	#10 CU	1"
50.3	50 AMP	1	3/3	(3) #6 CU	#10 CU	1"
50.4	50 AMP	1	3/4	(4) #6 CU	#10 CU	1"
60.3	60 AMP	1	3/3	(3) #4 CU	#10 CU	1-1/2"
60.4	60 AMP	1	3/4	(4) #4 CU	#10 CU	1-1/2"
70.3	70 AMP	1	3/3	(3) #4 CU	#8 CU	1-1/2"
70.4	70 AMP	1	3/4	(4) #4 CU	#8 CU	1-1/2"
80.3	80 AMP	1	3/3	(3) #2 CU	#8 CU	1-1/2"
80.4	80 AMP	1	3/4	(4) #2 CU	#8 CU	1-1/2"
100.3	100 AMP	1	3/3	(3) #1 CU	#8 CU	2"
100.4	100 AMP	1	3/4	(4) #1 CU	#8 CU	2"
100.S	100 AMP	1	3/4	(4) #1 CU	-	2"
150.3	150 AMP	1	3/3	(3) #2/0 CU	#6 CU	2"
150.4	150 AMP	1	3/4	(4) #2/0 CU	#6 CU	2"
150.S	150 AMP	1	3/4	(4) #2/0 CU	-	2"
225.3	225 AMP	1	3/3	(3) #4/0 CU	#6 CU	3"
225.4	225 AMP	1	3/4	(4) #4/0 CU	#6 CU	3"
225.S	225 AMP	1	3/4	(4) #4/0 CU	-	3"
250.3	250 AMP	1	3/3	(3) #250KCMIL CU	#6 CU	3"
250.4	250 AMP	1	3/4	(4) #250KCMIL CU	#6 CU	3"
250.S	250 AMP	1	3/4	(4) #250KCMIL CU	-	3"
300.3	300 AMP	1	3/3	(3) #350KCMIL CU	#4 CU	3"
300.4	300 AMP	1	3/4	(4) #350KCMIL CU	#4 CU	3"
300.S	300 AMP	1	3/4	(4) #350KCMIL CU	-	3"
400.3	400 AMP	2	3/3	(3) #4/0 CU X 2	#4 CU X 2	3"X 2
400.4	400 AMP	2	3/4	(4) #4/0 CU X 2	#4 CU X 2	3"X 2
400.S	400 AMP	2	3/4	(4) #4/0 CU X 2	-	3"X 2
500.3	500 AMP	2	3/3	(3) #250KCMIL CU X 2	#2 CU X 2	3"X 2
500.4	500 AMP	2	3/4	(4) #250KCMIL CU X 2	#2 CU X 2	3"X 2
500.S	500 AMP	2	3/4	(4) #250KCMIL CU X 2	-	3"X 2
600.3	600 AMP	2	3/3	(3) #350KCMIL CU X 2	#1 CU X 2	3"X 2
600.4	600 AMP	2	3/4	(4) #350KCMIL CU X 2	#1 CU X 2	3"X 2
600.S	600 AMP	2	3/4	(4) #350KCMIL CU X 2	-	3"X 2
800.3	800 AMP	2	3/3	(3) #600KCMIL CU X 2	#1/0 CU X 2	3"X 2
800.4	800 AMP	2	3/4	(4) #600KCMIL CU X 2	#1/0 CU X 2	3"X 2
800.S	800 AMP	2	3/4	(4) #600KCMIL CU X 2		3"X 2
1000.3	1000 AMP	3	3/3	(3) #600KCMIL CU x 3	#2/0 CU X 3	4"X 3
1000.4	1000 AMP	3	3/4	(4) #600KCMIL CU x 3	#2/0 CU X 3	4"X 3
1000.4 1000.5	1000 AMP	3	3/4	(4) #600KCMIL CU x 3	πΔΙΟ GU Λ 3	4 X 3
1200.3	1200 AMP	3		(3) #600KCMIL CU x 3	#3/0 CLL V 3	4 X 3
1200.3	1200 AMP	3	3/3	(4) #600KCMIL CU x 3	#3/0 CU X 3	
			3/4	(4) #600KCMIL CU x 3	#3/0 CU X 3	4"X 3
1200.S 1600.3	1200 AMP	3	3/4	(3) #600KCMIL CU x 4	11410 01137 4	4"X 3
	1600 AMP	4	3/3	` '	#4/0 CU X 4	4"X 4
1600.4	1600 AMP	4	3/4	(4) #600KCMIL CU x 4 (4) #600KCMIL CU x 4	#4/0 CU X 4	4"X 4

NOTE: SCHEDULE IS A MASTER SCHEDULE. NOT ALL CONDUCTOR SIZES ARE USED IN THE SINGLE LINE DIAGRAM.

AMPS	GEC SIZE
100	#6 CU
150	#6 CU
200	#2 CU
250	#2 CU
400	#1/0 CU
500	#1/0 CU
600	#3/0 CU
800	#3/0 CU
1000	#3/0 CU
1200	#3/0 CU
1600	#3/0 CU
2000	#3/0 CU
3000	#3/0 CU
4000	#3/0 CU
5000	#3/0 CU

NOTE: SCHEDULE IS A MASTER SCHEDULE. NOT ALL CONDUCTOR SIZES ARE USED IN THE SINGLE LINE DIAGRAM.



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	DRAWN BY:			WM/RE
ı			·	

PROJECT NUMBER: 201-0052-002

DESIGNED BY:

WM/RB

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SHEET TITLE

ELECTRICAL ONE LINE DIAGRAM

SHEET NUMBER

E701

AIRPORT PENSACOLA, FLORIDA

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904-256-2500 Fax 904-256-2503

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WM/RB

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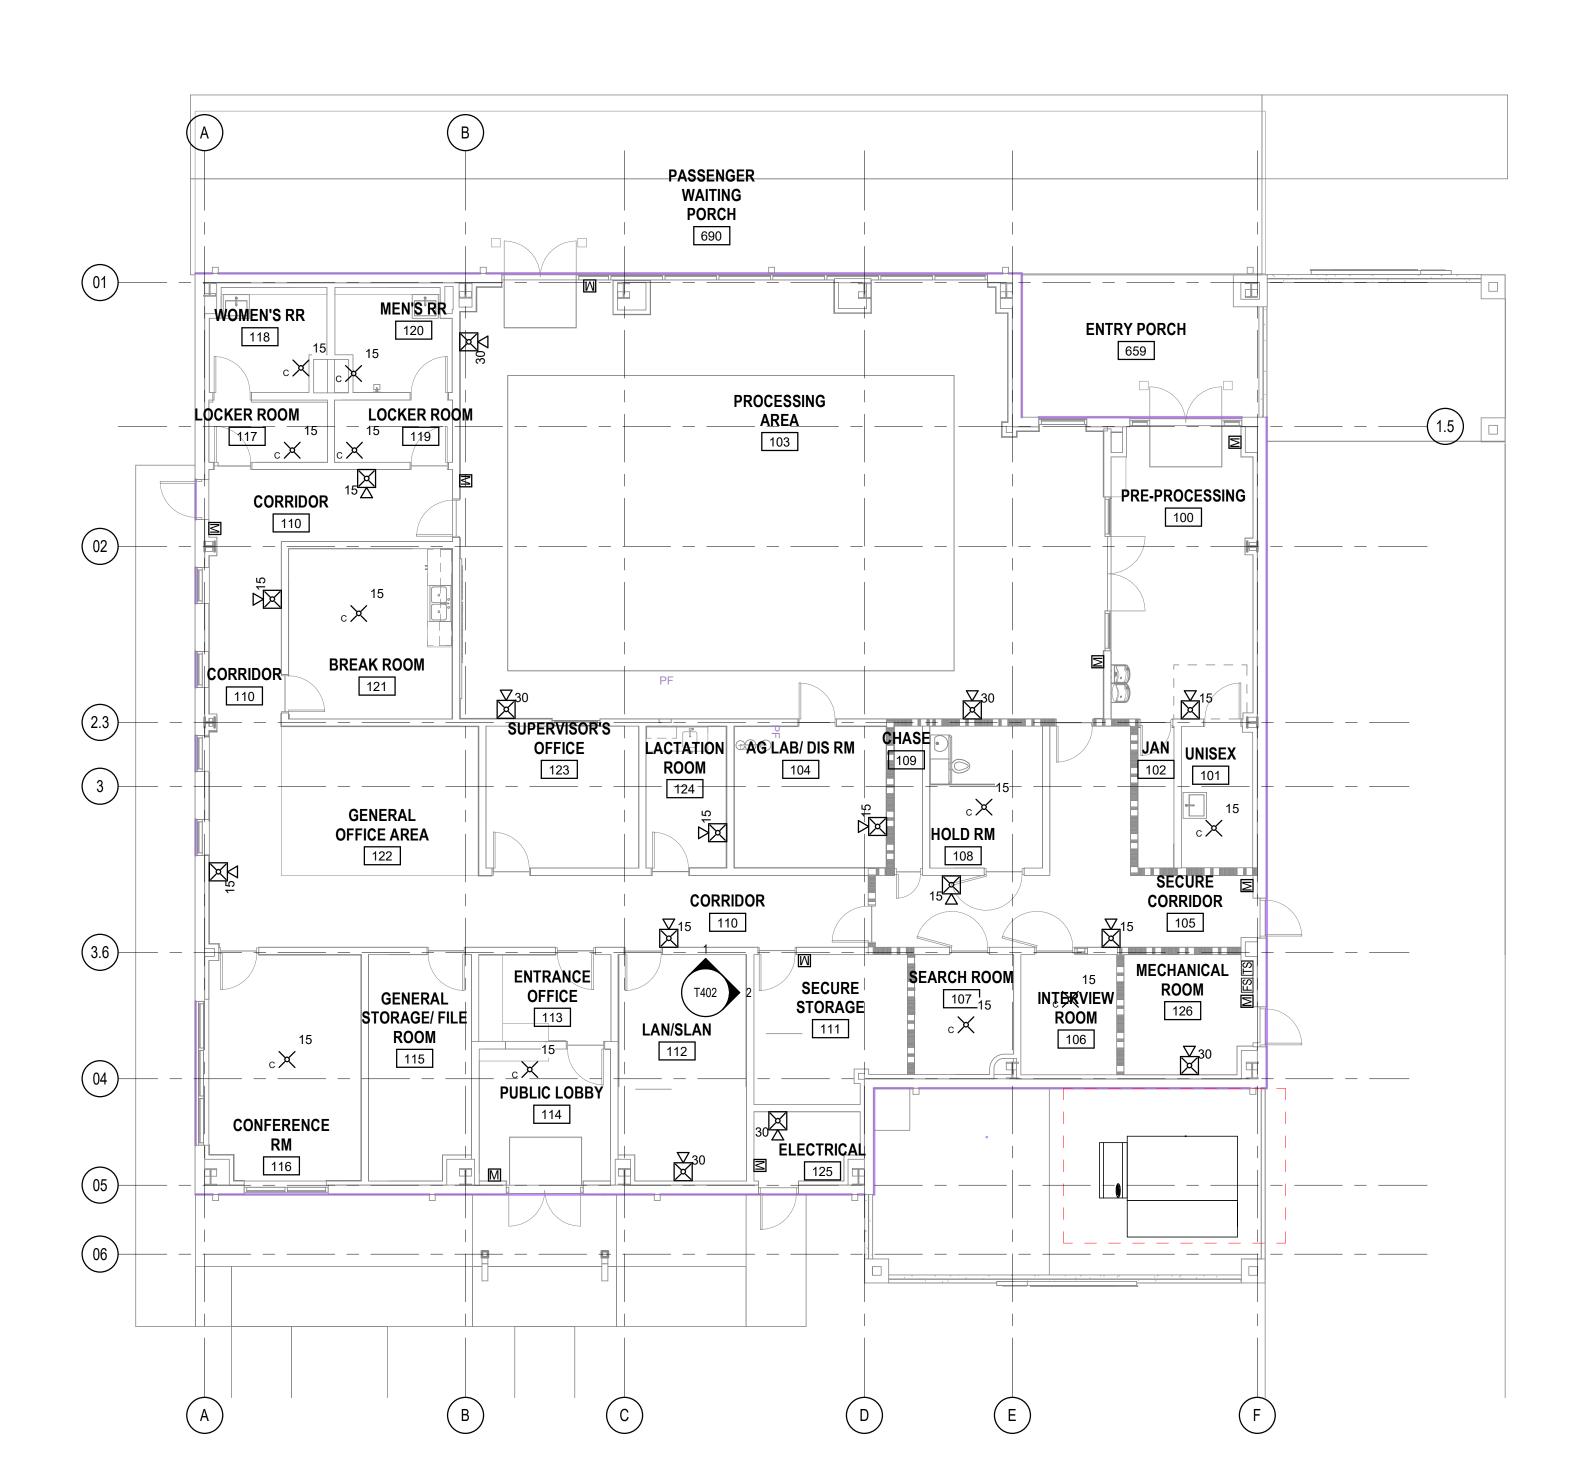
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FIRST FLOOR **PLAN - FIRE ALARM**

SHEET NUMBER

FA101


SCALE: 1/8" = 1'-0"







3/4" C

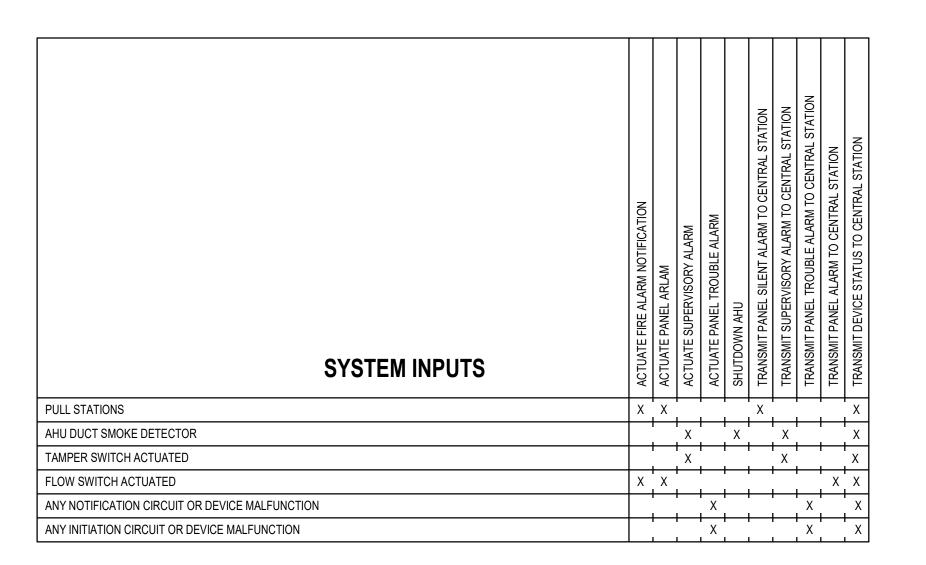

2

FIRE ALARM OPERATION SEQUENCE

SCALE: 1" = 1'-0"

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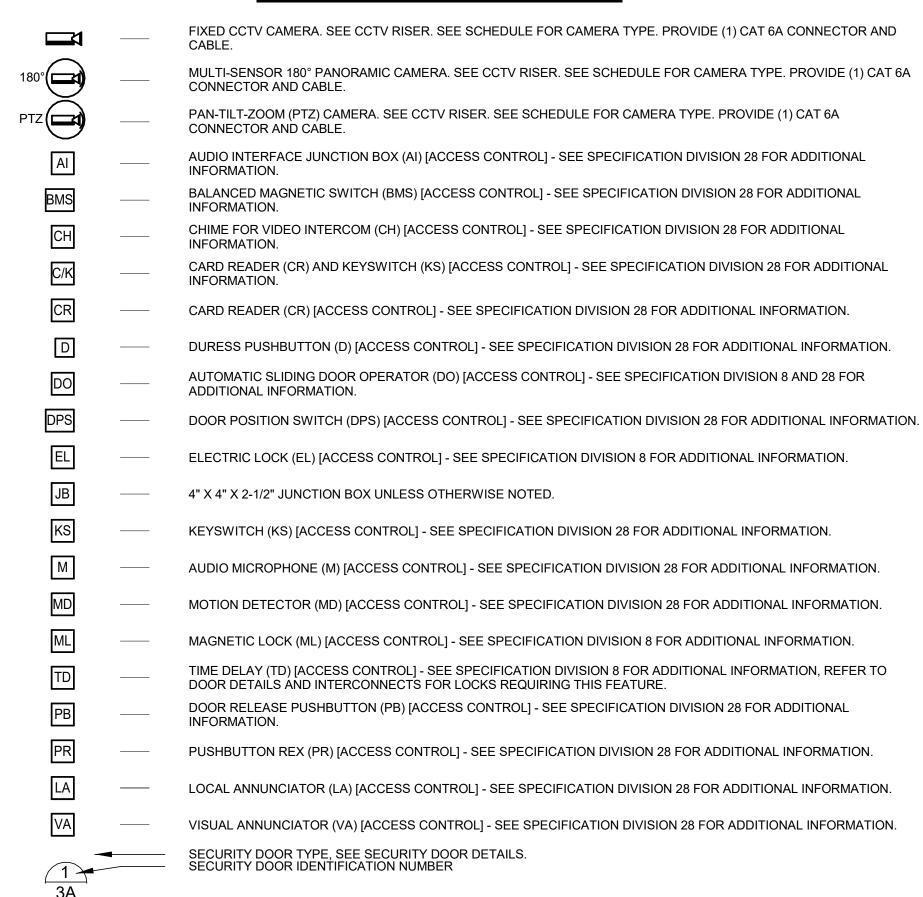
SHEET TITLE

FIRE ALARM RISER DIAGRAM

SHEET NUMBER

FA701

SECURITY SYSTEMS LEGEND



		COMMUNICATIONS SYSTEMS LEGEND
		FLOOR BOX COMMUNICATION OUTLET - (3) CAT6A COMMUNICATIONS JACKS (ONE (1) WHITE AND TWO (2) BLUE) WITH (1) WHITE AND TWO (2) BLUE BLUE CAT 6A.
•	18" TO €	SECURITY/VIDEO OUTLET - (2) CAT6A COMMUNICATIONS JACKS (GREEN) WITH GREEN CAT 6A, SEE NOTES 16 & 17.
\triangleleft	18" TO €	COMMUNICATION OUTLET - (3) CAT6A COMMUNICATIONS JACKS (ONE (1) WHITE AND TWO (2) BLUE) WITH ONE (1) WHITE AND TWO (2) BLUE BLUE CAT 6A, SEE NOTES 16 & 17.
⋖w	54" TO €	WALL PHONE OUTLET- (1) WALL PHONE JACK (WHITE) WITH WHITE CAT 6A, SEE NOTES 16 & 17.
⋖ TV	84" TO &	TELEVISION OUTLET- WALL MOUNTED TELEVISION JACK WITH (1) COAX AND (2) CAT6A COMMUNICATIONS JACKS (ONE (1) GREEN AND ONE (1) BLUE) WITH ONE (1) GREEN AND ONE (1) BLUE CAT 6A.
		CABLE TRAY, SIZE AS NOTED.
		TELECOM EQUIPMENT CABINET (REFER TO COMM ROOM LAYOUT DRAWINGS)
		CONDUIT TURNING UP
		CONDUIT TURNING DOWN
		CONDUIT RUN, CAPPED
		CONDUIT RUN, TERMINATING WITH END BUSHING
(AP)		WIRELESS ACCESS POINT (FURNISHED BY CBP UON.) - PROVIDE (2) CAT 6A COMMUNICATIONS JACKS (YELLOW) WITH YELLOW CAT6A, SEE NOTES 16 & 17.

CABLE JACKET/RJ-45 MODULE COLORS SHALL BE AS FOLLOWS UNLESS OTHERWISE NOTED:

CBP DATA: BLUE

SECURITY/VIDEO: GREEN

VOICE: WHITE

WAP: YELLOW

RADIO: RED

GENERAL NOTES:

- 1. CONTRACTOR SHALL FIELD VERIFY ALL NEW DEVICE AND EQUIPMENT LOCATIONS PRIOR TO THE START OF INSTALLATION. ANY CONFLICTS SHALL BE IMMEDIATELY BROUGHT TO THE ATTENTION OF THE OWNER.
- 2. MINIMUM CONDUIT SIZE SHALL BE 3/4" WITH THE EXCEPTION OF "DROP CONDUITS" AT DOOR LOCATIONS, WHICH MAY BE 1/2". ALL CONDUITS SHALL BE EMT:
- EXCEPTIONS INCLUDE A. GRS FOR EXTERIOR AREAS
- B. RS FOR AREAS ACCESSIBLE TO THE PUBLIC
- C. PVC FOR BURIED OR CAST-IN-PLACE CONDUITS
- D. FLEXIBLE CONDUIT FOR CONCEALED DROPS TO DEVICES AND WHERE APPROVED BY THE OWNER.
- 3. CONDUIT FILL SHALL NOT EXCEED 40%. INSTALLATION OF CONDUIT AND WIRING SHALL BE IN COMPLIANCE WITH NATIONAL ELECTRICAL CODE (NEC). ALL WIRING SHALL BE HOMERUN, UNLESS OTHERWISE NOTED. ANY SPLICES MUST BE APPROVED BY THE DESIGNER.
- 4. CONTRACTOR SHALL COORDINATE THE ROUTING AND LOCATION OF NEW COMMUNICATIONS CONDUITS WITH THE ELECTRICAL CONTRACTOR AND OTHER TRADES.
- 5. CONTRACTOR SHALL BE RESPONSIBLE FOR ENSURING THAT LINE VOLTAGE (120V AND ABOVE) POWER CONDUCTORS ARE NOT ROUTED WITHIN 12 INCHES OF COMMUNICATIONS WIRING.
- 6. ALL CONDUCTORS SHALL BE COLOR CODED AND TAGGED AS DESCRIBED IN THE WRITTEN SPECIFICATIONS AND APPROVED BY THE DESIGNER.
- 7. COORDINATE WORK WITH OTHER TRADES AND CONFIRM FINAL MOUNTING LOCATION FOR NEW AND RELOCATED EQUIPMENT WITH THE OWNER PRIOR TO
- 8. CONTRACTOR SHALL FOLLOW MANUFACTURER'S RECOMMENDED INSTALLATION PROCEDURES FOR ALL EQUIPMENT. UNLESS OTHERWISE NOTED, ALL MATERIALS SHALL BE NEW AND UNUSED.
- 9. ALL RACEWAY, CONDUIT AND JUNCTION BOXES SHALL BE NEW AND INSTALLED WITH PULL STRING. REUSE OF EXISTING CONDUITS MUST BE APPROVED BY THE
- 10. CONDUITS PENETRATING FIRE RATED WALLS OR FLOORS SHALL USE APPROVED U.L. DEVICES IN ORDER TO MAINTAIN FIRE RATING OF THE WALL OR FLOOR.
- 11. ALL SECURITY CABLING SHALL BE INSTALLED IN DEDICATED CONDUIT.
- 12. MAINTAIN MINIMUM BENDING RADII FOR ALL CABLES ACCORDING TO THE CABLE MANUFACTURER AND PER BICSI AND TIA STANDARDS.
- 13. ALL WIRING, CABLING AND CONDUCTORS SHALL BE NEW UNLESS REUSE OF EXISTING IS APPROVED BY THE OWNER.
- 14. ALL WORK MUST BE CLOSELY COORDINATED WITH THE OWNER. ANY WORK AFFECTING AIRPORT OPERATIONS, CBP, TSA OR TENANTS MUST BE SCHEDULED IN ADVANCE AND PRE-APPROVED BY THE OWNER.
- 15. IF EXISTING FOUIPMENT, MUST BE DECOMMISSIONED. THE CONTRACTOR SHALL COORDINATE WITH THE OWNER TO PROPERLY SHUT DOWN FOUIPMENT PRIOR TO DISCONNECTING. CONTRACTOR SHALL PROPERLY STORE EQUIPMENT ON SITE AT AN AREA DESIGNATED BY THE OWNER UNTIL THE EQUIPMENT IS REINSTALLED OR CONVEYED TO THE OWNER UPON COMPLETION OF THE PROJECT.
- 16. ALL COMMUNICATIONS OUTLET BOXES SHALL BE MIN. 4" WIDE BY 4" HIGH BY 2 1/2" DEEP WITH SINGLE GANG MUD RING.
- 17. UNLESS NOTED OTHERWISE, PROVIDE 1" C FROM COMMUNICATIONS OUTLET TO THE CABLE TRAY. CONTRACTOR SHALL FURNISH AND INSTALL CABLING AS REQUIRED. CABLE ROUTING WILL BE VIA CONDUIT (INACCESSIBLE SPACES) AND CABLE TRAY SYSTEM (ACCESSIBLE SPACES) TO COMM ROOM OR ROOM OF TERMINATION. PROVIDE RACEWAY SYSTEM OVER THE INACCESSIBLE CEILING SPACE AND AS INDICATED ON PLANS. TELE/DATA CONDUITS ARE TO BE LONG RADIUS TYPE AND SHALL CONTAIN PULL STRINGS. PROVIDE PLATES FOR ALL OUTLETS. CAT 6A CABLES SHALL BE PLENUM RATED. "LB" TYPE FITTING SHALL NOT BE USED.
- 18. SECURITY CONTROL CONDUCTORS SHALL BE SHIELDED COPPER AND MINIMUM 18 AWG, UNLESS OTHERWISE NOTED. SECURITY CONDUCTORS SHALL NOT SHARE CONDUIT WITH CONDUCTORS OF OTHER TRADES. SECURITY CONTRACTOR SHALL BE RESPONSIBLE FOR ENSURING THAT HIGH VOLTAGE (120 VAC) POWER CONDUCTORS ARE NOT ROUTED WITHIN 12 INCHES OF SECURITY CONTROL WIRING. ALL CONDUCTORS SHALL BE COLOR CODED AND TAGGED AS DESCRIBED IN THE WRITTEN SPECIFICATIONS AND APPROVED BY THE DESIGNER.

ABBREVIATIONS:

- ACS ACCESS CONTROL SYSTEM
- AFF ABOVE FINISHED FLOOR
- AGRICULTURAL AHJ AUTHORITY HAVING JURISDICTION
- AUDIO INTERFACE
- AUDIOVISUAL AWG AMERICAN WIRE GAUGE
- BMS BALANCED MAGNETIC SWITCH
- C. CONDUIT CATV CABLE TELEVISION
- CBP CUSTOMS AND BORDER PROTECTION
- CCTV CLOSED CIRCUIT TELEVISION
- CR CARD READER C/K CARD READER AND KEYSWITCH
- **DURESS BUTTON** DIV DIVISION
- DO DOOR OPERATOR
- DPS DOOR POSITION SWITCH
- EL ELECTRIC LOCK GCTC GATE CONTROL TERMINATION CABINET
- GRS GALVANIZED RIGID STEEL
- IDS INTRUSION DETECTION SYSTEM
- INTERNET PROTOCOL
- ISP INTERNET SERVICE PROVIDER
- JB JUNCTION BOX KS KEYSWITCH
- LA LOCAL ANNUNCIATOR LAN LOCAL AREA NETWORK
- LCD LIQUID CRYSTAL DISPLAY MBS MAGNETIC BOND SENSOR
- MD MOTION DETECTOR
- MIC MICROPHONE MAGNETIC LOCK
- MM MULTI-MODE MS MAGNETIC SWITCH
- DOOR RELEASE PUSHBUTTON PUSHBUTTON REX
- POWER TRANSFER PTZ PAN-TILT-ZOOM
- PVC POLYVINYL CHLORIDE
- QTY QUANTITY REX REQUEST TO EXIT
- RIGID STEEL
- SINGLE MODE
- STRIKE SWITCH
- TBD TO BE DETERMINED TD TIME-DELAY
- TVSS TRANSIENT VOLTAGE SURGE SUPPRESSION TYP TYPICAL
- UON UNLESS OTHERWISE NOTED
- UPS UNINTERRUPTIBLE POWER SUPPLY
- VA VISUAL ANNUNCIATOR
- VMS VIDEO MANAGEMENT SYSTEM
- VoIP VOICE OVER IP TELEPHONY WAP WIRELESS ACCESS POINT
- W/T WIRE TROUGH

	CABLE LEGEND				
ID	DESCRIPTION	DEVICE			
Α	6-24 AWG SHIELDED 9-24 AWG SHIELDED	CARD READER. CABLE LENGTH < 450' CARD READER. CABLE LENGTH > 450'			
В	4-22 AWG UNSHIELDED	MISC. INPUT (DOOR POSITION/REX/TD)			
С	4-14 AWG UNSHIELDED	ANNUNCIATOR (HORN/STROBE)			
D	2-14 AWG UNSHIELDED 2-12 AWG UNSHIELDED	MISC. OUTPUT (LOCK) CABLE LENGTH UP TO 100' MISC. OUTPUT (LOCK). CABLE LENGTH UP TO 200'			
Е	CATEGORY 6A UTP	ETHERNET (VOICE, DATA, VIDEO)			
E1	OUTDOOR CAT 6A UTP	OUTDOOR RATED ETHERNET CABLE			
F	2-18 AWG UNSHIELDED	FIRE ALARM RELAY AND MISC. I/O			
G	8-18 AWG UNSHIELDED	GATE OPERATOR I/O			
K	6-18 AWG UNSHIELDED	IDS KEY PAD			
М	PROVIDED BY DEVICE MFG.	EXTERNAL MICROPHONE CABLE			
Т	RG-6/U COAX	CABLE TELEVISION			
R	4-18 AWG SHIELDED	RS-485 SERIAL COMMUNICATION			
Х	MULTI-MODE FIBER	FIBER OPTIC PATCH CABLE			
Υ	25-PAIR COPPER	ANALOG TELEPHONE LINE			

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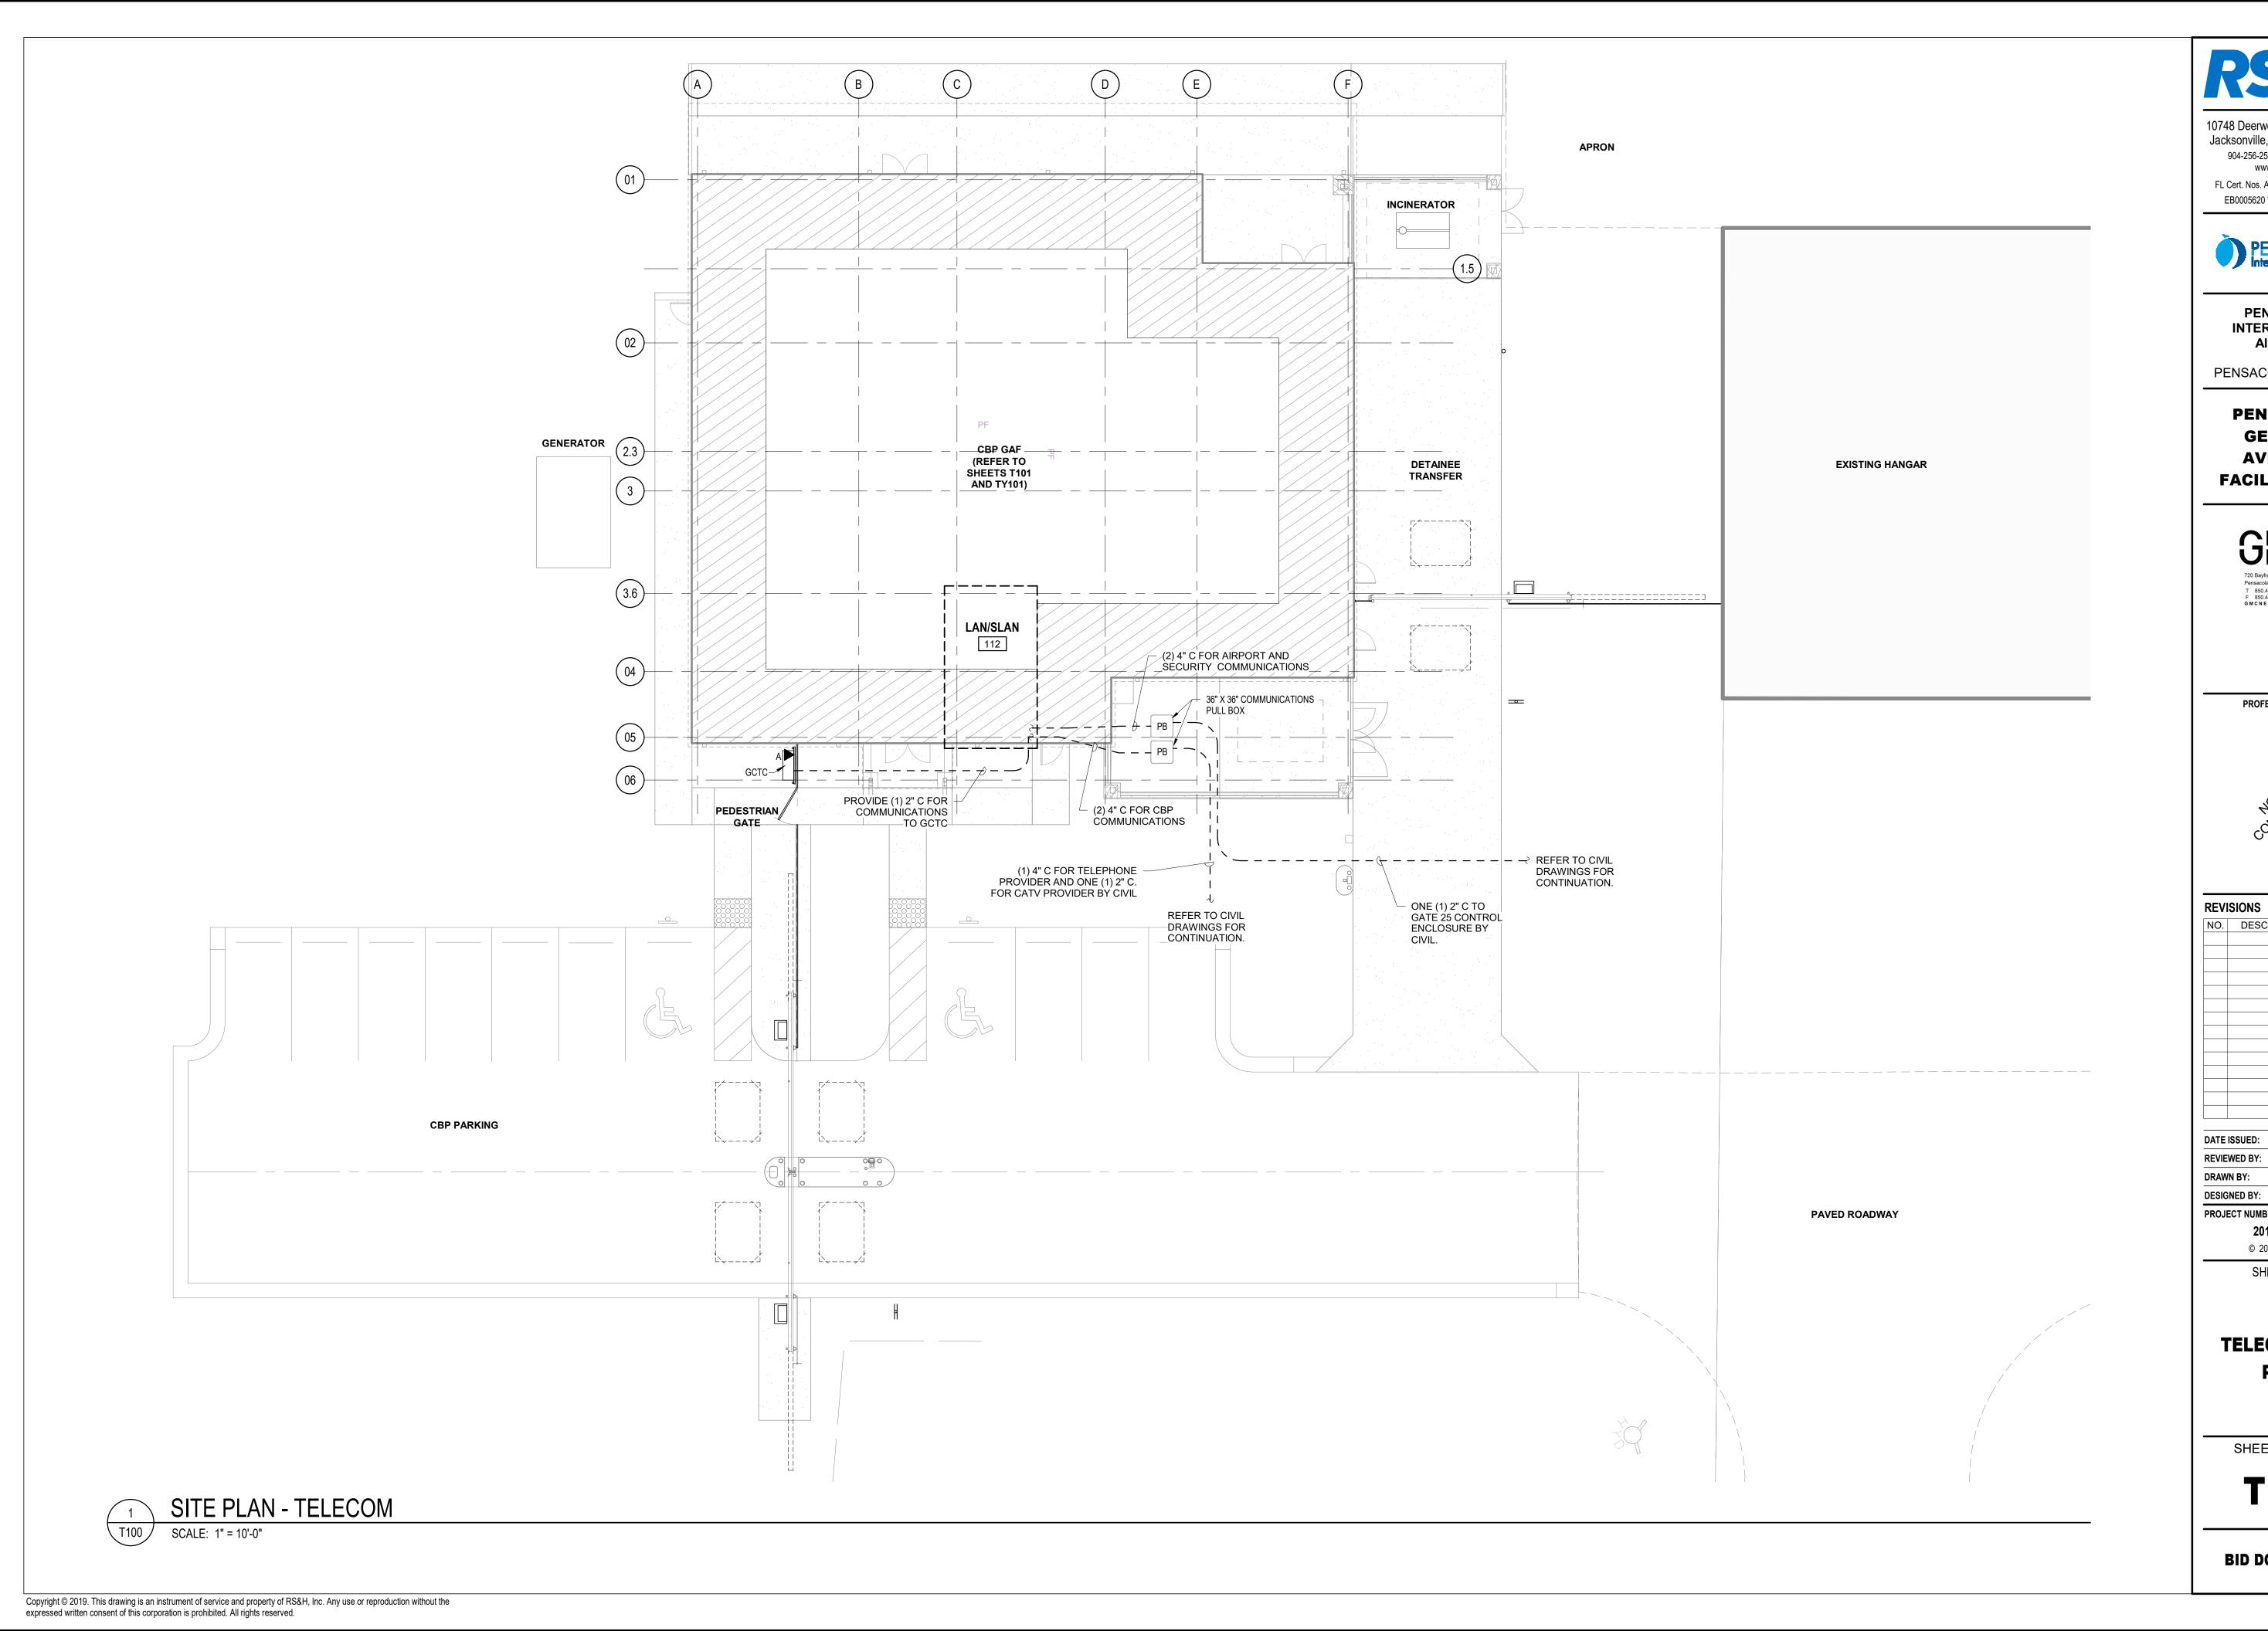
SHEET TITLE

PROJECT NUMBER:

TELECOM GENERAL NOTES, SYMBOLS AND ABBREVIATIONS

SHEET NUMBER

T001





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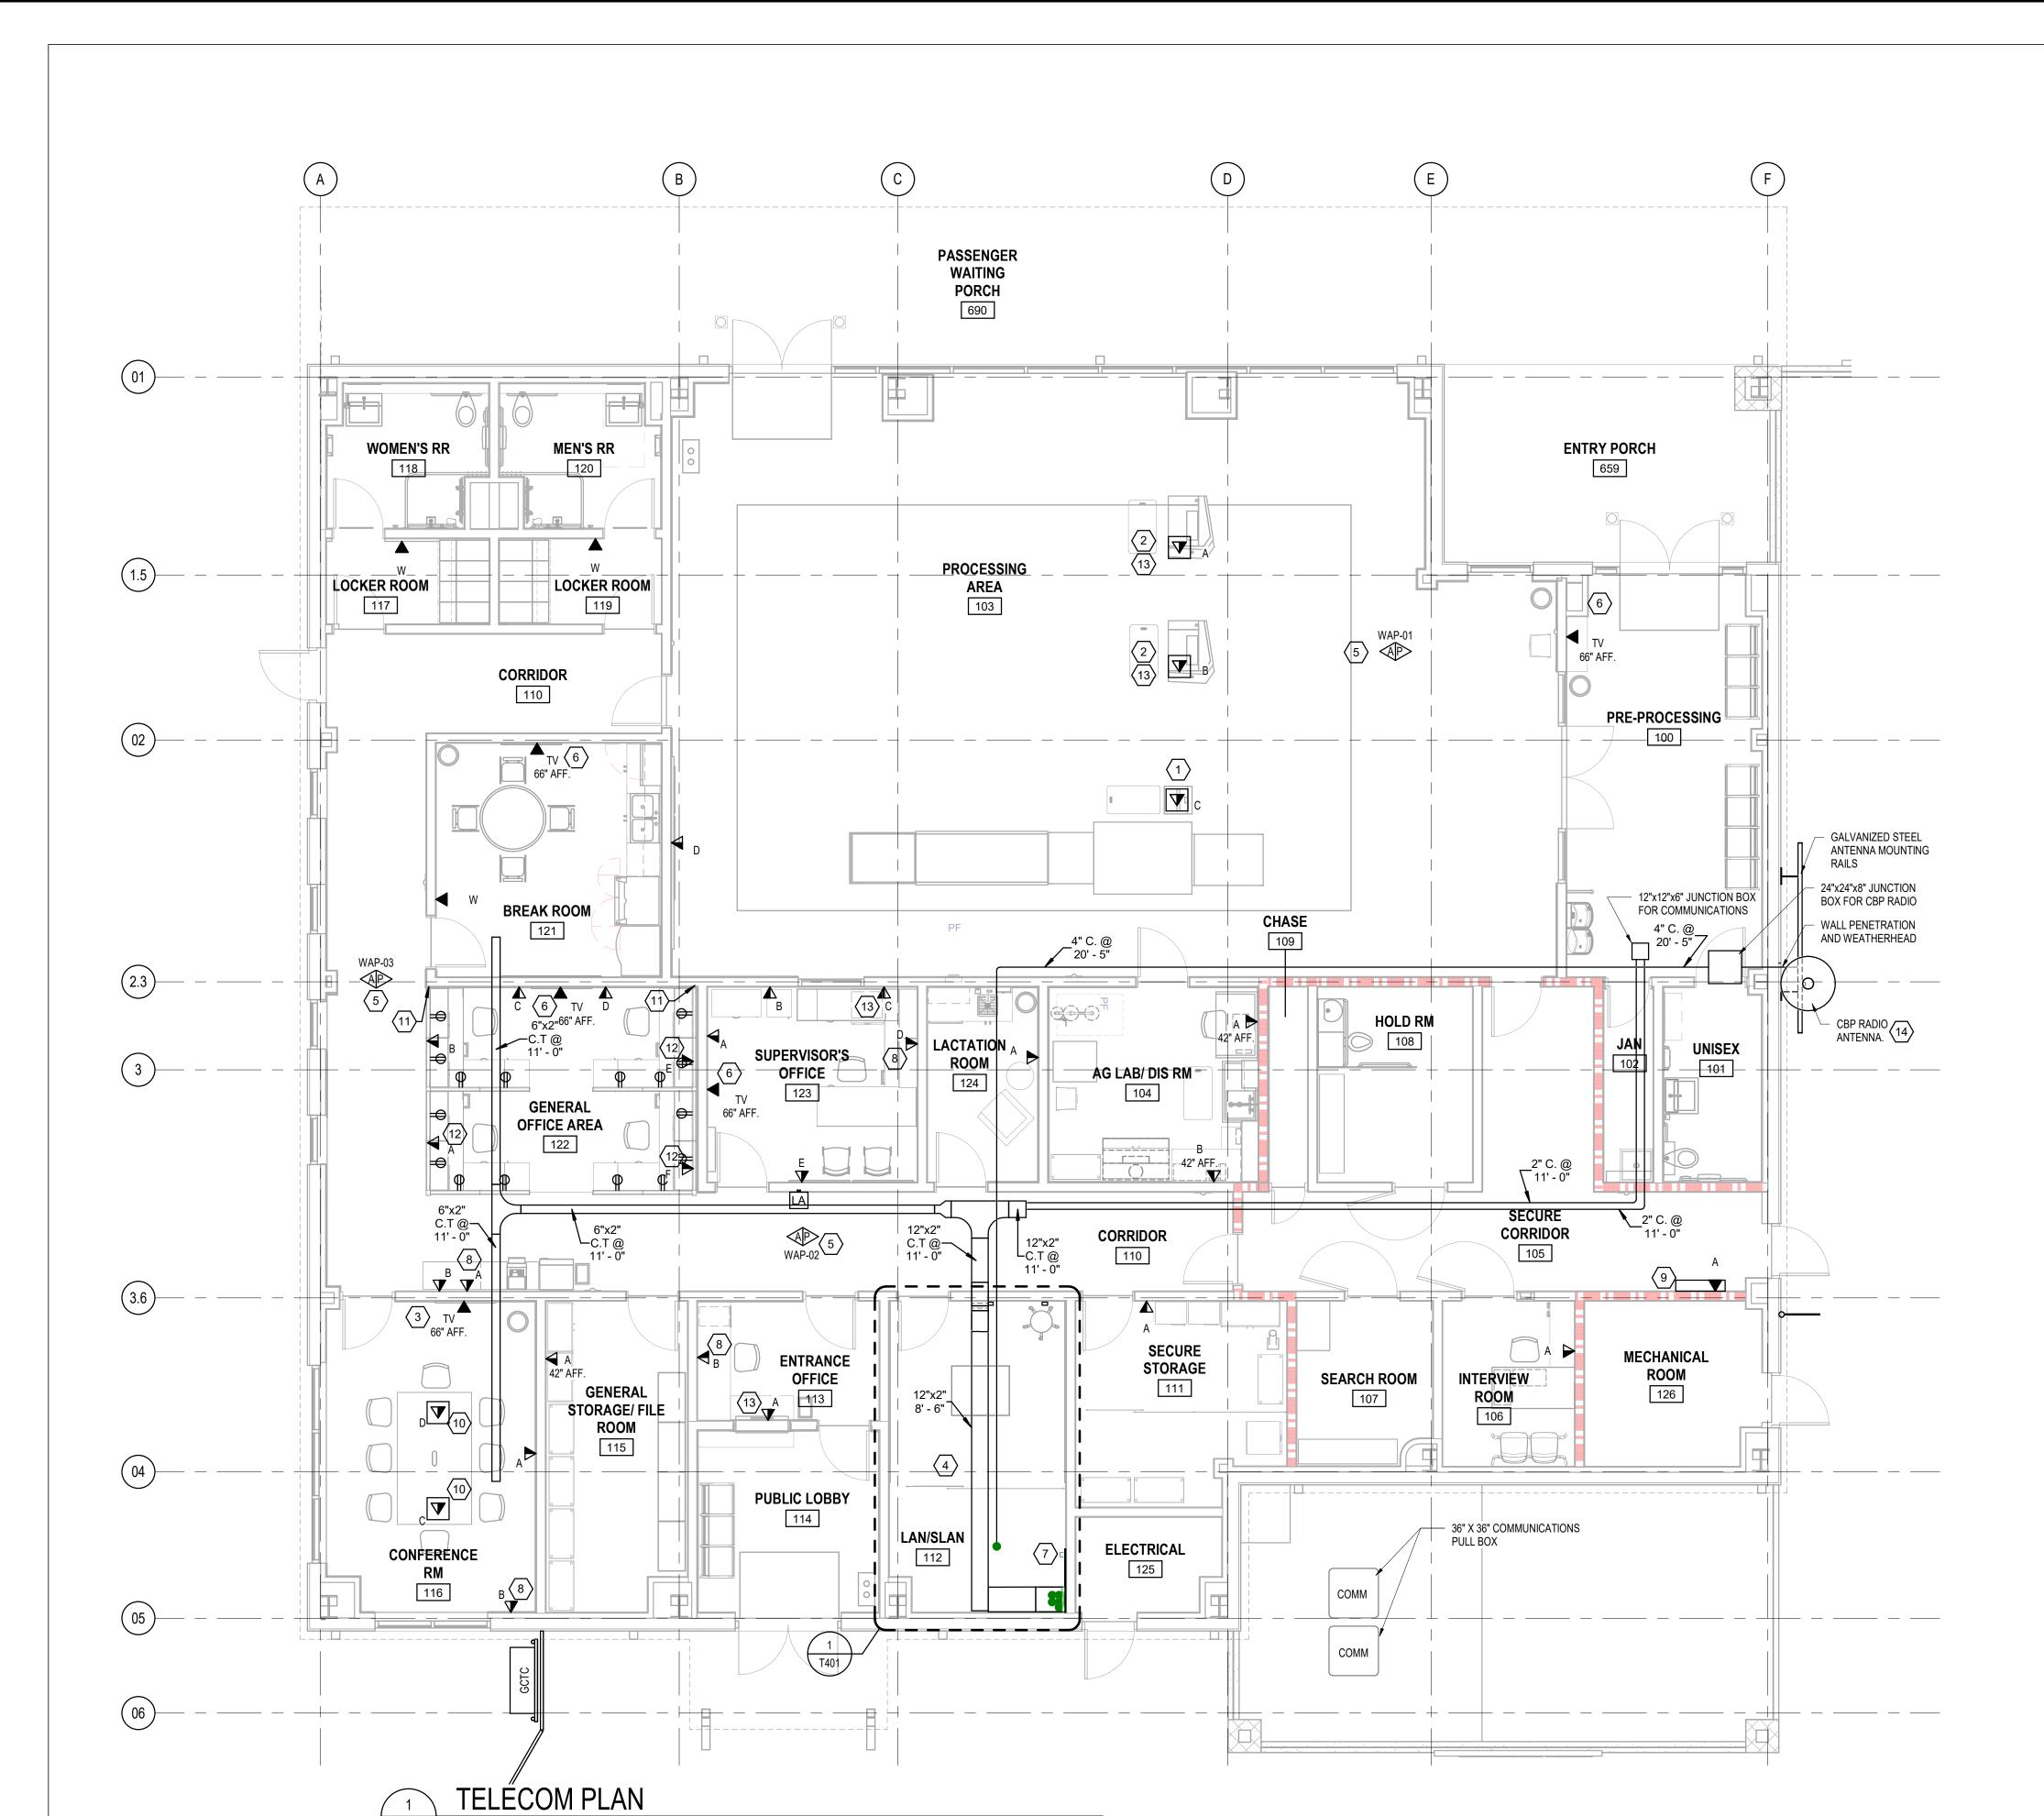
TELECOM SITE

PLAN

SHEET TITLE

SHEET NUMBER

T100



NOTES:

1. COMMUNICATIONS CABLE AND DEVICES INSTALLED ABOVE CEILING SHALL BE PLENUM RATED.

KEYED NOTES:

- 1. DATA OUTLET FOR PROCESSING AREA X-RAY PODIUM. COLOCATE WITH POWER OUTLETS IN FLUSH FLOOR BOX, COORDINATE WITH DIVISION 26.
- 2. DATA OUTLET FOR PRIMARY AREA PODIUM. COLOCATE WITH POWER OUTLETS IN FLUSH FLOOR BOX, COORDINATE WITH DIVISION 26.
- 3. DATA OUTLET FOR OWNER PROVIDED WALL MOUNTED LARGE FORMAT DISPLAY (APPROX 85" LCD). COLOCATE WITH POWER OUTLETS IN RECESSED WALL BOX BEHIND DISPLAY. COORDINATE AV REQUIREMENTS WITH THE OWNER.
- 4. PROVIDE 12-STRAND MM FIBER (50/125 OM2) IN CORRUGATED INNERDUCT TERMINATED ON LC CONNECTORS FOR CONNECTION TO AIRPORT DATA AND SECURITY NETWORKS AT THE GATE 25 GCTC, REFER TO DETAIL 8 ON SHEET T501 (REFER TO CIVIL DRAWINGS FOR LOCATION OF GATE 25).
- 5. CBP WIRELESS ACCESS POINT (WAP) FURNISHED BY CBP AND INSTALLED BY THE CONTRACTOR, CABLE AND TERMINATIONS PROVIDED BY THE CONTRACTOR.
- 6. DATA OUTLET FOR WALL MOUNTED TELEVISION. COLOCATE WITH POWER OUTLETS IN RECESSED WALL BOX BEHIND DISPLAY.
- 7. TELEPHONE AND CATV PROVIDER TERMINATION POINT. 110 BLOCKS FOR 25-PAIR COPPER CABLE AND COAX SPLITTER FOR RG-6/U BETWEEN CBP LAN ROOM AND TELEPHONE POLE (REFER TO CIVIL SITE PLAN FOR POLE LOCATION).
- 8. PROVIDE ADDITIONAL DATA OUTLET FOR CBP RADIO, REFER TO TELECOMMUNICATIONS OUTLET SCHEDULE.
- 9. PROVIDE DATA OUTLET FOR VIDEO MONITOR INSIDE DETENTION GRADE HOUSING. COORDINATE WITH DIVISION 26.
- 10. PROVIDE HDMI CONNECTION BETWEEN FLOOR BOX AND WALL BOX BEHIND WALL MOUNTED TV.
- 11. PROVIDE IN-WALL RACEWAY FOR CONNECTION TO DATA OUTLETS IN FURNITURE SYSTEM, COORDINATE WITH FURNITURE SUPPLIER AND DIVISION 26.
- 12. DATA OUTLET MOUNTED IN FURNITURE SYSTEM WALL, COORDINATE WITH FURNITURE SUPPLIER AND DIVISION 26.
- 13. PROVIDE ADDITIONAL DATA OUTLET FOR SECURITY VIDEO INTERCOM, REFER TO TELECOMMUNICATIONS OUTLET SCHEDULE.
- 14. REFER TO DETAIL ON SHEET T403 FOR RADIO ANTENNA PROVIDED BY CBP.



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SVS

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VJM

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SHEET TITLE

TELECOM PLAN


SHEET NUMBER

T101

BID DOCUMENTS

T101

SCALE: 3/16" = 1'-0"

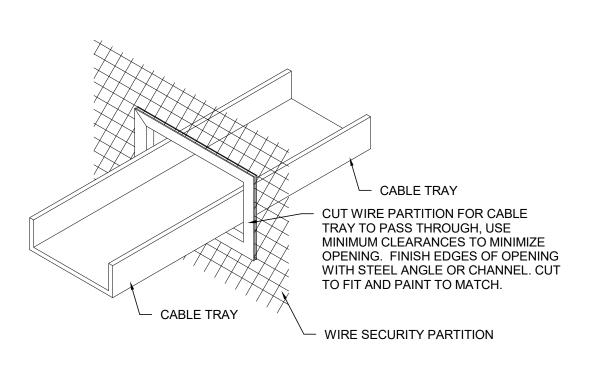

3 DATA CABLE TRAY PENETRATION
T401 SCALE: N.T.S.

NOTES:

- CONTRACTOR SHALL PROVIDE ALL HARDWARE REQUIRED FOR RACK MOUNTED DEVICES. ONCE ALL EQUIPMENT IS INSTALLED CONTRACTOR SHALL FILL EMPTY RACK UNITS IN THE FRONT OF THE CABINET WITH BLANK PANELS.
- 2. REFER TO DETAIL 2 ON SHEET T503 FOR GROUND BUS AND POWER STRIPS REQUIRED WITHIN EACH EQUIPMENT CABINET.
- CHATSWORTH PRODUCTS ENCLOSURE FAN KIT MODEL# 16146 IIS OR APPROVED EQUAL TO BE MOUNTED TO THE TOP OF THE EQUIPMENT CABINET.
- 4. ISP EQUIPMENT FOR CBP INTERNET SERVICE SHALL BE PROVIDED AND INSTALLED BY THE SERVICE PROVIDER.

T402

3' - 4 5/16"

110 BLOCK-

SECONDARY-

BONDING

18" X 2" CABLE-

LADDER 8'-6" AFF.

__2" C. FOR CBP RADIO ANTENNA CABLES

BUSBAR

BATTERY CABINET

(BY DIV 26)

(36" X 42" X 84")

UPS |

(BY DIV 26)

(24" X 42" X 84")

AIRPORT NETWORK

CBP NETWORK

(24" X 42" X 84")

CBP TACCOM

(24" X 42" X 84")

(24" X 42" X 84")

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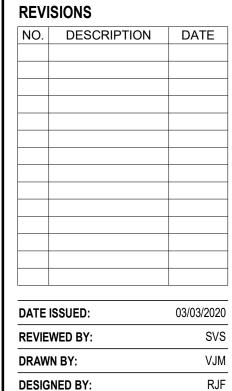
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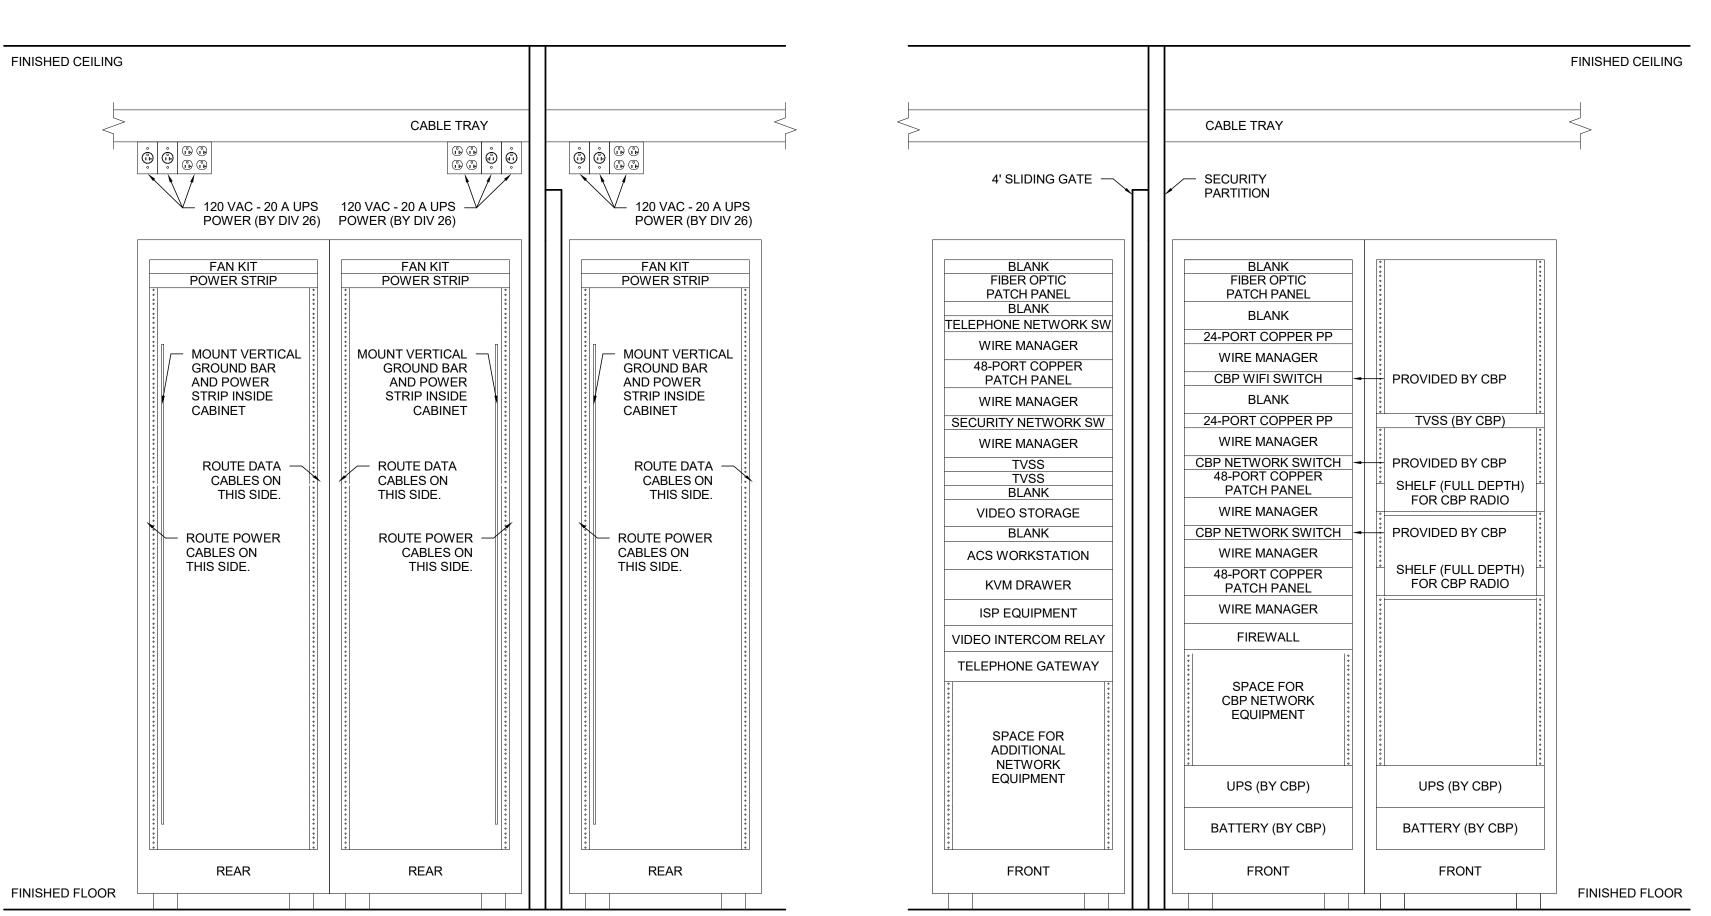
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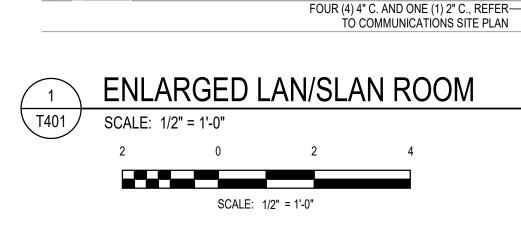
ENLARGED
TELECOM PLAN
AND DETAILS

SHEET NUMBER

T401

BID DOCUMENTS






ACS AND IDS CONTROL-


LADDER 8'-6" AFF.


112

T401

PANELS (TYP.)

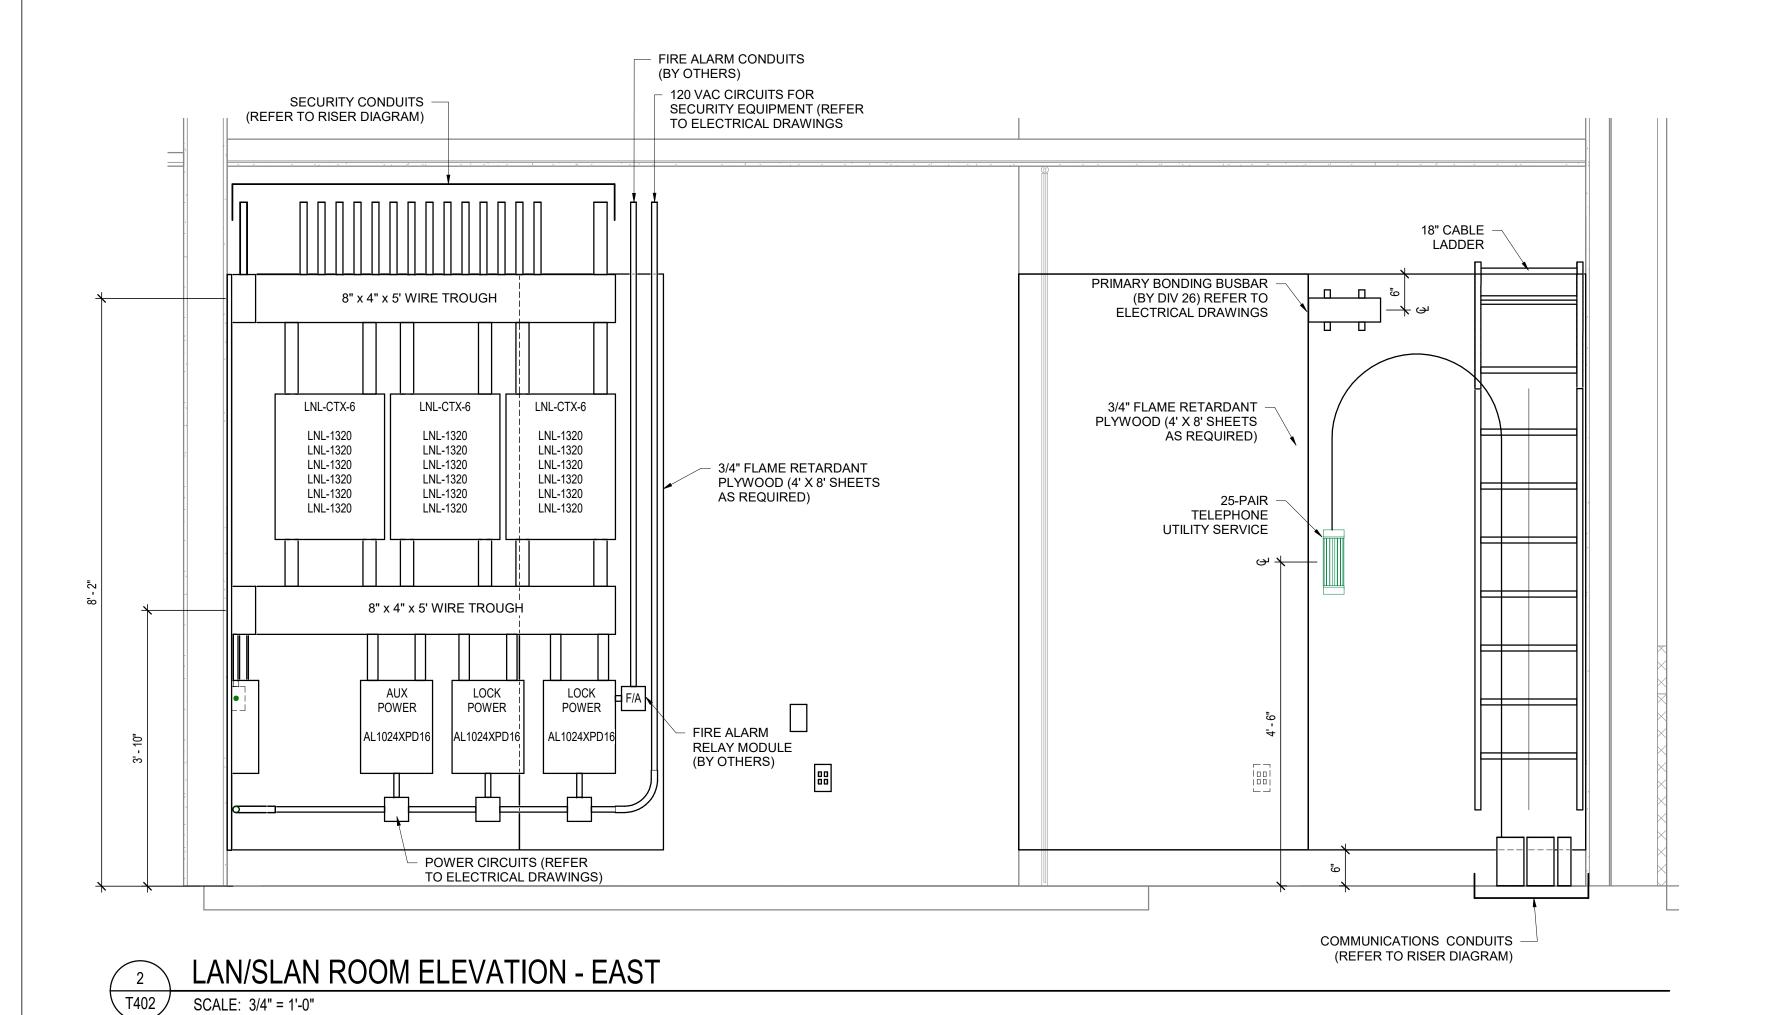

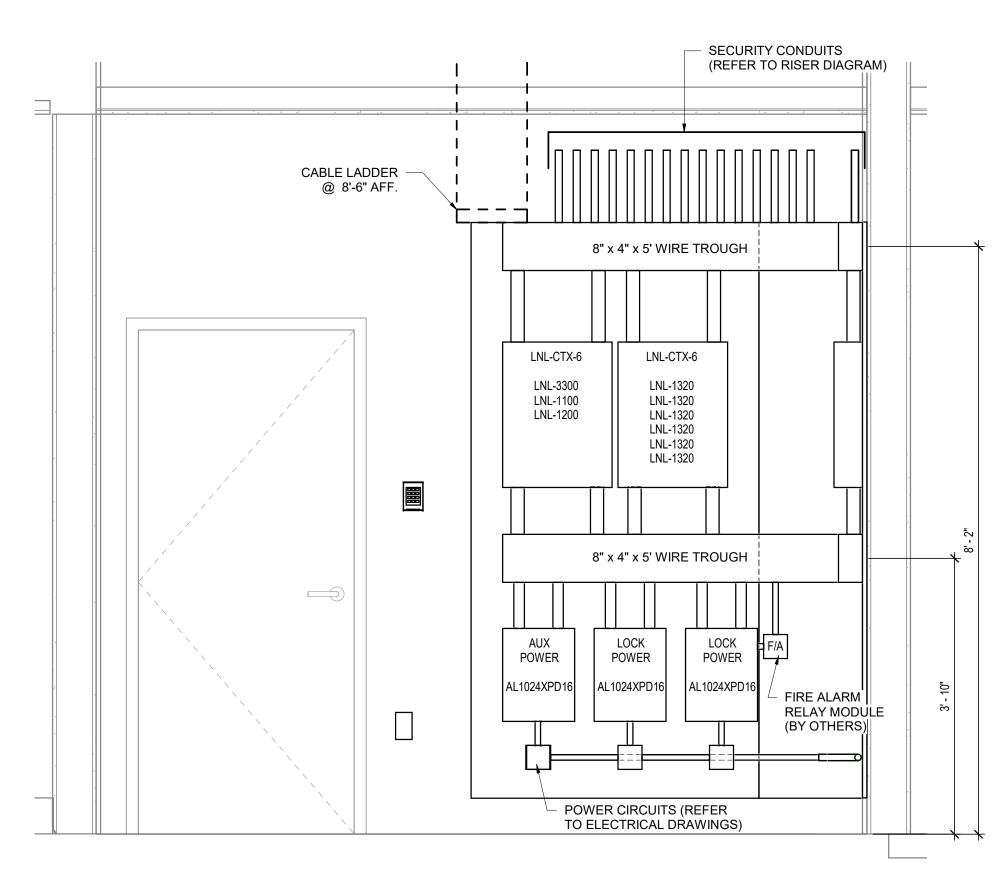

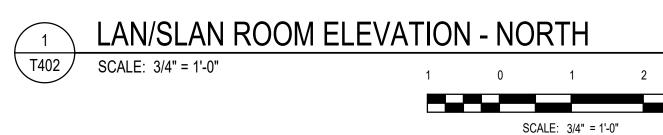



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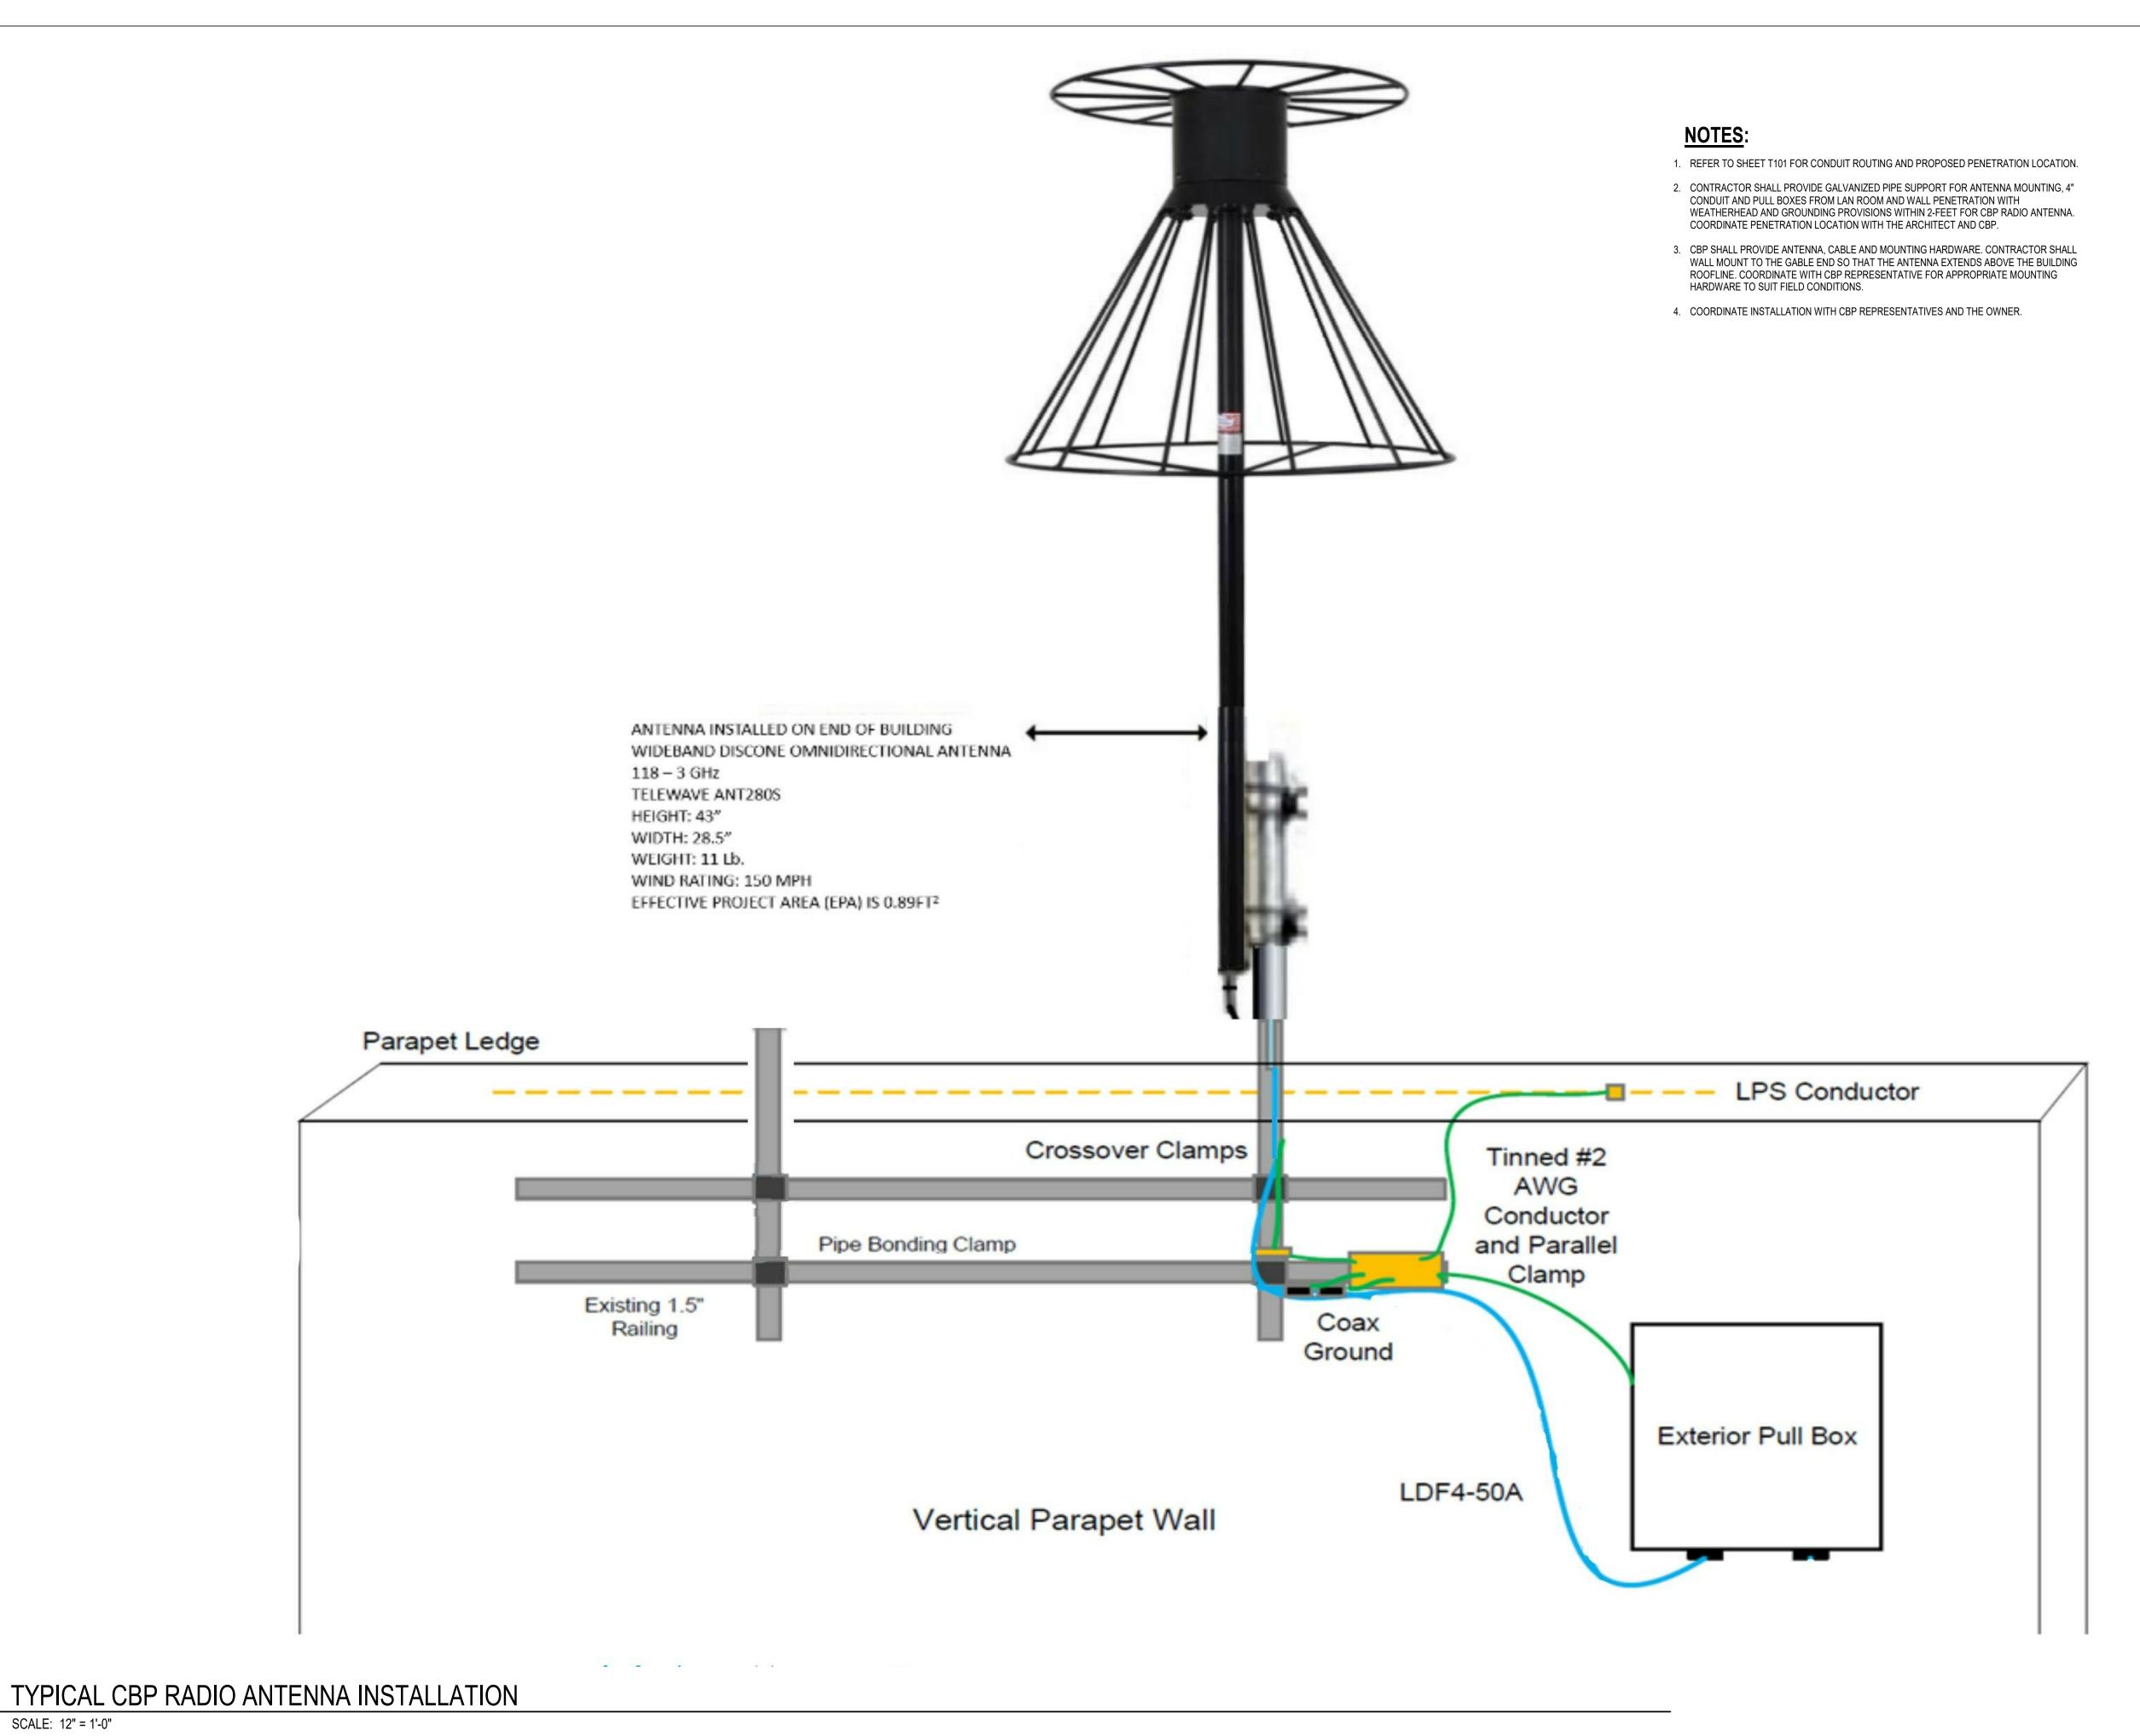
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TELECOM ELEVATIONS

SHEET NUMBER

T402





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SHEET TITLE

CBP RADIO ANTENNA INSTALLATION

SHEET NUMBER

T403

BID DOCUMENTS

SCALE: 12" = 1'-0"

T403

SUPPORT DATA CABLES ON

TO DETAIL 1 ON SHEET T503

J-HOOKS TO CABLE TRAY. REFER

- DATA CABLES (TYP)

- 1" CONDUIT (TYP)

FLUSHOUTLET

COVER

SCALE: N.T.S.

= 120 VAC BY DIVISION 26

BOX (BY DIVISION 26)

DATA OUTLET TYP MOUNTING

CONDUIT BUSHING (TYP)


1" CONDUIT (TYP)


- COMM OUTLET


FINISHED

FLOOR

SUSPENDED CEILING

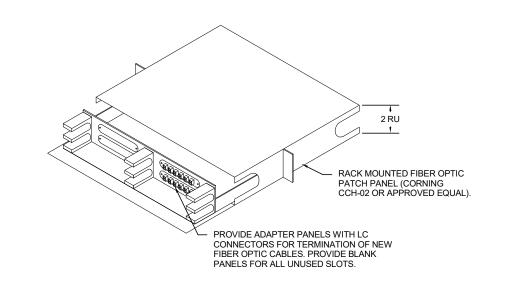

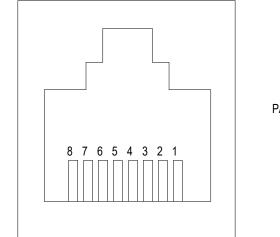


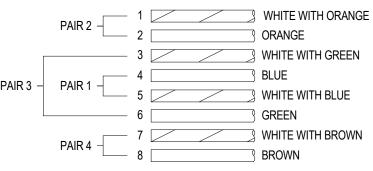


COMMUNICATIONS OUTLET WIRING

TELECOM OUTLET - T568B T501 SCALE: N.T.S.



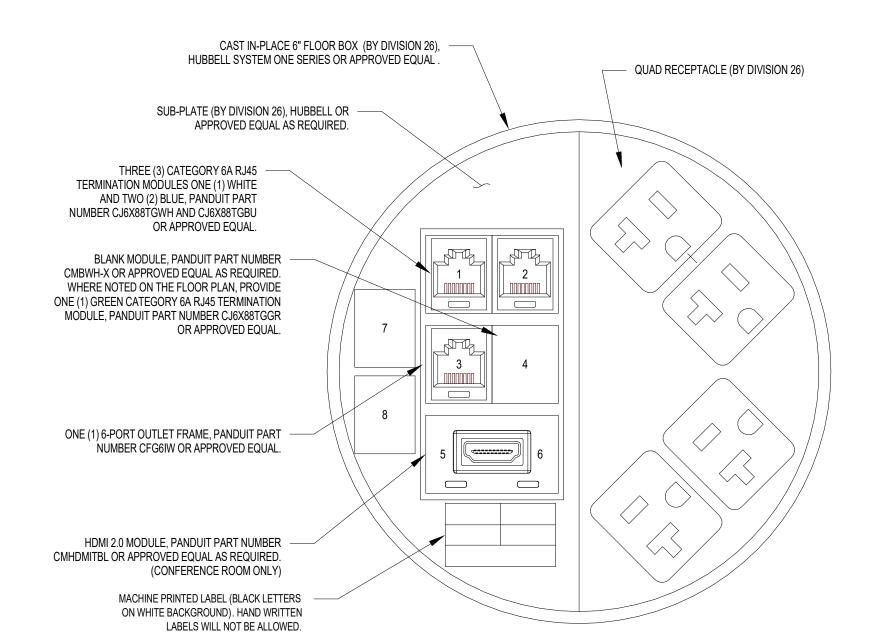

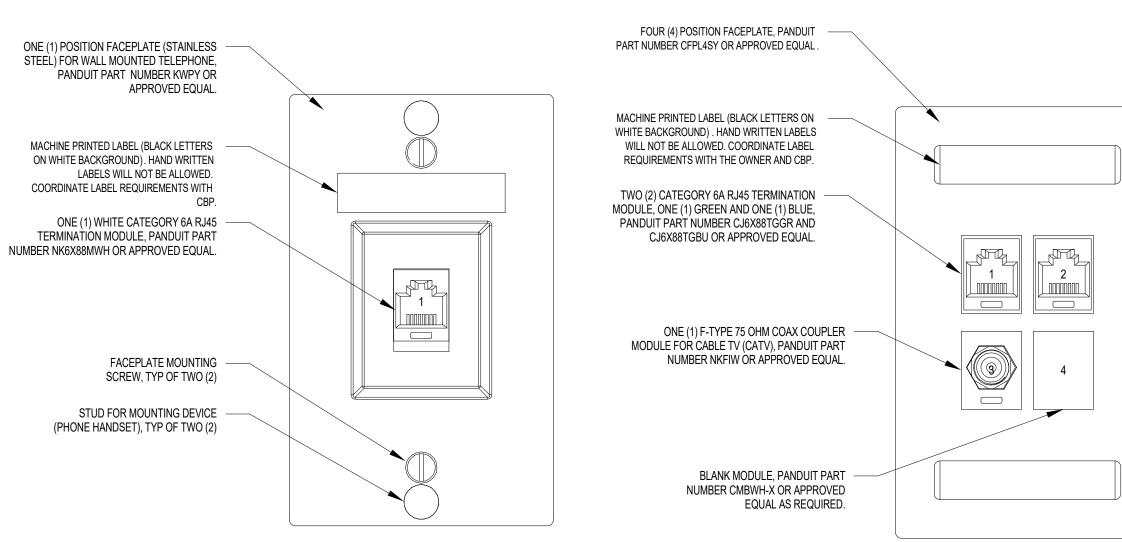




TELECOM OUTLET - FLOOR BOX


SCALE: N.T.S.


COORDINATE LABEL REQUIREMENTS WITH





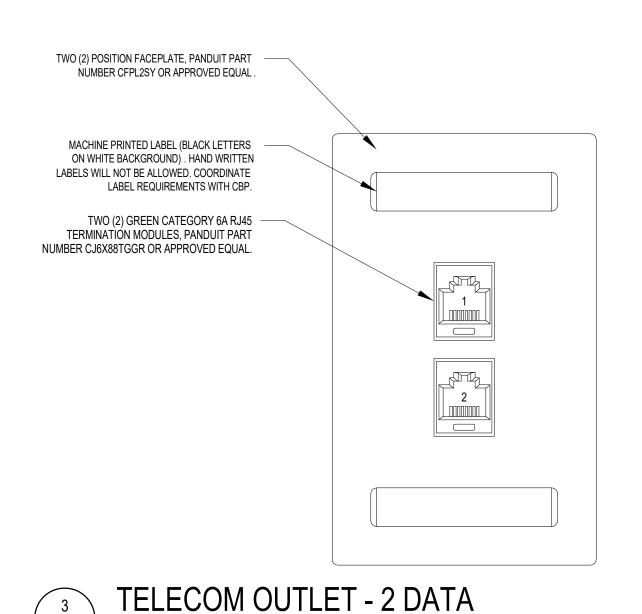

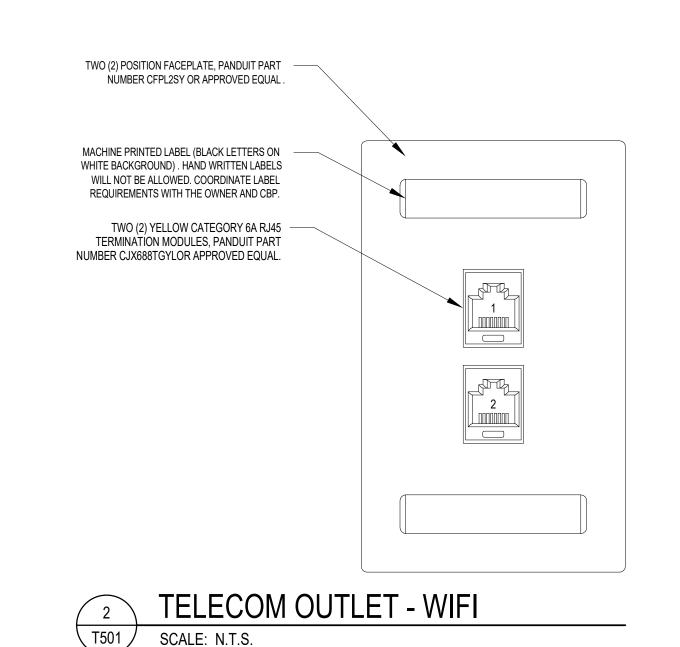

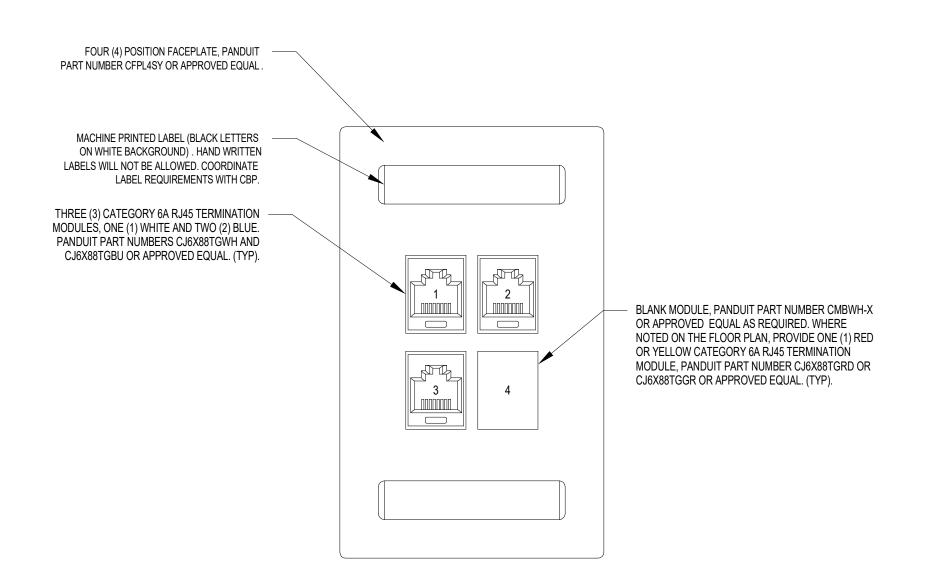

TELECOM OUTLET - CBP VOICE-DATA

SCALE: N.T.S.

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T501 /

SCALE: N.T.S.

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RJF

DESIGNED BY: PROJECT NUMBER: 201-0052-002


DRAWN BY:


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TELECOM DETAILS


SHEET NUMBER

T501




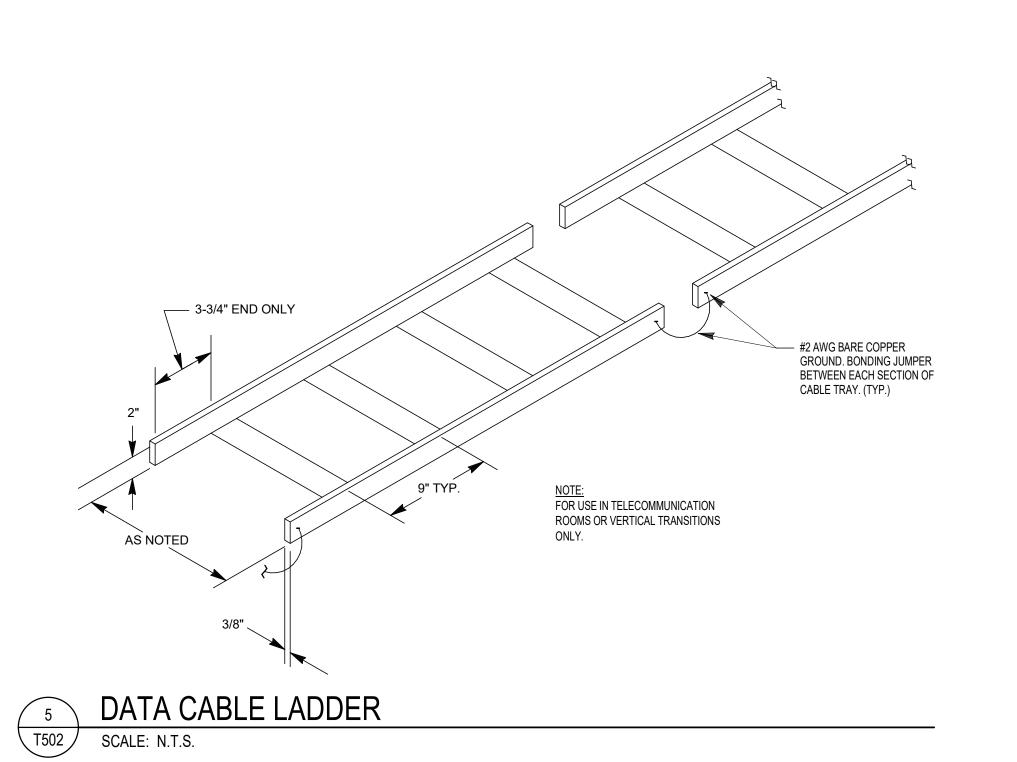

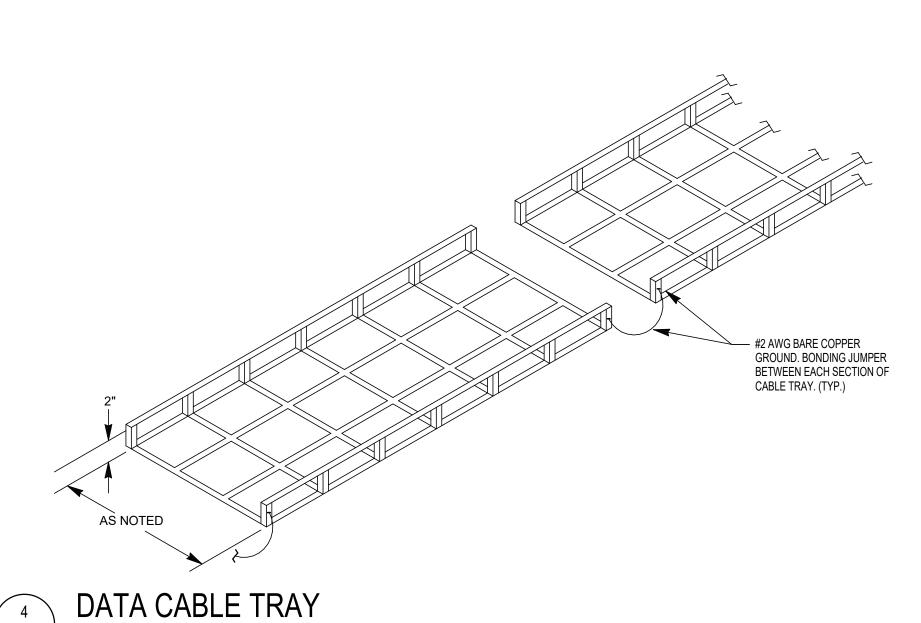SCALE: N.T.S.

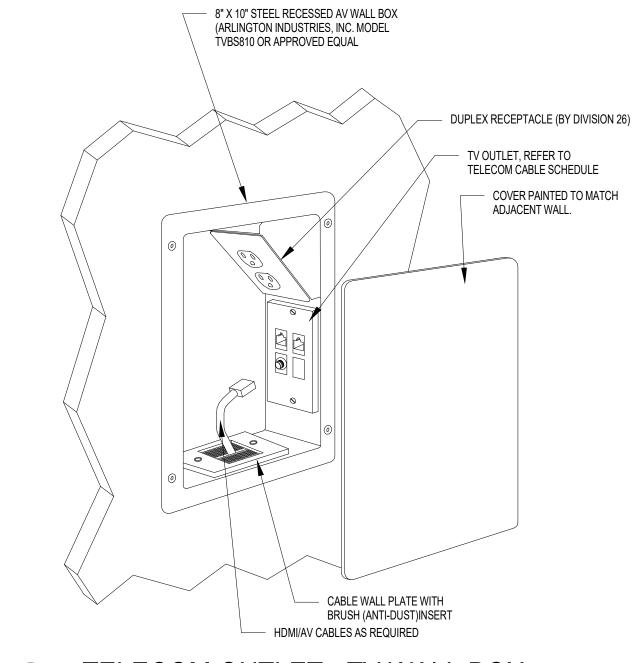


TELECOM OUTLET - TV WALL BOX T502 SCALE: N.T.S.

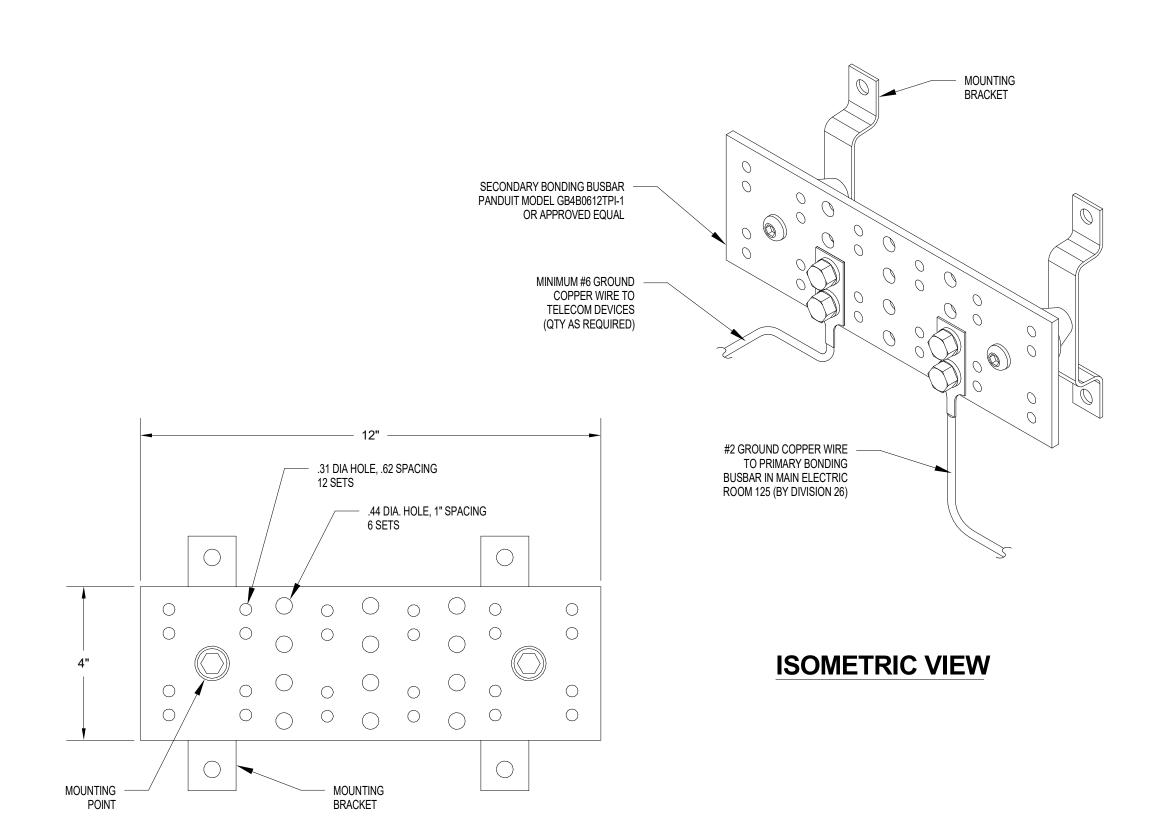

FRONT VIEW

SECONDARY BONDING BUSBAR

SCALE: N.T.S.

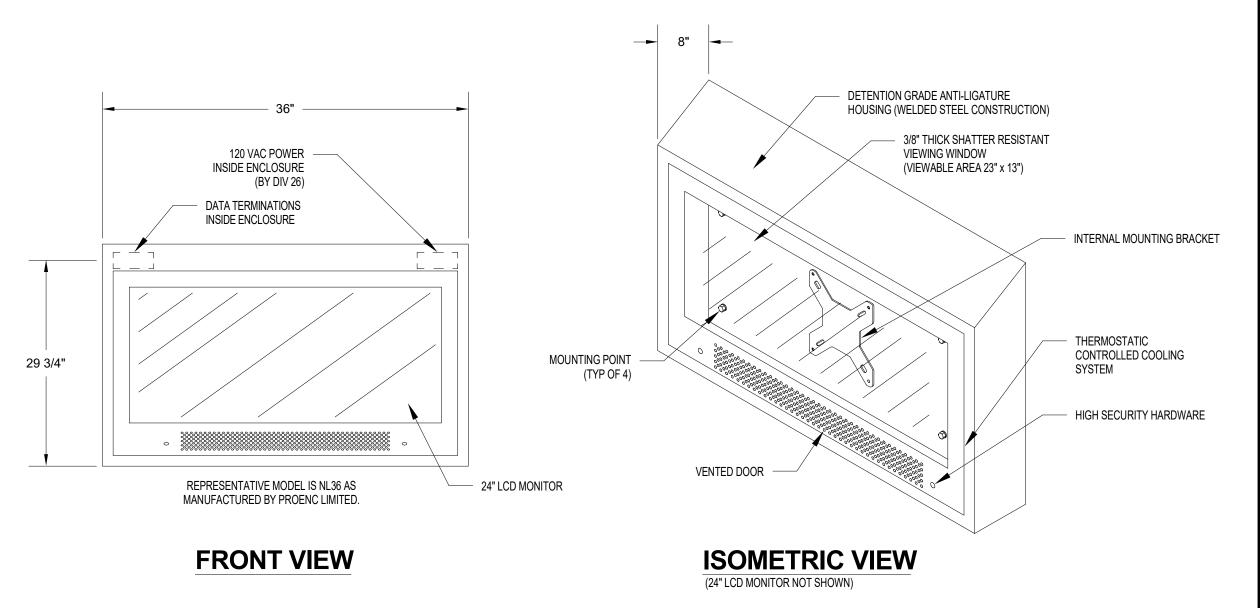

DETENTION GRADE SECURITY MONITOR ENCLOSURE SCALE: 12" = 1'-0"

10748 Deerwood Park Blvd. South Jacksonville, Florida 32256-0597 904-256-2500 Fax 904-256-2503 www.rsandh.com

FL Cert. Nos. AAC001886 * IB26000956 EB0005620 * LCC000210 * GB238



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PENSACOLA GENERAL AVIATION FACILITY (GAF)

720 Bayfront Parkway, Suite 200 Pensacola, FL 32502 T 850.432.0706 F 850.433.0508 G M C N E T W O R K . C O M

PROFESSIONAL SEAL



REVISIONS DATE ISSUED: REVIEWED BY: DRAWN BY:

RJF **DESIGNED BY:** PROJECT NUMBER:


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SHEET TITLE

TELECOM DETAILS

SHEET NUMBER

T502

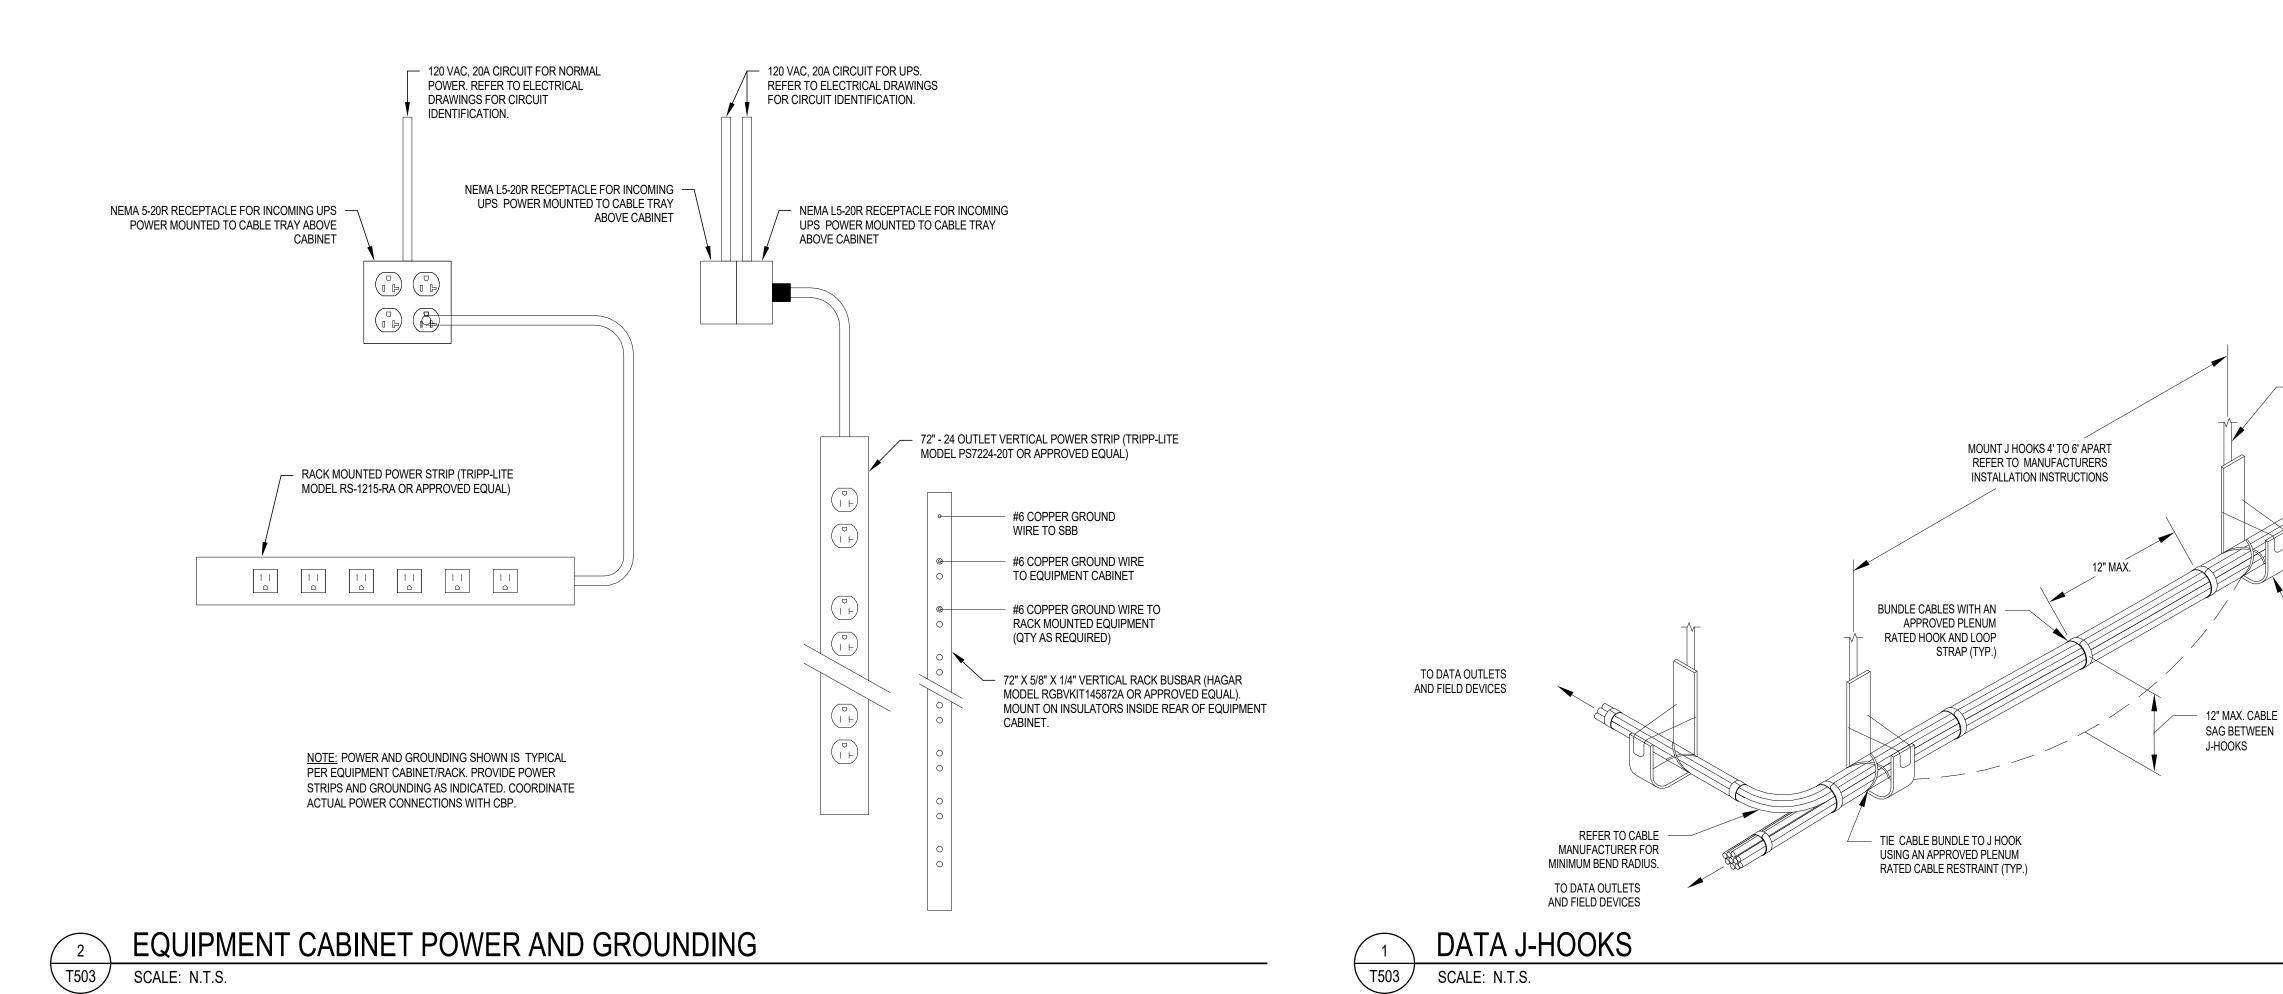

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PENSACOLA, FLORIDA

PENSACOLA
GENERAL
AVIATION
FACILITY (GAF)



PROFESSIONAL SEAL



NO.	DESCRIPTION	DATE
DATE IS	SSUED:	03/03/202
REVIEV	VED BY:	SVS
DRAWN	I BY:	VJN
DESIGN	IED BY:	RJI
PROJF(CT NUMBER:	

REVISIONS

- WIRE ROD SUPPORT.
MOUNT J-HOOKS
ACCORDING TO FIELD
CONDITIONS (TYP.)

2" J-HOOK CABLE SUPPORT

MINIMUM, SIZE AS REQUIRED.

PROJECT NUMBER: 201-0052-002
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SHEET TITLE

TELECOM DETAILS

SHEET NUMBER

T503

- OUTLET NUMBERS LISTED HEREIN ARE FOR CONTRACTOR REFERENCE AND INDICATE OUTLET DESIGNATION BY ROOM NUMBER AND OUTLET ID AS SHOWN ON THE COMMUNICATIONS FLOOR PLAN.
- 2. UNLESS OTHERWISE NOTED, CABLES SHALL BE ROUTED FROM THE WALL OUTLET IN 1" DROP CONDUIT TO THE NEAREST BRANCH OF THE
- COMMUNICATIONS CABLE TRAY.

 3. FINAL SCHEME TO BE USED FOR LABELING OUTLETS, CABLES AND PATCH PANELS SHALL BE IN COORDINATION WITH THE OWNER AND CBP.
- PATCH PANELS SHALL BE IN COORDINATION WITH THE OWNER AND CBP.

 4. REFER TO OUTLET DETAILS ON SHEET T501 FOR FACEPLATE AND TERMINATION MODULE REQUIREMENTS. FINAL CONFIGURATIONS SHALL BE REVIEWED AND APPROVED BY THE OWNER AND CBP PRIOR TO INSTALLATION.

PENSACOLA International Airpor

10748 Deerwood Park Blvd. South

Jacksonville, Florida 32256-0597

904-256-2500 Fax 904-256-2503

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INTERNATIONAL AIRPORT

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F 850.432.0508
G M C N E T W O R K . C O M

PROFESSIONAL SEAL

NOTFORTION CONSTRUCTION

NO.	DESCRIPTION	DATE
140.	DEGOINI HON	DAIL
		·
DATE IS	SSUED:	03/03/202

REVISIONS

DATE ISSUED:	03/03/2020
REVIEWED BY:	SVS
DRAWN BY:	VJM
DESIGNED BY:	RJF
PROJECT NUMBER:	

NUMBER: 201-0052-002 © 2020 RS&H, INC.

SHEET TITLE

TELECOM CABLE SCHEDULE

SHEET NUMBER

T601

BID DOCUMENTS

										LET CABLE SCHEDULE		
ROOM IUMBER	MARK NUMBER	OUTLET NUMBER	MODULE TYPE	MODULE COLOR	DATA TYPE	OUTLET DETAIL	CABLE TYPE	CABLE COLOR	COMM ROOM	TERMINATION LOCATION	PATCH PANEL LABEL	NOTES
		1	D.145	BLUE	DATA		0.17.04	BLUE			100.TV.1	MALL MOUNT OUT ET 2011 AFE 201 COATE
400		2	RJ45	GREEN	DATA		CAT 6A	GREEN	112	CBP DATA PATCH PANEL	100.TV.2	WALL MOUNT OUTLET 66" AFF COLOCATE WITH POWER IN RECESSED 8X10 BOX, REF
100	TV	3	F	-	CATV	4	RG6/U	BLACK			100.TV.3	TO DETAIL X ON SHEET T501. COORDINATE
		4	BLANK	-	-		-	-	-	-	BLANK	
		1		WHITE	DATA			WHITE			103.A.1	
		2	RJ45	BLUE	DATA		CAT 6A	BLUE	112	CBP DATA PATCH PANEL	103.A.2	
		3		GREEN	DATA DATA			GREEN			103.A.3 103.A.4	FLUSH MOUNT FLOOR OUTLET COLOCAT
103	Α	5	BLANK	-	-	6	-	-	-	-	BLANK	WITH POWER RECEPTACLE, COORDINATE WITH DIVISION 26.
		6	BLANK	-	-		-	-	-	-	BLANK	WITH DIVISION 20.
		7 8	BLANK BLANK	-	-		-	-	-	-	BLANK BLANK	
		1	DLAINK	WHITE	DATA		-	WHITE	-	<u>-</u>	103.B.1	
		2	RJ45	BLUE	DATA		CAT 6A	BLUE	112	CBP DATA PATCH PANEL	103.B.2	
		3	11040		DATA		OATOA		112	ODI DATATATOTTI ANLL	103.B.3	FLUSH MOUNT FLOOR OUTLET COLOCAT
103	В	4 5	BLANK	GREEN	DATA -	6	_	GREEN	_	_	103.B.4 BLANK	\dashv WITH POWER RECEPTACLE, COORDINATE
		6	BLANK	-	-		-	-	-	-	BLANK	WITH DIVISION 26.
		7	BLANK	-	-		-	-	-	-	BLANK	
		8	BLANK	- WHITE	- DATA		-	- WHITE	-	-	BLANK 103.C.1	
		2	RJ45		DATA		CAT 6A		112	CBP DATA PATCH PANEL	103.C.1	
		3	11010	BLUE	DATA		0,11 0,1	BLUE			103.C.3	FILLIOU MOUNT FILOOD OUT FT COLOOD
103	С	4	BLANK	-	-	6	-	-	-	-	BLANK	FLUSH MOUNT FLOOR OUTLET COLOCA WITH POWER RECEPTACLE, COORDINATE
100		5	BLANK	-	-	v	-	-	-	-	BLANK	WITH DIVISION 26.
		6 7	BLANK BLANK	-	-		-	-	-	-	BLANK BLANK	
		8	BLANK	-	-		-	-	-	-	BLANK	
		1		WHITE	DATA			WHITE			103.D.1	WALL MOUNT OUTLET COLOCATED WITH
103	D	3	RJ45	BLUE	DATA DATA	1	CAT 6A	BLUE	112	CBP DATA PATCH PANEL	103.D.2 103.D.3	POWER RECEPTACLE, COORDINATE WITH
		4	BLANK	_	DATA -		_	-	-	-	BLANK	DIVISION 26.
		1		WHITE	DATA			WHITE			104.A.1	WALL MOUNT OUT ET 40% AFE OOL OOAT
104	Α	2	RJ45	BLUE	DATA	1	CAT 6A	BLUE	112	CBP DATA PATCH PANEL	104.A.2	WALL MOUNT OUTLET 42" AFF COLOCATION WITH POWER RECEPTACLE, COORDINATE
		3	BLANK	_	DATA		_	_	_		104.A.3 BLANK	WITH DIVISION 26.
		1	DLAINIX	WHITE	DATA		-	WHITE		-	104.B.1	
104	В	2	RJ45	BLUE	DATA	1	CAT 6A	BLUE	112	CBP DATA PATCH PANEL	104.B.2	WALL MOUNT OUTLET 42" AFF COLOCATION WITH POWER RECEPTACLE, COORDINATE
104		3	DI ANII		DATA	ı					104.B.3	WITH POWER RECEPTACLE, COORDINATE WITH DIVISION 26.
		4	BLANK	-	-		-	-	-	-	BLANK	
		1			DATA						105.A.1	MOUNT OUTLET INSIDE DETENTION GRA
105	Α		RJ45	GREEN		3	CAT 6A	GREEN	112	SECURITY PATCH PANEL		MONITOR ENCLOSURE COLOCATED WITH
		0		0.12.1	DATA	·		0.1211			105.A.2	POWER RECEPTACLE, REFER TO DETAIL 3 SHEET T501. COORDINATE WITH DIVISION
		2			DATA						105.A.2	
		1		WHITE	DATA			WHITE			106.A.1	WALL MOUNT OUT ET OOL OOATED WITH
106	Α	2	RJ45	BLUE	DATA	1	CAT 6A	BLUE	112	CBP DATA PATCH PANEL	106.A.2	WALL MOUNT OUTLET COLOCATED WITH POWER RECEPTACLE, COORDINATE WITH
		3	BLANK		DATA		_		_		106.A.3 BLANK	DIVISION 26.
		1	DLAINK	WHITE	DATA		-	WHITE	-	<u>-</u>	110.A.1	
110	A	2	RJ45	BLUE	DATA	1	CAT 6A	BLUE	112	CBP DATA PATCH PANEL	110.A.2	WALL MOUNT OUTLET COLOCATED WITH POWER RECEPTACLE, COORDINATE WITH
110	A	3	NJ45		DATA	ı	CATOA		112		110.A.3	DIVISION 26.
		4		RED WHITE	DATA DATA			RED WHITE		CBP RADIO PATCH PANEL	110.A.4 110.B.1	
	_	2	RJ45		DATA		CAT 6A		112	CBP DATA PATCH PANEL	110.B.1	WALL MOUNT OUTLET COLOCATED WITH
110	В	3		BLUE	DATA	1		BLUE			110.B.3	POWER RECEPTACLE, COORDINATE WITH DIVISION 26.
		4	BLANK	140	-		-	-	-	-	BLANK	
		1 2	RJ45	WHITE	DATA DATA		CAT 6A	WHITE	112	CBP DATA PATCH PANEL	111.A.1 111.A.2	WALL MOUNT OUTLET COLOCATED WITH
	Α	3	11040	BLUE	DATA	1	UAT UA	BLUE	114	ODI DATATATOTIFANEL	111.A.3	POWER RECEPTACLE, COORDINATE WITH DIVISION 26.
111	^	4	BLANK	-	-		-	-	-	-	BLANK	DIVIDION ZU.
111	A			WHITE	DATA		0.17	WHITE	440	ODD D474 D4701	112.A.1	WALL MOUNT OUTLET COLOCATED WITH
111	^	1					CAT 6A	BLUE	112	CBP DATA PATCH PANEL	112.A.2 112.A.3	\dashv POWER RECEPTACLE, COORDINATE WITH
111	A	2	RJ45	BLUE	DATA	1			ı		BLANK	DIVISION 26.
		•	RJ45 BLANK	BLUE -	DATA DATA	1	-	-	-	-	DECINIT	+
		2 3 4 1	BLANK		DATA - DATA	1	-				112.B.1	WALL MOUNT OUT ET COLOCATED WIT
112		2 3 4 1 2		-	DATA - DATA DATA	1		-	112	CBP DATA PATCH PANEL	112.B.1 112.B.2	POWER RECEPTACLE, COORDINATE WITH
112	A	2 3 4 1 2 3	BLANK RJ45	- WHITE	DATA - DATA	1	- CAT 6A	- WHITE	112	CBP DATA PATCH PANEL	112.B.1 112.B.2 112.B.3	
112	A	2 3 4 1 2	BLANK	- WHITE	DATA - DATA DATA	1	-	- WHITE			112.B.1 112.B.2 112.B.3 BLANK	POWER RECEPTACLE, COORDINATE WITH DIVISION 26.
112	В	2 3 4 1 2 3 4 1 2	BLANK RJ45	- WHITE BLUE - WHITE	DATA - DATA DATA DATA - DATA - DATA DATA	1	- CAT 6A	- WHITE BLUE - WHITE	112	CBP DATA PATCH PANEL	112.B.1 112.B.2 112.B.3 BLANK 112.C.1 112.C.2	POWER RECEPTACLE, COORDINATE WITH DIVISION 26. WALL MOUNT OUTLET COLOCATED WITH
112	A	2 3 4 1 2 3 4 1 2 3	BLANK RJ45 BLANK RJ45	- WHITE BLUE - WHITE BLUE	DATA - DATA DATA DATA - DATA DATA DATA D	1 1	- CAT 6A	- WHITE BLUE - WHITE BLUE	112 - 112	CBP DATA PATCH PANEL - CBP DATA PATCH PANEL	112.B.1 112.B.2 112.B.3 BLANK 112.C.1 112.C.2 112.C.3	POWER RECEPTACLE, COORDINATE WITH DIVISION 26. WALL MOUNT OUTLET COLOCATED WITH
112	В	2 3 4 1 2 3 4 1 2 3 4	BLANK RJ45 BLANK	- WHITE BLUE - WHITE BLUE	DATA - DATA DATA DATA - DATA DATA DATA D	1 1	- CAT 6A	- WHITE BLUE - WHITE BLUE	112	CBP DATA PATCH PANEL	112.B.1 112.B.2 112.B.3 BLANK 112.C.1 112.C.2 112.C.3 BLANK	POWER RECEPTACLE, COORDINATE WITH DIVISION 26. WALL MOUNT OUTLET COLOCATED WITH POWER RECEPTACLE, COORDINATE WITH
112	A B	2 3 4 1 2 3 4 1 2 3 4	BLANK RJ45 BLANK RJ45 BLANK	- WHITE BLUE - WHITE BLUE - WHITE WHITE	DATA - DATA DATA DATA - DATA DATA DATA	1 1	CAT 6A CAT 6A	- WHITE BLUE - WHITE BLUE - WHITE	112 - 112 -	CBP DATA PATCH PANEL - CBP DATA PATCH PANEL -	112.B.1 112.B.2 112.B.3 BLANK 112.C.1 112.C.2 112.C.3 BLANK 112.D.1	POWER RECEPTACLE, COORDINATE WITH DIVISION 26. WALL MOUNT OUTLET COLOCATED WITH POWER RECEPTACLE, COORDINATE WITH DIVISION 26. WALL MOUNT OUTLET COLOCATED WITH
112	В	2 3 4 1 2 3 4 1 2 3 4	BLANK RJ45 BLANK RJ45	- WHITE BLUE - WHITE BLUE	DATA - DATA DATA DATA - DATA DATA DATA D	1 1 1	- CAT 6A	- WHITE BLUE - WHITE BLUE	112 - 112	CBP DATA PATCH PANEL - CBP DATA PATCH PANEL	112.B.1 112.B.2 112.B.3 BLANK 112.C.1 112.C.2 112.C.3 BLANK	POWER RECEPTACLE, COORDINATE WITH DIVISION 26. WALL MOUNT OUTLET COLOCATED WITH DIVISION 26. WALL MOUNT OUTLET COLOCATED WITH POWER RECEPTACLE, COORDINATE WITH POWER RECEPTACLE, COORDINATE WITH POWER RECEPTACLE, COORDINATE WITH
112	A B	2 3 4 1 2 3 4 1 2 3 4 1 2	BLANK RJ45 BLANK RJ45 BLANK	- WHITE BLUE - WHITE BLUE - WHITE BLUE - WHITE BLUE	DATA - DATA DATA DATA - DATA DATA DATA D	1 1	CAT 6A CAT 6A	- WHITE BLUE - WHITE BLUE - WHITE BLUE - BLUE	112 - 112 -	CBP DATA PATCH PANEL - CBP DATA PATCH PANEL -	112.B.1 112.B.2 112.B.3 BLANK 112.C.1 112.C.2 112.C.3 BLANK 112.D.1 112.D.2 112.D.3 BLANK	POWER RECEPTACLE, COORDINATE WITH DIVISION 26. WALL MOUNT OUTLET COLOCATED WITH POWER RECEPTACLE, COORDINATE WITH DIVISION 26. WALL MOUNT OUTLET COLOCATED WITH
112	A B	2 3 4 1 2 3 4 1 2 3 4 1 2 3 4 1 2 3 4 1	BLANK RJ45 BLANK RJ45 BLANK RJ45 BLANK	- WHITE BLUE - WHITE BLUE - WHITE BLUE BLUE	DATA DATA	1 1	CAT 6A CAT 6A CAT 6A CAT 6A	- WHITE BLUE - WHITE BLUE - WHITE	112 - 112 - 112	CBP DATA PATCH PANEL - CBP DATA PATCH PANEL - CBP DATA PATCH PANEL	112.B.1 112.B.2 112.B.3 BLANK 112.C.1 112.C.2 112.C.3 BLANK 112.D.1 112.D.2 112.D.3 BLANK 112.E.1	POWER RECEPTACLE, COORDINATE WITH DIVISION 26. WALL MOUNT OUTLET COLOCATED WITH DIVISION 26. WALL MOUNT OUTLET COLOCATED WITH POWER RECEPTACLE, COORDINATE WITH DIVISION 26. WALL MOUNT OUTLET COLOCATED WITH DIVISION 26.
112	A B	2 3 4 1 2 3 4 1 2 3 4 1 2 3 4 1 2 3 4 1 2	BLANK RJ45 BLANK RJ45 BLANK RJ45	- WHITE BLUE - WHITE BLUE - WHITE BLUE - WHITE BLUE	DATA - DATA DATA - DATA - DATA DATA DATA	1 1 1	CAT 6A CAT 6A CAT 6A	- WHITE BLUE - WHITE BLUE - WHITE BLUE - BLUE	112 - 112 - 112	CBP DATA PATCH PANEL - CBP DATA PATCH PANEL - CBP DATA PATCH PANEL	112.B.1 112.B.2 112.B.3 BLANK 112.C.1 112.C.2 112.C.3 BLANK 112.D.1 112.D.2 112.D.3 BLANK 112.E.1 112.E.1	POWER RECEPTACLE, COORDINATE WITH DIVISION 26. WALL MOUNT OUTLET COLOCATED WITH POWER RECEPTACLE, COORDINATE WITH DIVISION 26. WALL MOUNT OUTLET COLOCATED WITH POWER RECEPTACLE, COORDINATE WITH DIVISION 26. WALL MOUNT OUTLET COLOCATED WITH POWER RECEPTACLE, COORDINATE WITH POWER RECEPTACLE, COORDINATE WITH
112 112 112	A B C	2 3 4 1 2 3 4 1 2 3 4 1 2 3 4 1 2 3 4 1	BLANK RJ45 BLANK RJ45 BLANK RJ45 BLANK	- WHITE BLUE - WHITE BLUE - WHITE BLUE - WHITE BLUE - WHITE	DATA DATA	1 1 1	CAT 6A CAT 6A CAT 6A CAT 6A	- WHITE BLUE - WHITE BLUE - WHITE BLUE - WHITE BLUE - WHITE	112 - 112 - 112	CBP DATA PATCH PANEL - CBP DATA PATCH PANEL - CBP DATA PATCH PANEL	112.B.1 112.B.2 112.B.3 BLANK 112.C.1 112.C.2 112.C.3 BLANK 112.D.1 112.D.2 112.D.3 BLANK 112.E.1	WALL MOUNT OUTLET COLOCATED WITH POWER RECEPTACLE, COORDINATE WITH DIVISION 26. WALL MOUNT OUTLET COLOCATED WITH POWER RECEPTACLE, COORDINATE WITH

ROOM NUMBER												
TOMBLIT	MARK NUMBER	OUTLET NUMBER	MODULE TYPE	MODULE COLOR	DATA TYPE	OUTLET DETAIL	CABLE TYPE	CABLE COLOR	COMM ROOM	TERMINATION LOCATION	PATCH PANEL LABEL	NOTES
	. 10 110 11	1		WHITE	DATA	2=1/\l		WHITE	1 (OOIVI		113.A.1	
		1		WHILE				WHILE				WALL MOUNT OUTLET COLOCATED WITH
113	Α	2	RJ45	BLUE	DATA	1	CAT 6A	BLUE	112	CBP DATA PATCH PANEL	113.A.2	POWER RECEPTACLE, COORDINATE WITH
		3			DATA						113.A.3	DIVISION 26.
		4		GREEN	DATA			GREEN			113.A.4	
		1		WHITE	DATA			WHITE			113.B.1	
440	_	2	5.45	5	DATA		0.7.0.	5	140	CBP DATA PATCH PANEL	113.B.2	WALL MOUNT OUTLET COLOCATED WITH
113	В	3	RJ45	BLUE	DATA	1	CAT 6A	BLUE	112		113.B.3	POWER RECEPTACLE, COORDINATE WITH
		4		RED	DATA			RED		CBP RADIO PATCH PANEL	113.B.4	DIVISION 26.
		4		WHITE	DATA			WHITE		CBI NADIOTATOTTANLE		
		1	5.45	WHILE			0.7.0.	WHILE		ODD DATA DATOU DANE!	115.A.1	WALL MOUNT OUTLET COLOCATED WITH
115	Α	2	RJ45	BLUE	DATA	1	CAT 6A	BLUE	112	CBP DATA PATCH PANEL	115.A.2	POWER RECEPTACLE, COORDINATE WITH
		3			DATA						115.A.3	DIVISION 26.
		4	BLANK	-	-		-	-	-	-	BLANK	
		1		WHITE	DATA			WHITE			116.A.1	
440		2	RJ45	5	DATA		CAT 6A	5	112	CBP DATA PATCH PANEL	116.A.2	WALL MOUNT OUTLET COLOCATED WITH
116	Α	3		BLUE	DATA	1		BLUE			116.A.3	POWER RECEPTACLE, COORDINATE WITH
		4	BLANK	_			_		_	-	BLANK	DIVISION 26.
		1	DEATH	WHITE	DATA		_	WHITE	_		116.B.1	
		0		VVIIII				VVIIIIL		CDD DATA DATOU DANIEL		WALL MOUNT OUTLET COLOCATED WITH
116	В	2	RJ45	BLUE	DATA	1	CAT 6A	BLUE	112	CBP DATA PATCH PANEL	116.B.2	POWER RECEPTACLE, COORDINATE WITH
		3	_		DATA						116.B.3	DIVISION 26.
		4		RED	DATA			RED		CBP RADIO PATCH PANEL	116.B.4	
		1		WHITE	DATA			WHITE			116.C.1	
		2	RJ45	D	DATA		CAT 6A	DITT	112	CBP DATA PATCH PANEL	116.C.2	
		3	_	BLUE	DATA			BLUE			116.C.3	1
		4	BLANK	_			_		_	_	BLANK	FLUSH MOUNT FLOOR OUTLET COLOCATE
116	С	5	אוווווים		ALIDIO/	6	-	-	-		DL/ IIII	WITH POWER RECEPTACLE, COORDINATE
			HDMI 2.0	BLACK	AUDIO/ VIDEO		HDMI 2.0	BLACK	116.D	TV WALL BOX	HDMI 2.0	WITH DIVISION 26.
		6			VIDEO							-
		7	BLANK	-	-		-	-	-	-	BLANK	
		8	BLANK	-	-			<u>-</u>		-	BLANK	
		1		WHITE	DATA			WHITE			116.D.1	
		2	RJ45		DATA		CAT 6A		112	CBP DATA PATCH PANEL	116.D.2	1
		3	1.5.1.5	BLUE	DATA		· · · · · · · ·	BLUE			116.D.3	1
		4	BLANK		אורוע					_	BLANK	FLUSH MOUNT FLOOR OUTLET COLOCATE
116	D		DLAINN	-	-	6	-	-	-	-	DLAINN	WITH POWER RECEPTACLE, COORDINATE
		5	HDMI 2.0	BLACK	AUDIO/		HDMI 2.0	BLACK	116.D	TV WALL BOX	HDMI 2.0	WITH DIVISION 26.
		6			VIDEO				-	- '		_
		7	BLANK	-	-		-	-	-	-	BLANK	
		8	BLANK	-	-		-	-	-	-	BLANK	
		1		BLUE	DATA			BLUE			116.TV.1	
		•	RJ45				CAT 6A		4.40	ODD DATA DATE:		WALL MOUNT OUTLET 66" AFF COLOCATED
116	TV	2		GREEN	DATA	₁		GREEN	112	CBP DATA PATCH PANEL	116.TV.2	WITH POWER IN RECESSED 8X10 BOX, REF
110	1 V	3	F	_	CATV	4	RG6/U	BLACK			116.TV.3	TO DETAIL X ON SHEET T501. COORDINATE
					O, 11 1						110.11.0	THE DIVIDION OF
		Л	DI ANII/									WITH DIVISION 26.
447	147	4	BLANK	-	-	-	-	-	-	- ODD DATA DATOU DANIEL	BLANK	
117	W	1	RJ45	WHITE	- DATA	5	- CAT 6A	- BLUE	112	CBP DATA PATCH PANEL	BLANK 117.W.1	WALL MOUNT OUTLET 54" AFF.
117 119	W W	4 1 1		WHITE WHITE	DATA DATA	5 5	-	- BLUE BLUE			BLANK 117.W.1 119.W.1	
		4 1 1	RJ45 RJ45	WHITE	- DATA	-	- CAT 6A CAT 6A	- BLUE	112	CBP DATA PATCH PANEL	BLANK 117.W.1	WALL MOUNT OUTLET 54" AFF. WALL MOUNT OUTLET 54" AFF.
119		1 1	RJ45	WHITE WHITE BLUE	DATA DATA DATA	-	- CAT 6A	BLUE BLUE BLUE	112 112	CBP DATA PATCH PANEL CBP DATA PATCH PANEL	BLANK 117.W.1 119.W.1 121.TV.1	WALL MOUNT OUTLET 54" AFF. WALL MOUNT OUTLET 54" AFF. WALL MOUNT OUTLET 66" AFF COLOCATED
119		1 1 1 2	RJ45 RJ45 RJ45	WHITE WHITE BLUE GREEN	DATA DATA DATA DATA DATA	-	CAT 6A CAT 6A CAT 6A	BLUE BLUE BLUE GREEN	112	CBP DATA PATCH PANEL	BLANK 117.W.1 119.W.1 121.TV.1 121.TV.2	WALL MOUNT OUTLET 54" AFF. WALL MOUNT OUTLET 54" AFF. WALL MOUNT OUTLET 66" AFF COLOCATED WITH POWER IN RECESSED 8X10 BOX, REFE
119	W	1 1	RJ45 RJ45	WHITE WHITE BLUE	DATA DATA DATA	5	- CAT 6A CAT 6A	BLUE BLUE BLUE	112 112	CBP DATA PATCH PANEL CBP DATA PATCH PANEL	BLANK 117.W.1 119.W.1 121.TV.1	WALL MOUNT OUTLET 54" AFF. WALL MOUNT OUTLET 54" AFF. WALL MOUNT OUTLET 66" AFF COLOCATED WITH POWER IN RECESSED 8X10 BOX, REFETO DETAIL X ON SHEET T501. COORDINATE
	W	1 1 1 2	RJ45 RJ45 RJ45	WHITE WHITE BLUE GREEN	DATA DATA DATA DATA DATA	5	CAT 6A CAT 6A CAT 6A	BLUE BLUE BLUE GREEN	112 112	CBP DATA PATCH PANEL CBP DATA PATCH PANEL	BLANK 117.W.1 119.W.1 121.TV.1 121.TV.2 121.TV.3	WALL MOUNT OUTLET 54" AFF. WALL MOUNT OUTLET 54" AFF. WALL MOUNT OUTLET 66" AFF COLOCATED WITH POWER IN RECESSED 8X10 BOX, REFE
119	TV	1 1 2 3	RJ45 RJ45 RJ45 F BLANK	WHITE WHITE BLUE GREEN -	DATA DATA DATA DATA DATA CATV	5	CAT 6A CAT 6A CAT 6A RG6/U	BLUE BLUE BLUE GREEN BLACK	112 112 112	CBP DATA PATCH PANEL CBP DATA PATCH PANEL CBP DATA PATCH PANEL	BLANK 117.W.1 119.W.1 121.TV.1 121.TV.2 121.TV.3 BLANK	WALL MOUNT OUTLET 54" AFF. WALL MOUNT OUTLET 54" AFF. WALL MOUNT OUTLET 66" AFF COLOCATED WITH POWER IN RECESSED 8X10 BOX, REFE TO DETAIL X ON SHEET T501. COORDINATE WITH DIVISION 26.
119	W	1 1 2 3	RJ45 RJ45 RJ45	WHITE WHITE BLUE GREEN WHITE	DATA DATA DATA DATA CATV - DATA	5	CAT 6A CAT 6A CAT 6A RG6/U	BLUE BLUE BLUE GREEN BLACK - BLUE	112 112 112	CBP DATA PATCH PANEL CBP DATA PATCH PANEL CBP DATA PATCH PANEL	BLANK 117.W.1 119.W.1 121.TV.1 121.TV.2 121.TV.3 BLANK 121.W.1	WALL MOUNT OUTLET 54" AFF. WALL MOUNT OUTLET 54" AFF. WALL MOUNT OUTLET 66" AFF COLOCATED WITH POWER IN RECESSED 8X10 BOX, REFETO DETAIL X ON SHEET T501. COORDINATE
119	TV	1 1 1 2 3 4 1	RJ45 RJ45 RJ45 F BLANK RJ45	WHITE WHITE BLUE GREEN -	DATA DATA DATA DATA CATV - DATA DATA DATA	5	CAT 6A CAT 6A CAT 6A RG6/U - CAT 6A	BLUE BLUE BLUE GREEN BLACK	112 112 112 - 112	CBP DATA PATCH PANEL CBP DATA PATCH PANEL CBP DATA PATCH PANEL - CBP DATA PATCH PANEL	BLANK 117.W.1 119.W.1 121.TV.1 121.TV.2 121.TV.3 BLANK 121.W.1 122.A.1	WALL MOUNT OUTLET 54" AFF. WALL MOUNT OUTLET 66" AFF COLOCATED WITH POWER IN RECESSED 8X10 BOX, REFE TO DETAIL X ON SHEET T501. COORDINATE WITH DIVISION 26. WALL MOUNT OUTLET 54" AFF.
119	TV W	1 1 1 2 3 4 1 1	RJ45 RJ45 RJ45 F BLANK	WHITE WHITE BLUE GREEN WHITE WHITE	DATA DATA DATA DATA DATA CATV - DATA DATA DATA DATA	5	CAT 6A CAT 6A CAT 6A RG6/U	BLUE BLUE BLUE GREEN BLACK - BLUE WHITE	112 112 112	CBP DATA PATCH PANEL CBP DATA PATCH PANEL CBP DATA PATCH PANEL	BLANK 117.W.1 119.W.1 121.TV.1 121.TV.2 121.TV.3 BLANK 121.W.1 122.A.1 122.A.2	WALL MOUNT OUTLET 54" AFF. WALL MOUNT OUTLET 66" AFF COLOCATED WITH POWER IN RECESSED 8X10 BOX, REFE TO DETAIL X ON SHEET T501. COORDINATE WITH DIVISION 26. WALL MOUNT OUTLET 54" AFF. WALL MOUNT OUTLET COLOCATED WITH
119	TV	1 1 1 2 3 4 1	RJ45 RJ45 RJ45 F BLANK RJ45	WHITE WHITE BLUE GREEN WHITE	DATA DATA DATA DATA CATV - DATA DATA DATA	5	CAT 6A CAT 6A CAT 6A RG6/U - CAT 6A	BLUE BLUE BLUE GREEN BLACK - BLUE	112 112 112 - 112	CBP DATA PATCH PANEL CBP DATA PATCH PANEL CBP DATA PATCH PANEL - CBP DATA PATCH PANEL	BLANK 117.W.1 119.W.1 121.TV.1 121.TV.2 121.TV.3 BLANK 121.W.1 122.A.1 122.A.2 122.A.3	WALL MOUNT OUTLET 54" AFF. WALL MOUNT OUTLET 66" AFF COLOCATED WITH POWER IN RECESSED 8X10 BOX, REFE TO DETAIL X ON SHEET T501. COORDINATE WITH DIVISION 26. WALL MOUNT OUTLET 54" AFF. WALL MOUNT OUTLET COLOCATED WITH POWER RECEPTACLE, COORDINATE WITH
119	TV W	1 1 1 2 3 4 1 1	RJ45 RJ45 RJ45 F BLANK RJ45	WHITE WHITE BLUE GREEN WHITE WHITE	DATA DATA DATA DATA DATA CATV - DATA DATA DATA DATA	5	CAT 6A CAT 6A CAT 6A RG6/U - CAT 6A	BLUE BLUE BLUE GREEN BLACK - BLUE WHITE	112 112 112 - 112	CBP DATA PATCH PANEL CBP DATA PATCH PANEL CBP DATA PATCH PANEL - CBP DATA PATCH PANEL	BLANK 117.W.1 119.W.1 121.TV.1 121.TV.2 121.TV.3 BLANK 121.W.1 122.A.1 122.A.2	WALL MOUNT OUTLET 54" AFF. WALL MOUNT OUTLET 66" AFF COLOCATED WITH POWER IN RECESSED 8X10 BOX, REFE TO DETAIL X ON SHEET T501. COORDINATE WITH DIVISION 26. WALL MOUNT OUTLET 54" AFF. WALL MOUNT OUTLET COLOCATED WITH
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119 121 121 122	TV W	1 1 1 2 3 4 1 1 2 3 4	RJ45 RJ45 RJ45 F BLANK RJ45	WHITE WHITE BLUE GREEN WHITE WHITE BLUE - WHITE	DATA DATA DATA DATA CATV - DATA DATA DATA DATA DATA DATA DATA DA	5	CAT 6A CAT 6A CAT 6A RG6/U - CAT 6A CAT 6A	BLUE BLUE BLUE GREEN BLACK - BLUE WHITE BLUE - WHITE	112 112 112 - 112 112	CBP DATA PATCH PANEL CBP DATA PATCH PANEL CBP DATA PATCH PANEL - CBP DATA PATCH PANEL	BLANK 117.W.1 119.W.1 121.TV.1 121.TV.2 121.TV.3 BLANK 121.W.1 122.A.1 122.A.2 122.A.3 BLANK 122.B.1	WALL MOUNT OUTLET 54" AFF. WALL MOUNT OUTLET 66" AFF COLOCATED WITH POWER IN RECESSED 8X10 BOX, REFE TO DETAIL X ON SHEET T501. COORDINATE WITH DIVISION 26. WALL MOUNT OUTLET 54" AFF. WALL MOUNT OUTLET COLOCATED WITH POWER RECEPTACLE, COORDINATE WITH DIVISION 26.
119 121 121 122	TV W	1 1 1 2 3 4 1 1 2 3 4 1 2	RJ45 RJ45 RJ45 F BLANK RJ45 RJ45 BLANK	WHITE WHITE BLUE GREEN WHITE WHITE BLUE	DATA DATA DATA DATA CATV - DATA DATA DATA DATA DATA DATA DATA DA	5	CAT 6A CAT 6A CAT 6A RG6/U CAT 6A CAT 6A CAT 6A	BLUE BLUE BLUE GREEN BLACK - BLUE WHITE BLUE	112 112 112 - 112 112	CBP DATA PATCH PANEL CBP DATA PATCH PANEL CBP DATA PATCH PANEL - CBP DATA PATCH PANEL CBP DATA PATCH PANEL -	BLANK 117.W.1 119.W.1 121.TV.1 121.TV.2 121.TV.3 BLANK 121.W.1 122.A.1 122.A.2 122.A.3 BLANK 122.B.1 122.B.2	WALL MOUNT OUTLET 54" AFF. WALL MOUNT OUTLET 66" AFF COLOCATED WITH POWER IN RECESSED 8X10 BOX, REFE TO DETAIL X ON SHEET T501. COORDINATE WITH DIVISION 26. WALL MOUNT OUTLET 54" AFF. WALL MOUNT OUTLET COLOCATED WITH POWER RECEPTACLE, COORDINATE WITH DIVISION 26. WALL MOUNT OUTLET COLOCATED WITH POWER RECEPTACLE, COORDINATE WITH POWER RECEPTACLE, COORDINATE WITH POWER RECEPTACLE, COORDINATE WITH
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119 121 121 122	TV W	1 1 1 2 3 4 1 1 2 3 4 1 2	RJ45 RJ45 RJ45 F BLANK RJ45 RJ45 BLANK	WHITE WHITE BLUE GREEN WHITE WHITE BLUE - WHITE BLUE - WHITE BLUE	DATA DATA DATA DATA CATV - DATA DATA DATA DATA DATA DATA DATA DA	5	CAT 6A CAT 6A CAT 6A RG6/U CAT 6A CAT 6A CAT 6A	BLUE BLUE BLUE GREEN BLACK - BLUE WHITE BLUE - WHITE BLUE - BLUE	112 112 112 - 112 112	CBP DATA PATCH PANEL CBP DATA PATCH PANEL CBP DATA PATCH PANEL - CBP DATA PATCH PANEL CBP DATA PATCH PANEL -	BLANK 117.W.1 119.W.1 121.TV.1 121.TV.2 121.TV.3 BLANK 121.W.1 122.A.1 122.A.2 122.A.3 BLANK 122.B.1 122.B.2 122.B.3 BLANK	WALL MOUNT OUTLET 54" AFF. WALL MOUNT OUTLET 66" AFF COLOCATED WITH POWER IN RECESSED 8X10 BOX, REFE TO DETAIL X ON SHEET T501. COORDINATE WITH DIVISION 26. WALL MOUNT OUTLET 54" AFF. WALL MOUNT OUTLET COLOCATED WITH POWER RECEPTACLE, COORDINATE WITH DIVISION 26. WALL MOUNT OUTLET COLOCATED WITH POWER RECEPTACLE, COORDINATE WITH POWER RECEPTACLE, COORDINATE WITH POWER RECEPTACLE, COORDINATE WITH
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119 121 121 122	TV W A B	1 1 1 2 3 4 1 1 2 3 4 1 2 3 4 1 2	RJ45 RJ45 RJ45 F BLANK RJ45 RJ45 BLANK RJ45	WHITE WHITE BLUE GREEN WHITE WHITE BLUE - WHITE BLUE - WHITE BLUE - WHITE	DATA DATA DATA DATA DATA CATV - DATA DATA DATA DATA DATA DATA DATA DA	5	CAT 6A CAT 6A CAT 6A RG6/U CAT 6A CAT 6A CAT 6A CAT 6A	BLUE BLUE BLUE GREEN BLACK - BLUE WHITE BLUE - WHITE BLUE - WHITE BLUE - WHITE	112 112 112 - 112 112 - 112	CBP DATA PATCH PANEL CBP DATA PATCH PANEL CBP DATA PATCH PANEL - CBP DATA PATCH PANEL CBP DATA PATCH PANEL -	BLANK 117.W.1 119.W.1 121.TV.1 121.TV.2 121.TV.3 BLANK 121.W.1 122.A.1 122.A.2 122.A.3 BLANK 122.B.1 122.B.2 122.B.3 BLANK 122.C.1 122.C.2	WALL MOUNT OUTLET 54" AFF. WALL MOUNT OUTLET 66" AFF COLOCATED WITH POWER IN RECESSED 8X10 BOX, REFE TO DETAIL X ON SHEET T501. COORDINATE WITH DIVISION 26. WALL MOUNT OUTLET 54" AFF. WALL MOUNT OUTLET COLOCATED WITH POWER RECEPTACLE, COORDINATE WITH DIVISION 26. WALL MOUNT OUTLET COLOCATED WITH POWER RECEPTACLE, COORDINATE WITH DIVISION 26. WALL MOUNT OUTLET COLOCATED WITH DIVISION 26.
119 121 121 122	TV W	1 1 1 2 3 4 1 1 2 3 4 1 2 3 4 1	RJ45 RJ45 RJ45 F BLANK RJ45 BLANK RJ45 BLANK RJ45 BLANK RJ45	WHITE WHITE BLUE GREEN WHITE WHITE BLUE - WHITE BLUE - WHITE BLUE	DATA DATA DATA DATA CATV - DATA DATA DATA DATA DATA DATA DATA DA	5	CAT 6A CAT 6A CAT 6A RG6/U - CAT 6A CAT 6A CAT 6A - CAT 6A	BLUE BLUE BLUE GREEN BLACK - BLUE WHITE BLUE - WHITE BLUE - BLUE	112 112 112 - 112 - 112 - 112	CBP DATA PATCH PANEL CBP DATA PATCH PANEL CBP DATA PATCH PANEL - CBP DATA PATCH PANEL CBP DATA PATCH PANEL - CBP DATA PATCH PANEL	BLANK 117.W.1 119.W.1 121.TV.1 121.TV.2 121.TV.3 BLANK 121.W.1 122.A.1 122.A.2 122.A.3 BLANK 122.B.1 122.B.2 122.B.3 BLANK 122.C.1 122.C.2 122.C.3	WALL MOUNT OUTLET 54" AFF. WALL MOUNT OUTLET 66" AFF COLOCATED WITH POWER IN RECESSED 8X10 BOX, REFE TO DETAIL X ON SHEET T501. COORDINATE WITH DIVISION 26. WALL MOUNT OUTLET 54" AFF. WALL MOUNT OUTLET COLOCATED WITH POWER RECEPTACLE, COORDINATE WITH DIVISION 26. WALL MOUNT OUTLET COLOCATED WITH POWER RECEPTACLE, COORDINATE WITH DIVISION 26.
119 121 121 122	TV W A B	1 1 1 2 3 4 1 1 2 3 4 1 2 3 4 1 2	RJ45 RJ45 RJ45 F BLANK RJ45 RJ45 BLANK RJ45 BLANK	WHITE WHITE BLUE GREEN WHITE WHITE BLUE - WHITE BLUE - WHITE BLUE - WHITE	DATA DATA DATA DATA DATA CATV - DATA DATA DATA DATA DATA DATA DATA DA	5	CAT 6A CAT 6A CAT 6A RG6/U - CAT 6A CAT 6A CAT 6A - CAT 6A	BLUE BLUE BLUE GREEN BLACK - BLUE WHITE BLUE - WHITE BLUE - WHITE BLUE - WHITE	112 112 112 - 112 - 112 - 112	CBP DATA PATCH PANEL CBP DATA PATCH PANEL CBP DATA PATCH PANEL - CBP DATA PATCH PANEL CBP DATA PATCH PANEL - CBP DATA PATCH PANEL	BLANK 117.W.1 119.W.1 121.TV.1 121.TV.2 121.TV.3 BLANK 121.W.1 122.A.1 122.A.2 122.A.3 BLANK 122.B.1 122.B.2 122.B.3 BLANK 122.C.1 122.C.2	WALL MOUNT OUTLET 54" AFF. WALL MOUNT OUTLET 66" AFF COLOCATED WITH POWER IN RECESSED 8X10 BOX, REFE TO DETAIL X ON SHEET T501. COORDINATE WITH DIVISION 26. WALL MOUNT OUTLET 54" AFF. WALL MOUNT OUTLET COLOCATED WITH POWER RECEPTACLE, COORDINATE WITH DIVISION 26. WALL MOUNT OUTLET COLOCATED WITH POWER RECEPTACLE, COORDINATE WITH DIVISION 26. WALL MOUNT OUTLET COLOCATED WITH POWER RECEPTACLE, COORDINATE WITH DIVISION 26.
119 121 121 122	TV W A B	1 1 1 2 3 4 1 1 2 3 4 1 2 3 4 1 2 3	RJ45 RJ45 RJ45 F BLANK RJ45 BLANK RJ45 BLANK RJ45 BLANK RJ45	WHITE WHITE BLUE GREEN WHITE WHITE BLUE - WHITE BLUE - WHITE BLUE - WHITE BLUE - BLUE - WHITE	DATA DATA DATA DATA DATA CATV - DATA DATA DATA DATA DATA DATA DATA DA	5	CAT 6A CAT 6A CAT 6A RG6/U CAT 6A CAT 6A CAT 6A CAT 6A CAT 6A CAT 6A	BLUE BLUE BLUE GREEN BLACK - BLUE WHITE BLUE - WHITE BLUE - WHITE BLUE - WHITE	112 112 112 - 112 - 112 - 112	CBP DATA PATCH PANEL CBP DATA PATCH PANEL CBP DATA PATCH PANEL - CBP DATA PATCH PANEL	BLANK 117.W.1 119.W.1 121.TV.1 121.TV.2 121.TV.3 BLANK 121.W.1 122.A.1 122.A.2 122.A.3 BLANK 122.B.1 122.B.2 122.B.3 BLANK 122.C.1 122.C.2 122.C.3	WALL MOUNT OUTLET 54" AFF. WALL MOUNT OUTLET 66" AFF COLOCATED WITH POWER IN RECESSED 8X10 BOX, REFE TO DETAIL X ON SHEET T501. COORDINATE WITH DIVISION 26. WALL MOUNT OUTLET 54" AFF. WALL MOUNT OUTLET COLOCATED WITH POWER RECEPTACLE, COORDINATE WITH DIVISION 26. WALL MOUNT OUTLET COLOCATED WITH POWER RECEPTACLE, COORDINATE WITH DIVISION 26. WALL MOUNT OUTLET COLOCATED WITH POWER RECEPTACLE, COORDINATE WITH DIVISION 26.
119 121 121 122 122	TV W A B	1 1 1 2 3 4 1 1 2 3 4 1 2 3 4 1 2 3 4 1 2	RJ45 RJ45 RJ45 RJ45 F BLANK RJ45 BLANK RJ45 BLANK RJ45 BLANK RJ45 BLANK	WHITE WHITE BLUE GREEN WHITE WHITE BLUE - WHITE	DATA DATA DATA DATA DATA CATV - DATA DATA DATA DATA DATA DATA DATA DA	5	CAT 6A CAT 6A CAT 6A RG6/U - CAT 6A CAT 6A CAT 6A - CAT 6A - CAT 6A -	BLUE BLUE BLUE BLUE GREEN BLACK - BLUE WHITE BLUE - WHITE	112 112 112 - 112 - 112 - 112 -	CBP DATA PATCH PANEL CBP DATA PATCH PANEL CBP DATA PATCH PANEL CBP DATA PATCH PANEL CBP DATA PATCH PANEL CBP DATA PATCH PANEL CBP DATA PATCH PANEL CBP DATA PATCH PANEL	BLANK 117.W.1 119.W.1 121.TV.1 121.TV.2 121.TV.3 BLANK 121.W.1 122.A.1 122.A.2 122.A.3 BLANK 122.B.1 122.B.2 122.B.3 BLANK 122.C.1 122.C.2 122.C.3 BLANK 122.D.1	WALL MOUNT OUTLET 54" AFF. WALL MOUNT OUTLET 66" AFF COLOCATED WITH POWER IN RECESSED 8X10 BOX, REFE TO DETAIL X ON SHEET T501. COORDINATE WITH DIVISION 26. WALL MOUNT OUTLET 54" AFF. WALL MOUNT OUTLET COLOCATED WITH POWER RECEPTACLE, COORDINATE WITH DIVISION 26. WALL MOUNT OUTLET COLOCATED WITH POWER RECEPTACLE, COORDINATE WITH DIVISION 26. WALL MOUNT OUTLET COLOCATED WITH POWER RECEPTACLE, COORDINATE WITH DIVISION 26. WALL MOUNT OUTLET COLOCATED WITH POWER RECEPTACLE, COORDINATE WITH DIVISION 26.
119 121 121 122 122	TV W A B	1 1 1 2 3 4 1 1 2 3 4 1 2 3 4 1 2 3 4 1 2 3 4 1 2	RJ45 RJ45 RJ45 F BLANK RJ45 BLANK RJ45 BLANK RJ45 BLANK RJ45	WHITE WHITE BLUE GREEN WHITE WHITE BLUE - WHITE BLUE - WHITE BLUE - WHITE BLUE WHITE	DATA DATA DATA DATA DATA CATV - DATA DATA DATA DATA DATA DATA DATA DA	5	CAT 6A CAT 6A CAT 6A RG6/U CAT 6A CAT 6A CAT 6A CAT 6A CAT 6A CAT 6A	BLUE BLUE BLUE GREEN BLACK - BLUE WHITE BLUE - WHITE BLUE - WHITE BLUE - WHITE BLUE WHITE BLUE	112 112 112 - 112 - 112 - 112	CBP DATA PATCH PANEL CBP DATA PATCH PANEL CBP DATA PATCH PANEL - CBP DATA PATCH PANEL	BLANK 117.W.1 119.W.1 121.TV.1 121.TV.2 121.TV.3 BLANK 121.W.1 122.A.1 122.A.2 122.A.3 BLANK 122.B.1 122.B.2 122.B.3 BLANK 122.C.1 122.C.2 122.C.3 BLANK 122.D.1 122.D.2	WALL MOUNT OUTLET 54" AFF. WALL MOUNT OUTLET 66" AFF COLOCATED WITH POWER IN RECESSED 8X10 BOX, REFE TO DETAIL X ON SHEET T501. COORDINATE WITH DIVISION 26. WALL MOUNT OUTLET 54" AFF. WALL MOUNT OUTLET COLOCATED WITH POWER RECEPTACLE, COORDINATE WITH DIVISION 26. WALL MOUNT OUTLET COLOCATED WITH POWER RECEPTACLE, COORDINATE WITH DIVISION 26. WALL MOUNT OUTLET COLOCATED WITH POWER RECEPTACLE, COORDINATE WITH DIVISION 26. WALL MOUNT OUTLET COLOCATED WITH POWER RECEPTACLE, COORDINATE WITH DIVISION 26.
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PNS GAF COMMUNICATIONS OUTLET CABLE SCHEDULE

- OUTLET NUMBERS LISTED HEREIN ARE FOR CONTRACTOR REFERENCE AND INDICATE OUTLET DESIGNATION BY ROOM NUMBER AND OUTLET ID AS SHOWN ON THE COMMUNICATIONS FLOOR PLAN.
- 2. UNLESS OTHERWISE NOTED, CABLES SHALL BE ROUTED FROM THE WALL OUTLET IN 1" DROP CONDUIT TO THE NEAREST BRANCH OF THE COMMUNICATIONS CABLE TRAY.
- 3. FINAL SCHEME TO BE USED FOR LABELING OUTLETS, CABLES AND PATCH PANELS SHALL BE IN COORDINATION WITH THE OWNER AND CBP.
- 4. REFER TO OUTLET DETAILS ON SHEET T501 FOR FACEPLATE AND TERMINATION MODULE REQUIREMENTS. FINAL CONFIGURATIONS SHALL BE REVIEWED AND APPROVED BY THE OWNER AND CBP PRIOR TO INSTALLATION.



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PENSACOLA INTERNATIONAL AIRPORT

PENSACOLA, FLORIDA

PENSACOLA
GENERAL
AVIATION
FACILITY (GAF)



PROFESSIONAL SEAL



NO.	DESCRIPTION	DATE

DATE ISSUED:	03/03/2020
REVIEWED BY:	SVS
DRAWN BY:	VJM
DESIGNED BY:	RJF
PROJECT NUMBER:	,

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SHEET TITLE


TELECOM CABLE SCHEDULE

SHEET NUMBER

T602

BID DOCUMENTS

PNS GAF COMMUNICATIONS OUTLET CABLE SCHEDULE MARK OUTLET MODULE MODULE DATA TYPE NUMBER NUMBER TYPE COLOR OUTLET CABLE CABLE COMM
DETAIL TYPE COLOR ROOM PATCH PANEL TERMINATION LOCATION NUMBER NUMBER NUMBER LABEL WHITE 123.A.1 DATA WALL MOUNT OUTLET COLOCATED WITH DATA RJ45 CAT 6A 112 CBP DATA PATCH PANEL 123.A.2 123 BLUE BLUE POWER RECEPTACLE, COORDINATE WITH DATA 123.A.3 DIVISION 26. BLANK BLANK 123.B.1 WHITE DATA WALL MOUNT OUTLET COLOCATED WITH DATA CAT 6A CBP DATA PATCH PANEL 123.B.2 RJ45 123 BLUE BLUE POWER RECEPTACLE, COORDINATE WITH DATA 123.B.3 DIVISION 26. BLANK BLANK 123.C.1 WHITE DATA WHITE WALL MOUNT OUTLET COLOCATED WITH DATA 123.C.2 123 BLUE CAT 6A BLUE CBP DATA PATCH PANEL POWER RECEPTACLE, COORDINATE WITH DATA 123.C.3 DIVISION 26. DATA 123.C.4 GREEN GREEN WHITE DATA WHITE 123.D.1 WALL MOUNT OUTLET COLOCATED WITH 123.D.2 DATA CBP DATA PATCH PANEL 123 CAT 6A BLUE RJ45 BLUE POWER RECEPTACLE, COORDINATE WITH DATA 123.D.3 DIVISION 26. RED RED DATA CBP RADIO PATCH PANEL 123.D.4 DATA 123.TV.1 BLUE BLUE WALL MOUNT OUTLET 66" AFF COLOCATED DATA **GREEN GREEN** CBP DATA PATCH PANEL 123.TV.2 WITH POWER IN RECESSED 8X10 BOX, REFER 123 TV TO DETAIL X ON SHEET T501. COORDINATE CATV 123.TV.3 RG6/U BLACK F WITH DIVISION 26. 4 BLANK BLANK DATA 124.A.1 WHITE WALL MOUNT OUTLET COLOCATED WITH DATA CAT 6A CBP DATA PATCH PANEL RJ45 124.A.2 BLUE BLUE 124 POWER RECEPTACLE, COORDINATE WITH DATA 124.A.3 DIVISION 26. GCTC.A.1 SURFACE MOUNT OUTLET INSIDE GCTC. GCTC RJ45 GREEN CAT 6A GREEN 112 SECURITY PATCH PANEL COORDINATE WITH DIVISION 28. GCTC.A.2 RJ45 YELLOW DATA MOUNT OUTLET ABOVE SUSPENDED 2 CAT 6A YELLOW 112 CBP DATA PATCH PANEL WAP.01.2 CEILING. MOUNT OUTLET ABOVE SUSPENDED RJ45 YELLOW CBP DATA PATCH PANEL CAT 6A YELLOW 112 CEILING. MOUNT OUTLET ABOVE SUSPENDED RJ45 YELLOW CAT 6A YELLOW 112 CBP DATA PATCH PANEL DATA CEILING. WAP.03.2

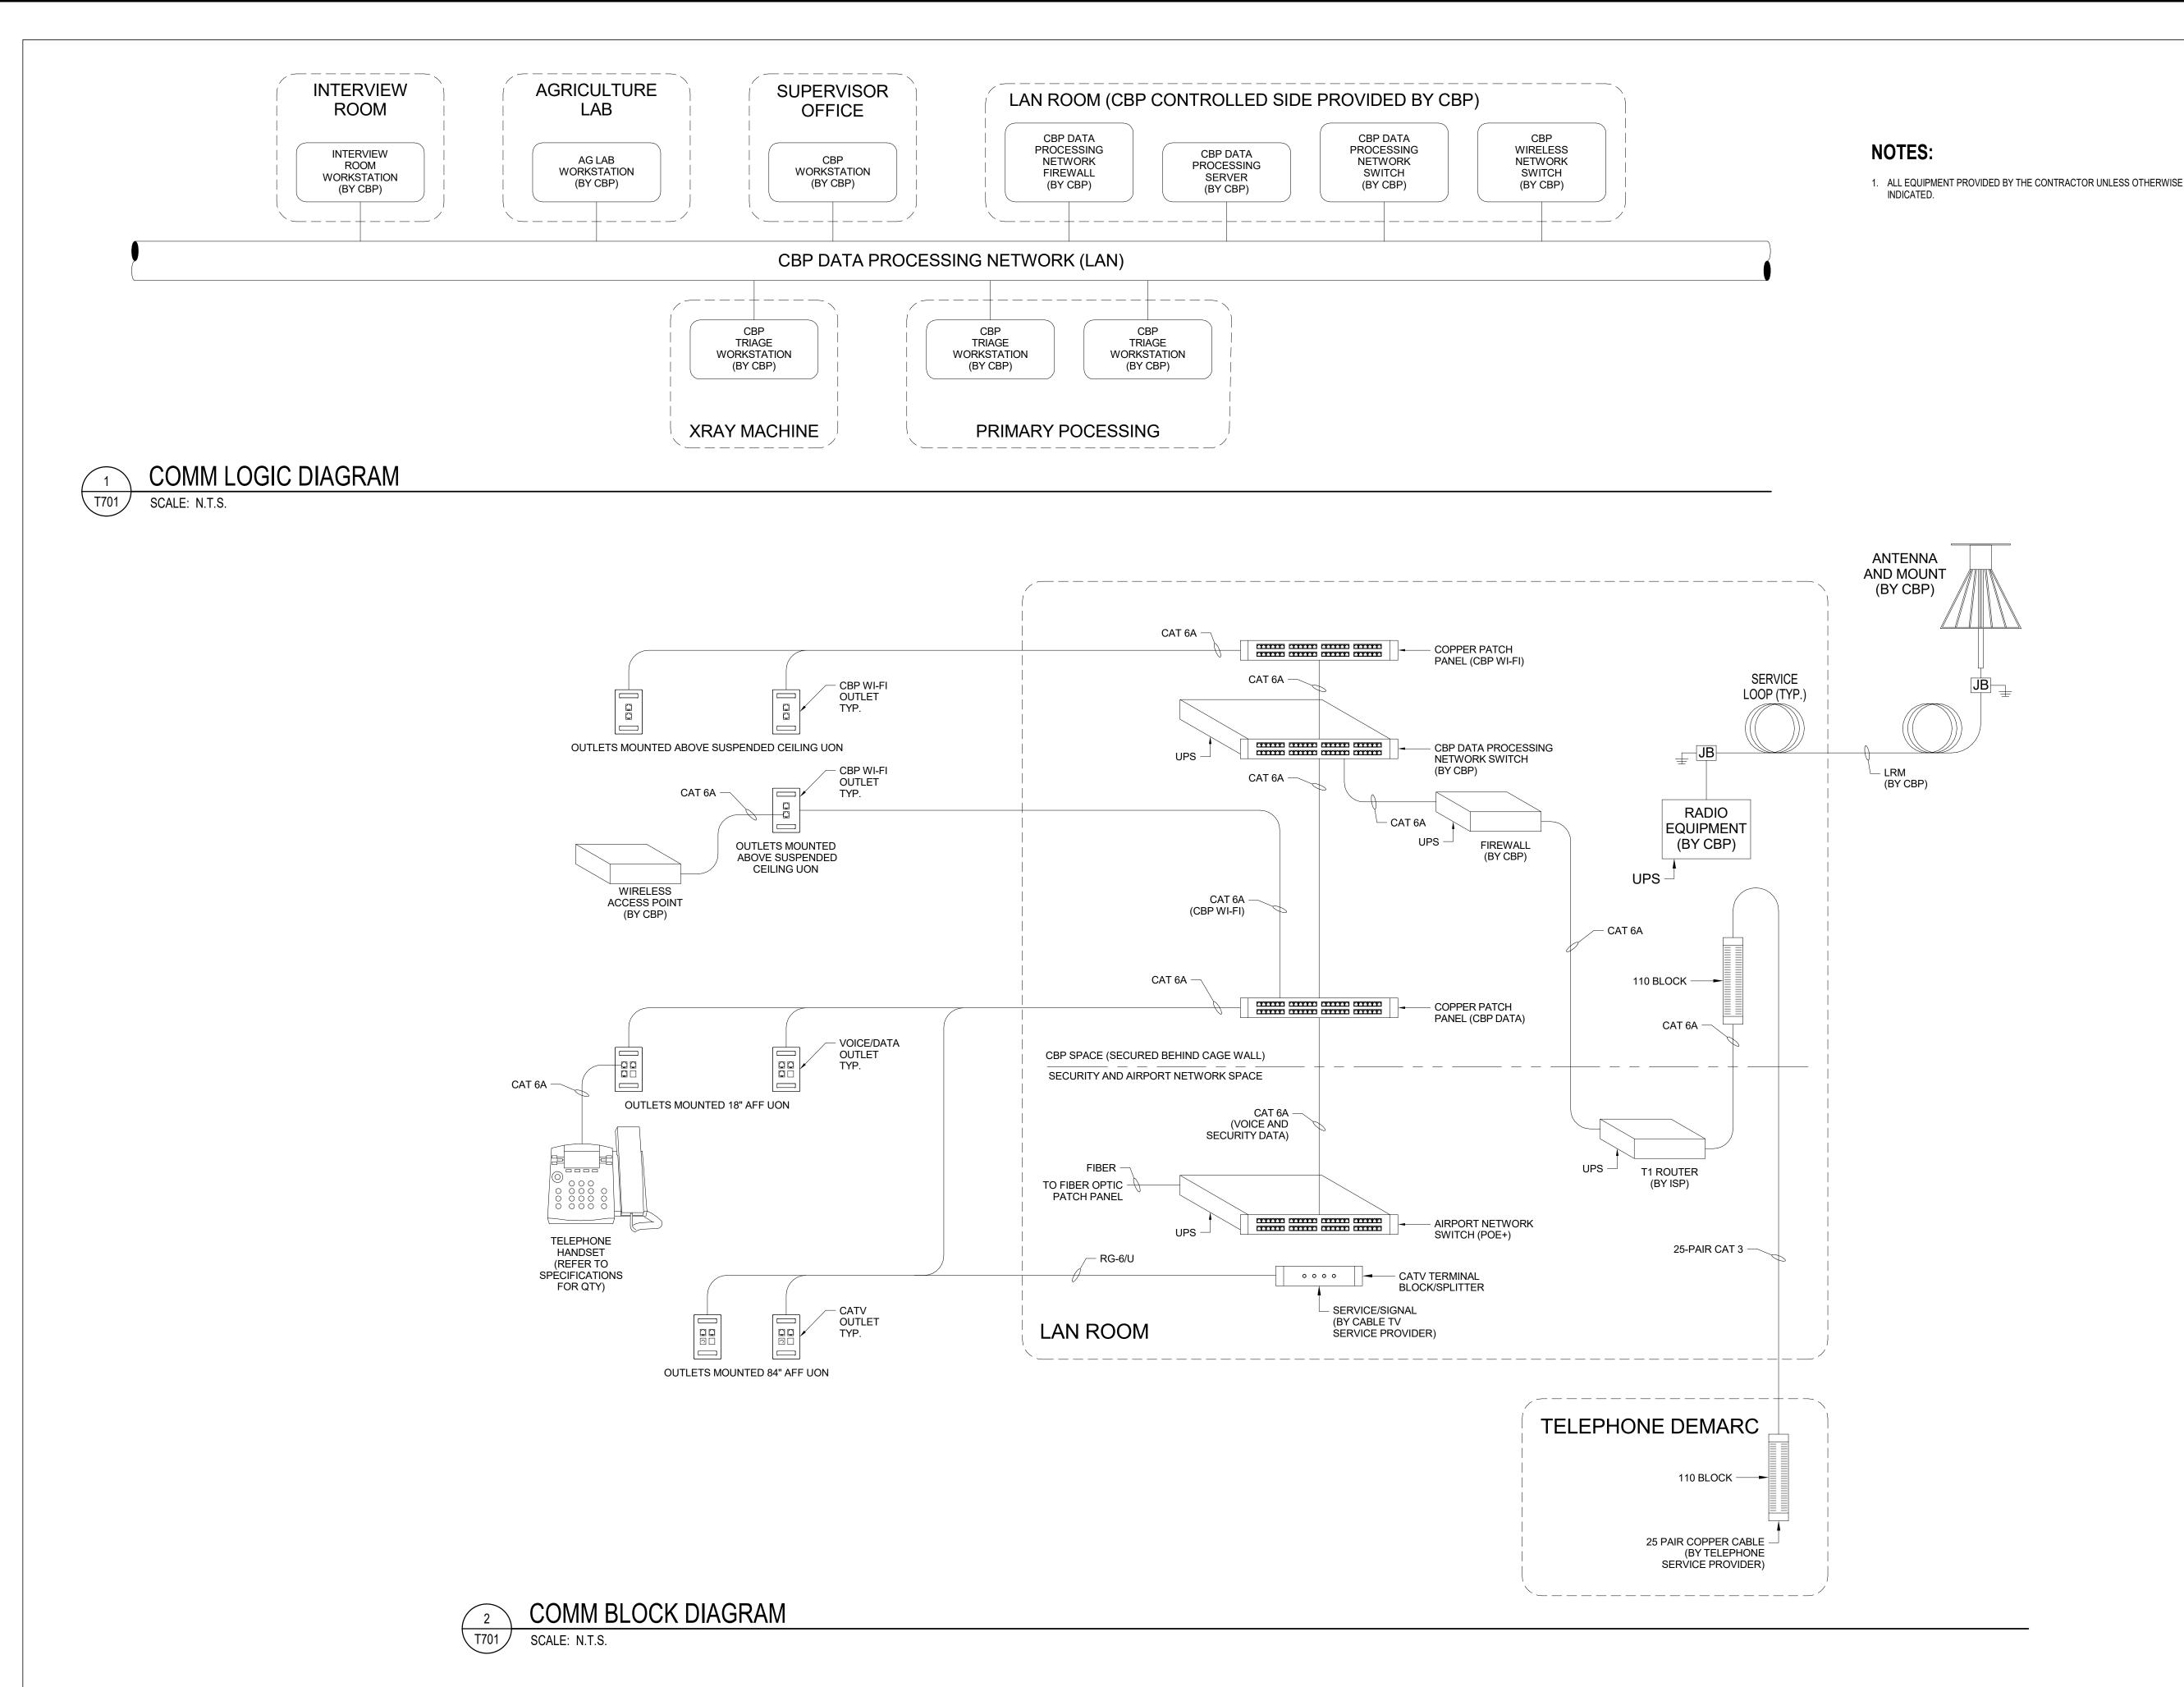



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PROFESSIONAL SEAL



REVISIONS

DATE ISSUED: 03/03/2020

NO. DESCRIPTION DATE

REVIEWED BY: SVS

DRAWN BY: VJM

DESIGNED BY: RJF

PROJECT NUMBER:

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SHEET TITLE

TELECOM BLOCK DIAGRAMS

SHEET NUMBER

T701

KEYED NOTES:

(39) E, (2) T

(42) E, (3) T

- 1. MOUNT OUTLET INSIDE 8" X 10" RECESSED WALL BOX FOR TELEVISION REFER TO DETAIL 3 ON SHEET T502, COORDINATE WITH DIVISION 26.
- 2. MOUNT OUTLET INSIDE CAST-IN PLACE FLUSH FLOOR BOX, REFER TO DETAIL 6 ON SHEET T501, COORDINATE WITH DIVISION 26.

NOTES:

(19) E, T

- REFER TO FLOOR PLANS FOR DEVICE MOUNTING LOCATIONS.
- THIS DIAGRAM IS SCHEMATIC IN NATURE AND MAY NOT SHOW ALL EQUIPMENT OR CONNECTIONS REQUIRED. THE CONTRACTOR SHALL PROVIDE ALL EQUIPMENT AND CONNECTIONS REQUIRED FOR A COMPLETE
- ALL EQUIPMENT, OUTLETS AND CABLE PROVIDED BY CONTRACTOR UON.



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Jacksonville, Florida 32256-0597



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PENSACOLA, FLORIDA

PENSACOLA GENERAL AVIATION FACILITY (GAF)

720 Bayfront Parkway, Suite 200 Pensacola, FL 32502 T 850 432 0706 F 850 433 0508 G M C N E T W O R K . C O M

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REVI	REVISIONS								
NO.	DESCRIPTION	DATE							

DATE ISSUED: 03/03/2020 **REVIEWED BY:** SVS VJMDRAWN BY: RJF **DESIGNED BY:**

PROJECT NUMBER: 201-0052-002


© 2020 RS&H, INC. SHEET TITLE

TELECOM INTERCONNECT DIAGRAM

SHEET NUMBER

T702


BID DOCUMENTS

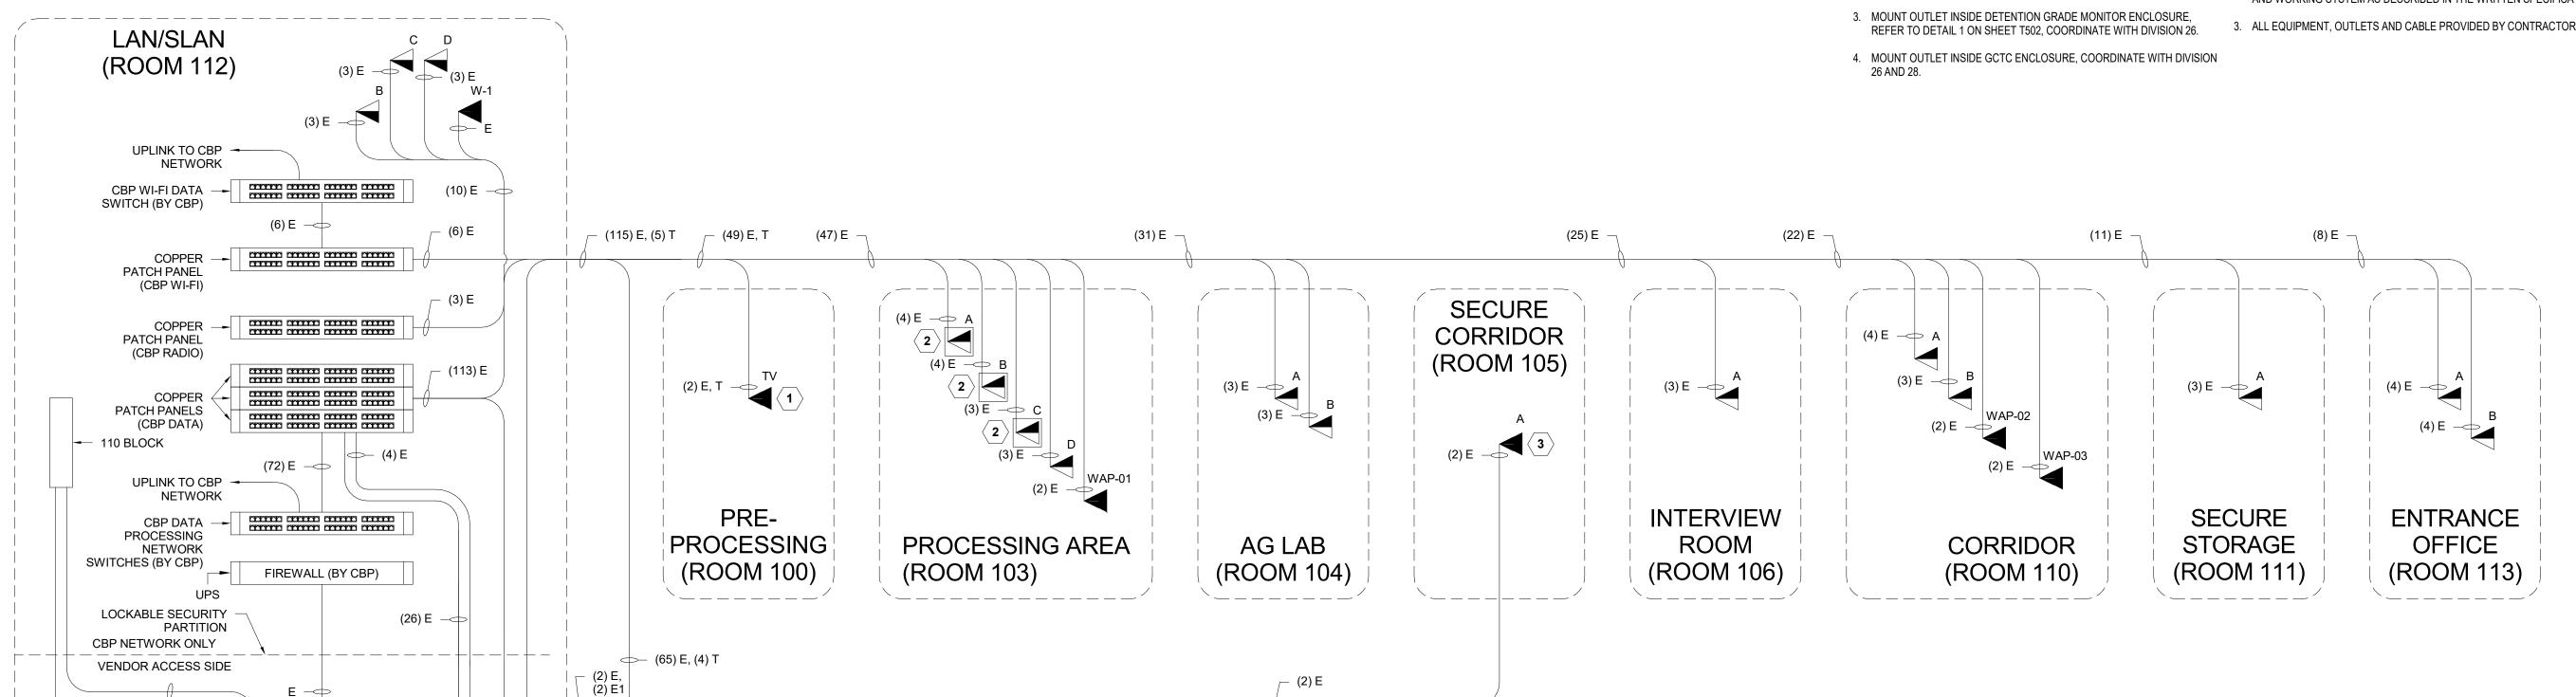

- (2) E

(43) E, (3) T

(44) E, (3) T

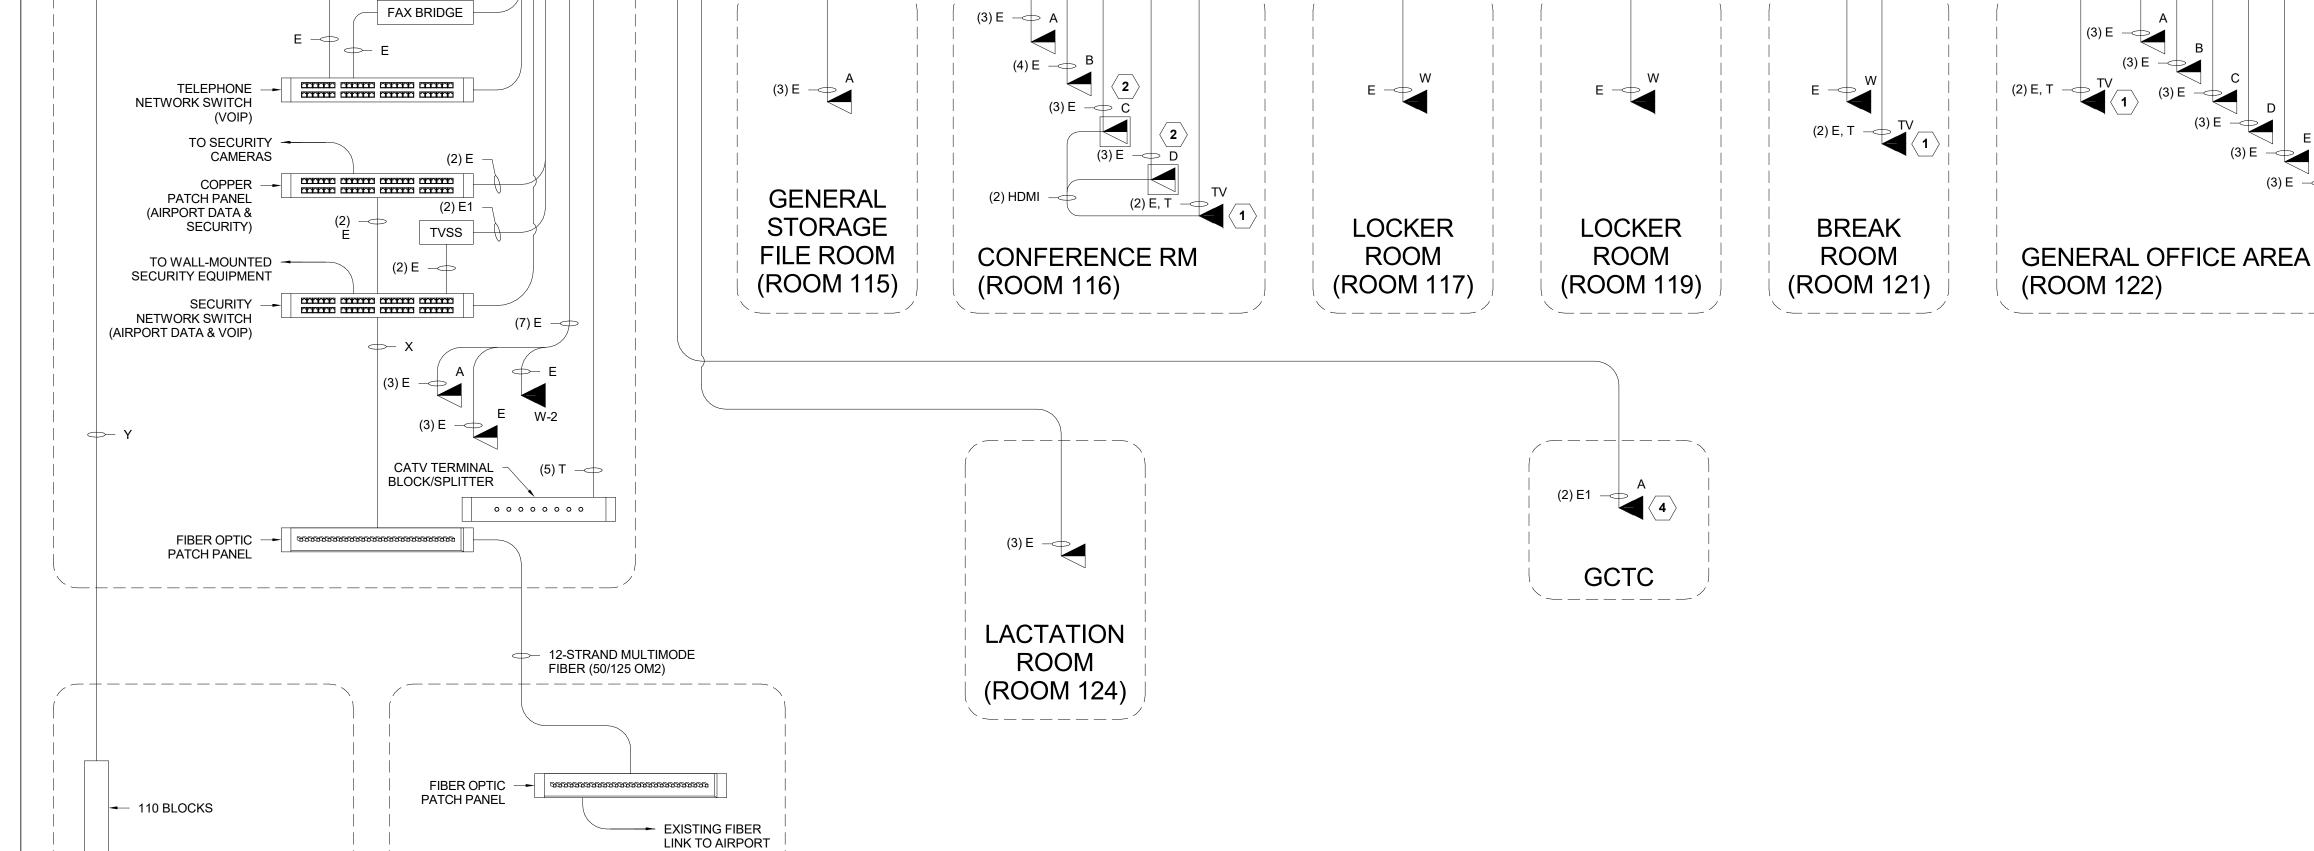

(59) E, (4) T

(62) E, (4) T

NETWORK

EXISTING VEHICLE GATE 25

CABLE LEGEND ID DESCRIPTION 6-24 AWG SHIELDED CARD READER. CABLE LENGTH < 450' 9-24 AWG SHIELDED CARD READER. CABLE LENGTH > 450' 4-22 AWG UNSHIELDED MISC. INPUT (DOOR POSITION/REX/TD) 4-14 AWG UNSHIELDED ANNUNCIATOR (HORN/STROBE) 2-14 AWG UNSHIELDED /ISC. OUTPUT (LOCK) CABLE LENGTH UP TO 100' IISC. OUTPUT (LOCK). CABLE LENGTH UP TO 200 2-12 AWG UNSHIELDED CATEGORY 6A UTP ETHERNET (VOICE, DATA, VIDEO) UTDOOR RATED ETHERNET CABLE OUTDOOR CAT 6A UTP 2-18 AWG UNSHIELDED FIRE ALARM RELAY AND MISC. I/O 8-18 AWG UNSHIELDED GATE OPERATOR I/O 6-18 AWG UNSHIELDED IDS KEY PAD EXTERNAL MICROPHONE CABLE PROVIDED BY DEVICE M **CABLE TELEVISION** 4-18 AWG SHIELDED RS-485 SERIAL COMMUNICATION MULTI-MODE FIBER FIBER OPTIC PATCH CABLE ANALOG TELEPHONE LINE 25-PAIR COPPER

(2) E, T

SUPERVISOR'S

OFFICE (ROOM 123)

TELEPHONE

PROVIDER DEMARC

ISP EQUIPMENT

- THIS DIAGRAM IS SCHEMATIC IN NATURE AND MAY NOT SHOW ALL BENDS OR TURNS REQUIRED. CONTRACTOR SHALL PROVIDE A COMPLETE RACEWAY SYSTEM AS REQUIRED.
- 2. REFER TO INTERCONNECT DIAGRAM FOR ADDITIONAL INFORMATION.

KEYED NOTES:

- (1) 4" C FOR TELEPHONE PROVIDER AND ONE (1) 2" C. FOR CATV PROVIDER BY CIVIL.
- 2. ONE (1) 2" C TO AIRPORT DUCTBANK BY CIVIL.
- 3. MOUNT OUTLET INSIDE 8" X 10 RECESSED WALL BOX FOR TELEVISION, REFER TO DETAIL 3 ON SHEET T502, COORDINATE WITH DIVISION 26.
- 4. PROVIDE DOUBLE GANG JUNCTION BOX WITH BLANK WALL PLATE 18" AFF BELOW WALL MOUNTED TV.
- MOUNT OUTLET INSIDE CAST-IN PLACE FLUSH FLOOR BOX, REFER TO DETAIL 6 ON SHEET T501, COORDINATE WITH DIVISION 26.
- 6. MOUNT OUTLET INSIDE DETENTION GRADE MONITOR ENCLOSURE, REFER TO DETAIL 1 ON SHEET T502, COORDINATE WITH DIVISION 26.
- MOUNT OUTLET INSIDE GCTC ENCLOSURE, COORDINATE WITH DIVISION 26 AND 28.
- 8. PROVIDE 36" X 36" COMMUNICATIONS PULL BOX FOR SERVICE PROVIDER CABLES.
- 9. PROVIDE 36" X 36" COMMUNICATIONS PULL BOX FOR AIRPORT DATA AND SECURITY COMMUNICATIONS CABLES.



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REVISIONS

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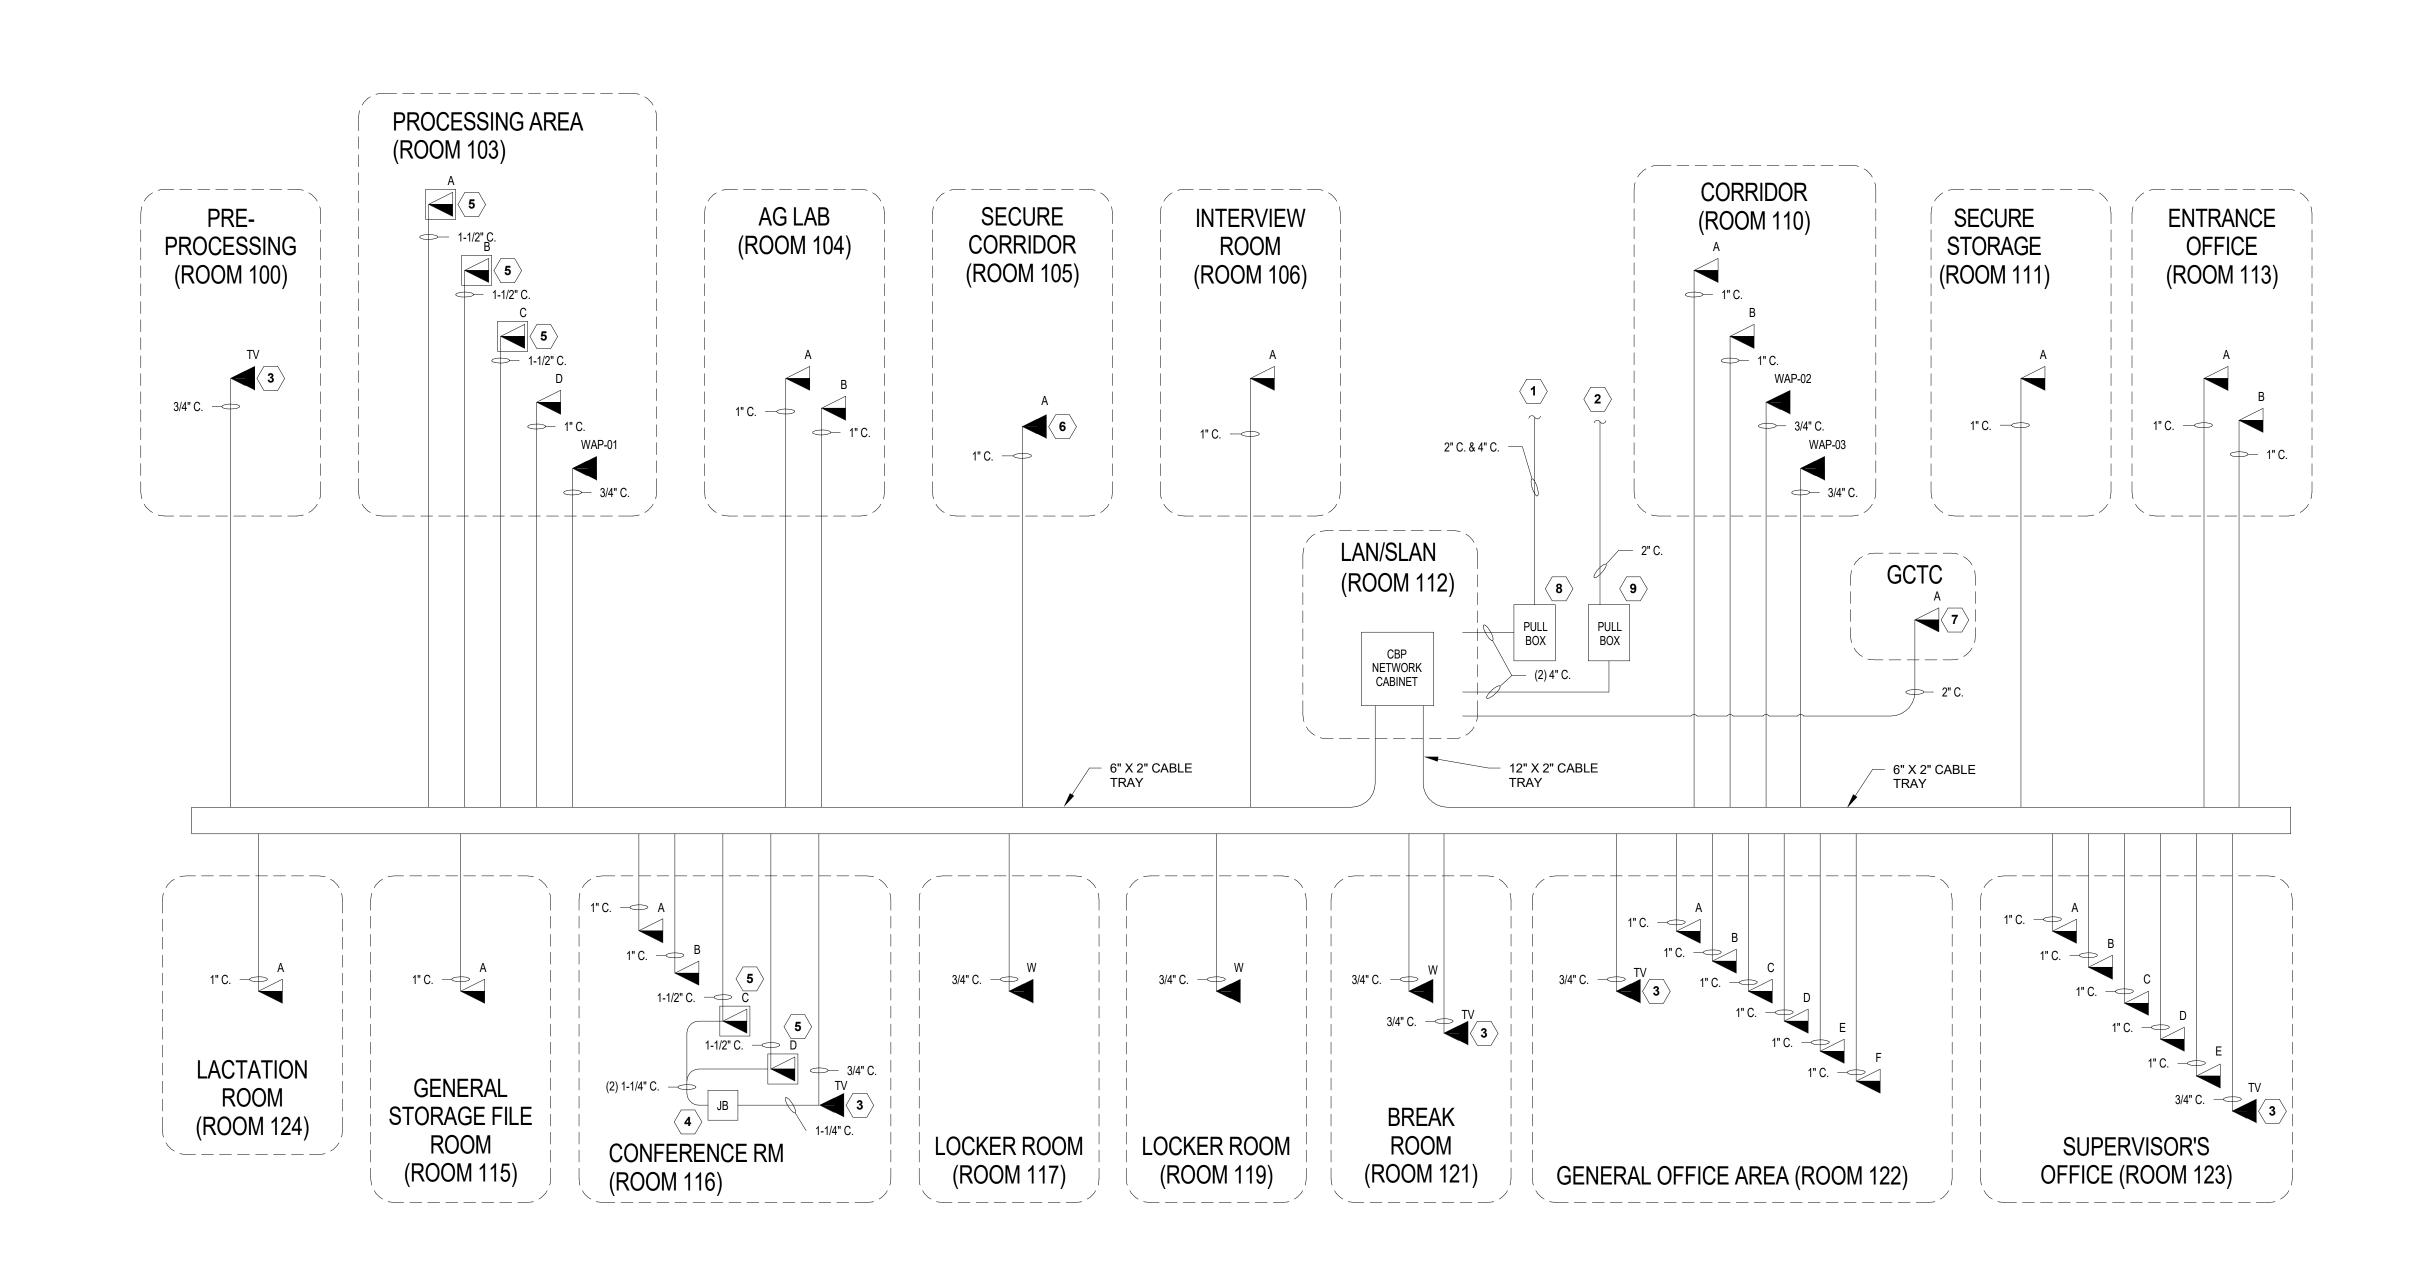
PROJECT NUMBER: 201-0052-002


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TELECOM RISER DIAGRAM

SHEET NUMBER

T703





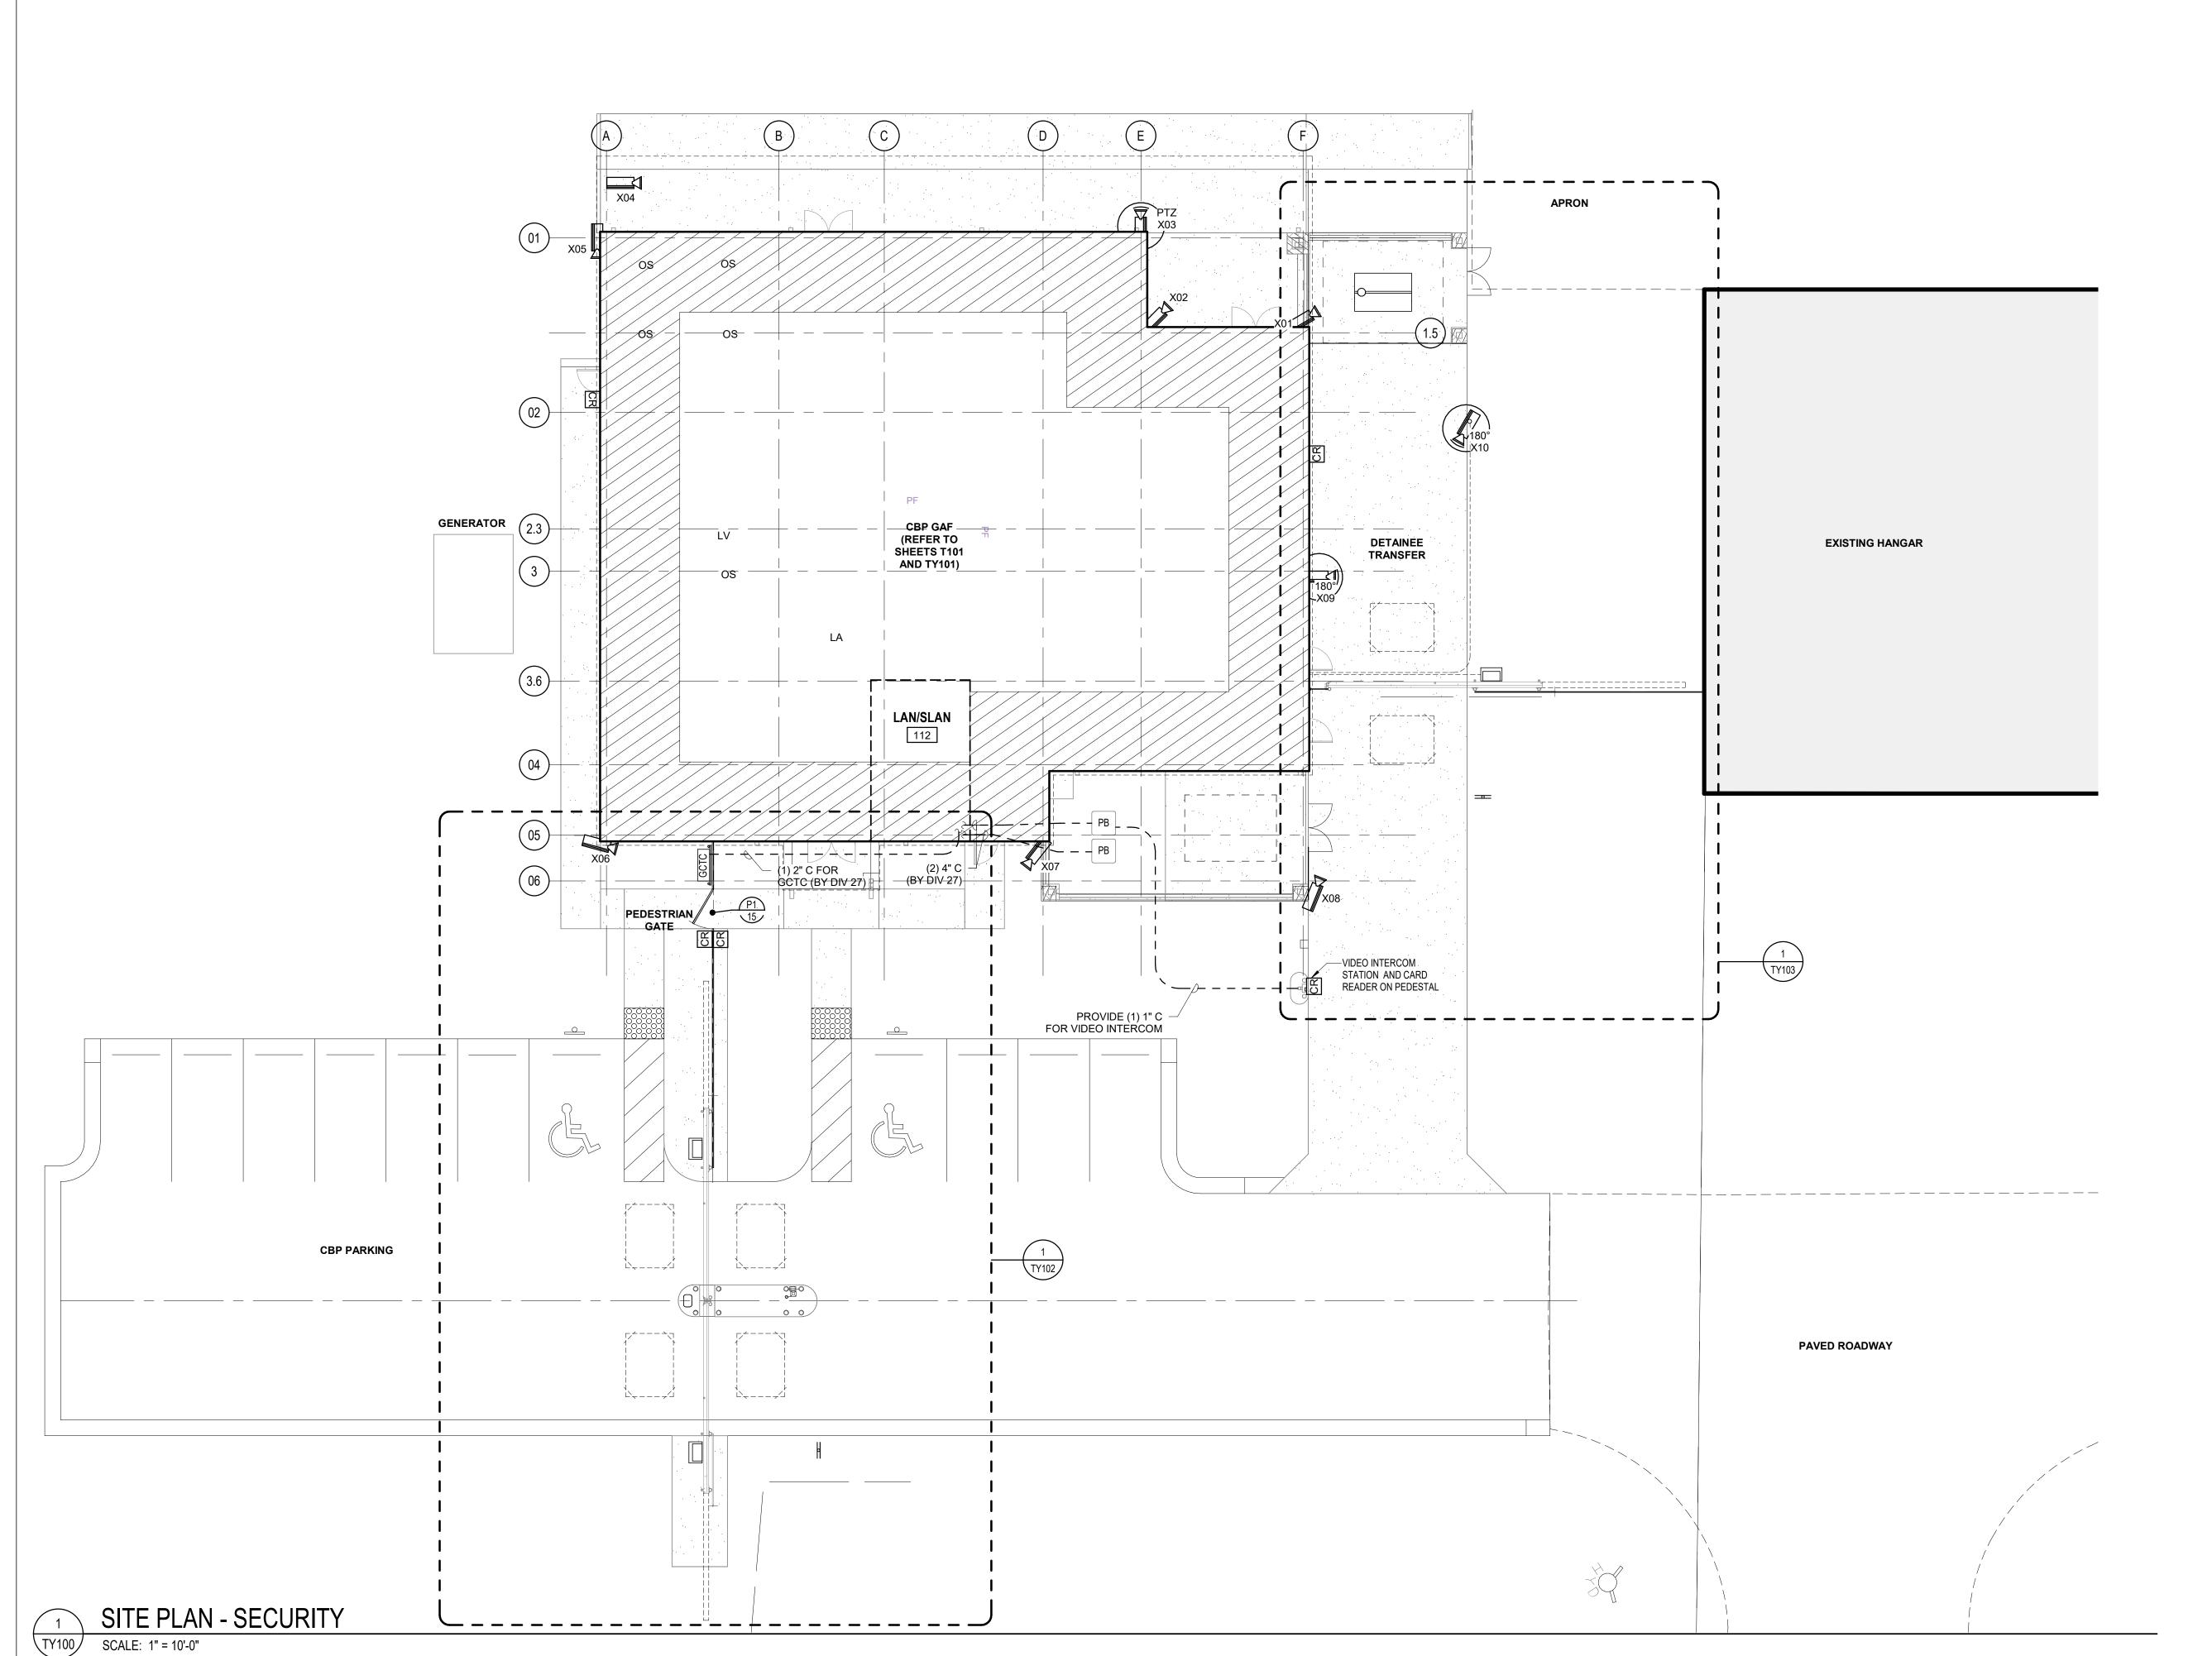

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FACILITY (GAF)



PROFESSIONAL SEAL



REVISIONS

 DATE ISSUED:
 03/03/2020

 REVIEWED BY:
 SVS

 DRAWN BY:
 VJM

 DESIGNED BY:
 RJF

 PROJECT NUMBER:

SECURITY SITE


PLAN

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SHEET TITLE

SHEET NUMBER

TY100



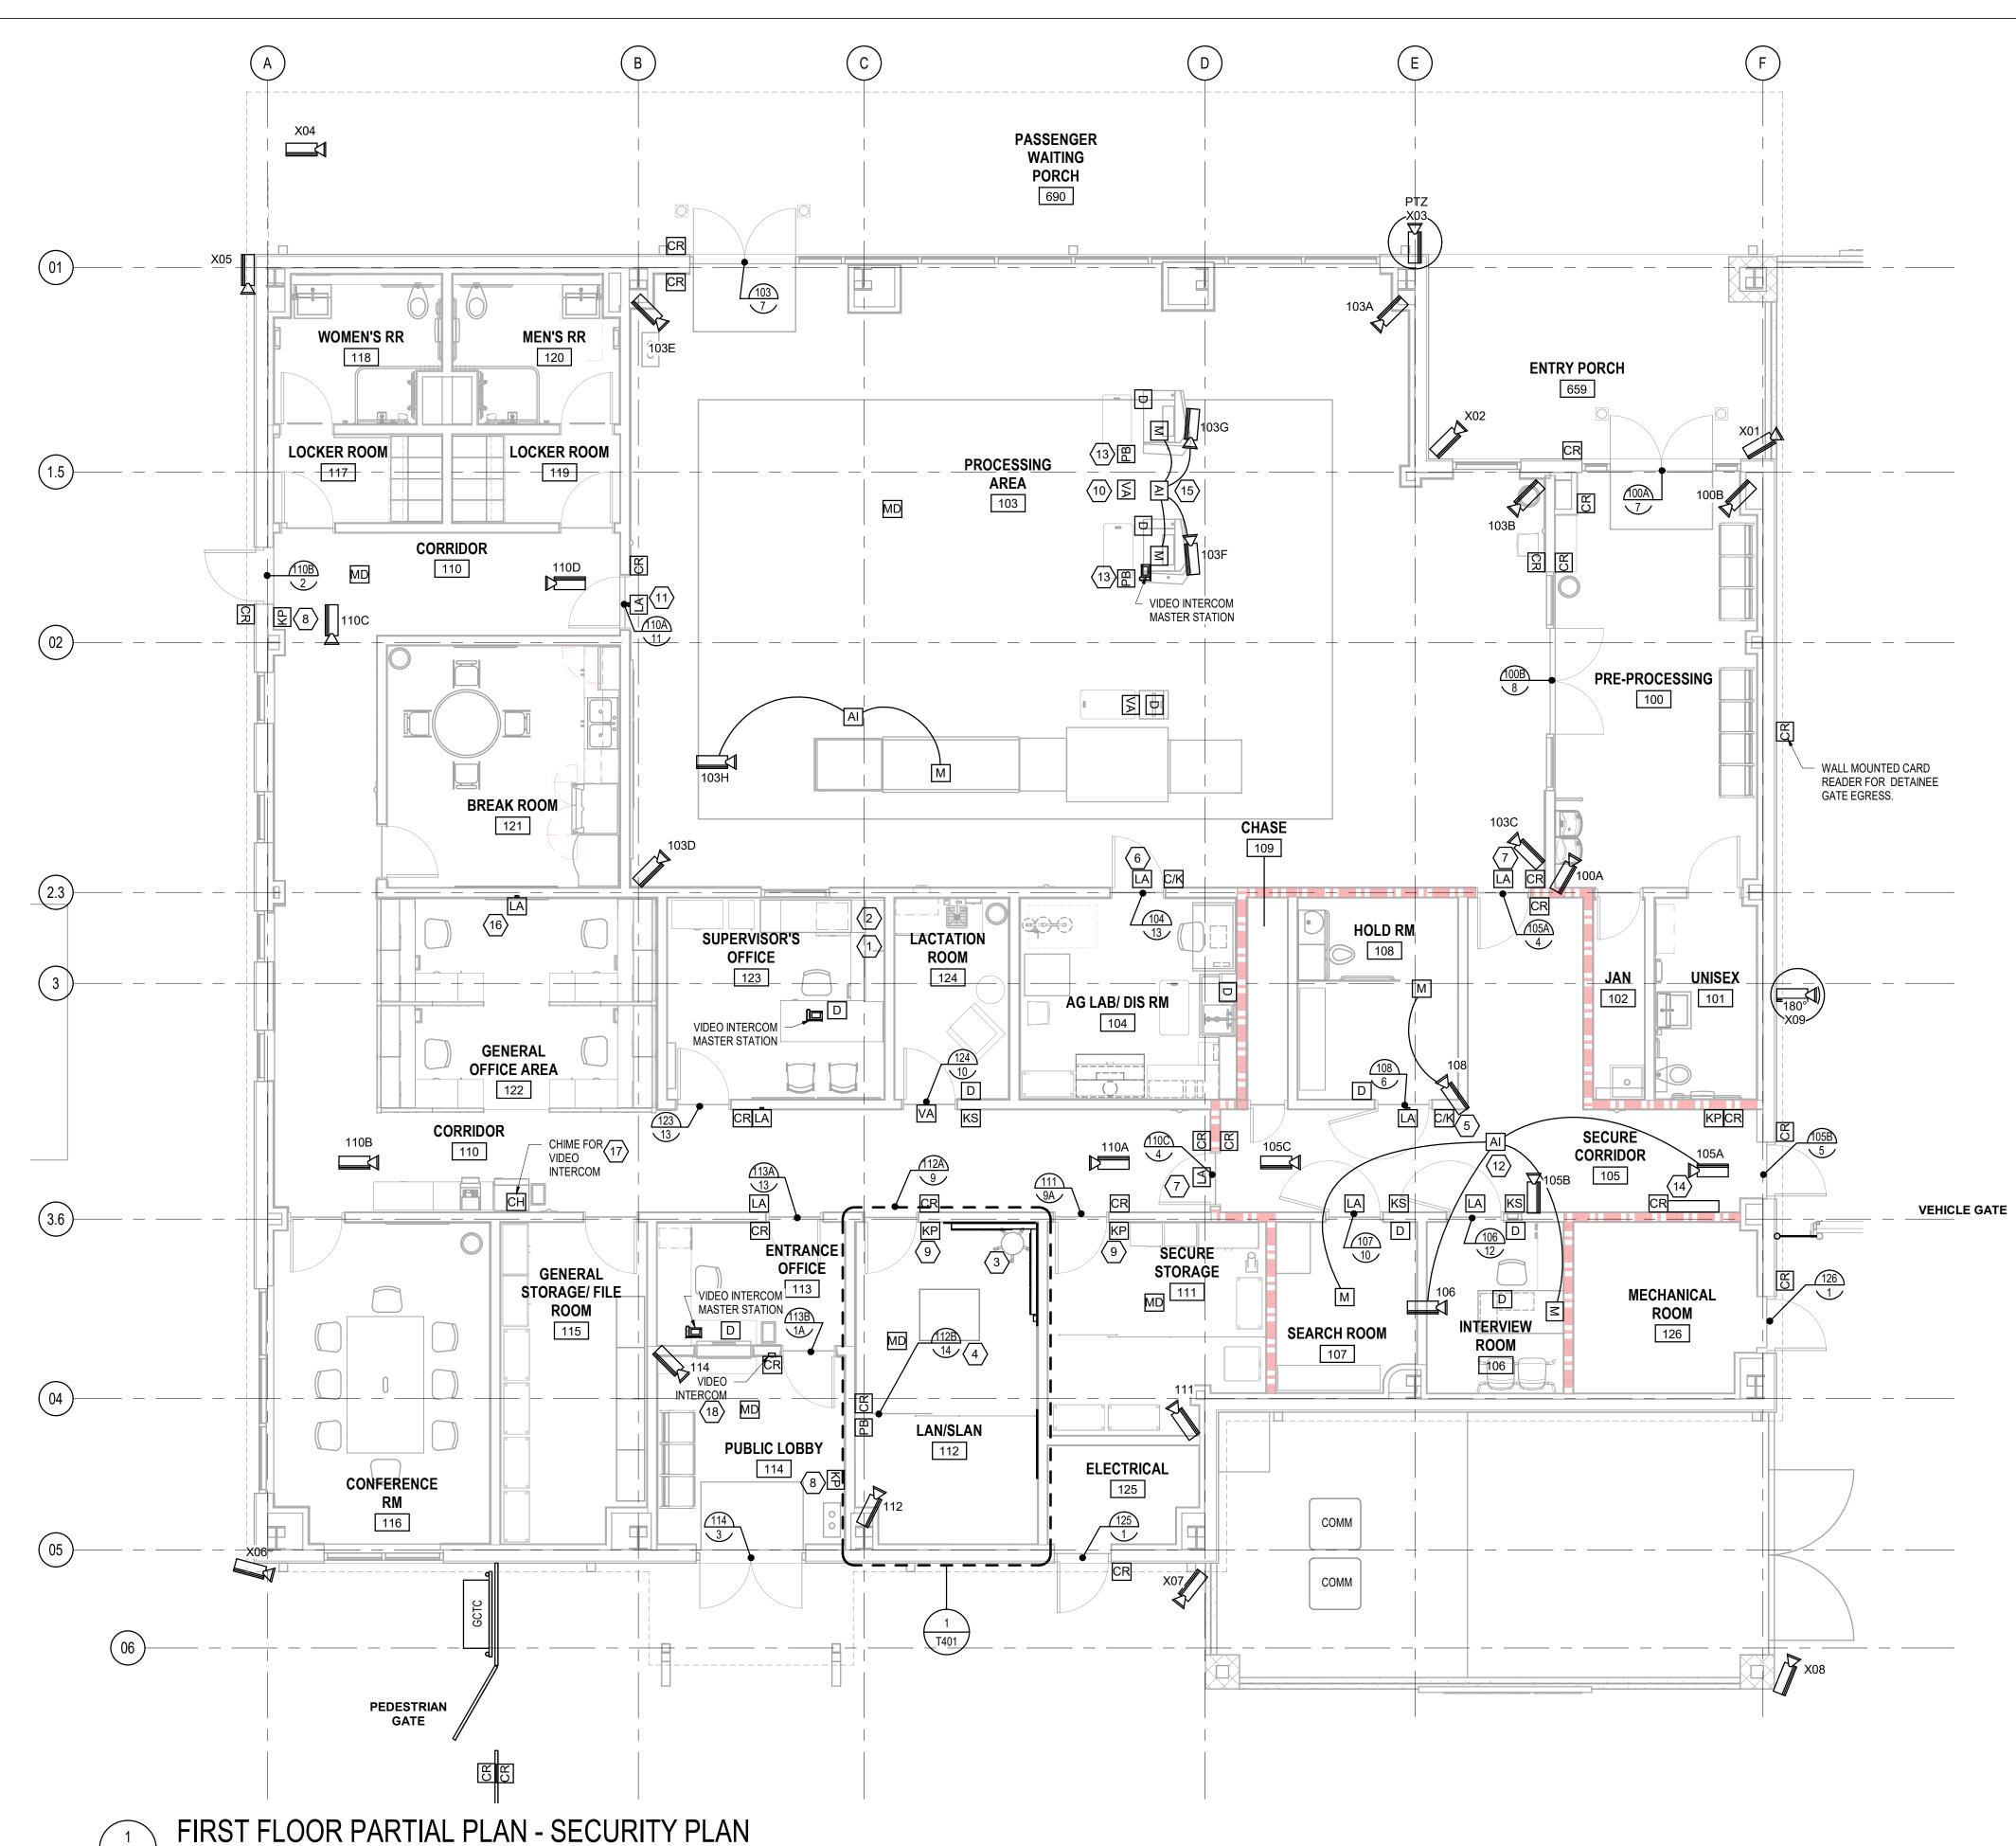

- 1. ACCESS CONTROL AND VIDEO MONITORING WORKSTATION WITH SPEAKERS.
- 2. PROVIDE REPORT PRINTER.
- 3. PROVIDE WALL MOUNTED ACCESS CONTROL PANELS, REFER TO SHEET T401 FOR DETAILS.
- 4. PROVIDE RACK MOUNTED VIDEO SURVEILLANCE EQUIPMENT, REFER TO SHEET T401 FOR DETAILS.
- 5. CARD READER FOR GUARD TOUR LOGGING. PROVIDE INDICATOR AND 15 MINUTE
- 6. HORN/STROBE DEVICE FOR AG LAB GRINDER DURESS BUTTON.
- 7. DUAL PURPOSE HORN/STROBE DEVICE FOR INTERVIEW ROOM, SEARCH ROOM AND HOLD ROOM DURESS BUTTONS AND TIME DELAY DOOR ALARM. STROBE WILL ACTIVATE WHEN ALARMS IN DETENTION SUITE ARE ACTIVATED.
- 8. KEY PAD TO ARM/DISARM THE CBP SPACE INTRUSION DETECTION ZONE.
- 9. KEY PAD TO ARM/DISARM THE ROOM'S INTRUSION DETECTION ZONE.

TIMER AS DESCRIBED IN CBP STANDARD.

- 10. CEILING MOUNTED VISUAL ANNUNCIATOR FOR PODIUM MOUNTED DURESS ALARM BUTTON. REFER TO DETAIL 2 ON SHEET TY506.
- 11. DUAL PURPOSE HORN/STROBE DEVICE FOR DURESS AND DOOR ALARM IN ADMIN
- 12. PROVIDE 12" X 12" X 6" JUNCTION BOX WITH LOCKABLE ACCESS COVER FLUSH MOUNTED IN CORRIDOR CEILING FOR CONDUITS TO CAMERAS. REFER TO CAMERA DETAILS TYPE D, F AND J ON SHEET TY507 AND TY508 AND INTERCONNECT DIAGRAM ON SHEET TY702. COORDINATE WITH ARCHITECTURAL REFLECTED CEILING, REFER TO SHEET A121.
- 13. DOOR RELEASE PUSH BUTTONS FOR DOOR 100B AND 103 MOUNTED IN PODIUM CASEWORK. REFER TO DOOR TYPES 7 AND 8 ON SHEET TY502 AND TY503 AND DETAIL 1 ON SHEET TY505.
- 14. DETENTION GRADE HOUSING FOR DETAINEE TRANSFER GATE AND CARD READER FOR GATE OPEN/CLOSE COMMAND, REFER TO DETAIL ON SHEET T502
- 15. PROVIDE 12" X 12" X 6" JUNCTION BOX MOUNTED ABOVE SUSPENDED CEILING FOR AUDIO INTERFACE UNITS TO CAMERAS, REFER TO CAMERA TYPE B ON SHEET TY507 AND INTERCONNECT DIAGRAM ON SHEET TY702 (REFER TO DETAIL 3 ON SHEET
- 16. STROBE WILL ACTIVATE WHEN DOOR OR DURESS ALARMS IN DETENTION SUITE, PROCESSING AREA, OR THE ADMIN SUITE ARE ACTIVATED. COORDINATE MOUNTING LOCATION WITH CBP.
- 17. PROVIDE WALL MOUNTED CHIME FOR SECURITY VIDEO INTERCOM. REFER TO SECURITY FLOOR PLAN AND INTERCONNECT DIAGRAM FOR ADDITIONAL INFORMATION. COORDINATE MOUNTING LOCATION WITH CBP.
- 18. VIDEO INTERCOM SHALL SIMULTANEOUSLY CALL ENTRANCE OFFICE, SUPERVISOR'S OFFICE, INSPECTION PODIUM MASTER STATIONS AND SOUND CHIME IN GENERAL OFFICE.



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DATE ISSUED: 03/03/2020 **REVIEWED BY:** VJMDRAWN BY: RJF **DESIGNED BY:**


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FIRST FLOOR **PARTIAL PLAN -SECURITY PLAN**

SHEET NUMBER

TY101



KEYED NOTES:

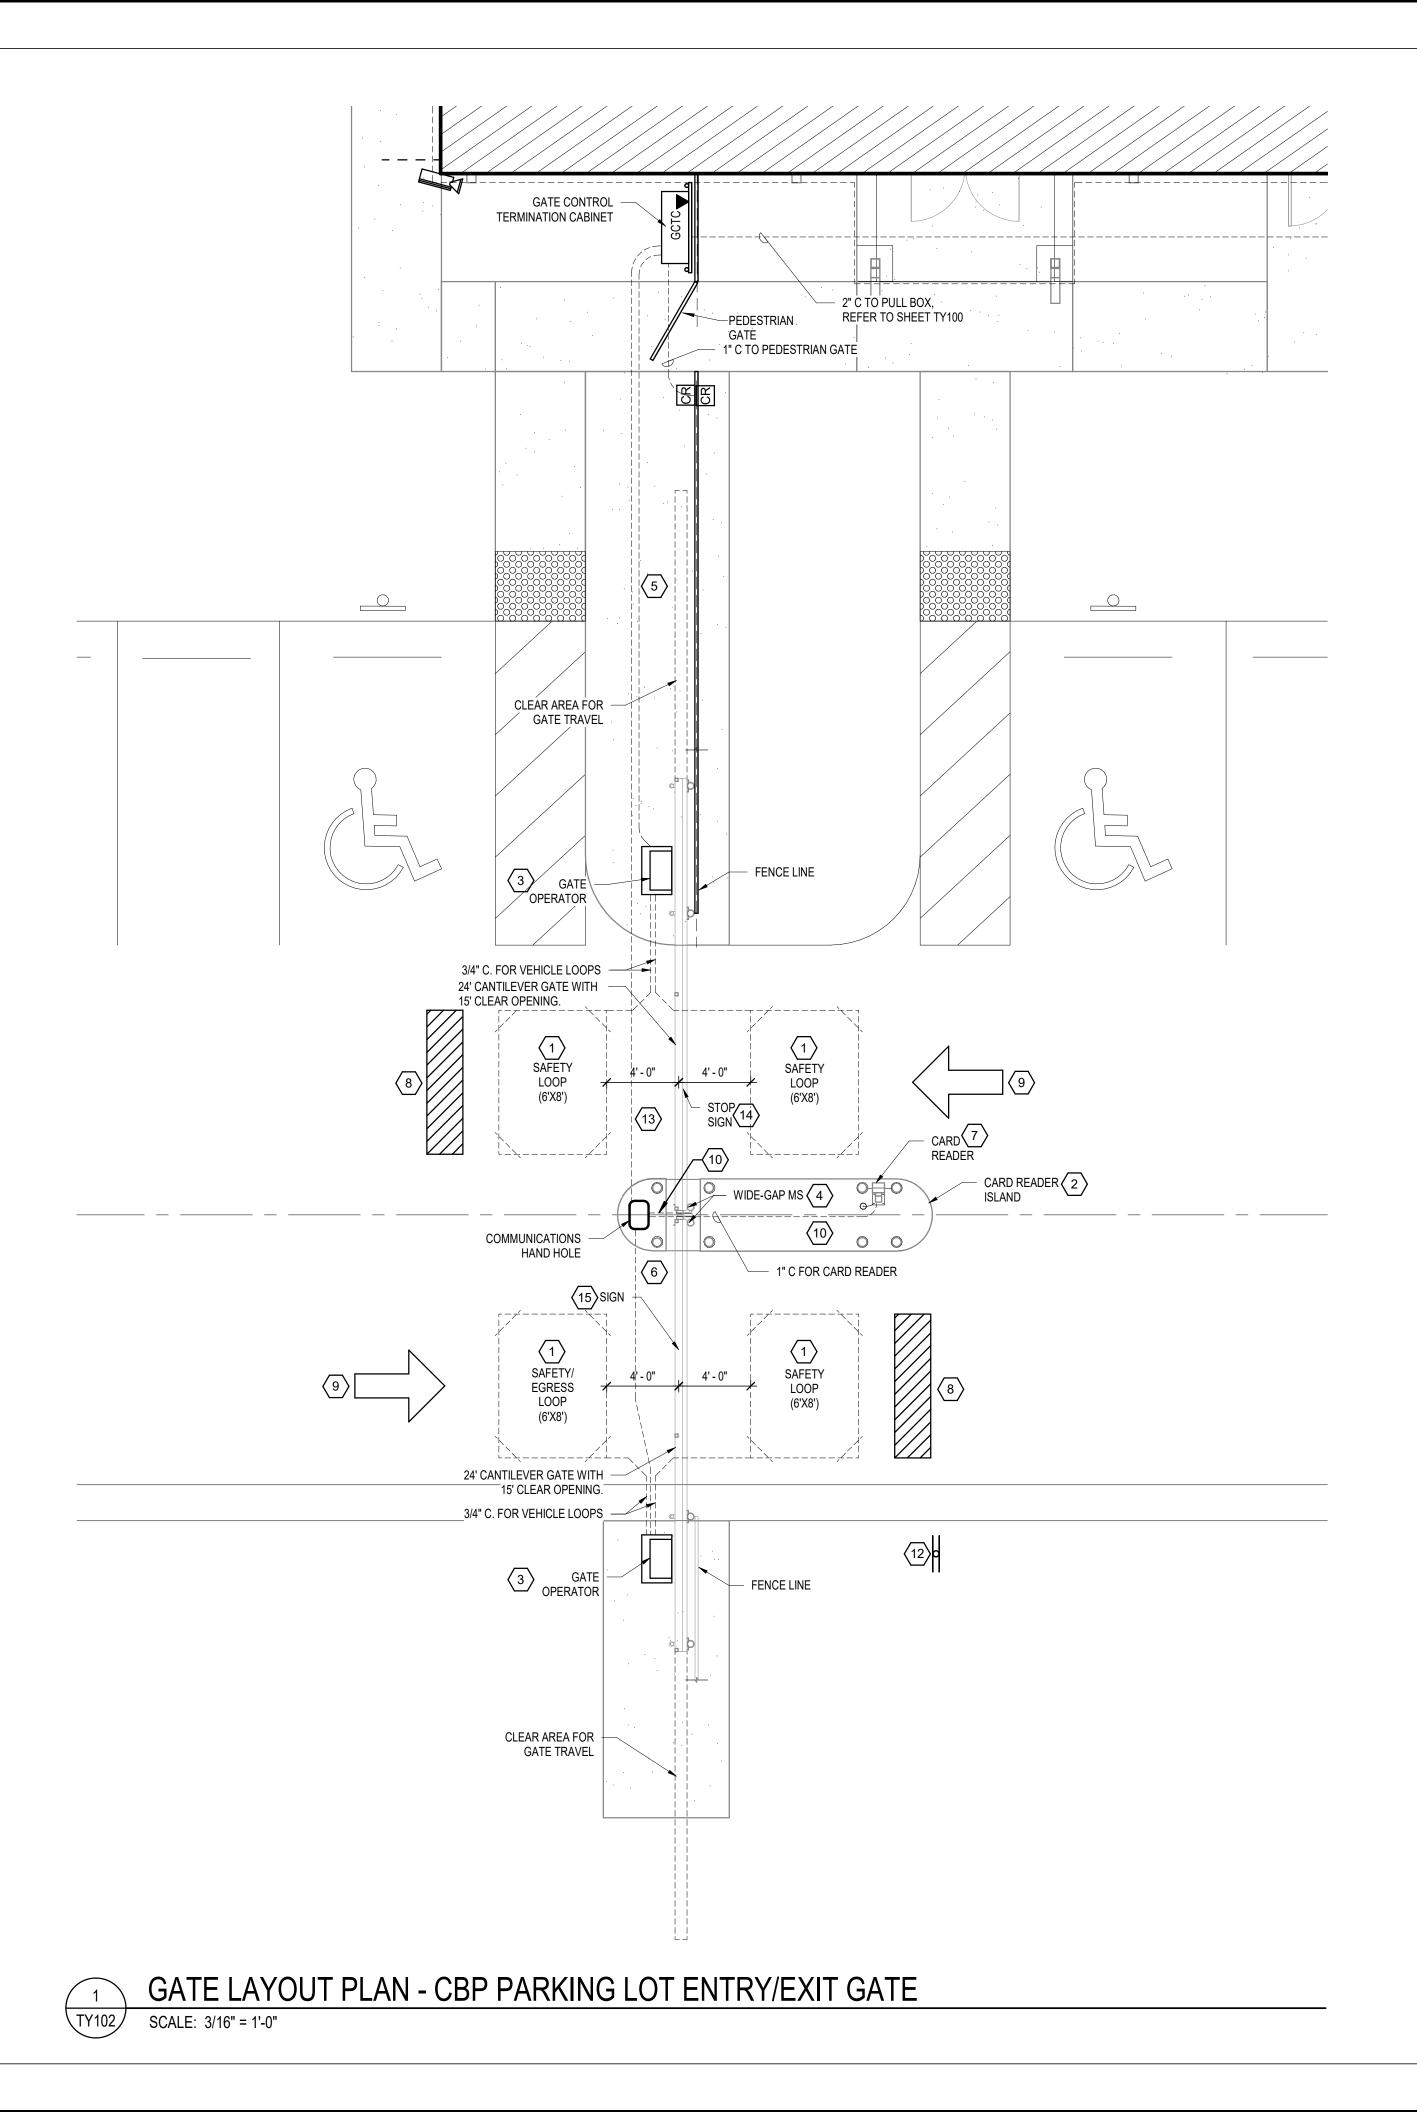- 1. PROVIDE IN-GROUND VEHICLE DETECTION LOOP, REFER TO DETAIL 3 ON SHEET TY511 FOR ADDITIONAL INFORMATION.
- 2. PROVIDE CARD READER ISLAND AND BOLLARDS, REFER TO DETAIL 1 ON SHEET TY510 FOR ADDITIONAL INFORMATION.
- 3. PROVIDE GATE OPERATOR WITH HYDRAULIC MOTOR AND ALUMINUM
- DRIVE RAIL, REFER TO DETAIL 1 AND 2 ON SHEET TY509.
- 4. PROVIDE WIDE-GAP MAGNETIC SWITCH TO MONITOR GATE POSITION, REFER TO DETAIL 1 ON SHEET TY509.
- 6. ONE (1) 1-1/2" BURIED PVC CONDUIT TO EXIT LANE GATE OPERATOR.
- 7. PROVIDE CARD READER MOUNTED TO PEDESTAL, REFER TO DETAIL 2 ON SHEET TY510 FOR ADDITIONAL INFORMATION.

5. ONE (1) 1-1/2" BURIED PVC CONDUIT TO ENTRY LANE GATE OPERATOR.

- 8. 2' x 8' PAINTED STRIPE. REFER TO DETAIL 4 ON SHEET TY509.
- 9. ARROW REPRESENTS DIRECTION OF TRAFFIC FLOW (NOT A PAINTED
- 10. ONE (1) 3/4" BURIED PVC CONDUIT TO ENTRY LANE CARD READER.
- 11. ONE (1) 1" BURIED PVC CONDUIT TO WEATHER PROOF JUNCTION BOX FOR WIDE-GAP MAGNETIC SWITCHES.
- 12. PROVIDE SIGN THAT READS "PULL BEYOND PAINTED STRIPE AND WAIT FOR GATE TO CLOSE" AND "DO NOT ENTER WRONG WAY". REFER TO DETAIL 4 ON SHEET TY511 AND DETAIL 5 ON SHEET TY510.
- 13. ONE (1) 1-1/2" BURIED PVC CONDUIT BETWEEN GCTC AND SECURITY HAND HOLE.
- 14. PROVIDE STOP SIGN MOUNTED TO GATE. REFER TO DETAIL 4 ON SHEET TY510.
- 15. PROVIDE SIGN THAT READS "APPROACH SLOWLY GATE WILL OPEN" MOUNTED TO GATE. REFER TO DETAIL 5 ON SHEET TY511.

SEQUENCE OF OPERATION: CBP PARKING GATE

- 1. INITIALLY THE GATE WILL BE CLOSED, THE GATE SHALL BE SECURED VIA THE AUTOMATED SLIDING GATE
- 2. TO ENTER, UPON A VALID CARD READ (AND PIN CODE ENTRY WHERE REQUIRED), THE ACS SHALL SIGNAL THE
- GATE TO OPEN AND THE WIDE-GAP MS SHALL BE SHUNTED FOR A (USER DEFINED) PERIOD OF TIME. 3. THE GATE WILL REMAIN OPEN FOR A PROGRAMMABLE PERIOD OF TIME, ALLOWING THE VEHICLE TO PROCEED THROUGH THE GATE. AFTER THE GATE OPEN TIME EXPIRES (PROGRAMMED IN THE GATE
- OPERATOR), THE GATE WILL ATTEMPT TO CLOSE. 4. AS A SAFETY FEATURE, THE GATE WILL NOT CLOSE AS LONG AS ONE OR BOTH OF THE SAFETY LOOPS ADJACENT TO THE GATE DETECT A METAL OBJECT OR SAFETY EDGE IS TRIGGERED. IF THE VEHICLE HAS NOT PROCEEDED BEYOND THE LOOP THE TIMER SHALL RESET EVERY TEN (10) SECONDS AND CHECK AGAIN
- FOR A METAL OBJECT OR OBSTRUCTION UNTIL THE GATE CLOSES. 5. VEHICLE OPERATORS WILL BE INSTRUCTED TO STOP PAST THE STRIPED LINE (STOP BAR) BEYOND THE SAFETY LOOP UNTIL THE GATE FULLY CLOSES BEHIND THEM TO PREVENT TAILGATERS (VEHICLES
- ATTEMPTING TO ENTER BEHIND WITHOUT PRESENTING A VALID CARD). 6. UPON CLOSURE OF THE GATE SENSED BY THE WIDE-GAP MAGNETIC CONTACT, THE GATE SHALL BE SECURE.

VEHICLE GATE EXIT

- 1. INITIALLY THE GATE WILL BE CLOSED, THE GATE SHALL BE SECURED VIA THE AUTOMATED SLIDING GATE OPERATOR. THE GATE WILL ALLOW EGRESS UPON ACTIVATION OF THE VEHICLE DETECTION LOOP.
- 2. A VEHICLE THAT APPROACHES THE GATE WILL ACTIVATE THE EGRESS/SAFETY LOOP SENDING A SIGNAL THE ACS. THE WIDE-GAP MS SHALL BE SHUNTED FOR A USER-DEFINED PERIOD OF TIME AND A SIGNAL FROM THE ACS SHALL CAUSE THE GATE OPERATOR TO OPEN THE GATE FOR A PREPROGRAMMED PERIOD OF TIME.
- 3. THE GATE WILL REMAIN OPEN FOR A PROGRAMMABLE PERIOD OF TIME, ALLOWING THE VEHICLE TO PROCEED THROUGH THE GATE. AFTER THE GATE OPEN TIME EXPIRES (PROGRAMMED IN THE GATE OPERATOR), THE GATE WILL ATTEMPT TO CLOSE
- 4. AS A SAFETY FEATURE, THE GATE WILL NOT CLOSE AS LONG AS ONE OR BOTH OF THE SAFETY LOOPS ADJACENT TO THE GATE DETECT A METAL OBJECT OR SAFETY EDGE IS TRIGGERED. IF THE VEHICLE HAS NOT PROCEEDED BEYOND THE LOOP THE TIMER SHALL RESET EVERY TEN (10) SECONDS AND CHECK AGAIN
- FOR A METAL OBJECT OR OBSTRUCTION UNTIL THE GATE CLOSES. 5. VEHICLE OPERATORS WILL BE INSTRUCTED TO STOP PAST THE STRIPED LINE (STOP BAR) BEYOND THE SAFETY LOOP UNTIL THE GATE FULLY CLOSES BEHIND THEM TO PREVENT UNAUTHORIZED VEHICLES FROM
- 6. UPON CLOSURE OF THE GATE SENSED BY THE WIDE-GAP MAGNETIC CONTACT, THE GATE SHALL BE SECURE.

- 1. A FIXED CAMERA WILL PROVIDE A FULL VIEW OF THE GATE AREA. THE CAMERA MAY BE VIEWED ON AN ACS/VMS WORKSTATION.
- PRESENTING AN INVALID CARD SHALL NOT OPEN THE GATE AND THE EVENT WILL BE LOGGED BY THE ACS. 3. UNAUTHORIZED OPERATION OF THE GATE SENSED BY THE WIDE-GAP MS, SUCH AS MANUALLY OPENING THE GATE, SHALL ACTIVATE A DOOR FORCED ALARM. AN ALARM SHALL BE SENT TO THE ALARM MONITORING
- 4. PERSONS WITH BADGE READ ERRORS OR WHO DO NOT HAVE THEIR BADGE MAY PARK IN THE PUBLIC
- PARKING AND PROCEED TO THE INTERCOM STATION IN THE LOBBY FOR ASSISTANCE. 5. THE ALARM MONITORING WORKSTATION LOCATED IN THE SUPERVISORS OFFICE WILL BE CAPABLE OF
- REMOTELY OPERATING ANY GATE, DOOR OR CAMERA CONTROLLED BY THE SYSTEM.
- 6. THE FINAL SEQUENCE OF OPERATION FOR ALL GATES, CAMERA VIEW AND ALARM CUE-UP SHALL BE COORDINATED WITH AND APPROVED BY CBP.
- 7. AN EDGE SENSOR INSTALLED ON THE LEADING EDGE OF THE GATE PANEL SHALL BE CONNECTED TO THE GATE OPERATOR VIA A WIRELESS TRANSMITTER/RECEIVER. UPON ACTIVATION OF THE SENSING EDGE THE GATE OPERATOR SHALL BE SIGNALED TO REVERSE THE DIRECTION OF TRAVEL.



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DATE	ISSUED:	03/03/202
REVIE	WED BY:	SV
DRAW	N BY:	VJI
DESIG	NED BY:	RJ


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SHEET TITLE

ENLARGED PLAN CBP GATE

SHEET NUMBER

TY102

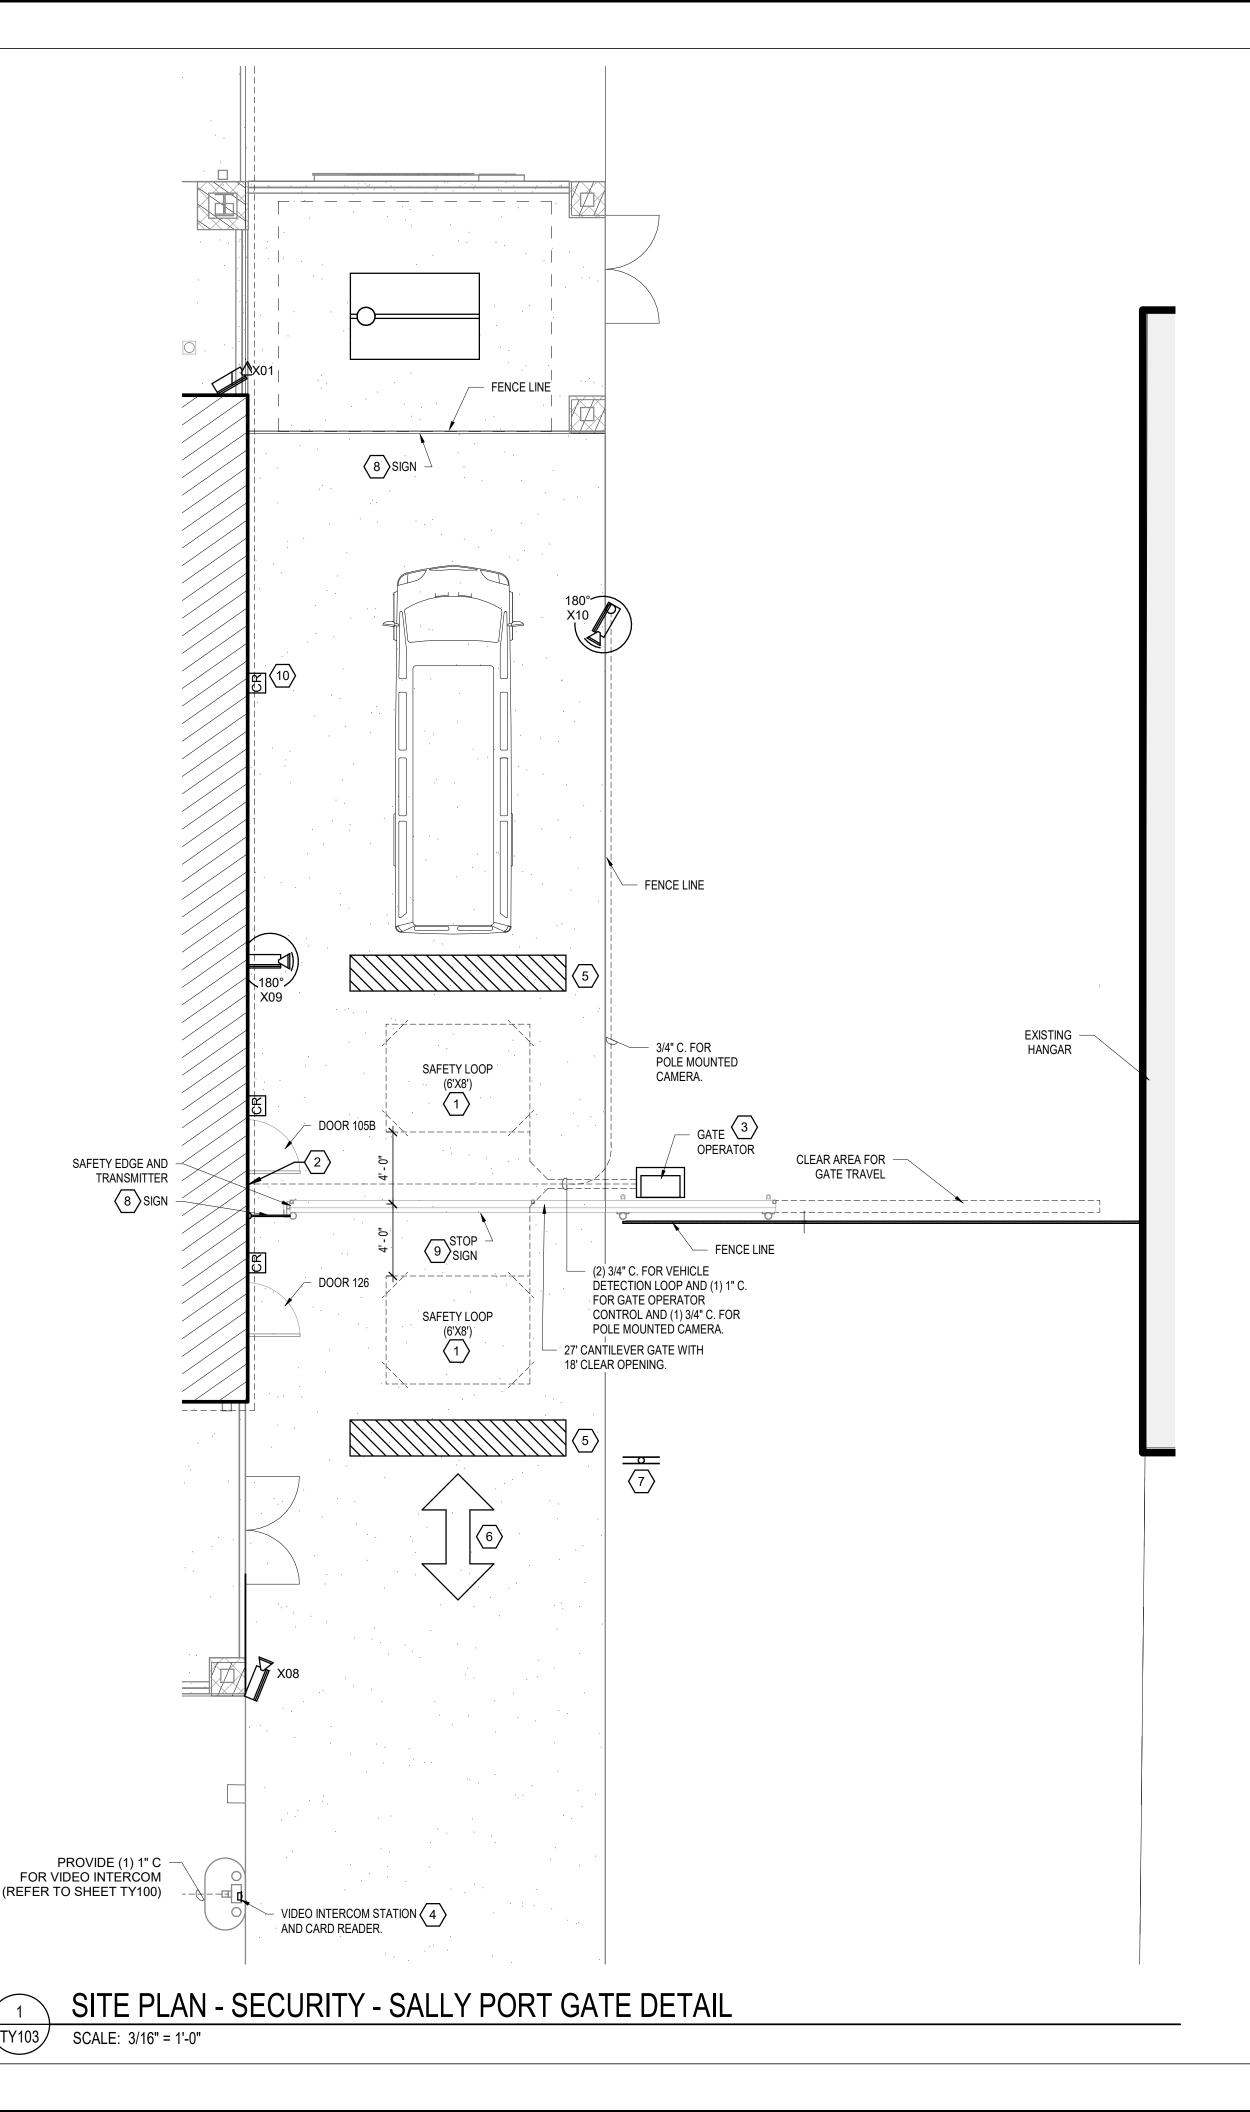

KEYED NOTES:

ADDITIONAL INFORMATION.

- 1. PROVIDE IN-GROUND VEHICLE DETECTION LOOP, REFER TO DETAIL 3 ON SHEET TY511 FOR ADDITIONAL INFORMATION.
- 2. ROUTE GATE OPERATOR CONTROL CAMERA AND POLE MOUNTED CAMERA CONDUITS INTO BUILDING AND CONNECT TO KS BACK BOX FOR ROUTING TO ACS PANEL.
- 3. PROVIDE GATE OPERATOR WITH HYDRAULIC MOTOR AND ALUMINUM
- DRIVE RAIL, REFER TO DETAIL 1 AND 2 ON SHEET TY509. 4. PROVIDE VIDEO INTERCOM AND CARD READER MOUNTED TO PEDESTAL, REFER TO DETAILS 1 AND 2 ON SHEET TY511 FOR
- 5. 2' x 8' PAINTED STRIPE. REFER TO DETAIL 4 ON SHEET TY509.
- 6. ARROW REPRESENTS DIRECTION OF TRAFFIC FLOW (NOT A PAINTED
- 7. PROVIDE SIGN THAT READS "PULL AHEAD OF PAINTED STRIPE AND WAIT FOR GATE TO CLOSE". REFER TO DETAIL 4 ON SHEET TY511.
- 8. PROVIDE SIGN THAT READS "BACKUP SLOWLY". REFER TO DETAIL 5 ON
- 9. PROVIDE STOP SIGN MOUNTED TO GATE. REFER TO DETAIL 4 ON
- 10. PROVIDE WALL MOUNTED CARD READER FOR GATE EGRESS, REFER TO DETAIL 6 ON SHEET TY506 FOR ADDITIONAL INFORMATION.

SEQUENCE OF OPERATION: DETAINEE TRANSFER GATE

VEHICLE GATE ENTRY

1. INITIALLY THE GATE WILL BE CLOSED, THE GATE SHALL BE SECURED VIA THE AUTOMATED SLIDING GATE

- 2. TO OPEN THE GATE FOR ENTRY, A BADGED PERSON MAY USE THE PEDESTAL MOUNTED CARD READER, THE WALL MOUNTED CARD READER INSIDE THE DETAINEE TRANSFER AREA OR THE DESIGNATED CARD READER IN THE DETENTION CORRIDOR. AN UNBADGED DRIVER WILL USE THE PEDESTAL MOUNTED VIDEO INTERCOM STATION TO CONTACT CBP. THE INTERCOM SYSTEM SHALL BE INTERFACED WITH THE ACS TO SIGNAL THE
- 3. A WALL MOUNTED MONITOR IN THE DETENTION CORRIDOR SHALL ALLOW CBP TO OBSERVE THE GATE AREA. . UPON A VALID CARD READ (AND PIN CODE ENTRY WHERE REQUIRED) OR A SIGNAL FROM THE INTERCOM SYSTEM, THE ACS SHALL SIGNAL THE GATE TO OPEN AND THE WIDE-GAP MS SHALL BE SHUNTED FOR A (USER DEFINED) PERIOD OF TIME.
- 5. THE GATE WILL REMAIN OPEN FOR A PROGRAMMABLE PERIOD OF TIME, ALLOWING THE VEHICLE TO PROCEED THROUGH THE GATE. AFTER THE GATE OPEN TIME EXPIRES (PROGRAMMED IN THE GATE OPERATOR) OR UPON COMMAND FROM THE ACS, THE GATE WILL ATTEMPT TO CLOSE.
- 6. AS A SAFETY FEATURE, THE GATE WILL NOT CLOSE AS LONG AS THE SAFETY LOOP ADJACENT TO THE GATE DETECTS A METAL OBJECT OR SAFETY EDGE IS TRIGGERED. IF THE VEHICLE HAS NOT PROCEEDED BEYOND THE LOOP, THE TIMER SHALL RESET EVERY TEN (10) SECONDS AND CHECK AGAIN FOR A METAL OBJECT OR OBSTRUCTION UNTIL THE GATE CLOSES.
- 7. VEHICLE OPERATORS WILL BE INSTRUCTED TO STOP PAST THE STRIPED LINE (STOP BAR) BEYOND THE IN-GROUND VEHICLE DETECTION LOOPS TO ALLOW THE GATE TO CLOSE BEHIND THEM.
- VEHICLE GATE EXIT 1. INITIALLY THE GATE WILL BE CLOSED, THE GATE SHALL BE SECURED VIA THE AUTOMATED SLIDING GATE
- 2. TO OPEN THE GATE FOR EGRESS, A BADGED PERSON MAY USE THE WALL MOUNTED CARD READER INSIDE THE DETAINEE TRANSFER AREA OR THE DESIGNATED CARD READER IN THE DETENTION CORRIDOR.
- 3. A WALL MOUNTED MONITOR IN THE DETENTION CORRIDOR SHALL ALLOW CBP TO OBSERVE THE GATE AREA. 4. UPON A VALID CARD READ (AND PIN CODE ENTRY WHERE REQUIRED), THE ACS SHALL SIGNAL THE GATE TO OPEN AND THE WIDE-GAP MS SHALL BE SHUNTED FOR A (USER DEFINED) PERIOD OF TIME.
- 5. THE GATE WILL REMAIN OPEN FOR A PROGRAMMABLE PERIOD OF TIME, ALLOWING THE VEHICLE TO PROCEED THROUGH THE GATE. AFTER THE GATE OPEN TIME EXPIRES (PROGRAMMED IN THE GATE
- OPERATOR), THE GATE WILL ATTEMPT TO CLOSE. 6. AS A SAFETY FEATURE. THE GATE WILL NOT CLOSE AS LONG AS ONE OR BOTH OF THE SAFETY LOOPS ADJACENT TO THE GATE DETECT A METAL OBJECT OR SAFETY EDGE IS TRIGGERED. IF THE VEHICLE HAS NOT PROCEEDED BEYOND THE LOOP THE TIMER SHALL RESET EVERY TEN (10) SECONDS AND CHECK AGAIN
- FOR A METAL OBJECT OR OBSTRUCTION UNTIL THE GATE CLOSES. 7. VEHICLE OPERATORS WILL BE INSTRUCTED TO STOP PAST THE STRIPED LINE (STOP BAR) BEYOND THE SAFETY LOOP UNTIL THE GATE FULLY CLOSES BEHIND THEM TO PREVENT UNAUTHORIZED VEHICLES FROM

- 1. FIXED 180° CAMERAS WILL PROVIDE A FULL VIEW OF THE GATE AREA. THE CAMERAS MAY BE VIEWED ON A
- WALL MOUNTED MONITOR IN THE DETENTION CORRIDOR OR AN ACS/VMS WORKSTATION. 2. AN EDGE SENSOR INSTALLED ON THE LEADING EDGE OF THE GATE PANEL SHALL BE CONNECTED TO THE GATE OPERATOR VIA A WIRELESS TRANSMITTER/RECEIVER. UPON ACTIVATION OF THE SENSING EDGE THE
- GATE OPERATOR SHALL BE SIGNALED TO REVERSE THE DIRECTION OF TRAVEL. 3. UNAUTHORIZED OPERATION OF THE GATE SENSED BY THE WIDE-GAP MS, SUCH AS MANUALLY OPENING THE GATE, SHALL ACTIVATE A DOOR FORCED ALARM. AN ALARM SHALL BE SENT TO THE ALARM MONITORING
- 4. THE ALARM MONITORING WORKSTATION LOCATED IN THE SUPERVISORS OFFICE WILL BE CAPABLE OF REMOTELY OPERATING ANY GATE, DOOR OR CAMERA CONTROLLED BY THE SYSTEM.
- 5. THE FINAL SEQUENCE OF OPERATION FOR ALL GATES, CAMERA VIEWS AND ALARM CUE-UP SHALL BE COORDINATED WITH AND APPROVED BY CBP.



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PENSACOLA INTERNATIONAL AIRPORT

PENSACOLA, FLORIDA

PENSACOLA GENERAL AVIATION FACILITY (GAF)



PROFESSIONAL SEAL



DESCRIPTION	DATE
	DESCRIPTION

DATE ISSUED: 03/03/2020 SVS REVIEWED BY: DRAWN BY: VJMRJF **DESIGNED BY:**

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SHEET TITLE

ENLARGED PLAN DETENTION GATE

SHEET NUMBER


TY103

- 1. THE DOOR SHALL BE SECURED VIA THE ELECTRIC LOCK. THE LOCK SHALL FAIL SECURE ON BOTH SIDES. 2. TO ENTER OR EXIT, UPON A VALID CARD READ (AND PIN CODE ENTRY WHERE REQUIRED), THE ACS SHALL SIGNAL THE LOCK TO OPEN AND THE DPS SHALL BE SHUNTED FOR A (USER DEFINED) PERIOD OF TIME.
- 3. AFTER A VALID ENTRY, WHEN THE UNLOCK TIME EXPIRES, THE DPS SHALL BE ACTIVATED. UNAUTHORIZED OPERATION OF THE DOOR SENSED BY THE DPS SHALL ACTIVATE A DOOR FORCED ALARM OR A DOOR HELD OPEN ALARM IF THE DOOR IS NOT PROPERLY CLOSED. THE ACS SHALL SEND AN ALARM SIGNAL TO THE MONITORING WORKSTATION. THE ALARM MUST BE CLEARED FROM THE MONITORING WORKSTATION IN THE SUPERVISOR'S
- 4. THE ACS SHALL ACTIVATE THE LOCAL ALARM DEVICE WHEN A DURESS BUTTON WITHIN THE DETENTION SUITE IS ACTIVATED. THE ALARM SHALL BE RESET BY THE KEYSWITCH ASSOCIATED WITH THE ACTIVE DEVICE.

\TY501/

SECURITY DOOR - TYPE 4


SCALE: N.T.S.

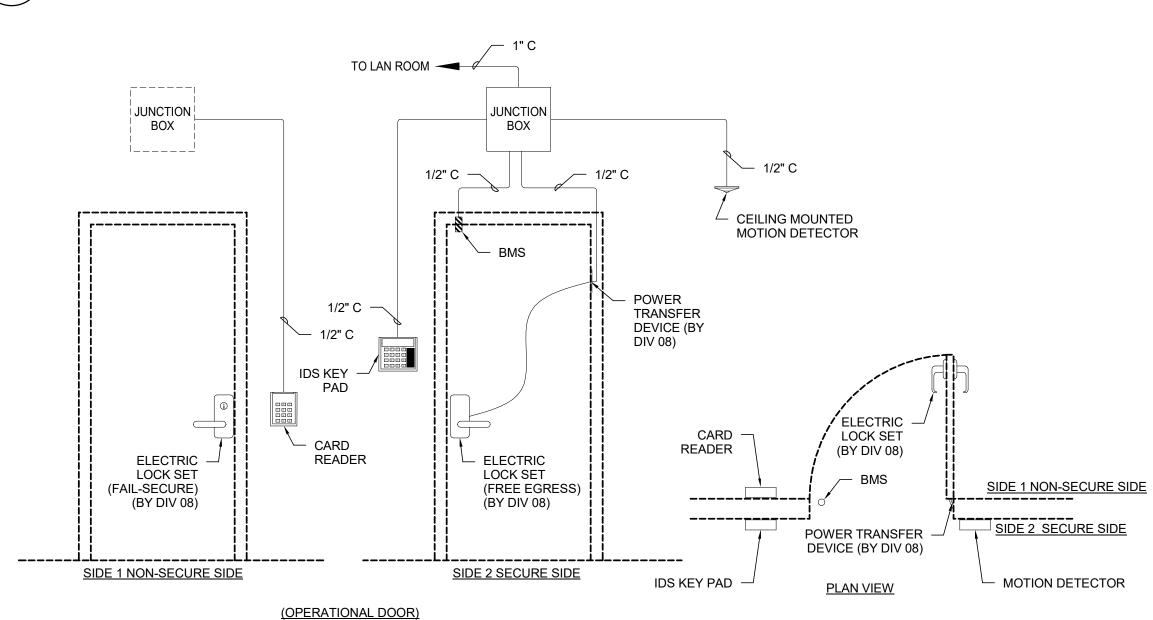

SEQUENCE OF OPERATIONS

- 1. THE DOOR SHALL BE SECURED VIA THE ELECTRIC LOCK WITH BUILT-IN REX. THE LOCK SHALL FAIL SECURE. 2. TO ENTER, UPON A VALID CARD READ (AND PIN CODE ENTRY WHERE REQUIRED), THE ACS SHALL SIGNAL THE LOCK
- TO OPEN AND THE BMS SHALL BE SHUNTED FOR A (USER DEFINED) PERIOD OF TIME. 3. THE DOOR SHALL ALLOW FREE EGRESS AT ANYTIME, A REQUEST TO EXIT SIGNAL FROM A BUILT-IN SWITCH IN THE
- HANDLE SHALL SHUNT THE BMS FOR A (USER DEFINED) PERIOD OF TIME.
- 4. AFTER A VALID ENTRY, WHEN THE UNLOCK TIME EXPIRES, THE BMS SHALL BE ACTIVATED. UNAUTHORIZED OPERATION OF THE DOOR SENSED BY THE BMS SHALL ACTIVATE A DOOR FORCED ALARM OR A DOOR HELD OPEN ALARM IF THE DOOR IS NOT PROPERLY CLOSED. THE ACS SHALL SEND AN ALARM SIGNAL TO THE MONITORING WORKSTATION. THE ALARM MUST BE CLEARED FROM THE MONITORING WORKSTATION IN THE SUPERVISOR'S OFFICE.



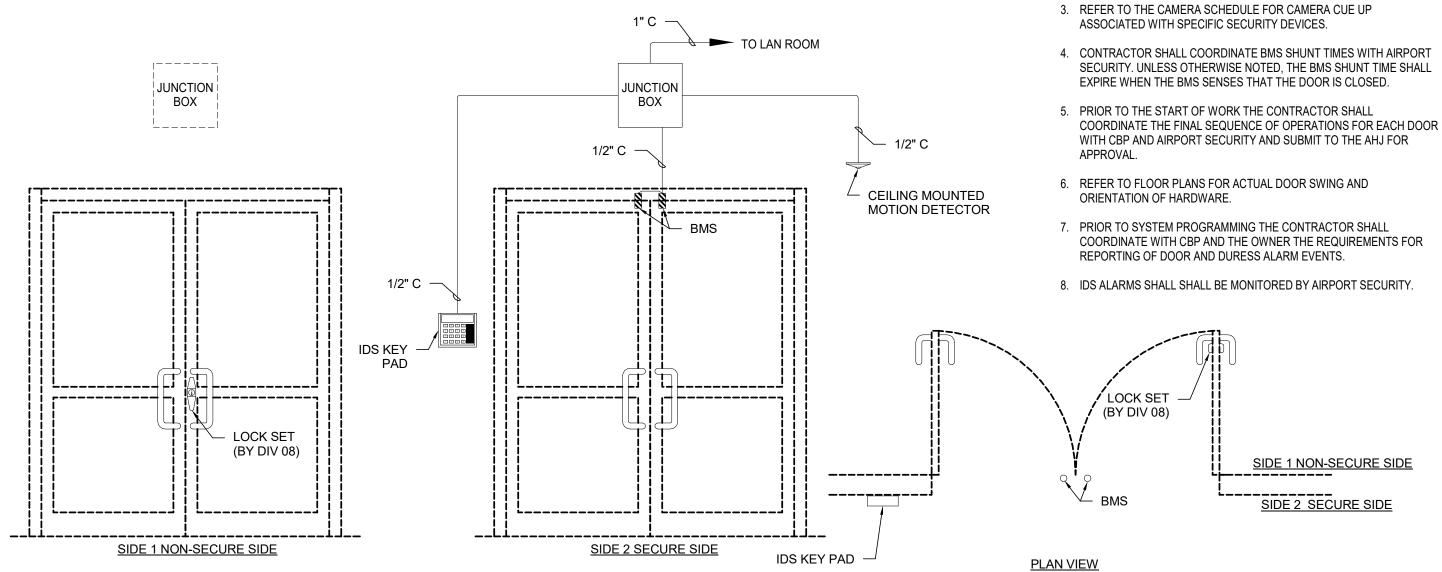

1. THE DOOR SHALL BE SECURED VIA THE MECHANICAL LOCK SET. THE DOOR SHALL BE UNLOCKED FOR PUBLIC

(OPERATIONAL DOOR)

ACCESS DURING NORMAL BUSINESS HOURS. 2. WHEN THE IDS IS ARMED THE THE BMS SHALL BE ACTIVATED. UNAUTHORIZED OPERATION OF THE DOOR SENSED BY THE BMS SHALL ACTIVATE A DOOR FORCED ALARM. THE IDS SHALL ANNUNCIATE THE ALARM ON THE IDS

KEYPAD AND SEND A SIGNAL TO THE MONITORING WORKSTATION. 3. THE ALARM MUST BE CLEARED FROM AN IDS KEY PAD OR THE MONITORING WORKSTATION IN THE SUPERVISOR'S

\TY501/ SCALE: N.T.S.

SEQUENCE OF OPERATIONS

SECURITY DOOR - TYPE 3

JUNCTION JUNCTION BOX BOX 1/2" C -— 3/4" C -----BMS (SEE NOTE) FLUSH MOUNTED POWER TRANSFER COVERT VIDEO INTERCOM DEVICE (BY DIV 08) DURESS BUTTON (SEE NOTE, **TYPE** (TYPE 1B ONLY) 1A ONLY) SIGN 1/2" C **ELECTRIC** LOCK SET CARD READER, CARD — (BY DIV 08) VIDEO INTERCOM READER ELECTRIC ELECTRIC (TYPE 1A ONLY) LOCK SET LOCK SET BMS SIDE 1 NON-SECURE SIDE (FAIL-SECURE) (FREE EGRESS) (BY DIV 08) (BY DIV 08)

SIDE 2 SECURE SIDE

(OPERATIONAL DOOR)

SEQUENCE OF OPERATIONS

SIDE 1 NON-SECURE SIDE

- 1. THE DOOR SHALL BE SECURED VIA THE ELECTRIC LOCK WITH BUILT-IN REX. THE LOCK SHALL FAIL SECURE. 2. TO ENTER, UPON A VALID CARD READ (AND PIN CODE ENTRY WHERE REQUIRED), THE ACS SHALL SIGNAL THE LOCK
- TO OPEN AND THE BMS SHALL BE SHUNTED FOR A (USER DEFINED) PERIOD OF TIME. 3. THE DOOR SHALL ALLOW FREE EGRESS AT ANYTIME, A REQUEST TO EXIT SIGNAL FROM A BUILT-IN SWITCH IN THE
- HANDLE SHALL SHUNT THE BMS FOR A (USER DEFINED) PERIOD OF TIME.

4. AFTER A VALID ENTRY, WHEN THE UNLOCK TIME EXPIRES, THE BMS SHALL BE ACTIVATED. UNAUTHORIZED OPERATION OF THE DOOR SENSED BY THE BMS SHALL ACTIVATE A DOOR FORCED ALARM OR A DOOR HELD OPEN ALARM IF THE DOOR IS NOT PROPERLY CLOSED. THE ACS SHALL SEND AN ALARM SIGNAL TO THE MONITORING WORKSTATION. THE ALARM MUST BE CLEARED FROM THE MONITORING WORKSTATION IN THE SUPERVISOR'S OFFICE.

NOTES:

FOR DOOR TYPE 1A (DOOR 113B), PROVIDE WALL MOUNTED VIDEO INTERCOM AND DPS IN LIEU OF BMS.

POWER TRANSFER -

DEVICE (BY DIV 08)

PLAN VIEW

L-----

SIDE 2 SECURE SIDE

2. REFER TO THE SECURITY DOOR SCHEDULE FOR INFORMATION SPECIFIC TO EACH DOOR AND THE HARDWARE REQUIRED.

MOTION DETECTOR

1. THESE DETAILS ARE SCHEMATIC IN NATURE AND MAY NOT SHOW ALI EQUIPMENT OR CONNECTIONS REQUIRED. THEY ARE INTENDED TO ILLUSTRATE TYPICAL EQUIPMENT LAYOUTS AND DESCRIBE SECURITY

NOTES:

HARDWARE OPERATIONS.



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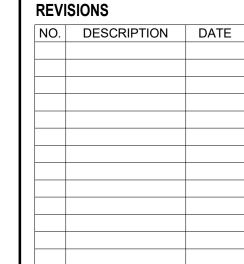
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PENSACOLA GENERAL AVIATION FACILITY (GAF)



PROFESSIONAL SEAL





DATE ISSUED: 03/03/2020 **REVIEWED BY:** SVS DRAWN BY: VJM RJF **DESIGNED BY:**

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SHEET TITLE

SECURITY DOOR DETAILS


SHEET NUMBER

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BID DOCUMENTS


SCALE: N.T.S.

SECURITY DOOR - TYPE 1

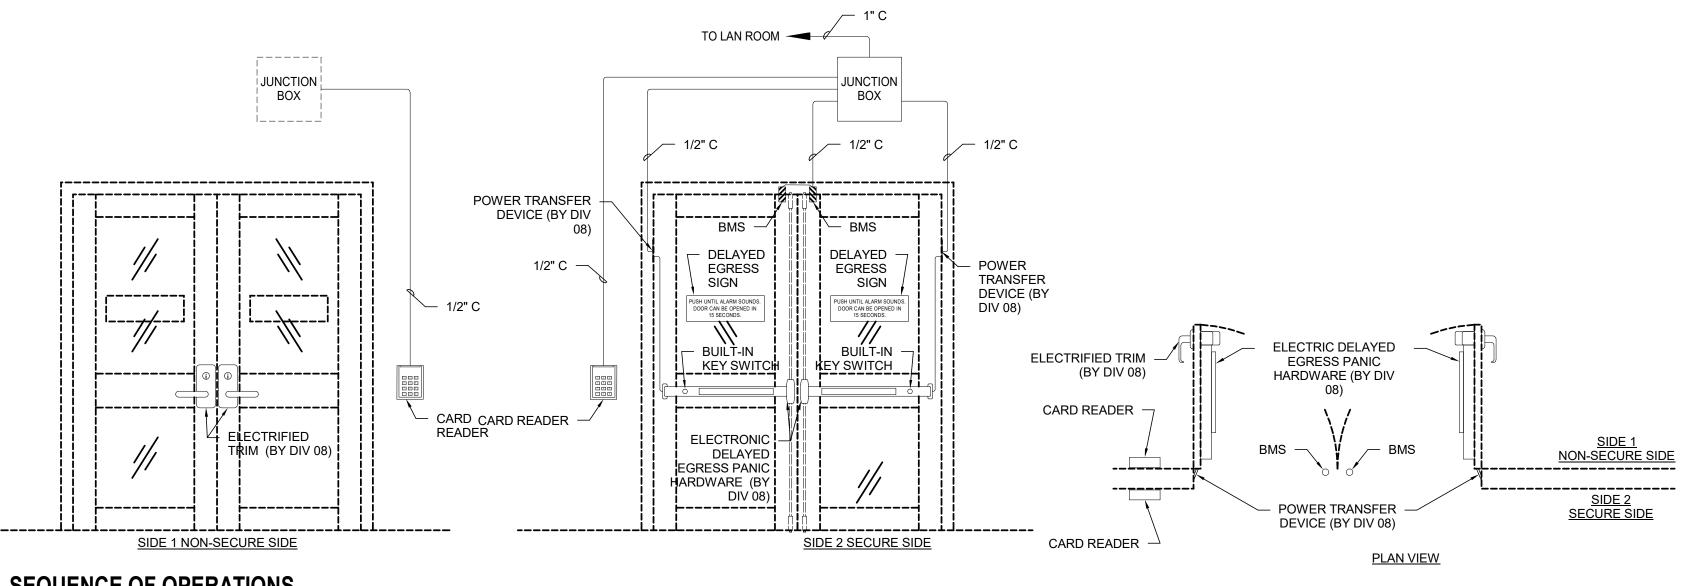

- 1. THE DOORS SHALL BE SECURED VIA THE ELECTRIFIED INTERNAL VERTICAL RODS
- ACTIVATED BY THE ELECTRONIC PUSH BAR WITH TIME DELAY, THE LOCK SHALL FAIL SAFE. 2. TO ENTER/EXIT, UPON A VALID CARD READ (AND PIN CODE ENTRY WHERE REQUIRED), THE ACS SHALL SIGNAL THE LOCK TO OPEN AND THE BMS SHALL BE SHUNTED FOR A (USER DEFINED) PERIOD OF TIME.
- 3. DEPRESSING THE PUSH PAD FOR LESS THAN TWO SECONDS SHALL GENERATE AN AUDIBLE ALARM WITHIN THE ELECTRONIC PUSH BAR.
- 4. WHEN THE PUSH PAD IS DEPRESSED FOR LONGER THAN TWO SECONDS WITHOUT A VALID CARD READ AN IRREVERSIBLE COUNTDOWN SHALL BE INITIATED, THERE SHALL BE AN AUDIBLE ALARM FROM WITHIN THE ELECTRONIC PUSH BAR AND AN ALARM SHALL BE SENT TO THE MONITORING STATION. THE BOTH DOORS SHALL UNLOCK AFTER A 15 SECOND
- 5. AFTER A VALID ENTRY, WHEN THE UNLOCK TIME EXPIRES, THE BMS SHALL BE ACTIVATED. UNAUTHORIZED OPERATION OF THE DOOR SENSED BY EITHER BMS SHALL ACTIVATE A DOOR FORCED ALARM OR A DOOR HELD OPEN ALARM IF THE DOOR IS NOT PROPERLY CLOSED. THE ACS SHALL SEND AN ALARM SIGNAL TO THE MONITORING STATION. THE ALARM MUST BE
- CLEARED FROM THE MONITORING WORKSTATION IN THE SUPERVISOR'S OFFICE. 6. THE DOOR SHALL BE INTERFACED WITH THE FIRE ALARM SYSTEM TO RELEASE THE LOCK
- WITHOUT DELAY IN THE EVENT OF A FIRE ALARM. 7. REFER TO THE FLOOR PLAN FOR REMOTE DOOR RELEASE PUSH BUTTONS LOCATED IN THE PRIMARY PASSENGER PROCESSING PODIUMS. UPON ACTIVATION OF AN ASSOCIATED REMOTE DOOR RELEASE PUSH BUTTON, THE ACS SHALL SIGNAL THE LOCK TO OPEN AND THE BMS SHALL BE SHUNTED FOR A (USER DEFINED) PERIOD OF TIME.

SECURITY DOOR - TYPE 7 TY502/ SCALE: N.T.S.

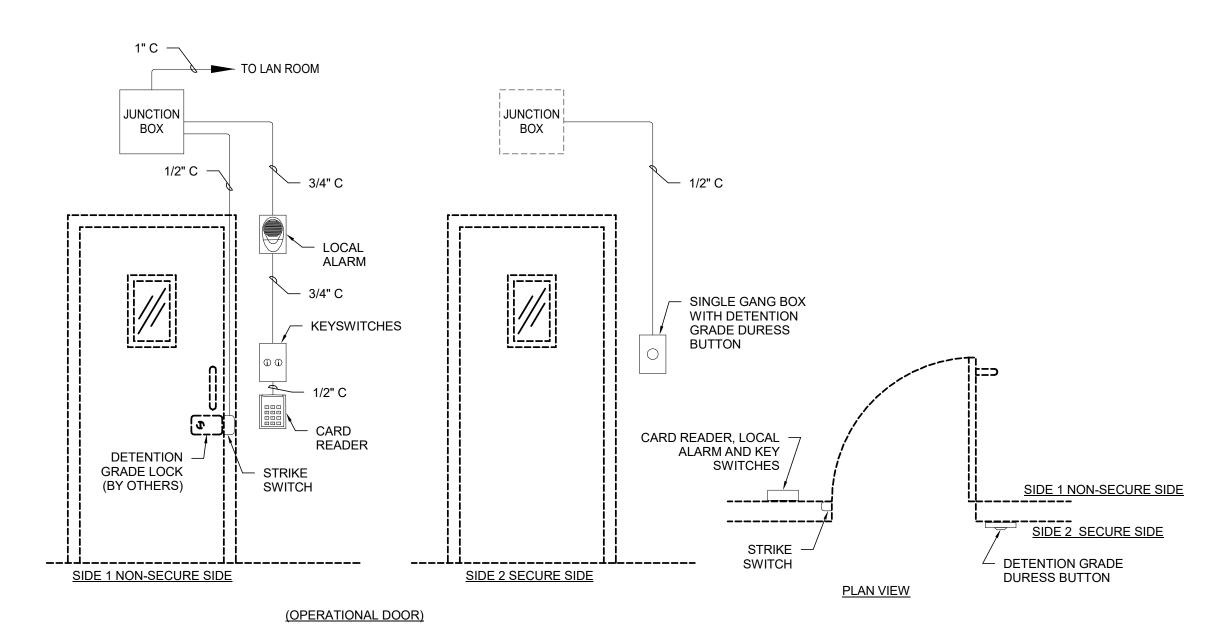


SEQUENCE OF OPERATIONS

- 1. THE DOOR SHALL BE SECURED VIA THE MECHANICAL LOCK. 2. WHEN THE ROOM IS USED TO HOLD A DETAINEE THE MECHANICAL LOCK SHALL BE LATCHED. A SWITCH INSIDE THE STRIKE SHALL SIGNAL THE ACS AND START A FIFTEEN (15) MINUTE TIMER. A CBP OFFICER SHALL PRESENT THEIR CARD TO THE GUARD TOUR CARD READER WHICH SHALL RESTART THE FIFTEEN (15) MINUTE TIMER. OFFICERS SHALL CHECK BACK EVERY FIFTEEN (15) MINUTES TO VISUALLY OBSERVE
- THE DETAINEE AND PRESENT THEIR CARD TO RESTART THE TIMER. 3. IN THE EVENT AN OFFICER DOES NOT PRESENT THEIR CARD WITHIN THE ALLOTTED TIME THE ACS SHALL ACTIVATE A LOCAL ALARM OUTSIDE THE HOLD ROOM, AND OTHER LOCATIONS AS COORDINATED WITH CBP.

SECURITY DOOR - TYPE 6

- 4. A KEY SWITCH OUTSIDE THE ROOM SHALL BE USED TO RESET OR DISABLE THE DURESS PUSHBUTTON ALARM INSIDE THE HOLD ROOM.
- 5. A SEPARATE KEY SWITCH OUTSIDE THE ROOM SHALL BE USED TO CONTROL THE ELECTRONIC FLUSH VALVE FOR THE TOILET INSIDE THE HOLD ROOM.
- WHEN ENABLED, DEPRESSING THE DURESS PUSHBUTTON SHALL ACTIVATE THE LOCAL ALARM DEVICE AND SEND AN ALARM SIGNAL TO THE MONITORING WORKSTATION. THE ACS SHALL ALSO ACTIVATE THE LOCAL ALARMS OUTSIDE THE DETENTION SUITE CORRIDOR DOOR, AND OTHER LOCATIONS AS COORDINATED WITH CBP.
- THE KEY SWITCH SHALL BE ABLE TO RESET THE ALARM DEVICES BUT SHALL NOT CLEAR THE ALARM EVENT FROM THE MONITORING WORKSTATION. THE ALARM MUST BE CLEARED FROM THE MONITORING WORKSTATION IN THE SUPERVISOR'S OFFICE.

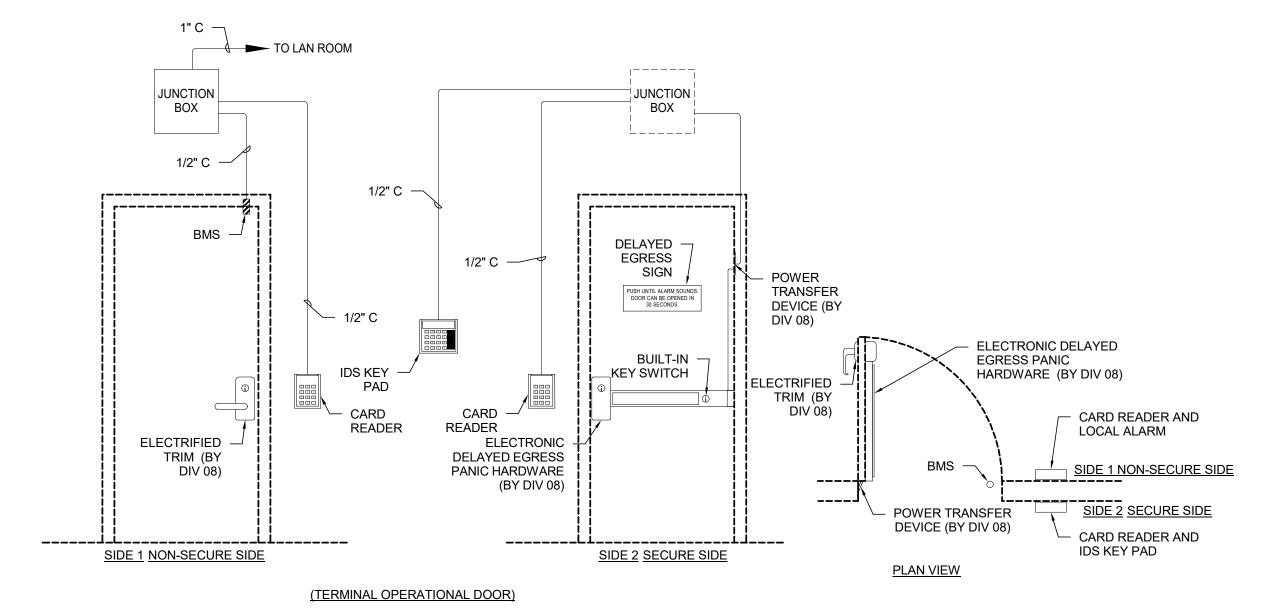

SEQUENCE OF OPERATIONS

UNLOCK AFTER A 30 SECOND DELAY.

- 1. THE DOORS SHALL BE SECURED VIA THE ELECTRONIC PUSH BAR WITH TIME DELAY, THE LOCK SHALL FAIL
- 2. TO ENTER/EXIT, UPON A VALID CARD READ (AND PIN CODE ENTRY WHERE REQUIRED), THE ACS SHALL SIGNAL THE LOCK TO OPEN AND THE BMS SHALL BE SHUNTED FOR A (USER DEFINED) PERIOD OF TIME. 3. DEPRESSING THE PUSH PAD FOR LESS THAN TWO SECONDS SHALL GENERATE AN AUDIBLE ALARM WITHIN
- 4. WHEN THE PUSH PAD IS DEPRESSED FOR LONGER THAN TWO SECONDS WITHOUT A VALID CARD READ AN IRREVERSIBLE COUNTDOWN SHALL BE INITIATED, THERE SHALL BE AN AUDIBLE ALARM FROM WITHIN THE
- THE ELECTRONIC PUSH BAR. ELECTRONIC PUSH BAR AND AN ALARM SHALL BE SENT TO THE MONITORING STATION. THE DOOR SHALL
- 5. AFTER A VALID ENTRY, WHEN THE UNLOCK TIME EXPIRES, THE BMS SHALL BE ACTIVATED. UNAUTHORIZED OPERATION OF THE DOOR SENSED BY THE BMS SHALL ACTIVATE A DOOR FORCED ALARM OR A DOOR HELD OPEN ALARM IF THE DOOR IS NOT PROPERLY CLOSED. THE ACS SHALL SEND AN ALARM SIGNAL TO THE MONITORING STATION. THE ALARM MUST BE CLEARED FROM THE MONITORING WORKSTATION IN THE SUPERVISOR'S OFFICE.

NOTES:

HARDWARE OPERATIONS.

ORIENTATION OF HARDWARE.

1. THESE DETAILS ARE SCHEMATIC IN NATURE AND MAY NOT SHOW ALL

2. REFER TO THE SECURITY DOOR SCHEDULE FOR INFORMATION

SPECIFIC TO EACH DOOR AND THE HARDWARE REQUIRED.

4. CONTRACTOR SHALL COORDINATE BMS SHUNT TIMES WITH AIRPORT SECURITY. UNLESS OTHERWISE NOTED, THE BMS SHUNT TIME SHALL

COORDINATE THE FINAL SEQUENCE OF OPERATIONS FOR EACH DOOR

WITH CBP AND AIRPORT SECURITY AND SUBMIT TO THE AHJ FOR

COORDINATE WITH CBP AND THE OWNER THE REQUIREMENTS FOR

EXPIRE WHEN THE BMS SENSES THAT THE DOOR IS CLOSED.

3. REFER TO THE CAMERA SCHEDULE FOR CAMERA CUE UP

5. PRIOR TO THE START OF WORK THE CONTRACTOR SHALL

6. REFER TO FLOOR PLANS FOR ACTUAL DOOR SWING AND

7. PRIOR TO SYSTEM PROGRAMMING THE CONTRACTOR SHALL

IDS ALARMS SHALL SHALL BE MONITORED BY AIRPORT SECURITY.

REPORTING OF DOOR AND DURESS ALARM EVENTS.

ASSOCIATED WITH SPECIFIC SECURITY DEVICES.

EQUIPMENT OR CONNECTIONS REQUIRED. THEY ARE INTENDED TO ILLUSTRATE TYPICAL EQUIPMENT LAYOUTS AND DESCRIBE SECURITY

THE DOOR SHALL BE INTERFACED WITH THE FIRE ALARM SYSTEM TO RELEASE THE LOCK WITHOUT DELAY IN THE EVENT OF A FIRE ALARM.

1. CONTRACTOR SHALL OBTAIN WRITTEN AUTHORIZATION FROM THE AHJ PRIOR TO ORDERING DELAYED



SECURITY DOOR - TYPE 5

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> Pensacola, FL 32502 T 850.432.0706 F 850.433.0508 G M C N E T W O R K . C O M

PROFESSIONAL SEAL



REVISIONS NO. DESCRIPTION DATE

DATE ISSUED: 03/03/2020 SVS REVIEWED BY: DRAWN BY: VJM RJF **DESIGNED BY:**

PROJECT NUMBER: 201-0052-002 © 2020 RS&H, INC.

SHEET TITLE


SECURITY DOOR DETAILS

SHEET NUMBER

TY502

BID DOCUMENTS


SCALE: N.T.S.

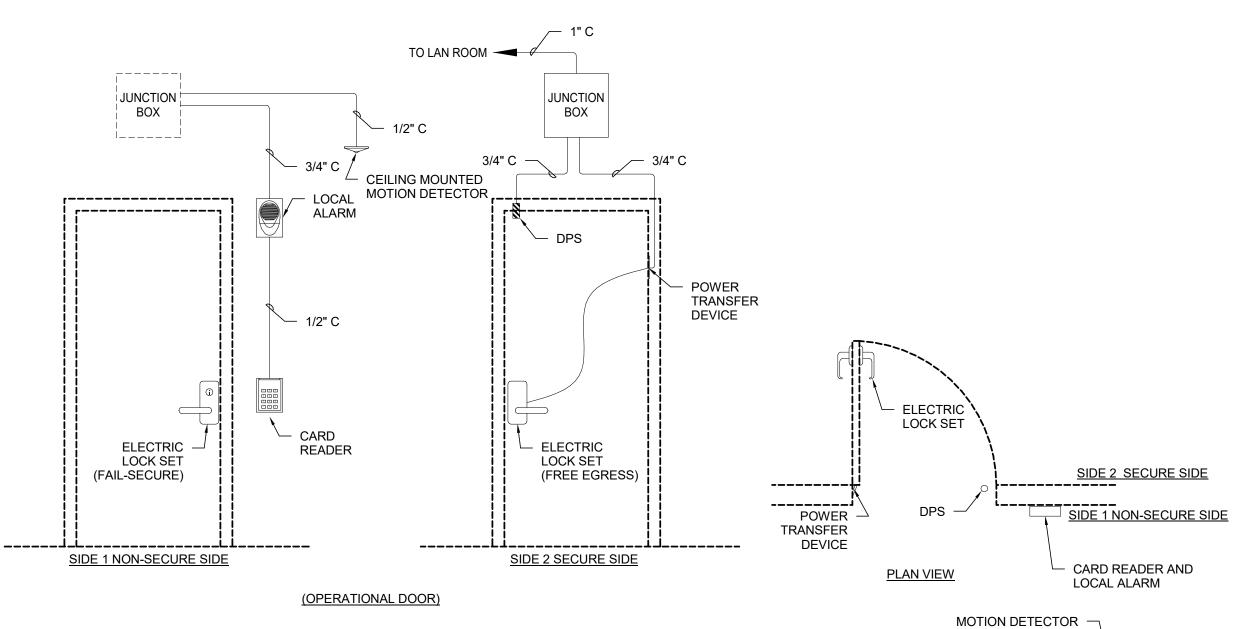

- 1. THE DOOR SHALL BE SECURED VIA THE ELECTRIC LOCK WITH BUILT-IN REX. THE LOCK
- SHALL FAIL SECURE. 2. TO ENTER, UPON A VALID CARD READ (AND PIN CODE ENTRY WHERE REQUIRED), THE ACS SHALL SIGNAL THE LOCK TO OPEN AND THE DPS SHALL BE SHUNTED FOR A (USER DEFINED)
- PERIOD OF TIME. 3. THE DOOR SHALL ALLOW FREE EGRESS AT ANYTIME, A REQUEST TO EXIT SIGNAL FROM A BUILT-IN SWITCH IN THE HANDLE SHALL SHUNT THE DPS FOR A (USER DEFINED) PERIOD OF
- 4. AFTER A VALID ENTRY. WHEN THE UNLOCK TIME EXPIRES, THE DPS SHALL BE ACTIVATED. UNAUTHORIZED OPERATION OF THE DOOR SENSED BY THE DPS SHALL ACTIVATE A DOOR FORCED ALARM OR A DOOR HELD OPEN ALARM IF THE DOOR IS NOT PROPERLY CLOSED. THE ACS SHALL SEND AN ALARM SIGNAL TO THE MONITORING WORKSTATION. THE ALARM MUST BE CLEARED FROM THE MONITORING WORKSTATION IN THE SUPERVISOR'S OFFICE.
- 5. THE ACS SHALL ACTIVATE THE LOCAL ALARM DEVICE WHEN A DURESS BUTTON WITHIN THE ADMIN SUITE IS ACTIVATED. THE ALARM SHALL BE RESET BY THE KEYSWITCH ASSOCIATED WITH THE ACTIVE DEVICE.

\TY503/

SECURITY DOOR - TYPE 11

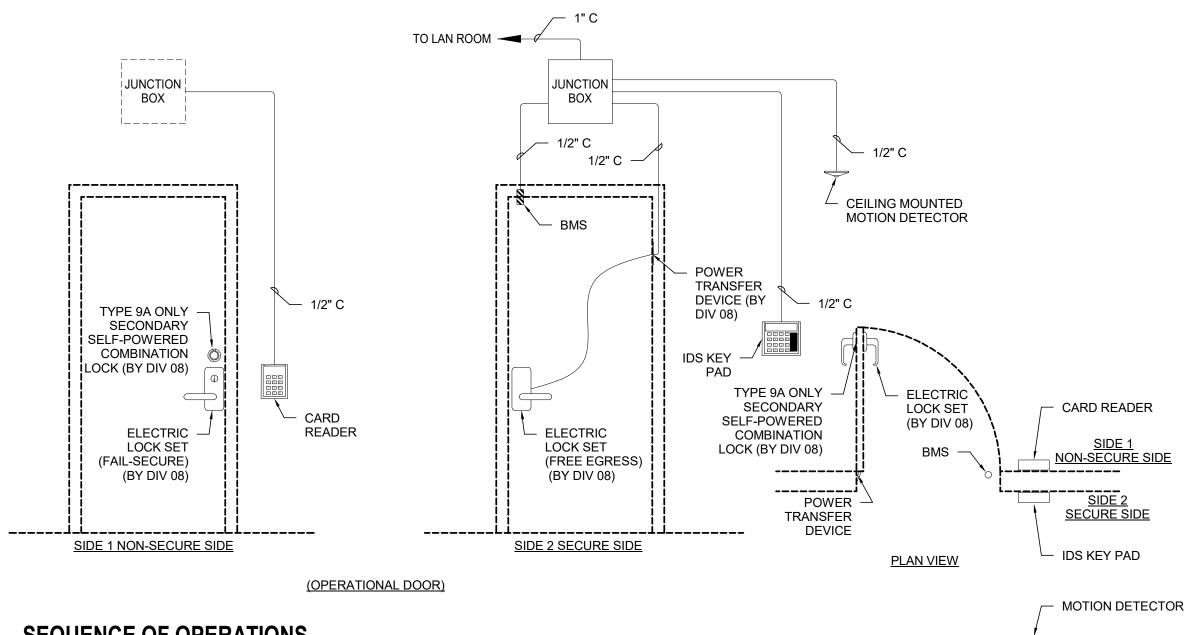

SEQUENCE OF OPERATIONS

- 1. THE DOOR SHALL BE SECURED VIA THE ELECTRIC LOCK WITH BUILT-IN REX. THE LOCK
- SHALL FAIL SECURE. 2. THE IDS KEY PAN SHALL BE USED TO ARM AND DISARM THE INTRUSION DETECTION ZONE (MOTION DETECTOR) WITHIN THE ROOM.
- 3. TO ENTER, UPON A VALID CARD READ (AND PIN CODE ENTRY WHERE REQUIRED) THE ACS SHALL SIGNAL THE LOCK TO OPEN AND THE BMS SHALL BE SHUNTED FOR A (USER DEFINED)
- 4. THE DOOR SHALL ALLOW FREE EGRESS AT ANYTIME, A REQUEST TO EXIT SIGNAL FROM A BUILT-IN SWITCH IN THE HANDLE SHALL SHUNT THE BMS FOR A (USER DEFINED) PERIOD OF
- 5. AFTER A VALID ENTRY, WHEN THE UNLOCK TIME EXPIRES THE BMS SHALL BE ACTIVATED. UNAUTHORIZED OPERATION OF THE DOOR SENSED BY THE BMS SHALL ACTIVATE A DOOR FORCED ALARM OR A DOOR HELD OPEN ALARM IF THE DOOR IS NOT PROPERLY CLOSED. THE ACS SHALL ACTIVATE THE LOCAL ALARM DEVICE AND AN ALARM SHALL BE SENT TO THE ALARM MONITORING WORKSTATION.
- 6. WHEN ARMED, THE INTRUSION DETECTION ZONE (MOTION DETECTOR) SHALL MONITOR THE ROOM FOR UNAUTHORIZED ACCESS. IF TRIGGERED, THE ACS SHALL ACTIVATE THE LOCAL ALARM DEVICE AND SEND AN ALARM SIGNAL TO THE MONITORING WORKSTATION.
- 7. THE IDS KEY PAD SHALL BE ABLE TO SILENCE THE AUDIBLE ALARM.

SECURITY DOOR - TYPE 9

SECURITY DOOR - TYPE 8

1. THESE DETAILS ARE SCHEMATIC IN NATURE AND MAY NOT SHOW ALL EQUIPMENT OR CONNECTIONS REQUIRED. THEY ARE INTENDED TO ILLUSTRATE TYPICAL EQUIPMENT LAYOUTS AND DESCRIBE SECURITY HARDWARE OPERATIONS. 2. REFER TO THE SECURITY DOOR SCHEDULE FOR INFORMATION SPECIFIC TO EACH DOOR AND THE HARDWARE REQUIRED. 3. REFER TO THE CAMERA SCHEDULE FOR CAMERA CUE UP ASSOCIATED WITH SPECIFIC SECURITY DEVICES. 4. CONTRACTOR SHALL COORDINATE BMS SHUNT TIMES WITH AIRPORT SECURITY, UNLESS OTHERWISE NOTED, THE BMS SHUNT TIME SHALL EXPIRE WHEN THE BMS SENSES THAT THE DOOR IS CLOSED. ─ 1/2" C 5. PRIOR TO THE START OF WORK THE CONTRACTOR SHALL COORDINATE THE FINAL SEQUENCE OF OPERATIONS FOR EACH DOOR WITH CBP AND AIRPORT SECURITY AND SUBMIT TO THE AHJ FOR 6. REFER TO FLOOR PLANS FOR ACTUAL DOOR SWING AND ORIENTATION OF HARDWARE. SINGLE GANG BOX 7. PRIOR TO SYSTEM PROGRAMMING THE CONTRACTOR SHALL WITH DURESS BUTTON, REFER TO

NOTES:

COORDINATE WITH CBP AND THE OWNER THE REQUIREMENTS FOR REPORTING OF DOOR AND DURESS ALARM EVENTS.

8. IDS ALARMS SHALL SHALL BE MONITORED BY AIRPORT SECURITY. LOCK SET - KEYSWITCH LOCAL ALARM SIDE 1 OUTSIDE ROOM SIDE 2 INSIDE ROOM

- DURESS BUTTON

SEQUENCE OF OPERATIONS

JUNCTION

BOX

LOCK SET

SIDE 1 OUTSIDE ROOM

LOCAL

1. THE DOOR SHALL BE SECURED VIA THE MECHANICAL LOCK. 2. A KEYSWITCH OUTSIDE THE ROOM SHALL BE USED TO RESET THE DURESS PUSHBUTTON

− 1/2" C

KEYSWITCH

(OPERATIONAL DOOR)

TO LAN ROOM

JUNCTION

BOX

LOCK SET

SIDE 2 INSIDE ROOM

WRITTEN

TYPE.


SPECIFICATIONS FOR

PLAN VIEW

- 3. DEPRESSING THE DURESS PUSHBUTTON SHALL ACTIVATE THE LOCAL ALARM DEVICE AND SEND AN ALARM SIGNAL TO THE MONITORING WORKSTATION. THE ACS SHALL ALSO ACTIVATE THE LOCAL ALARM OUTSIDE THE DETENTION SUITE OR ADMIIN CORRIDOR DOORS
- AND OTHER LOCATIONS AS COORDINATED WITH CBP. 4. THE KEYSWITCH SHALL BE ABLE TO RESET THE ALARM DEVICES BUT SHALL NOT CLEAR THE ALARM EVENT FROM THE MONITORING WORKSTATION. THE ALARM MUST BE CLEARED FROM THE MONITORING WORKSTATION IN THE SUPERVISOR'S OFFICE.



SECURITY DOOR - TYPE 10

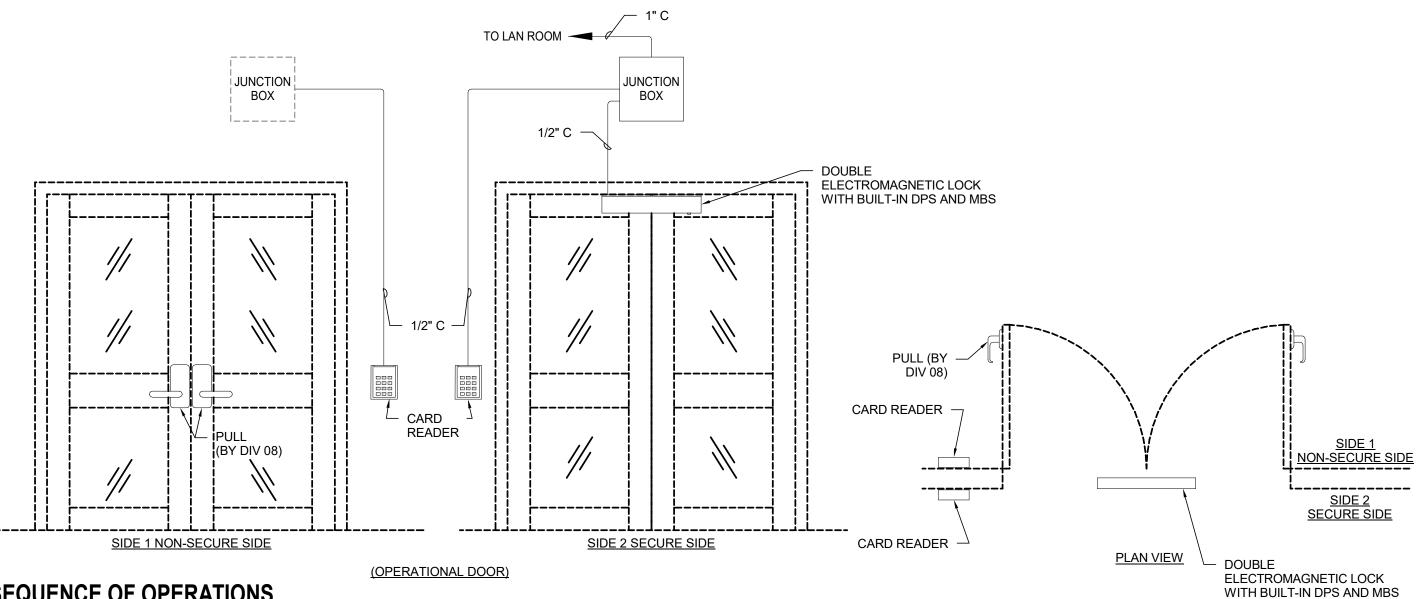

SEQUENCE OF OPERATIONS

- 1. THE DOORS SHALL BE SECURED VIA THE DOUBLE ELECTROMAGNETIC LOCK WITH BUILT-IN DPS AND MBS, THE LOCK SHALL FAIL SAFE.
- 2. TO ENTER OR EXIT, UPON A VALID CARD READ (AND PIN CODE ENTRY WHERE REQUIRED). THE ACS SHALL RELEASE THE LOCK TO OPEN AND THE DPS SHALL BE SHUNTED FOR A
- (USER DEFINED) PERIOD OF TIME. AFTER A VALID ENTRY, WHEN THE UNLOCK TIME EXPIRES, THE DPS SHALL BE ACTIVATED. UNAUTHORIZED OPERATION OF THE DOOR SENSED BY THE DPS SHALL ACTIVATE A DOOR FORCED ALARM OR A DOOR HELD OPEN ALARM IF THE DOOR IS NOT PROPERLY CLOSED. THE ACS SHALL SEND AN ALARM SIGNAL TO THE MONITORING WORKSTATION. THE ALARM MUST BE CLEARED FROM THE MONITORING WORKSTATION IN THE SUPERVISOR'S OFFICE.
- 4. OPERATION OF A DESIGNATED REMOTE DOOR RELEASE PUSHBUTTON CONNECTED TO THE ACS SHALL RELEASE THE LOCK TO OPEN AND THE DPS SHALL BE SHUNTED FOR A (USER
- DEFINED) PERIOD OF TIME 5. THE DOOR SHALL BE INTERFACED WITH THE FIRE ALARM SYSTEM TO RELEASE THE LOCK
- WITHOUT DELAY IN THE EVENT OF A FIRE ALARM. 6. REFER TO THE FLOOR PLAN FOR REMOTE DOOR RELEASE PUSH BUTTONS LOCATED IN THE PRIMARY PASSENGER PROCESSING PODIUMS. UPON ACTIVATION OF AN ASSOCIATED REMOTE DOOR RELEASE PUSH BUTTON, THE ACS SHALL SIGNAL THE LOCK TO RELEASE AND THE DPS SHALL BE SHUNTED FOR A (USER DEFINED) PERIOD OF TIME.

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REVISIONS NO. DESCRIPTION DATE

DATE ISSUED: 03/03/2020 **REVIEWED BY:** SVS VJM DRAWN BY:

PROJECT NUMBER: 201-0052-002 RJF


DESIGNED BY:

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SECURITY DOOR DETAILS

SHEET NUMBER

TY503

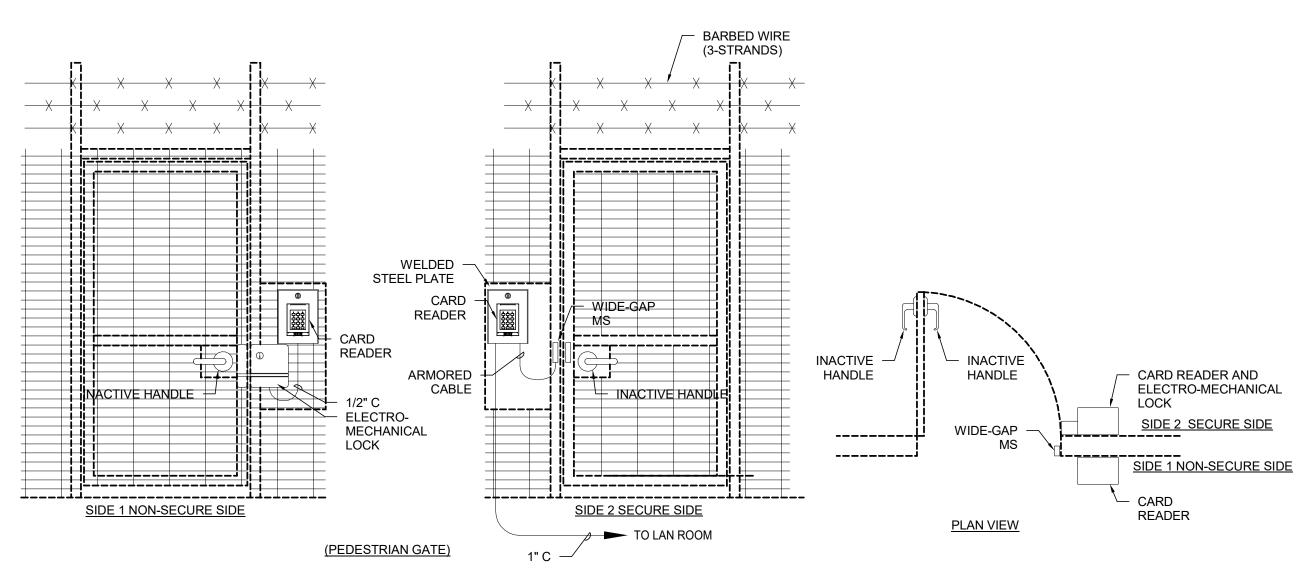


SCALE: N.T.S.

TY504/

- 1. THE DOOR SHALL BE SECURED VIA THE ELECTROMECHANICAL LOCK WITH KEYED OVERRIDE. THE LOCK SHALL FAIL
- 2. TO ENTER OR EXIT, UPON A VALID CARD READ (AND PIN CODE ENTRY WHERE REQUIRED), THE ACS SHALL SIGNAL
- THE LOCK TO OPEN AND THE WIDE-GAP DPS SHALL BE SHUNTED FOR A (USER DEFINED) PERIOD OF TIME. 3. AFTER A VALID ENTRY, WHEN THE UNLOCK TIME EXPIRES, THE DPS SHALL BE ACTIVATED. UNAUTHORIZED OPERATION OF THE DOOR SENSED BY THE DPS SHALL ACTIVATE A DOOR FORCED ALARM OR A DOOR HELD OPEN ALARM IF THE DOOR IS NOT PROPERLY CLOSED. THE ACS SHALL SEND AN ALARM SIGNAL TO THE MONITORING WORKSTATION. THE ALARM MUST BE CLEARED FROM THE MONITORING WORKSTATION IN THE SUPERVISOR'S

SECURITY DOOR - TYPE 15

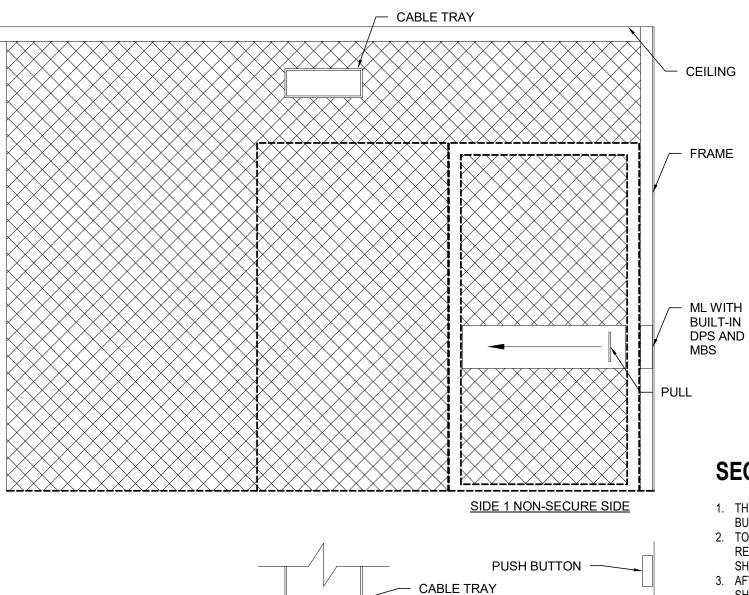

SLIDING DOOR

WITH 4'-0"

OPENING

NOTES:

- 1. THESE DETAILS ARE SCHEMATIC IN NATURE AND MAY NOT SHOW ALL EQUIPMENT OR CONNECTIONS REQUIRED. THEY ARE INTENDED TO ILLUSTRATE TYPICAL EQUIPMENT LAYOUTS AND DESCRIBE SECURITY HARDWARE OPERATIONS.
- 2. REFER TO THE SECURITY DOOR SCHEDULE FOR INFORMATION SPECIFIC TO EACH DOOR AND THE HARDWARE REQUIRED.
- 3. REFER TO THE CAMERA SCHEDULE FOR CAMERA CUE UP ASSOCIATED WITH SPECIFIC SECURITY DEVICES.
- 4. CONTRACTOR SHALL COORDINATE BMS SHUNT TIMES WITH AIRPORT SECURITY. UNLESS OTHERWISE NOTED, THE BMS SHUNT TIME SHALL EXPIRE WHEN THE BMS SENSES THAT THE DOOR IS CLOSED.
- 5. PRIOR TO THE START OF WORK THE CONTRACTOR SHALL COORDINATE THE FINAL SEQUENCE OF OPERATIONS FOR EACH DOOR WITH CBP AND AIRPORT SECURITY AND SUBMIT TO THE AHJ FOR
- 6. REFER TO FLOOR PLANS FOR ACTUAL DOOR SWING AND ORIENTATION OF HARDWARE.
- 7. PRIOR TO SYSTEM PROGRAMMING THE CONTRACTOR SHALL COORDINATE WITH CBP AND THE OWNER THE REQUIREMENTS FOR REPORTING OF DOOR AND DURESS ALARM EVENTS.
- 8. IDS ALARMS SHALL SHALL BE MONITORED BY AIRPORT SECURITY.

SEQUENCE OF OPERATIONS

- 1. THE DOORS SHALL BE SECURED VIA THE ELECTROMAGNETIC LOCK WITH
- BUILT-IN DPS AND MBS. THE LOCK SHALL FAIL SAFE. 2. TO ENTER, UPON A VALID CARD READ (AND PIN CODE ENTRY WHERE REQUIRED), THE ACS SHALL RELEASE THE LOCK TO OPEN AND THE DPS
- SHALL BE SHUNTED FOR A (USER DEFINED) PERIOD OF TIME. . AFTER A VALID ENTRY, WHEN THE UNLOCK TIME EXPIRES, THE DPS SHALL BE ACTIVATED. UNAUTHORIZED OPERATION OF THE DOOR SENSED BY THE DPS SHALL ACTIVATE A DOOR FORCED ALARM OR A DOOR HELD OPEN ALARM IF THE DOOR IS NOT PROPERLY CLOSED. THE ACS SHALL SEND AN ALARM SIGNAL TO THE MONITORING WORKSTATION. THE ALARM MUST BE CLEARED FROM THE MONITORING WORKSTATION IN THE SUPERVISOR'S OFFICE.
- 4. A REQUEST TO EXIT SIGNAL FROM THE WALL MOUNTED PUSH BUTTON SHALL SHUNT THE DPS FOR A (USER DEFINED) PERIOD OF TIME AND
- RELEASE THE MAGNETIC LOCK BY DIRECTLY INTERRUPTING THE POWER. . THE DOOR SHALL BE INTERFACED WITH THE FIRE ALARM SYSTEM TO

RELEASE THE LOCK WITHOUT DELAY IN THE EVENT OF A FIRE ALARM.


SECURITY DOOR - TYPE 14

TY504

SCALE: N.T.S.

SIDE 2 SECURE SIDE

SIDE 1 NON-SECURE SIDE

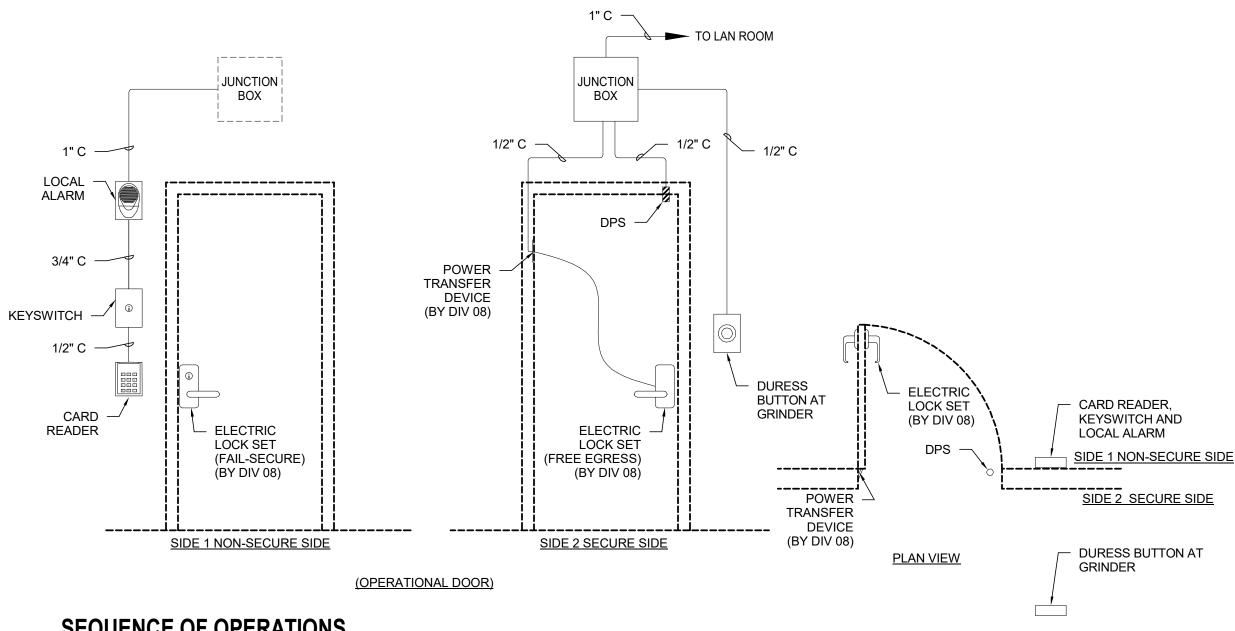

SEQUENCE OF OPERATIONS


SCALE: N.T.S.

\TY504/

- 1. THE DOOR SHALL BE SECURED VIA THE ELECTRIC LOCK WITH BUILT-IN REX. THE LOCK
- SHALL FAIL SECURE. 2. TO ENTER, UPON A VALID CARD READ (AND PIN CODE ENTRY WHERE REQUIRED), THE ACS SHALL SIGNAL THE LOCK TO OPEN AND THE DPS SHALL BE SHUNTED FOR A (USER DEFINED) PERIOD OF TIME.
- 3. THE DOOR SHALL ALLOW FREE EGRESS AT ANYTIME, A REQUEST TO EXIT SIGNAL FROM A BUILT-IN SWITCH IN THE HANDLE SHALL SHUNT THE DPS FOR A (USER DEFINED) PERIOD OF
- 4. AFTER A VALID ENTRY, WHEN THE UNLOCK TIME EXPIRES, THE DPS SHALL BE ACTIVATED. UNAUTHORIZED OPERATION OF THE DOOR SENSED BY THE DPS SHALL ACTIVATE A DOOR FORCED ALARM OR A DOOR HELD OPEN ALARM IF THE DOOR IS NOT PROPERLY CLOSED. THE ACS SHALL ACTIVATE THE LOCAL ALARM DEVICES AND SEND AN ALARM SIGNAL TO THE MONITORING WORKSTATION.

SECURITY DOOR - TYPE 13

- 5. CLOSING THE DOOR SHALL RESET THE ALARM DEVICES BUT SHALL NOT CLEAR THE ALARM EVENT FROM THE MONITORING WORKSTATION. THE ALARM MUST BE CLEARED FROM THE MONITORING WORKSTATION IN THE SUPERVISOR'S OFFICE.
- 6. A KEYSWITCH OUTSIDE THE ROOM SHALL BE USED TO RESET THE DURESS PUSHBUTTON
- 7. DEPRESSING THE DURESS PUSHBUTTON SHALL ACTIVATE THE LOCAL ALARM DEVICE AND SEND AN ALARM SIGNAL TO THE MONITORING WORKSTATION. THE ACS SHALL ALSO ACTIVATE THE LOCAL ALARM IN OTHER LOCATIONS AS COORDINATED WITH CBP.
- 8. THE KEYSWITCH SHALL BE ABLE TO RESET THE ALARM DEVICES BUT SHALL NOT CLEAR THE ALARM EVENT FROM THE MONITORING WORKSTATION. THE ALARM MUST BE CLEARED FROM THE MONITORING WORKSTATION IN THE SUPERVISOR'S OFFICE.

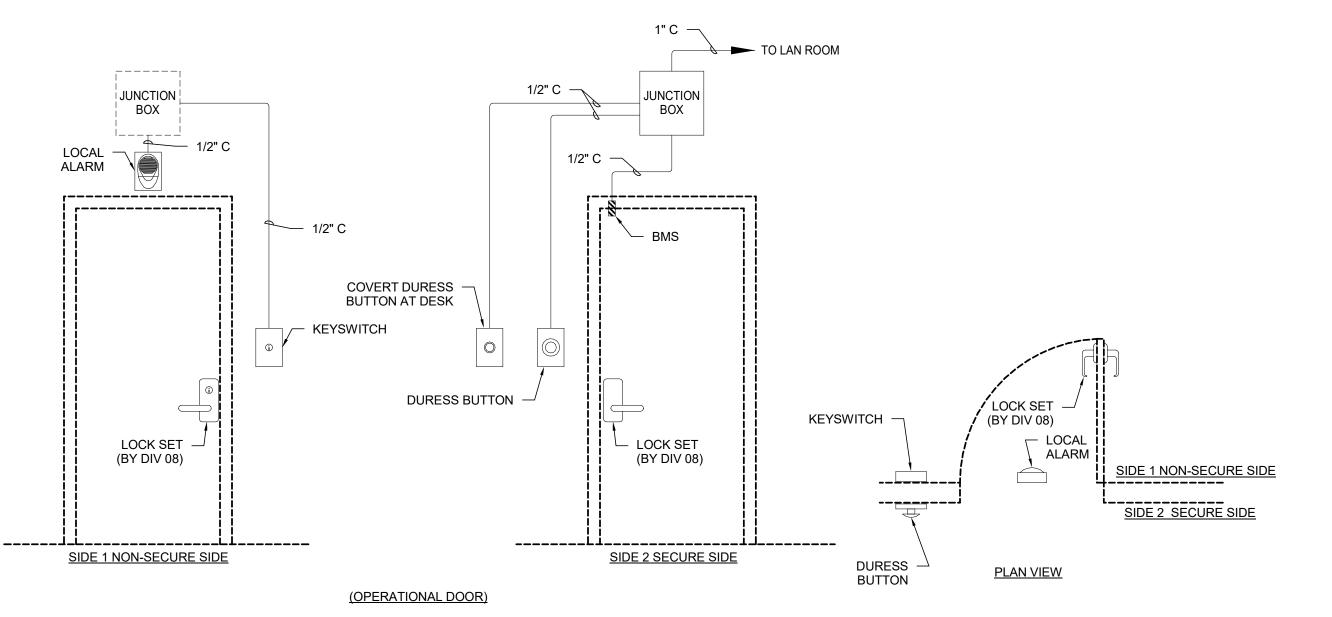

ML WITH -

AND MBS

BUILT-IN DPS

CARD READER

SEQUENCE OF OPERATIONS

- THE DOOR SHALL BE SECURED VIA THE MECHANICAL LOCK.
- 2. A KEYSWITCH OUTSIDE THE ROOM SHALL BE USED TO RESET THE DURESS PUSHBUTTON
- 3. DEPRESSING EITHER DURESS PUSHBUTTON SHALL ACTIVATE THE LOCAL ALARM DEVICE AND SEND AN ALARM SIGNAL TO THE MONITORING WORKSTATION. THE ACS SHALL ALSO ACTIVATE THE LOCAL ALARM OUTSIDE THE DETENTION SUITE OR ADMIIN CORRIDOR DOORS AND OTHER LOCATIONS AS COORDINATED WITH CBP.
- 4. THE KEYSWITCH SHALL BE ABLE TO RESET THE ALARM DEVICES BUT SHALL NOT CLEAR THE ALARM EVENT FROM THE MONITORING WORKSTATION. THE ALARM MUST BE CLEARED FROM THE MONITORING WORKSTATION IN THE SUPERVISOR'S OFFICE.



SECURITY DOOR - TYPE 12



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REVISIONS

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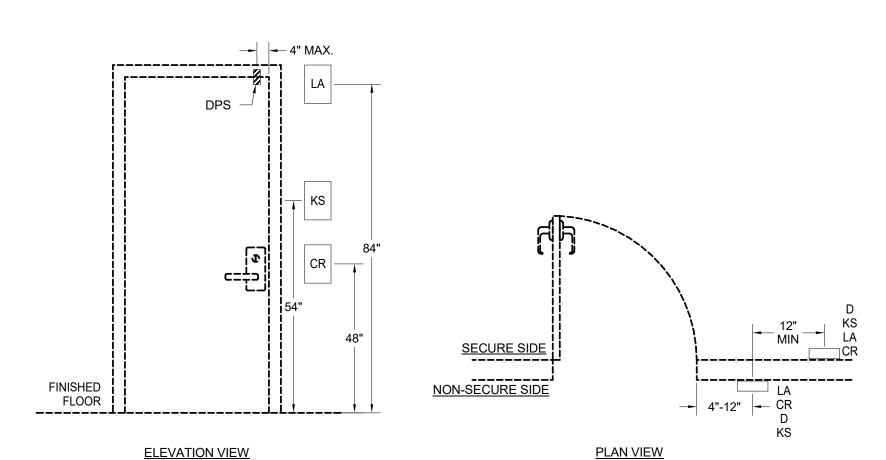
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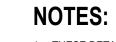
SHEET TITLE

SECURITY DOOR DETAILS

SHEET NUMBER

TY504





DEVICES.

- 1. THESE DETAILS ARE SCHEMATIC IN NATURE AND MAY NOT SHOW ALL EQUIPMENT OR CONNECTIONS REQUIRED. THEY ARE INTENDED TO ILLUSTRATE TYPICAL EQUIPMENT LAYOUTS AND DESCRIBE
- SECURITY HARDWARE OPERATIONS. 2. REFER TO THE SECURITY DOOR SCHEDULE FOR INFORMATION SPECIFIC TO EACH SECURITY DEVICE
- AND THE HARDWARE REQUIRED. EB0005620 * LCC000210 * GB238 3. REFER TO THE CAMERA SCHEDULE FOR CAMERA CUE UP ASSOCIATED WITH SPECIFIC SECURITY



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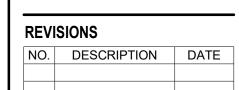
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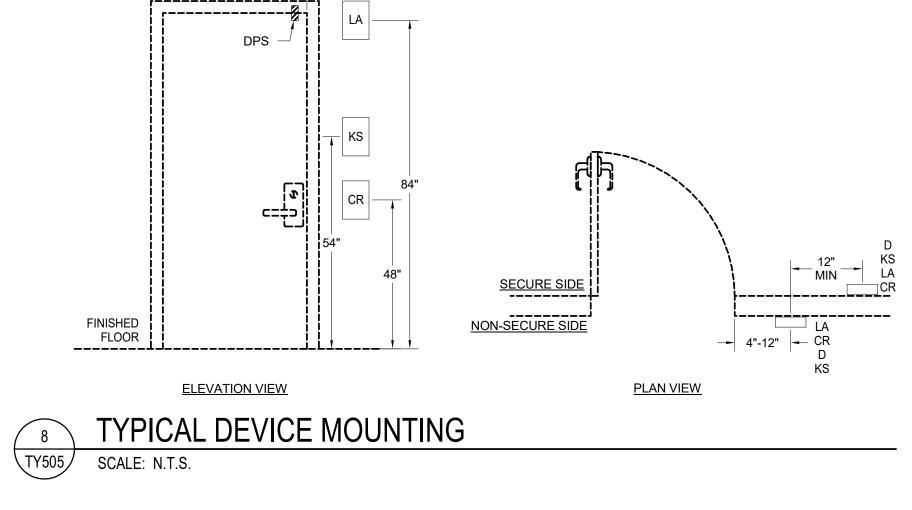
SHEET TITLE

SECURITY DEVICE DETAILS

SHEET NUMBER

TY505

BID DOCUMENTS





(° °)



WALL/SURFACE MOUNTED

FACEPLATE

BLACK LETTERS

GREEN PUSHBUTTON

WALL/SURFACE MOUNTED

PUSHBUTTON WITH STAINLESS STEEL

TAMPER PROOF HARDWARE (TYP.)

RED MUSHROOM TYPE PUSHBUTTON,

SCALE: N.T.S.

2-1/2 DIAMETER MINIMUM


WITH LED (ILLUMINATED)

TAMPER PROOF HARDWARE (TYP.)


TY505

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PUSHBUTTON WITH STAINLESS STEEL

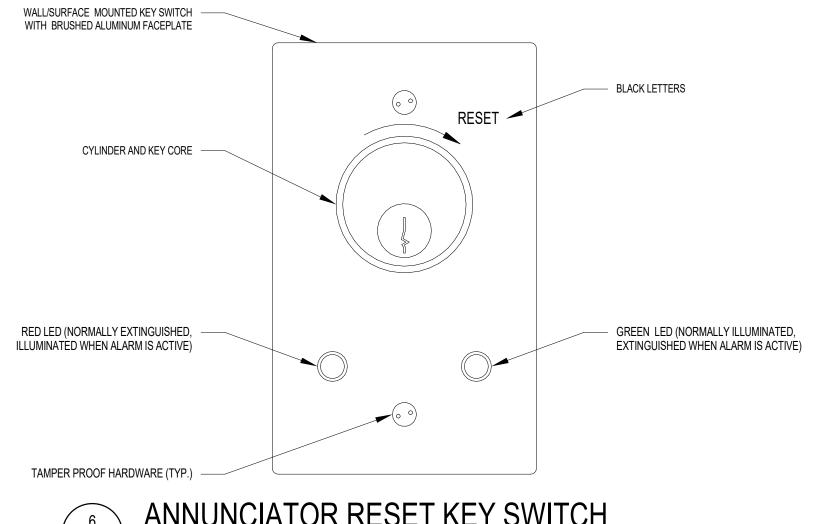


ANNUNCIATOR RESET KEY SWITCH TY505/ SCALE: N.T.S.

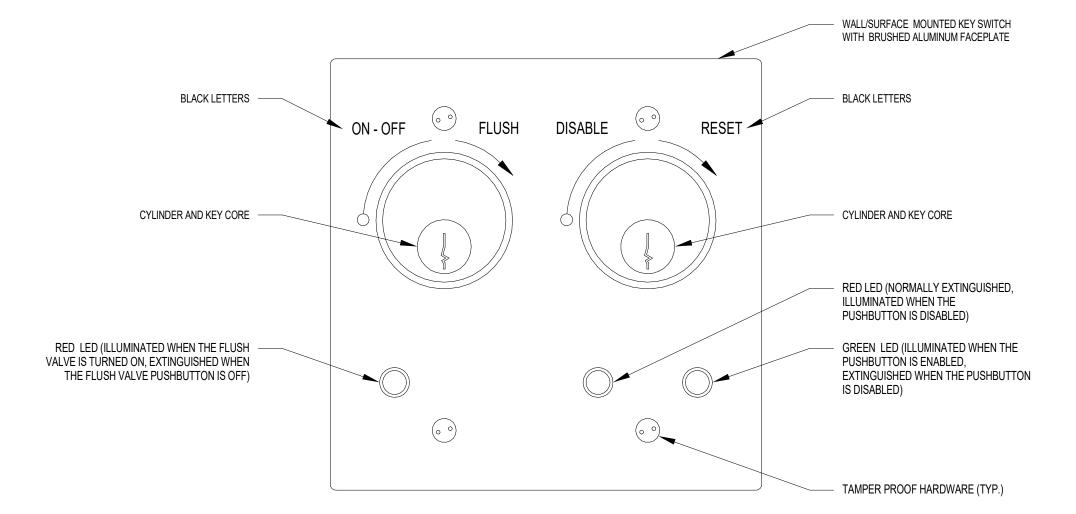

ANNUNCIATOR HOLD ROOM DISABLE RESET KEY SWITCH \TY505/ SCALE: N.T.S.


TY505


SCALE: N.T.S.

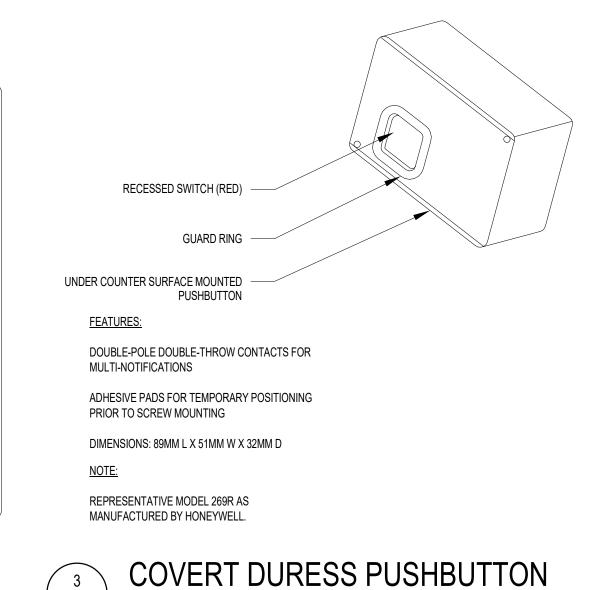


\TY505

SCALE: N.T.S.

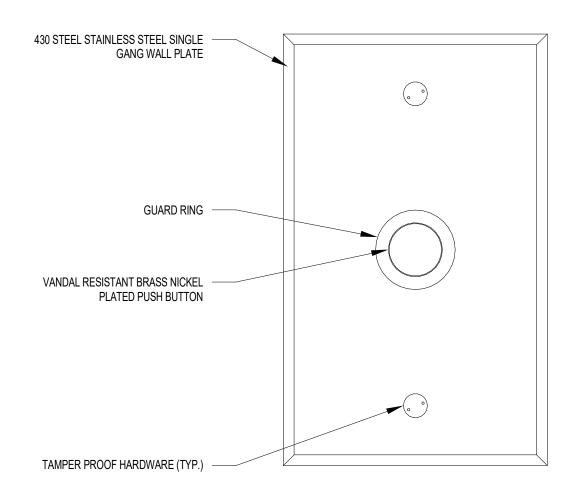

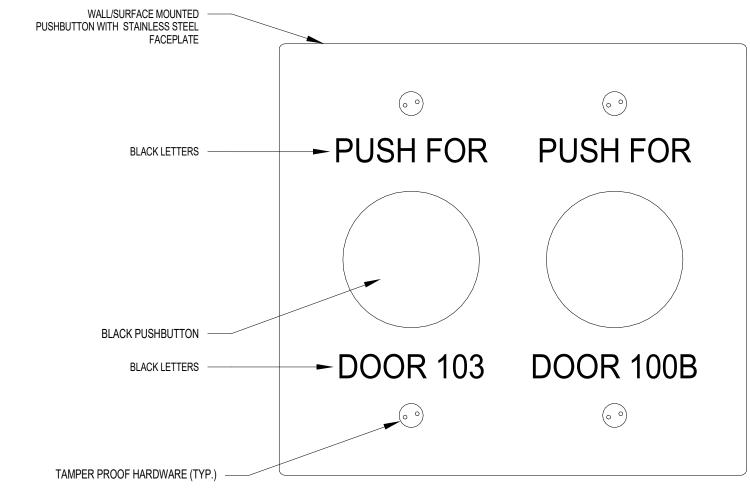

DOOR RELEASE PUSHBUTTON

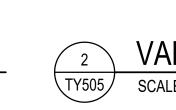

VANDAL RESISTANT DURESS PUSHBUTTON SCALE: N.T.S.

DURESS MUSHROOM PUSHBUTTON

1. THESE DETAILS ARE SCHEMATIC IN NATURE AND MAY NOT SHOW ALL EQUIPMENT OR CONNECTIONS REQUIRED. THEY ARE INTENDED TO ILLUSTRATE TYPICAL EQUIPMENT LAYOUTS AND DESCRIBE SECURITY HARDWARE OPERATIONS.



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 DESIGNED BY:
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PROJECT NUMBER: 201-0052-002


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SECURITY DEVICE DETAILS

SHEET NUMBER

TY506

BID DOCUMENTS

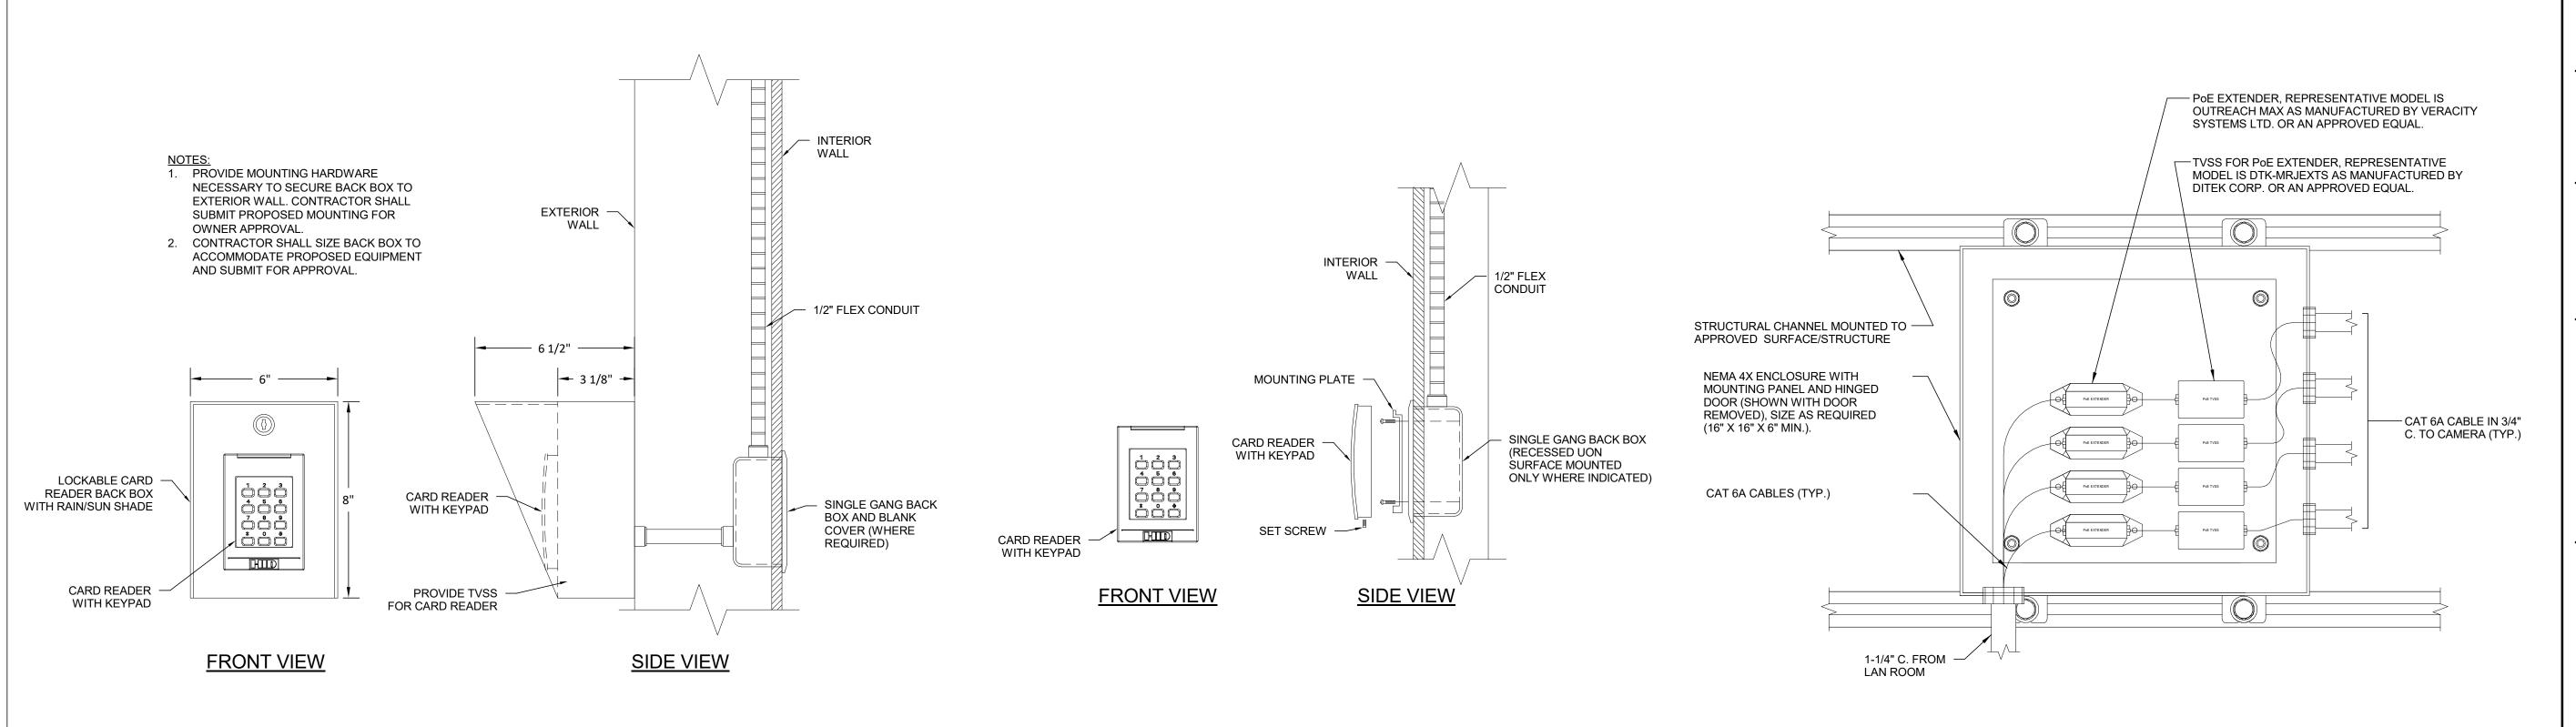

EXTERIOR CARD READER MOUNTING

CARD READER MOUNTING (TYP.)

SCALE: N.T.S.

POE EXTENDER JUNCTION BOX

SCALE: N.T.S.

TERMINALS, WIRE HORN AND

STROBE SEPARATELY

NOTE: REPRESENTATIVE MODEL IS

CSH-1224W-BW AS MANUFACTURED BY

POTTER ELECTRIC SIGNAL CO. REFER


TO MANUFACTURERS INSTALLATION

SETTINGS REQUIRED TO CONFIGURE

SHALL APPROVE FINAL SETTINGS TO BE USED IN EACH LOCATION.

THE UNIT. CBP REPRESENTATIVE

INSTRUCTIONS FOR SWITCH

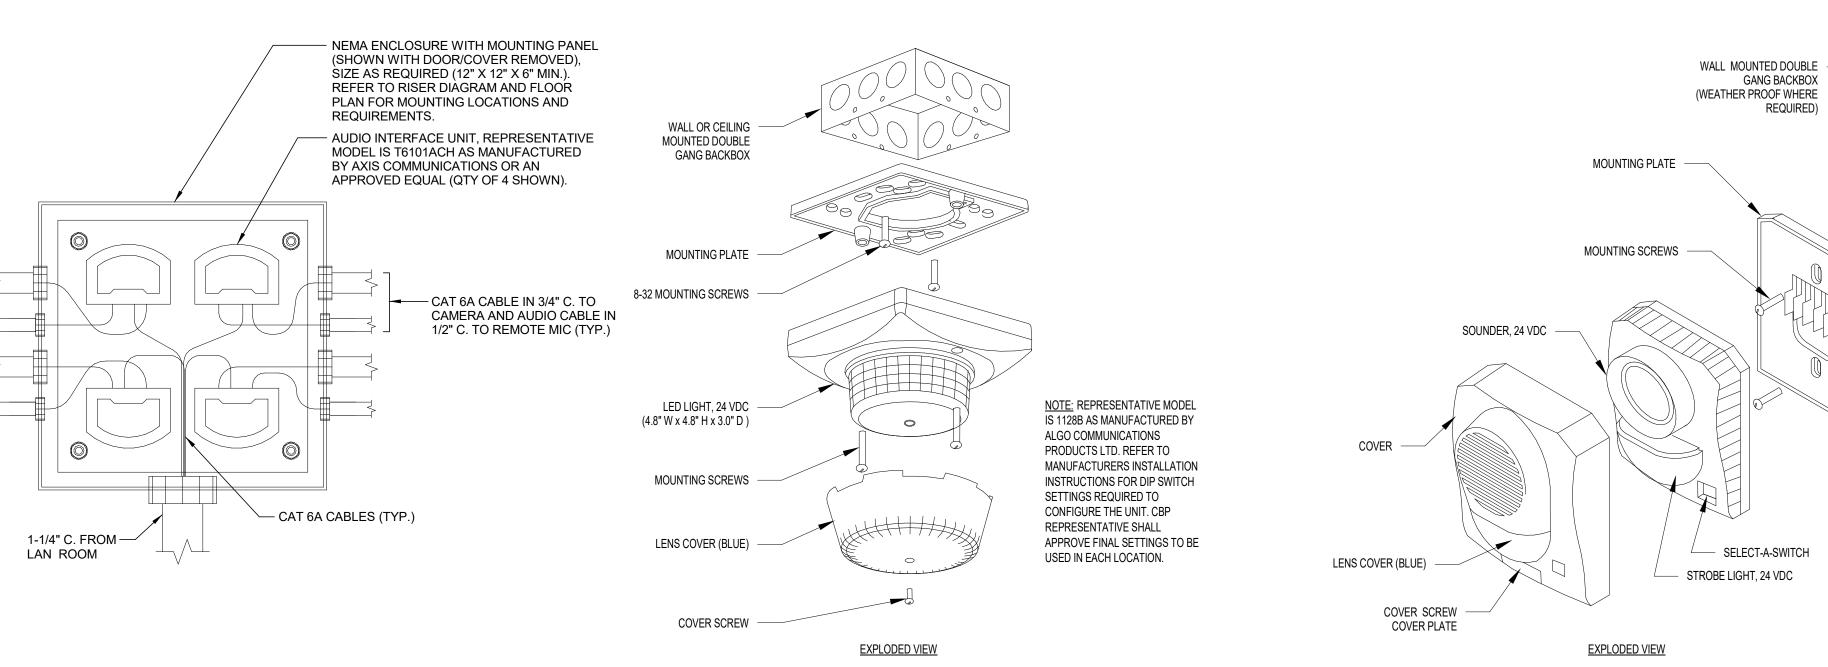

TY506

² VISUAL ANNUNCIATOR

SCALE: N.T.S.

1 L

LOCAL ANNUNCIATOR - HORN/STROBE

SCALE: N.T.S.

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SCALE: N.T.S.

\TY506/

AUDIO INTERFACE JUNCTION BOX

TY506 SCALE: N.T.S.

\TY507

SCALE: N.T.S.

NOTES:

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- 2. REFER TO THE SECURITY CAMERA SCHEDULE FOR INFORMATION SPECIFIC TO EACH CAMERA AND THE HARDWARE REQUIRED.
- 3. REFER TO THE CAMERA SCHEDULE FOR CAMERA CUE UP ASSOCIATED WITH SPECIFIC SECURITY DEVICES.

- CAT6A

(VIDEO\POE)

1-1/4" C. TO LAN ROOM



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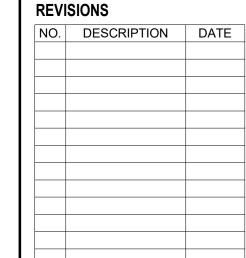
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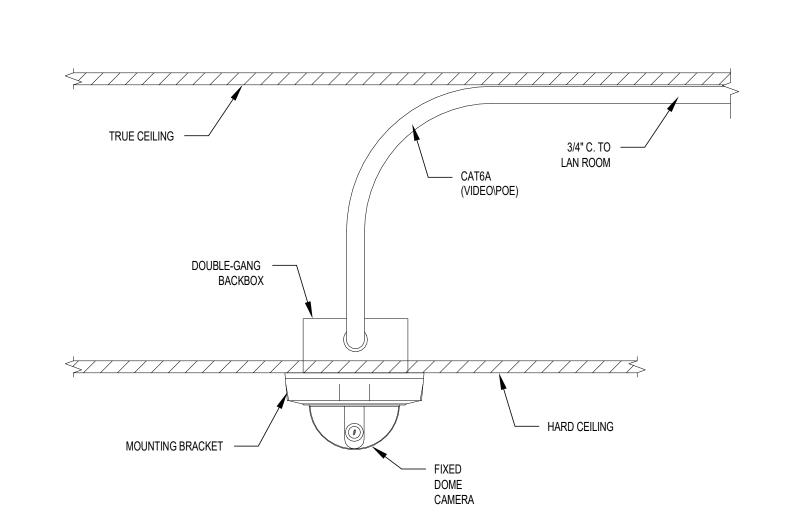
SHEET TITLE

SECURITY CAMERA DETAILS


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TY507

BID DOCUMENTS





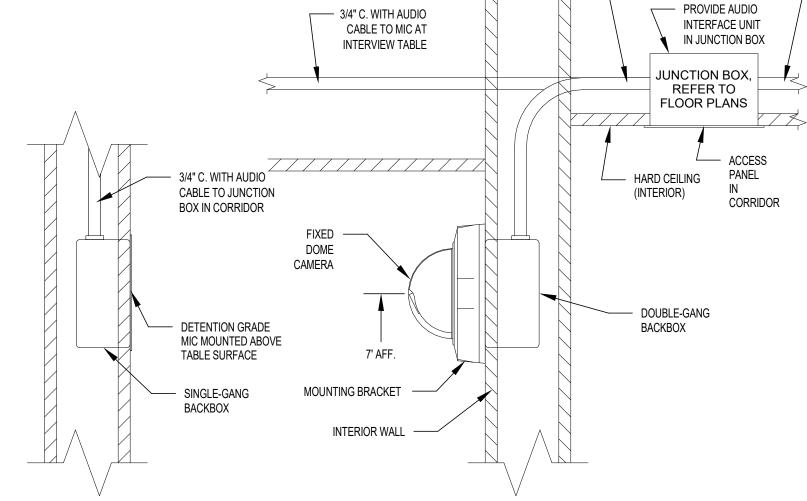


TRUE CEILING

SECURITY CAMERA TYPE D


\TY507/ SCALE: N.T.S.

TY507

SCALE: N.T.S.

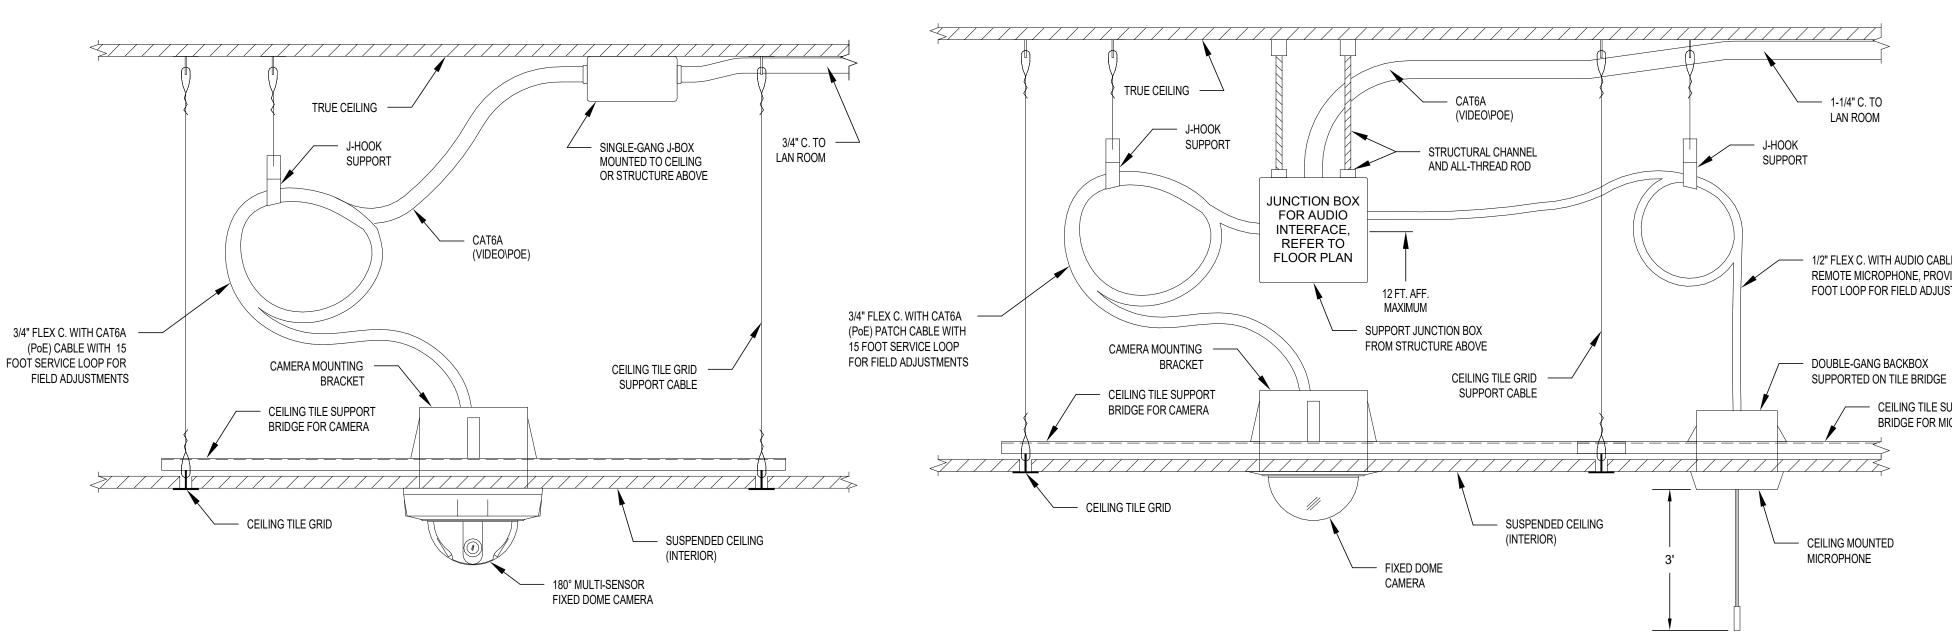

\TY507/

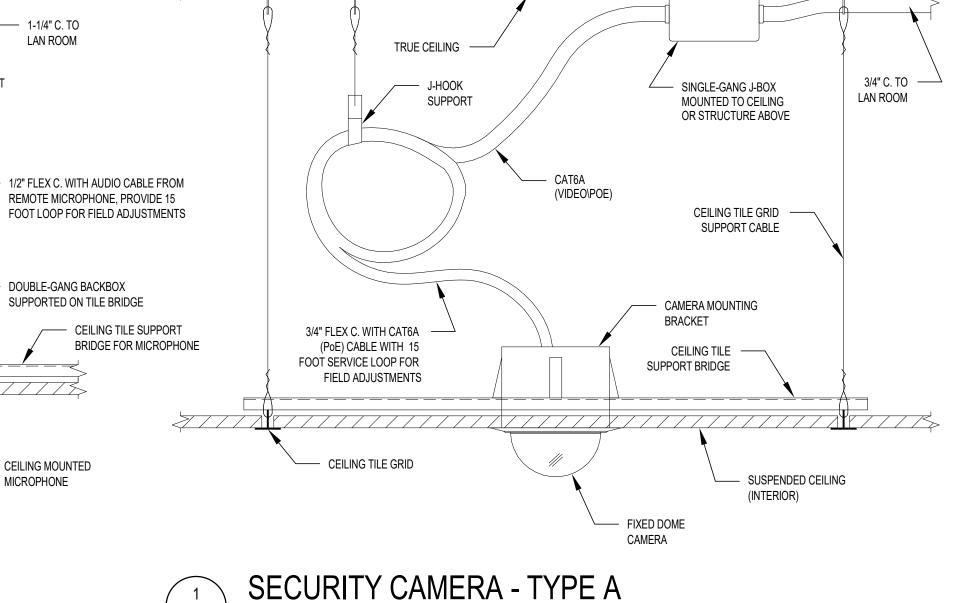

SECURITY CAMERA TYPE B

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SECURITY CAMERA TYPE C

TRUE CEILING

SINGLE-GANG

AUDIO CABLE -

BACKBOX

8' - 6" AFF.

8' AFF.

HARDENED WALL

DETENTION GRADE CAMERA

SECURITY CAMERA TYPE F

DETENTION

GRADE MIC

HARDENED CEILING

CONTOUR OF CAMERA HOUSING. COORDINATE

REQUIREMENTS WITH

THE ARCHITECT

SCALE: N.T.S.

STAINLESS STEEL

WRAP, MATCH

FRAMING

CAT6A

(VIDEO\POE)

HARD CEILING

DOUBLE-GANG BACKBOX

CABLE GROMMET IN

BACK OF CAMERA HOUSING

(INTERIOR)

1-1/4" C. TO LAN ROOM

JUNCTION BOX,

REFER TO

FLOOR PLANS

ACCESS

PANEL IN

CORRIDOR

TRUE

CEILING

PENDANT EXTENSION (SIZED AS REQUIRED)

SECURITY CAMERA TYPE I

SCALE: N.T.S.

ANCHOR BOLTS

EXTERIOR WALL

- 1. THESE DETAILS ARE SCHEMATIC IN NATURE AND MAY NOT SHOW ALL EQUIPMENT OR CONNECTIONS REQUIRED. THEY ARE INTENDED TO ILLUSTRATE TYPICAL EQUIPMENT LAYOUTS AND DESCRIBE SECURITY HARDWARE OPERATIONS.
- 2. REFER TO THE SECURITY CAMERA SCHEDULE FOR INFORMATION SPECIFIC TO EACH CAMERA AND THE HARDWARE REQUIRED.
- 3. REFER TO THE CAMERA SCHEDULE FOR CAMERA CUE UP ASSOCIATED WITH SPECIFIC SECURITY

3/4" C. TO -

SINGLE-GANG J-BOX MOUNTED TO CEILING

3/4" C. TO -LAN ROOM

(VIDEO\POE)

- SUSPENDED CEILING (INTERIOR)

— TRUE CEILING (INTERIOR)

LAN ROOM

CAT6A

PENDANT

BRACKET

MOUNTING

DOME CAMERA

(VIDEO\POE)



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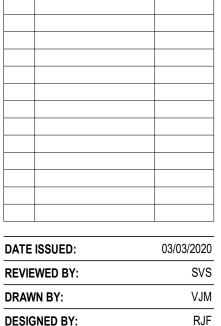
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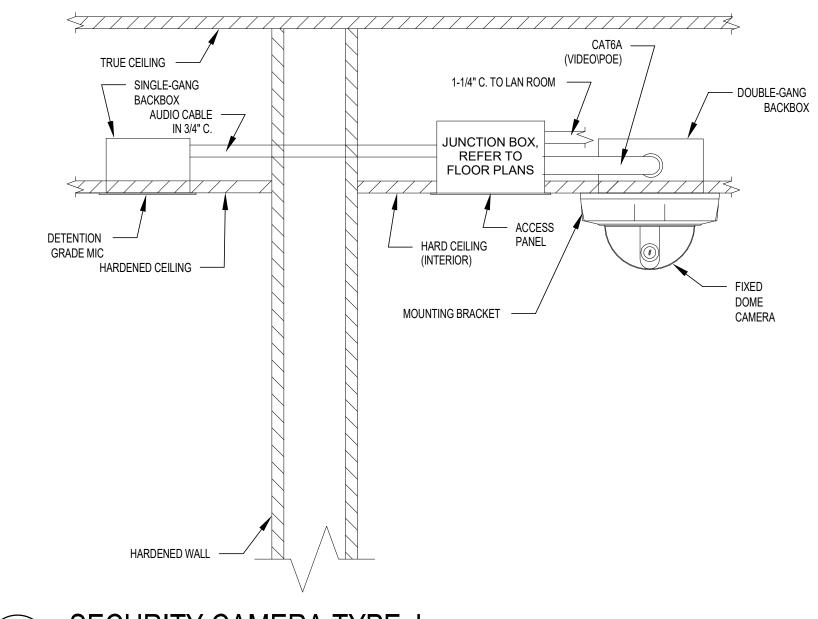
SHEET TITLE

SECURITY CAMERA DETAILS

SHEET NUMBER


TY508

BID DOCUMENTS








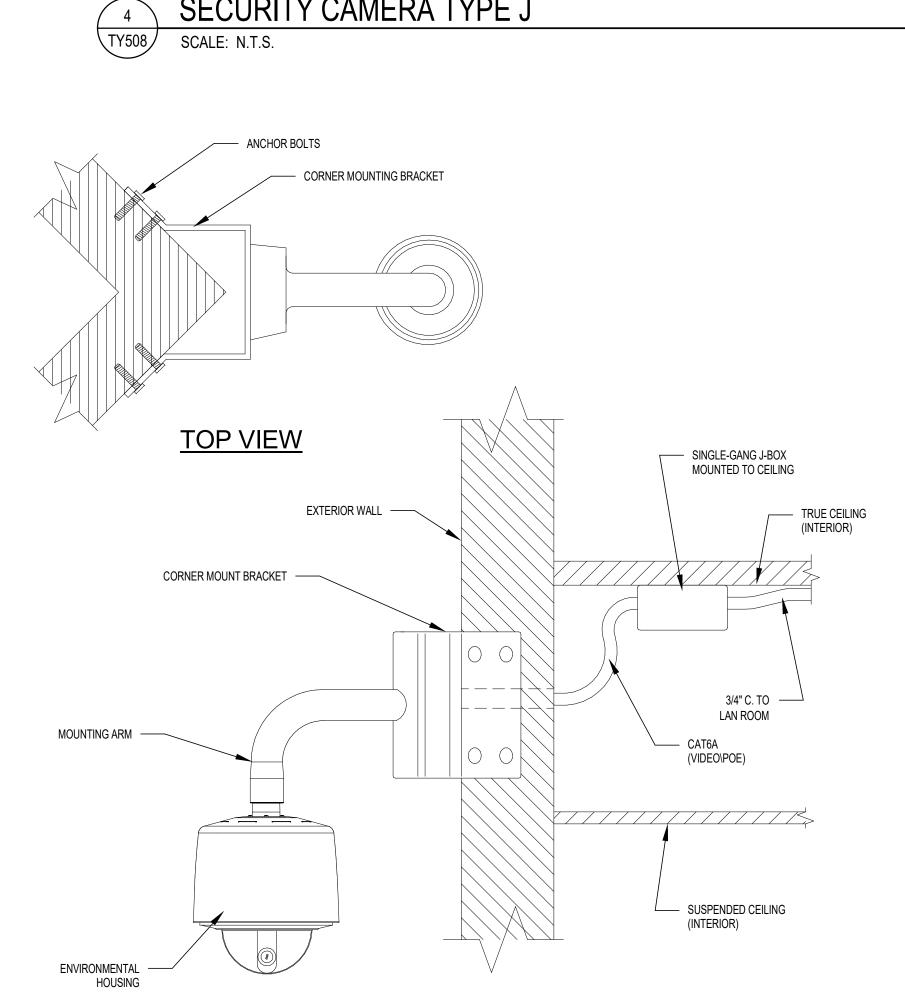





ENVIRONMENTAL HOUSING


MOUNTING ARM

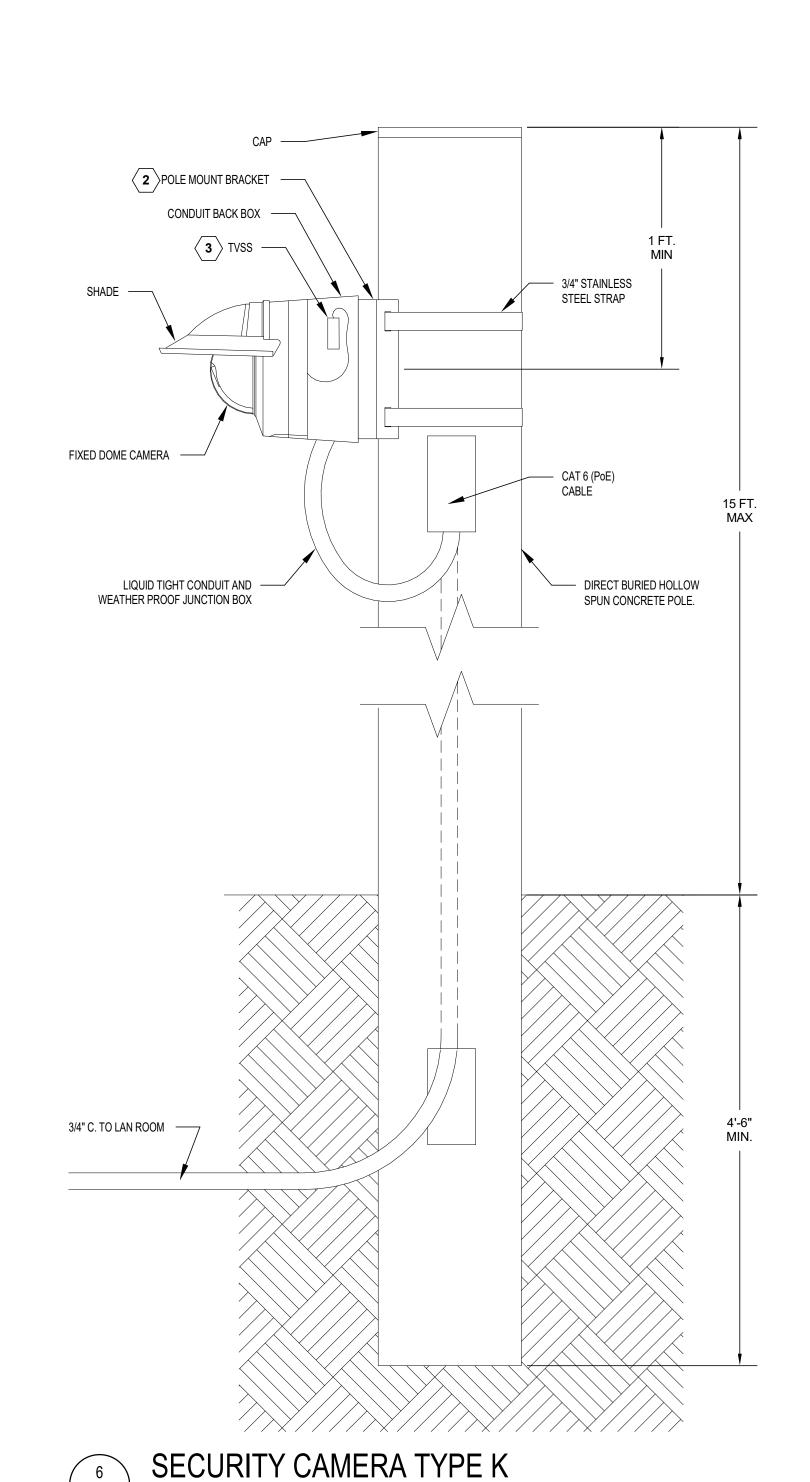

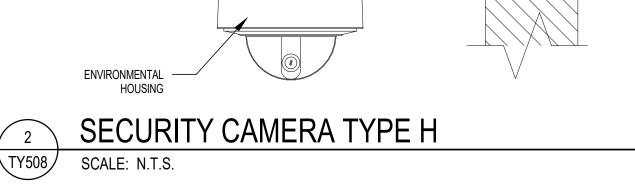

SCALE: N.T.S.

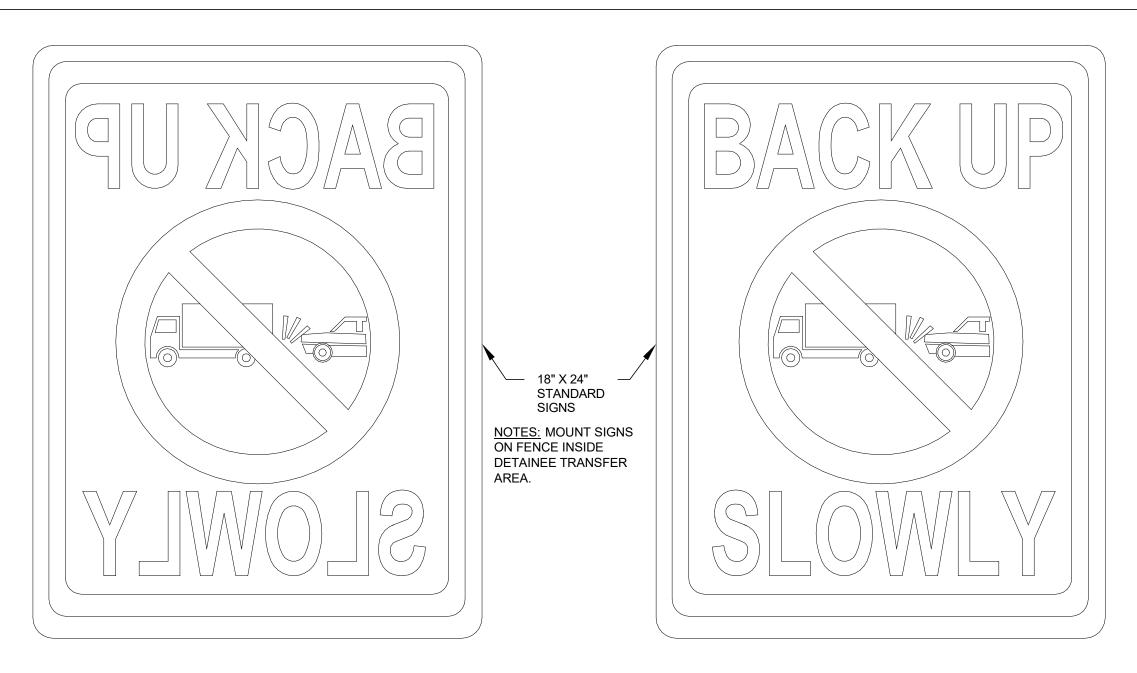

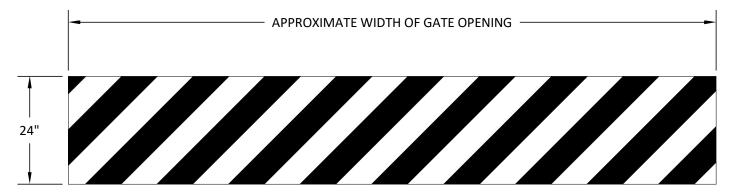

NOTES:

1. PAINT DIRECTLY ON FINISHED ROADWAY USING AN APPROVED BLACK AND YELLOW TRAFFIC PAINT (PROSTRIPE PLUS BY PROFESSIONAL PAVEMENT PRODUCTS (PPP) INC. OR EQUIVALENT) WITH ADDED GLASS BEADS (WEISSKER LUX GLASS BEADS BY PPP INC.) @ 6.25 LBS. PER GALLON.

2. PATTERN SHALL BE 5" WIDE STRIPES 10" O.C. @ 45 DEGREE ANGLE.



NOTES:

- THESE DETAILS ARE SCHEMATIC IN NATURE AND MAY NOT SHOW ALL EQUIPMENT OR CONNECTIONS REQUIRED. THEY ARE INTENDED TO ILLUSTRATE TYPICAL LAYOUTS.
- 2. UNLESS OTHERWISE NOTED, ALL EQUIPMENT SHALL BE PROVIDED BY
- 3. DIMENSION ARE FOR REFERENCE ONLY AND ARE DEPENDENT UPON THE EXISTING FIELD CONDITIONS.
- 4. REFER TO GATE LAYOUT PLANS ON SHEET TY102 FOR THE LOCATION OF PULL BOXES, PEDESTALS, AND BOLLARDS.

1. MOUNT WIDE-GAP MS TO STEEL POST AND MOUNT MAGNETS TO

MOUNTED TO CBP PARKING GATES ONLY.

ALUMINUM DRIVE RAIL ATTACHED TO SLIDING GATE. WIDE-GAP MS

KEYED NOTES:



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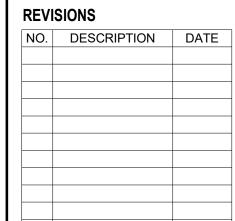
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SHEET TITLE

VEHICLE GATE DETAILS

SHEET NUMBER


TY509

BID DOCUMENTS







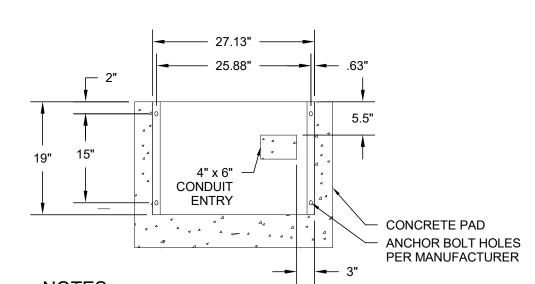


NOTES:

1. DIMENSIONS ARE PROVIDED FOR REFERENCE ONLY. ACTUAL DIMENSIONS ARE DEPENDANT UPON MANUFACTURER SELECTED. REPRESENTATIVE MODEL IS LXL SERIES MANUFACTURED BY B&B AMRA, INC.

GATE OPERATOR BASE DETAIL


SCALE: N.T.S.

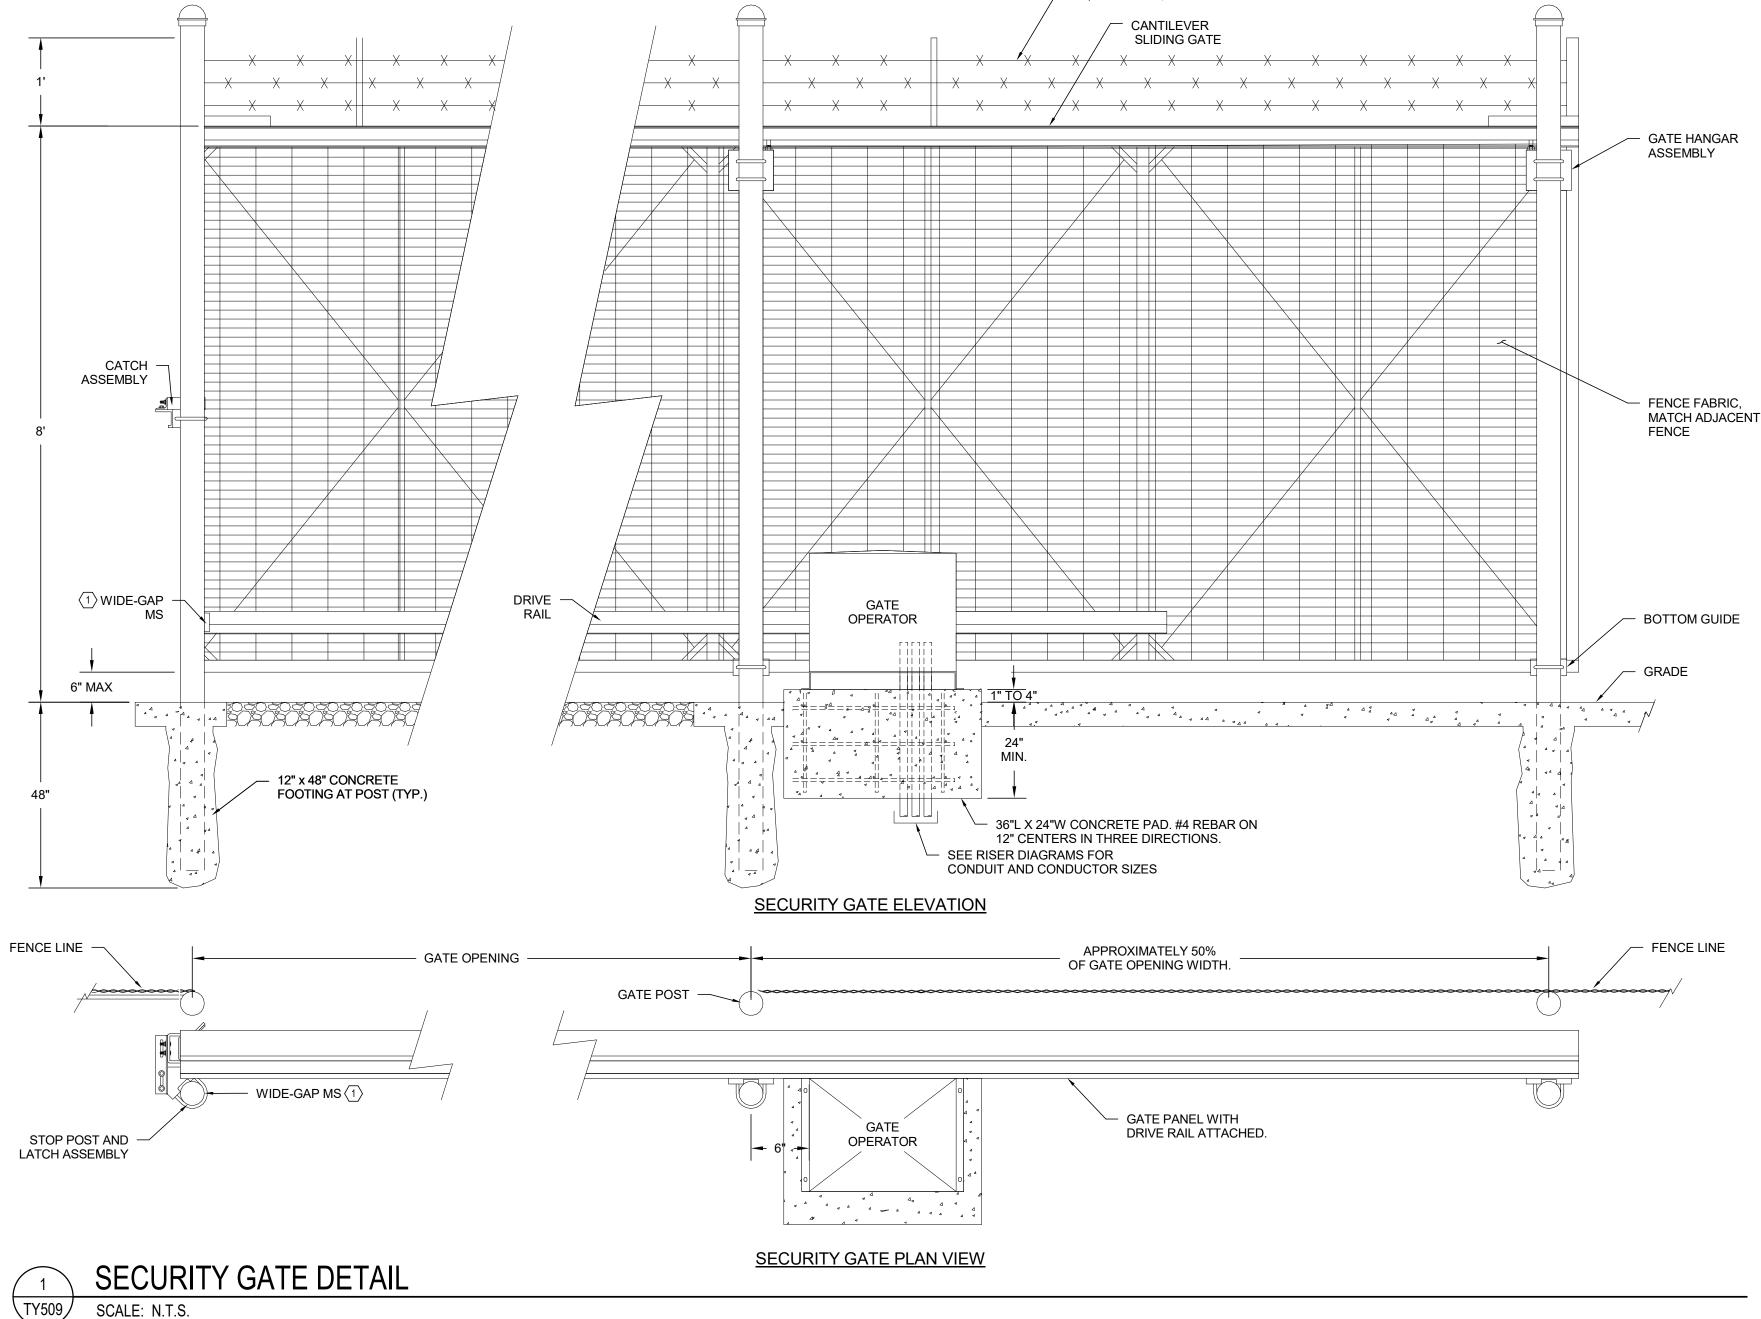

BARBED WIRE (3-STRANDS)

\TY509

SCALE: N.T.S.

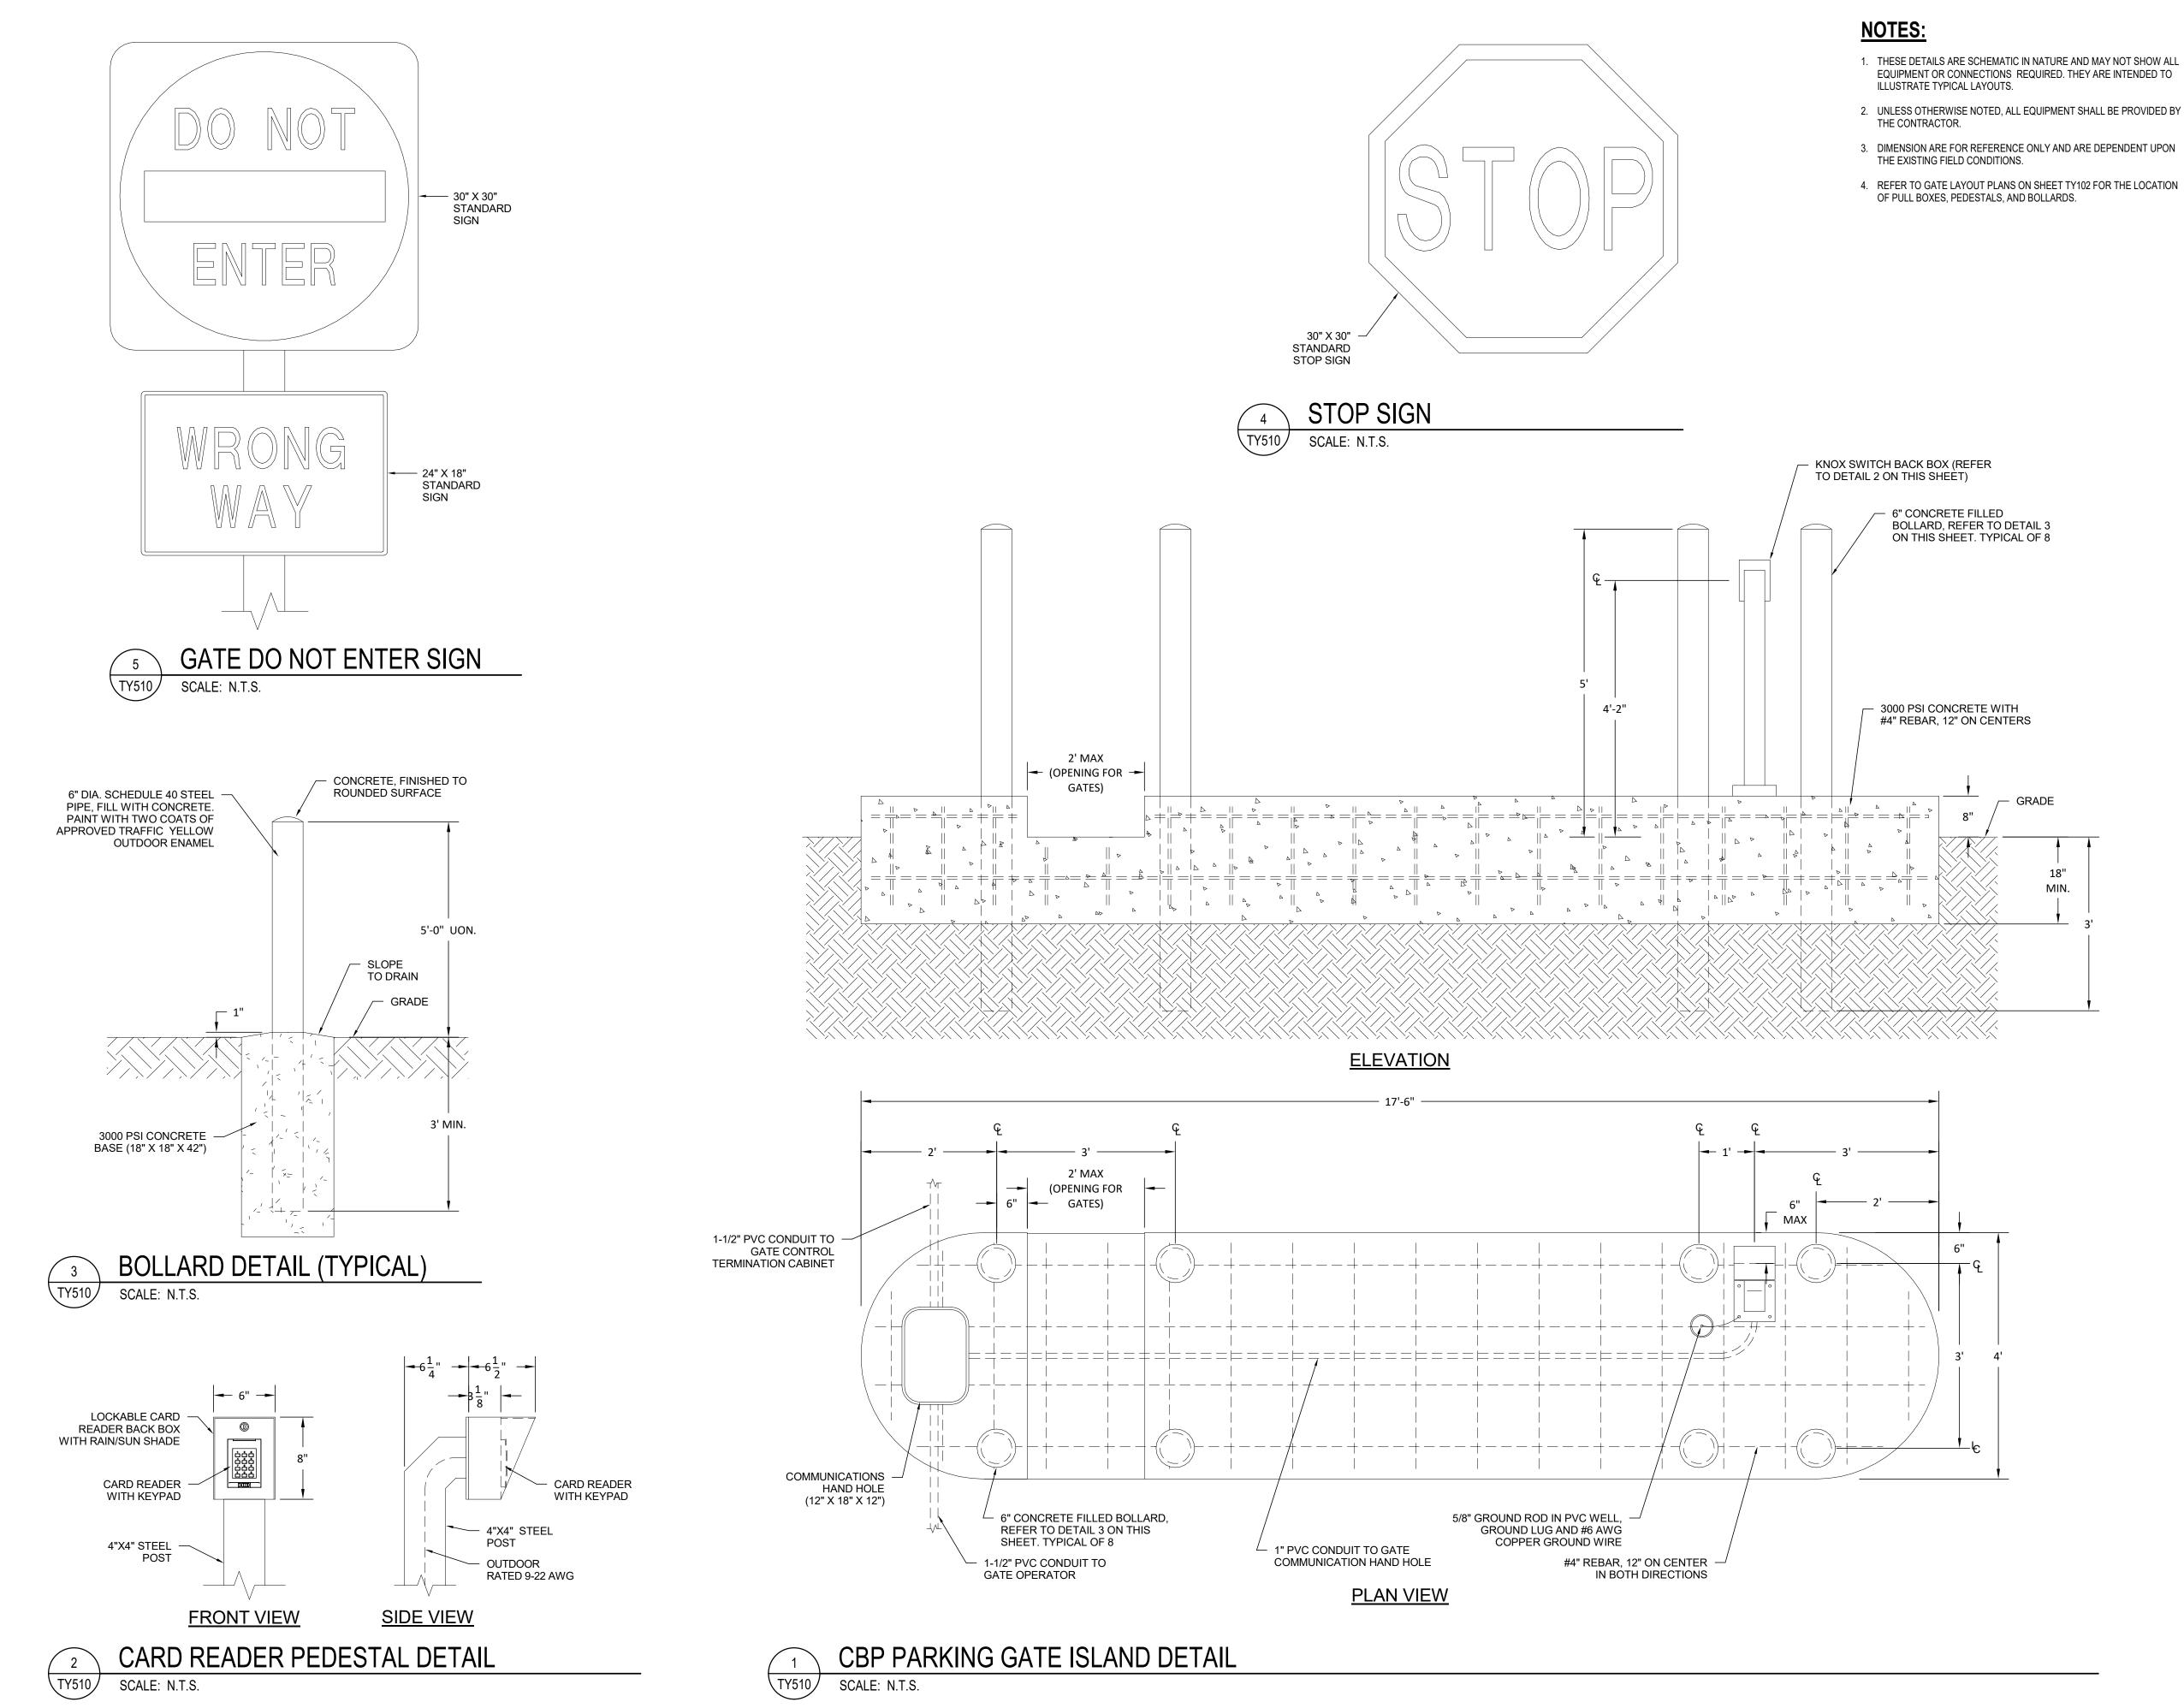

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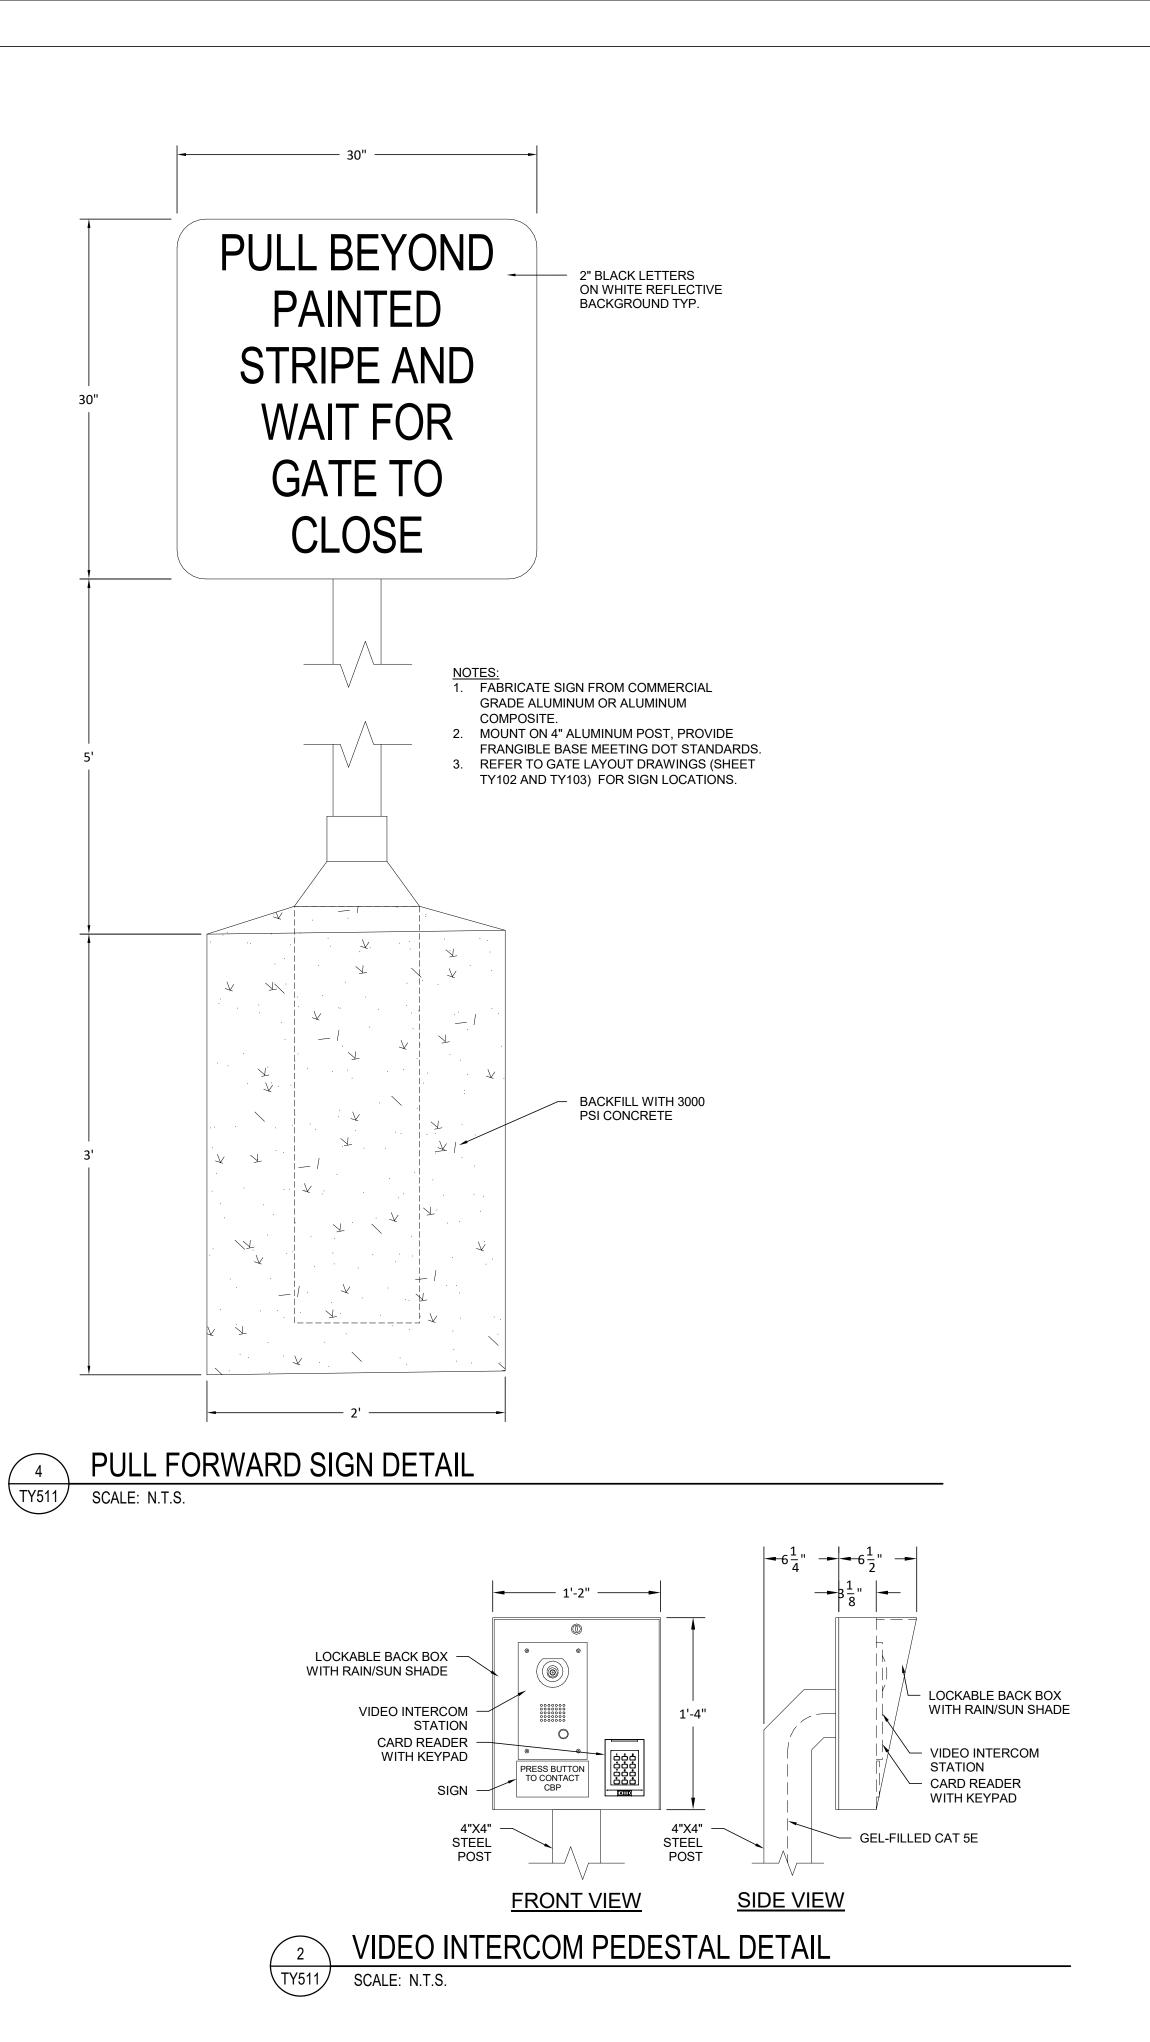
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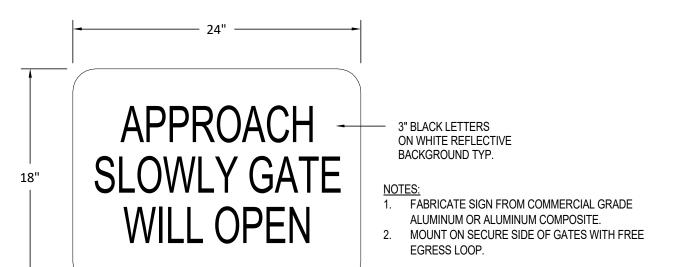
SHEET TITLE

VEHICLE GATE DETAILS


SHEET NUMBER

TY510






APPROACH SLOWLY SIGN DETAIL TY511/ SCALE: N.T.S.

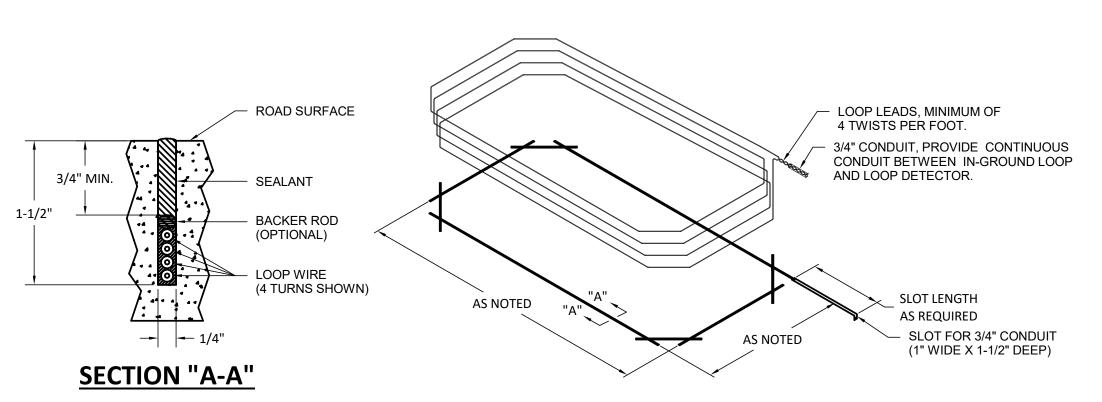

VEHCLE DETECTION LOOP (TYP.)

SCALE: N.T.S.

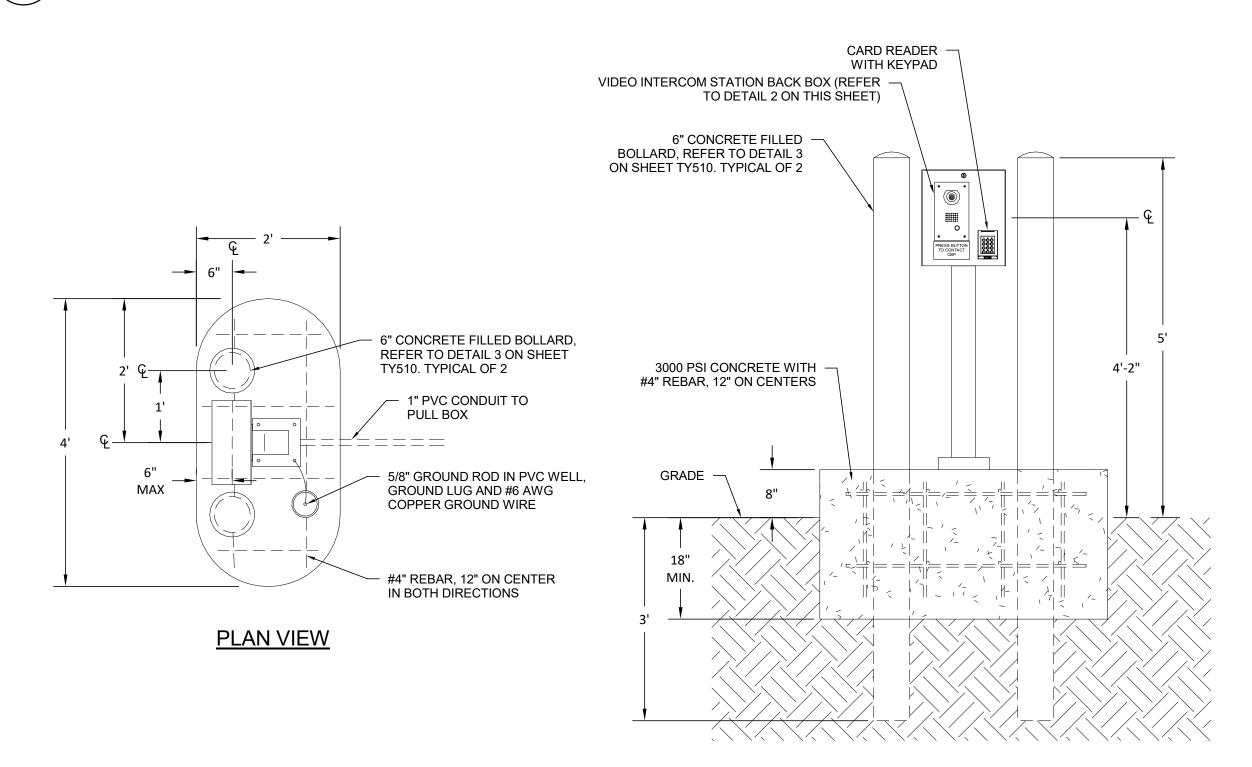

ELEVATION

NOTES:

ILLUSTRATE TYPICAL LAYOUTS.

THE EXISTING FIELD CONDITIONS.

OF PULL BOXES, PEDESTALS, AND BOLLARDS.

THE CONTRACTOR.

2. UNLESS OTHERWISE NOTED, ALL EQUIPMENT SHALL BE PROVIDED BY

3. DIMENSION ARE FOR REFERENCE ONLY AND ARE DEPENDENT UPON

4. REFER TO GATE LAYOUT PLANS ON SHEET TY102 FOR THE LOCATION

DETENTION SUITE GATE PEDESTAL DETAIL \TY511*/* SCALE: N.T.S.

1. THESE DETAILS ARE SCHEMATIC IN NATURE AND MAY NOT SHOW ALL EQUIPMENT OR CONNECTIONS REQUIRED. THEY ARE INTENDED TO

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DRAWN	I BY:	VJM

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VEHICLE GATE DETAILS

SHEET NUMBER

TY511

 CAMERA AND DOOR NUMBERS LISTED
 HEREIN INDICATE THE CAMERA OR DOOR
 DOOR DESIGNATION AS SHOWN ON THE DRAWINGS. FINAL CAMERA AND DOOR NUMBERS FOR SYSTEM CONFIGURATION AND PROGRAMMING TO BE DETERMINED BY CBP AND THE OWNER AS COORDINATED BY THE CONTRACTOR.

REFER TO FLOOR PLANS FOR LOCATION OF CAMERAS AND DOORS AS INDICATED BY SHEET NUMBER.

3. REFER TO ABBREVIATIONS LIST ON SHEET T001 FOR DEVICE IDENTIFIERS.

REFER TO SECURITY CAMERA DETAILS ON SHEETS TY507 AND TY508 FOR TYPICAL MOUNTING DETAILS FOR EACH CAMERA TYPE AS IDENTIFIED BY NUMBER.

. CONTRACTOR SHALL REVIEW THE MOUNTING TYPE AND COORDINATE MOUNTING HARDWARE TO MEET THE FIELD CONDITIONS. ANY CONFLICTS SHALL BE IMMEDIATELY BROUGHT TO THE ATTENTION OF THE DESIGNER.

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DRAW	/N BY:	V
DESIG	SNED BY:	F
PROJ	ECT NUMBER:	

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SECURITY CAMERA SCHEDULE

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SHEET TITLE

SHEET NUMBER

TY601

									PNS GAF SECU	RITY CAMERA	SCHEDU	LE						
CAMERA NUMBER	CAMERA TYPE	DESCRIPTION	CAMERA MANUFACTURER	CAMERA MODEL	LE	ENS	SHEET NUMBER	LOCATION	PRESET POSITION/CAMERA CUE-UP	ALARM ACTIVATION	MOUNT	MOUNTING HEIGHT	HOUSING	PRIMARY MONITORING	SECONDARY MONITORING	CAMERA DETAIL	EQUIPMENT ROOM	ACTION
100A	A	3 MP FIXED IP HD CAMERA	AXIS	M3026-VE	3.0-10.5 mm	VARI-FOCAL	TY101	PRE-PROCESSING (ROOM 100)	DOOR 100A	DOOR 100A/BMS	CEILING	10 FT.	INTERIOR	СВР	NONE	А	112	PROVIDE CEILING MOUNTED FIXED INDOOR DOME.
100B	А	3 MP FIXED IP HD CAMERA	AXIS	M3026-VE	3.0-10.5 mm	VARI-FOCAL	TY101	PRE-PROCESSING (ROOM 100)	DOOR 100B	DOOR 100B/BMS	CEILING	10 FT.	INTERIOR	СВР	NONE	А	112	PROVIDE CEILING MOUNTED FIXED INDOOR DOME.
103A	В	5 MP FIXED IP HD CAMERA	AXIS	P3227-VL	3.0-10.5 mm	VARI-FOCAL	TY101	PROCESSING AREA (ROOM 103)	PRIMARY PROCESSING	PODIUM DURESS BUTTONS	CEILING	10 FT.	INTERIOR	СВР	NONE	A	112	PROVIDE CEILING MOUNTED FIXED INDOOR DOME.
103B	В	5 MP FIXED IP HD CAMERA	AXIS	P3227-VL	3.0-10.5 mm	VARI-FOCAL	TY101	PROCESSING AREA (ROOM 103)	PRIMARY PROCESSING	PODIUM DURESS BUTTON	CEILING	10 FT.	INTERIOR	СВР	NONE	А	112	PROVIDE CEILING MOUNTED FIXED INDOOR DOME.
103C	В	5 MP FIXED IP HD CAMERA	AXIS	P3227-VL	3.0-10.5 mm	VARI-FOCAL	TY101	PRIMARY PROCESSING PODIUM (ROOM 103)	PRIMARY PROCESSING	PODIUM DURESS BUTTONS	CEILING	10 FT.	INTERIOR	СВР	NONE	А	112	PROVIDE CEILING MOUNTED FIXED INDOOR DOME.
103D	В	5 MP FIXED IP HD CAMERA	AXIS	P3227-VL	3.0-10.5 mm	VARI-FOCAL	TY101	PRIMARY PROCESSING PODIUM (ROOM 103)	PRIMARY PROCESSING	PODIUM DURESS BUTTON	CEILING	10 FT.	INTERIOR	СВР	NONE	A	112	PROVIDE CEILING MOUNTED FIXED INDOOR DOME.
103E	В	5 MP FIXED IP HD CAMERA	AXIS	P3227-VL	3.0-10.5 mm	VARI-FOCAL	TY101	PRIMARY PROCESSING PODIUM (ROOM 103)	PRIMARY PROCESSING	PODIUM DURESS BUTTON	CEILING	10 FT.	INTERIOR	СВР	NONE	A	112	PROVIDE CEILING MOUNTED FIXED INDOOR DOME.
103F	В	5 MP FIXED IP HD CAMERA	AXIS	P3227-VL	3.0-10.5 mm	VARI-FOCAL	TY101	CBP PODIUM (ROOM 103)	PRIMARY PROCESSING PODIUM	PODIUM DURESS BUTTON	CEILING	10 FT.	INTERIOR	СВР	NONE	В	112	PROVIDE CEILING MOUNTED FIXED INDOOR DOME. PROVIDE CEIL MOUNTED PENDANT EXTERNAL MICROPHONE AND AUDIO INTERFA
103G	В	5 MP FIXED IP HD CAMERA	AXIS	P3227-VL	3.0-10.5 mm	VARI-FOCAL	TY101	CBP PODIUM (ROOM 103)	PRIMARY PROCESSING PODIUM	PODIUM DURESS BUTTON	CEILING	10 FT.	INTERIOR	СВР	NONE	В	112	UNIT. PROVIDE CEILING MOUNTED FIXED INDOOR DOME. PROVIDE CEIL MOUNTED PENDANT EXTERNAL MICROPHONE AND AUDIO INTERFA
103H	В	5 MP FIXED IP HD CAMERA	AXIS	P3227-VL	3.0-10.5 mm	VARI-FOCAL	TY101	X-RAY INSPECTION TABLES (ROOM 103)	PRIMARY PROCESSING X-RAY STATION	PODIUM DURESS BUTTON	CEILING	10 FT.	INTERIOR	СВР	NONE	В	112	PROVIDE CEILING MOUNTED FIXED INDOOR DOME. PROVIDE CEIL MOUNTED PENDANT EXTERNAL MICROPHONE AND AUDIO INTERFAUNIT.
105A	В	5 MP FIXED IP HD CAMERA	AXIS	P3227-VL	3.0-10.5 mm	VARI-FOCAL	TY101	DETENTION CORRIDOR (ROOM 105)	DOOR 110C	DOOR 110C/BMS, DURESS BUTTON	CEILING	10 FT.	INTERIOR	СВР	NONE	J	112	PROVIDE CEILING MOUNTED FIXED INDOOR DOME. PROVIDE CEIL MOUNTED DETENTION GRADE EXTERNAL MICROPHONE AND AUDIO INTERFACE UNIT.
105B	В	5 MP FIXED IP HD CAMERA	AXIS	P3227-VL	3.0-10.5 mm	VARI-FOCAL	TY101	DETENTION CORRIDOR (ROOM 105)	DOOR 105A	DOOR 105B/BMS	CEILING	10 FT.	INTERIOR	СВР	NONE	E	112	PROVIDE CEILING MOUNTED FIXED INDOOR DOME.
105C	В	5 MP FIXED IP HD CAMERA	AXIS	P3227-VL	3.0-10.5 mm	VARI-FOCAL	TY101	DETENTION CORRIDOR (ROOM 105)	DOOR 105B	DOOR 105B/BMS	CEILING	10 FT.	INTERIOR	СВР	NONE	E	112	PROVIDE CEILING MOUNTED FIXED INDOOR DOME.
106	В	5 MP FIXED IP HD CAMERA	AXIS	P3227-VL	3.0-10.5 mm	VARI-FOCAL	TY101	INTERVIEW ROOM (ROOM 106)	INTERVIEW TABLE	DURESS BUTTONS	WALL	7 FT.	INTERIOR	СВР	NONE	D	112	PROVIDE WALL MOUNTED FIXED INDOOR DOME. PROVIDE CEILING MOUNTED DETENTION GRADE EXTERNAL MICROPHONE AND AUDITORIES UNIT.
108	E	1.3 MP FIXED IP HD CAMERA	AXIS	Q8414-LVS	2.5-6 mm	VARI-FOCAL	TY101	HOLD ROOM (ROOM 108)	HOLDING CELL	DURESS BUTTON	CORNER	10 FT.	INTERIOR	СВР	NONE	F	112	PROVIDE FIXED INDOOR CAMERA IN DETENTION GRADE CORNER MOUNT HOUSING. PROVIDE CEILING MOUNT DETENTION GRADE EXTERNAL MICROPHONE CONNECTED TO AUDIO INPUT ON CAMER
110A	A	3 MP FIXED IP HD CAMERA	AXIS	M3026-VE	3.0-10.5 mm	VARI-FOCAL	TY101	CORRIDOR (ROOM 110)	CORRIDOR	DOORS 112, 113A, 123, 124/BMS	CEILING	10 FT.	INTERIOR	СВР	NONE	А	112	PROVIDE CEILING MOUNTED FIXED INDOOR DOME.
110B	A	3 MP FIXED IP HD CAMERA	AXIS	M3026-VE	3.0-10.5 mm	VARI-FOCAL	TY101	CORRIDOR (ROOM 110)	DOOR 110C	-	CEILING	10 FT.	INTERIOR	СВР	NONE	A	112	PROVIDE CEILING MOUNTED FIXED INDOOR DOME.
110C	A	3 MP FIXED IP HD CAMERA	AXIS	M3026-VE	3.0-10.5 mm	VARI-FOCAL	TY101	CORRIDOR (ROOM 110)	CONFERENCE ROOM (ROOM 116)	-	CEILING	10 FT.	INTERIOR	СВР	NONE	А	112	PROVIDE CEILING MOUNTED FIXED INDOOR DOME.
110D	A	3 MP FIXED IP HD CAMERA	AXIS	M3026-VE	3.0-10.5 mm	VARI-FOCAL	TY101	CORRIDOR (ROOM 110)	DOOR 110B	DOOR 110B/BMS	CEILING	10 FT.	INTERIOR	СВР	NONE	A	112	PROVIDE CEILING MOUNTED FIXED INDOOR DOME.
111	A	3 MP FIXED IP HD CAMERA	AXIS	M3026-VE	3.0-10.5 mm	VARI-FOCAL	TY101	SECURE STORAGE (ROOM 111)	DOOR 111	DOOR 110B/BMS	CEILING	10 FT.	INTERIOR	СВР	NONE	E	112	PROVIDE CEILING MOUNTED FIXED INDOOR DOME.
112	A	3 MP FIXED IP HD CAMERA	AXIS	M3026-VE	3.0-10.5 mm	VARI-FOCAL	TY101	LAN/SLAN (ROOM 112)	DOOR 112	DOORS 112A, 112B/BMS	CEILING	10 FT.	INTERIOR	СВР	NONE	A	112	PROVIDE CEILING MOUNTED FIXED INDOOR DOME.
114	А	3 MP FIXED IP HD CAMERA	AXIS	M3026-VE	3.0-10.5 mm	VARI-FOCAL	TY101	PUBLIC LOBBY (ROOM 114)	DOOR X114A	DOOR X114A/BMS, DURESS BUTTON	CEILING	10 FT.	INTERIOR	СВР	NONE	А	112	PROVIDE CEILING MOUNTED FIXED INDOOR DOME.

								PNS GAF SECU	RITY CAMERA	A SCHEDU	JLE						
CAMERA NUMBER	CAMERA TYPE	DESCRIPTION	CAMERA MANUFACTURER	CAMERA MODEL	LENS	SHEET NUMBER	LOCATION	PRESET POSITION/CAMERA CUE-UP	ALARM ACTIVATION	MOUNT	MOUNTING HEIGTH	HOUSING	PRIMARY MONITORING	SECONDARY MONITORING	CAMERA DETAIL	EQUIPMENT ROOM	ACTION
X01	A	3 MP FIXED IP HD CAMERA	AXIS	M3026-VE	3.0-10.5 mm VARI-FOCA	TY100, TY101	PASSENGER WAITING PORCH (690)	APRON	-	WALL	10 FT.	EXTERIOR	CBP	AIRPORT	G	112	PROVIDE WALL MOUNTED OUTDOOR FIXED DOME.
X02	А	3 MP FIXED IP HD CAMERA	AXIS	M3026-VE	3.0-10.5 mm VARI-FOCA	TY100, TY101	PASSENGER WAITING PORCH (690)	ENTRY/PORCH	-	CEILING	10 FT.	EXTERIOR	CBP	AIRPORT	E	112	PROVIDE CEILING MOUNTED OUTDOOR FIXED DOME.
X03	D	8 MP PTZ IP HD CAMERA	AXIS	Q6128-E	4.3-129 mm PTZ	TY100, TY101	PASSENGER WAITING PORCH (690)	LANDSIDE EXTERIOR	-	CEILING	10 FT.	EXTERIOR	CBP	AIRPORT	Е	112	PROVIDE CEILING MOUNTED OUTDOOR FIXED DOME.
X04	A	3 MP FIXED IP HD CAMERA	AXIS	M3026-VE	3.0-10.5 mm VARI-FOCA	TY100, TY101	PASSENGER WAITING PORCH (690)	ENTRY DOOR 103 AND PORCH	-	CEILING	10 FT.	EXTERIOR	CBP	AIRPORT	E	112	PROVIDE CEILING MOUNTED OUTDOOR FIXED DOME.
X05	A	3 MP FIXED IP HD CAMERA	AXIS	M3026-VE	3.0-10.5 mm VARI-FOCA	TY100, TY101	NORTH WEST EXTERIOR CORNER	WEST SIDE AND ENTRY DOOR 110B	-	WALL	10 FT.	EXTERIOR	CBP	AIRPORT	G	112	PROVIDE WALL MOUNTED OUTDOOR FIXED DOME.
X06	A	3 MP FIXED IP HD CAMERA	AXIS	M3026-VE	3.0-10.5 mm VARI-FOCA	TY100, TY101	SOUTH WEST EXTERIOR CORNER	PUBLIC LOBBY ENTRY DOOR X114A	-	CEILING	10 FT.	EXTERIOR	CBP	AIRPORT	I	112	PROVIDE PENDANT MOUNTED OUTDOOR FIXED DOME.
X07	A	3 MP FIXED IP HD CAMERA	AXIS	M3026-VE	3.0-10.5 mm VARI-FOCA	TY100, TY101	SOUTH EXTERIOR	PUBLIC LOBBY ENTRY DOOR X114A	-	WALL	10 FT.	EXTERIOR	СВР	AIRPORT	G	112	PROVIDE WALL MOUNTED OUTDOOR FIXED DOME.
X08	A	3 MP FIXED IP HD CAMERA	AXIS	M3026-VE	3.0-10.5 mm VARI-FOCA	TY100, TY101	SOUTH EAST EXTERIOR CORNER	DETAINEE TRANSFER GATE	-	WALL	10 FT.	EXTERIOR	CBP	AIRPORT	G	112	PROVIDE WALL MOUNTED OUTDOOR FIXED DOME.
X09	С	15 MP 180° FIXED IP HD CAMERA	AXIS	Q3708-PVE	(3) 5.0 mm VARI-FOCA	TY100, TY101	DETAINEE TRANSFER AREA	DETAINEE TRANSFER AREA	-	WALL	10 FT.	EXTERIOR	СВР	AIRPORT	G	112	PROVIDE WALL MOUNTED OUTDOOR FIXED DOME.
X10	С	15 MP 180° FIXED IP HD CAMERA	AXIS	Q3708-PVE	(3) 5.0 mm VARI-FOCA	TY100, TY101	DETAINEE TRANSFER AREA	DETAINEE TRANSFER AREA	-	POLE	10 FT.	EXTERIOR	СВР	AIRPORT	K	112	PROVIDE POLE MOUNTED OUTDOOR FIXED DOME.
V01	F	1.23 MP FIXED IP VIDEO INTERCOM	AIPHONE	IX-DVF	2.5 mm VARI-FOCA	TY100, TY101	PUBLIC LOBBY (ROOM 114)	-	-	WALL	4.5 FT	INTERIOR	СВР	NONE	SEE NOTE	112	PROVIDE WALL MOUNTED VIDEO INTERCOM STATION.
V02	F	1.23 MP FIXED IP VIDEO INTERCOM	AIPHONE	IX-DVF	2.5 mm VARI-FOCA	TY100, TY101	DETAINEE TRANSFER AREA	-	-	PEDESTAL	4.5 FT	EXTERIOR	СВР	NONE	SEE NOTE	112	PROVIDE PEDESTAL MOUNTED VIDEO INTERCOM STATION.
				+	+	+			+	1	1	+	1	1			

- 1. CAMERA AND DOOR NUMBERS LISTED HEREIN INDICATE THE CAMERA OR DOOR DOOR DESIGNATION AS SHOWN ON THE DRAWINGS. FINAL CAMERA AND DOOR NUMBERS FOR SYSTEM CONFIGURATION AND PROGRAMMING TO BE DETERMINED BY CBP AND THE OWNER AS COORDINATED BY THE CONTRACTOR.
- 2. REFER TO FLOOR PLANS FOR LOCATION OF CAMERAS AND DOORS AS INDICATED BY SHEET NUMBER.
- REFER TO ABBREVIATIONS LIST ON SHEET T001 FOR DEVICE IDENTIFIERS.
- 4. REFER TO SECURITY CAMERA DETAILS ON SHEETS TY507 AND TY508 FOR TYPICAL MOUNTING DETAILS FOR EACH CAMERA TYPE AS IDENTIFIED BY NUMBER.
- 5. CONTRACTOR SHALL REVIEW THE MOUNTING TYPE AND COORDINATE MOUNTING HARDWARE TO MEET THE FIELD CONDITIONS. ANY CONFLICTS SHALL BE IMMEDIATELY BROUGHT TO THE ATTENTION OF THE DESIGNER.

RS&

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PENSACOLA INTERNATIONAL AIRPORT

PENSACOLA, FLORIDA

PENSACOLA
GENERAL
AVIATION
FACILITY (GAF)



PROFESSIONAL SEAL



REVIS	SIONS	
NO.	DESCRIPTION	DA

DATE ISSUED: 03/03/2020

REVIEWED BY: SVS

DRAWN BY: VJM

DESIGNED BY: RJF

PROJECT NUMBER:

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SECURITY CAMERA SCHEDULE

SHEET NUMBER

TY602

	113B	TY101	ENTRANCE OFFICE (113)	1		1	1		1					1	-	1A	112
	114	TY101	PUBLIC LOBBY (114)		1			2				1			-	3	112
	123	TY101	SUPERVISORS OFFICE (ROOM 123)	1		1	1		1	1			1		-	13	112
	124	TY101	LACTATION ROOM (ROOM 124)							1	1		1		-	10	112
	125	TY101	ELECTRIC ROOM (ROOM 125)	1		1	1	1							-	1	112
19.rvt	126	TY101	MECHANICAL ROOM (ROOM 126)	1		1	1	1							-	1	112
_GAF_E_R	P1	TY101	SECURE PARKING AREA	2		1			1						-	15	GCTC1
.2001_PNS	GATE-1	TS101	SECURE PARKING AREA VEHICLE GATE	1					2						-	SEE NOTES	GCTC1
3AF/20100£	GATE-2	TS101	DETAINIEE TRANSFER VEHICLE GATE	2					1					1	-	SEE NOTES	112
360://PNS (-	TY101	PROCESSING AREA PODIUMS (ROOM 103)							,	1		4 2		-	-	112
PM BIM	-	TY101	PROCESSING AREA X-RAY STATION (ROOM 103)							,	1		1 1		-	-	112
<u> </u>																	

- CAMERA AND DOOR NUMBERS LISTED HEREIN INDICATE THE CAMERA OR DOOR DOOR DESIGNATION AS SHOWN ON THE DRAWINGS. FINAL CAMERA AND DOOR NUMBERS FOR SYSTEM CONFIGURATION AND PROGRAMMING TO BE DETERMINED BY CBP AND THE OWNER AS COORDINATED BY THE CONTRACTOR.
- REFER TO FLOOR PLANS FOR LOCATION OF CAMERAS AND DOORS AS INDICATED BY SHEET NUMBER.
- DEVICES INDICATED ARE REQUIRED TO CONFIGURE THE ACCESS CONTROL AND ALARM ANNUNCIATION FUNCTIONS REQUIRED. CONTRACTOR SHALL PROVIDE ALL ANCILLARY DEVICES (RELAYS, TIMERS, RESISTORS, ETC.) TO COMPLETE THE INSTALLATION AND CONFIGURATION OF DEVICES WITH THE ACCESS CONTROL
- REFER TO DIVISION 08 "DOOR HARDWARE" SPECIFICATION FOR ELECTRIFIED LOCKING REQUIREMENTS. REFER TO DIVISION 28 "ACCESS CONTROL" SPECIFICATION FOR AND DETAILS IN THE DRAWINGS FOR SECURITY DEVICE REQUIREMENTS.
- REFER TO ABBREVIATIONS LIST ON SHEET T001 FOR DEVICE IDENTIFIERS.
- REFER TO SECURITY DOOR DETAILS ON SHEETS TY501 THRU TY506 FOR TYPICAL MOUNTING DETAILS FOR EACH DOOR TYPE AS IDENTIFIED BY NUMBER.
- CONTRACTOR SHALL REVIEW THE SEQUENCE OF OPERATION FOR EACH DOOR TYPE, THE HARDWARE AND REQUIRED DEVICES TO ENSURE PROPER OPERATION FOR PASSAGE THROUGH EACH DOOR. ANY CONFLICTS IN DOOR HARDWARE, BOTH ELECTRONIC AND MECHANICAL, THAT MAY RESULT IN IMPROPER OPERATION OF ACCESS CONTROLLED DOORS MUST BE IMMEDIATELY BROUGHT TO THE ATTENTION OF THE DESIGNER.

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REVI	SIONS	
NO.	DESCRIPTION	DATE

03/03/2020 DATE ISSUED: SVS REVIEWED BY: VJM DRAWN BY: RJF **DESIGNED BY:**

PROJECT NUMBER: 201-0052-002

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SECURITY DOOR SCHEDULE

SHEET NUMBER


TY603

DOOR NO.	SHEET NO.	LOCATION	CR K	IP ML	EL T	D PT	BMS	DPS	SS	LA V	A KS	S MD	РВ	D	VI	FIRE ALARM INTERFACE	DOOR TYPE	EQUIPMENT ROOM	CAMERA COVERAGE	SPECIAL NOTES
100A	TY101	PRE-PROCESSING (ROOM 100)	2		2 2	2 2	2									Υ	7	112	100A	PROVIDE CR AND (2) EL ON PULL SIDE. PROVIDE CR, (2) EL W/ 15 SECOND TIME-DELAY, (2) PT AND (2) BMS ON PUSH SIDE.
100B	TY101	PRE-PROCESSING (ROOM 100)	2	2												Υ	8	112	100B	PROVIDE CR ON PULL SIDE. PROVIDE CR AND (2) ML W/ BUILT-IN DPS AND MBS ON PUSH SIDE. PROGRAM ACS TO RELEASE ML VIA REMOTE PB AT PASSENGER PROCESSING PODIUMS.
103	TY101	PROCESSING AREA (ROOM 103)	2		2 2	2 2	2									Υ	7	112	-	PROVIDE CR AND (2) EL ON PULL SIDE. PROVIDE CR, (2) EL W/ 15 SECOND TIME-DELAY, (2) PT AND (2) BMS ON PUSH SIDE. PROGRAM ACS TO OPEN LOCKS VIA REMOTE PB AT PASSENGER PROCESSING PODIUMS.
104	TY101	AG LAG (ROOM 104)	1		1	1		1		1				1		-	13	112	103B	PROVIDE CR, KS AND LA ON PUSH SIDE. PROVIDE EL W/ BUILT-IN REX, PT AND DPS C PULL SIDE. PROVIDE WALL MOUNTED DURESS BUTTON WITHIN ARMS REACH OF GRINDER.
105A	TY101	DETENTION SUITE CORRIDOR (ROOM 105)	2		1	1		1		1						-	4	112	103B. 105B	PROVIDE CR AND FAILSECURE EL ON BOTH SIDES. PROVIDE LA ON PUSH SIDE. PROVIDE PT AND DPS ON PULL SIDE.
105B	TY101	DETENTION SUITE CORRIDOR (ROOM 105)	2 1	1	1 1	1 1	1									-	5	112	105C	PROVIDE CR AND ELON PULL SIDE. PROVIDE CR, EL W/ 30 SECOD TIME-DELAY, PT AND BMS ON PUSH SIDE. PROVIDE KP FOR IDS.
106	TY101	INTERVIEW ROOM (ROOM 106)								1	1			2		-	12	112	105A, 105C	PROVIDE LA AND KS ON PULL SIDE. PROVIDE COVERT DURESS BUTTON UNDER TABLE SURFACE AND WALL MOUNTED DURESS BUTTON ADJACENT TO DOOR.
107	TY101	SEARCH ROOM (ROOM 107)								1	1			1		-	10	112	105A	PROVIDE LA AND KS ON PULL SIDE. PROVIDE WALL MOUNTED DURESS BUTTON WITHIN ROOM ADJACENT TO DOOR.
108	TY101	HOLD ROOM (ROOM 108)	1						1	1	2			1		-	6	112	105A	PROVIDE STRIKE SWITCH TO MONITOR DETENTION LOCK LATCH BOLT. PROVIDE DETENTION GRADE DURESS BUTTON WITHIN HOLD ROOM. PROVIDE GUARD TOUR CF (2) KS AND LA OUTSIDE OF HOLD ROOM. REFER TO THE DRAWINGS AND WRITTEN SPECIFICATIONS ADDITIONAL INFORMATION.
110A	TY101	ADMINISTRATION SUITE ENTRY/EXIT - (CORIDOR 110)	1		1	1		1		1		1				-	11	112	103A	PROVIDE CR AND LA ON PUSH SIDE. PROVIDE EL W/ BUILT-IN REX, PT AND DPS ON PULL SIDE. PROVIDE CEILING MOUNTED MD IN PRIMARY PROCESSING FOR IDS,
110B	TY101	CBP ENTRY/EXIT - (CORIDOR 110)	1 1	1	1	1	1					1				-	2	112	-	PROVIDE CR ON PULL SIDE. PROVIDE EL W/ BUILT-IN REX, PT AND BMS ON PUSH SII PROVIDE KP AND MD FOR IDS.
110C	TY101	DETENTION SUITE CORRIDOR (ROOM 105)	2		1	1		1		1						-	4	112	105A, 110B	PROVIDE CR AND FAILSEURE EL ON BOTH SIDES. PROVIDE LA ON PULL SIDE. PROVIDE PT AND DPS ON PUSH SIDE.
111	TY101	SECURE STORAGE (ROOM 111)	1 1	1	1	1	1					1				-	9A	112	110B, 111	PROVIDE CR AND SELF-POWERED DIAL COMBINATION LOCK ON PUSH SIDE. PROVIDE LW/BUILT-IN REX, PT AND BMS ON PULL SIDE. PROVIDE KP AND MD WITHIN ROOM FOR IDS.
112A	TY101	LAN/SLAN ROOM (ROOM 112)	1 1	1	1	1	1					1				-	9	112	110A, 110B, 112	PROVIDE CR ON PUSH SIDE. PROVIDE EL W/ BUILT-IN REX, PT AND BMS ON PULL SI PROVIDE MD AND KP WITHIN ROOM FOR IDS.
112B	TY101	SLAN ROOM (ROOM 112)	1	1									1			Υ	14	112	112	PROVIDE CR ON OUTSIDE OF SLIDING GATE. PROVIDE PB AND ML W/ BUILT-IN DPS AND MBS INSIDE SECURED AREA.
113A	TY101	ENTRANCE OFFICE (113)	1		1	1		1		1				1		-	13	112	110A, 110B	PROVIDE EL W/ BUILT-IN REX, PT, BMS, LA AND KS PUSH SIDE. PROVIDE CR ON PUL SIDE. PROVIDE COVERT DURESS BUTTON UNDER DESK.
113B	TY101	ENTRANCE OFFICE (113)	1		1	1		1							1	-	1A	112	114	PROVIDE CR AND VI ON PULL SIDE. PROVIDE EL W/ BUILT-IN REX, PT AND DPS ON PUSH SIDE.
114	TY101	PUBLIC LOBBY (114)	1	1			2					1				-	3	112	114	PROVIDE (2) BMS ON PUSH SIDE. PROVIDE KP AND MD WITHIN LOBBY FOR IDS.
123	TY101	SUPERVISORS OFFICE (ROOM 123)	1		1	1		1		1				1		-	13	112	110A, 110B	PROVIDE CR AND LA ON PUSH SIDE. PROVIDE EL W/ BUILT-IN REX, PT AND DPS ON PULL SIDE. COVERT DURESS BUTTON UNDER DESK.
124	TY101	LACTATION ROOM (ROOM 124)								1	1			1		-	10	112	110B	PROVIDE LA AND KS ON PUSH SIDE. PROVIDE WALL MOUNTED DURESS BUTTON WITHIN ROOM ADJACENT TO DOOR.
125	TY101	ELECTRIC ROOM (ROOM 125)	1		1	1	1									-	1	112	-	PROVIDE CR ON PULL SIDE. PROVIDE EL W/BUILT-IN REX, PT, AND BMS ON PUSH SI
126	TY101	MECHANICAL ROOM (ROOM 126)	1		1	1	1									-	1	112	-	PROVIDE CR ON PULL SIDE. PROVIDE EL W/BUILT-IN REX, PT, AND BMS ON PUSH SII
P1	TY101	SECURE PARKING AREA	2		1			1								-	15	GCTC1	-	PROVIDE CR ON PUSH SIDE. PROVIDE CR, ELECTROMECHANICAL LOCK WITH KEY OVERRIDE, AND WIDE-GAP DPS ON PULL SIDE.
GATE-1	TS101	SECURE PARKING AREA VEHICLE GATE	1					2								-	SEE NOTES	GCTC1	-	REFER TO GATE LAYOUT ON SHEET TY102.
GATE-2	TS101	DETAINIEE TRANSFER VEHICLE GATE	2					1							1	-	SEE NOTES	112	-	REFER TO GATE LAYOUT ON SHEET TY103.
-	TY101	PROCESSING AREA PODIUMS (ROOM 103)											4	2		-	-	112	-	AT EACH PODIUM PROVIDE COVERT DURESS BUTTON AND PB MOUNTED IN PODIUM CASEWORK. PROVIDE CEILING MOUNTED VA BETWEEN PODIUMS.
-	TY101	PROCESSING AREA X-RAY STATION (ROOM 103)											1	1		-	-	112	-	PROVIDE CEILING MOUNTED VA AND D AND PB MOUNTED IN X-RAY WORKSTATION CASEWORK.
-	TY101	DETENTION SUITE CORRIDOR (ROOM 105)	1													-	-	-	-	PROVIDE CR ADJACENT TO WALL MOUNTED VIDEO MONITOR TO OPEN/CLOSE DETAINIEE TRANSFER VEHICLE GATE, REFER TO GATE LAYOUT ON SHEET TY103.




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1. ALL EQUIPMENT PROVIDED BY THE CONTRACTOR UNLESS OTHERWISE INDICATED.

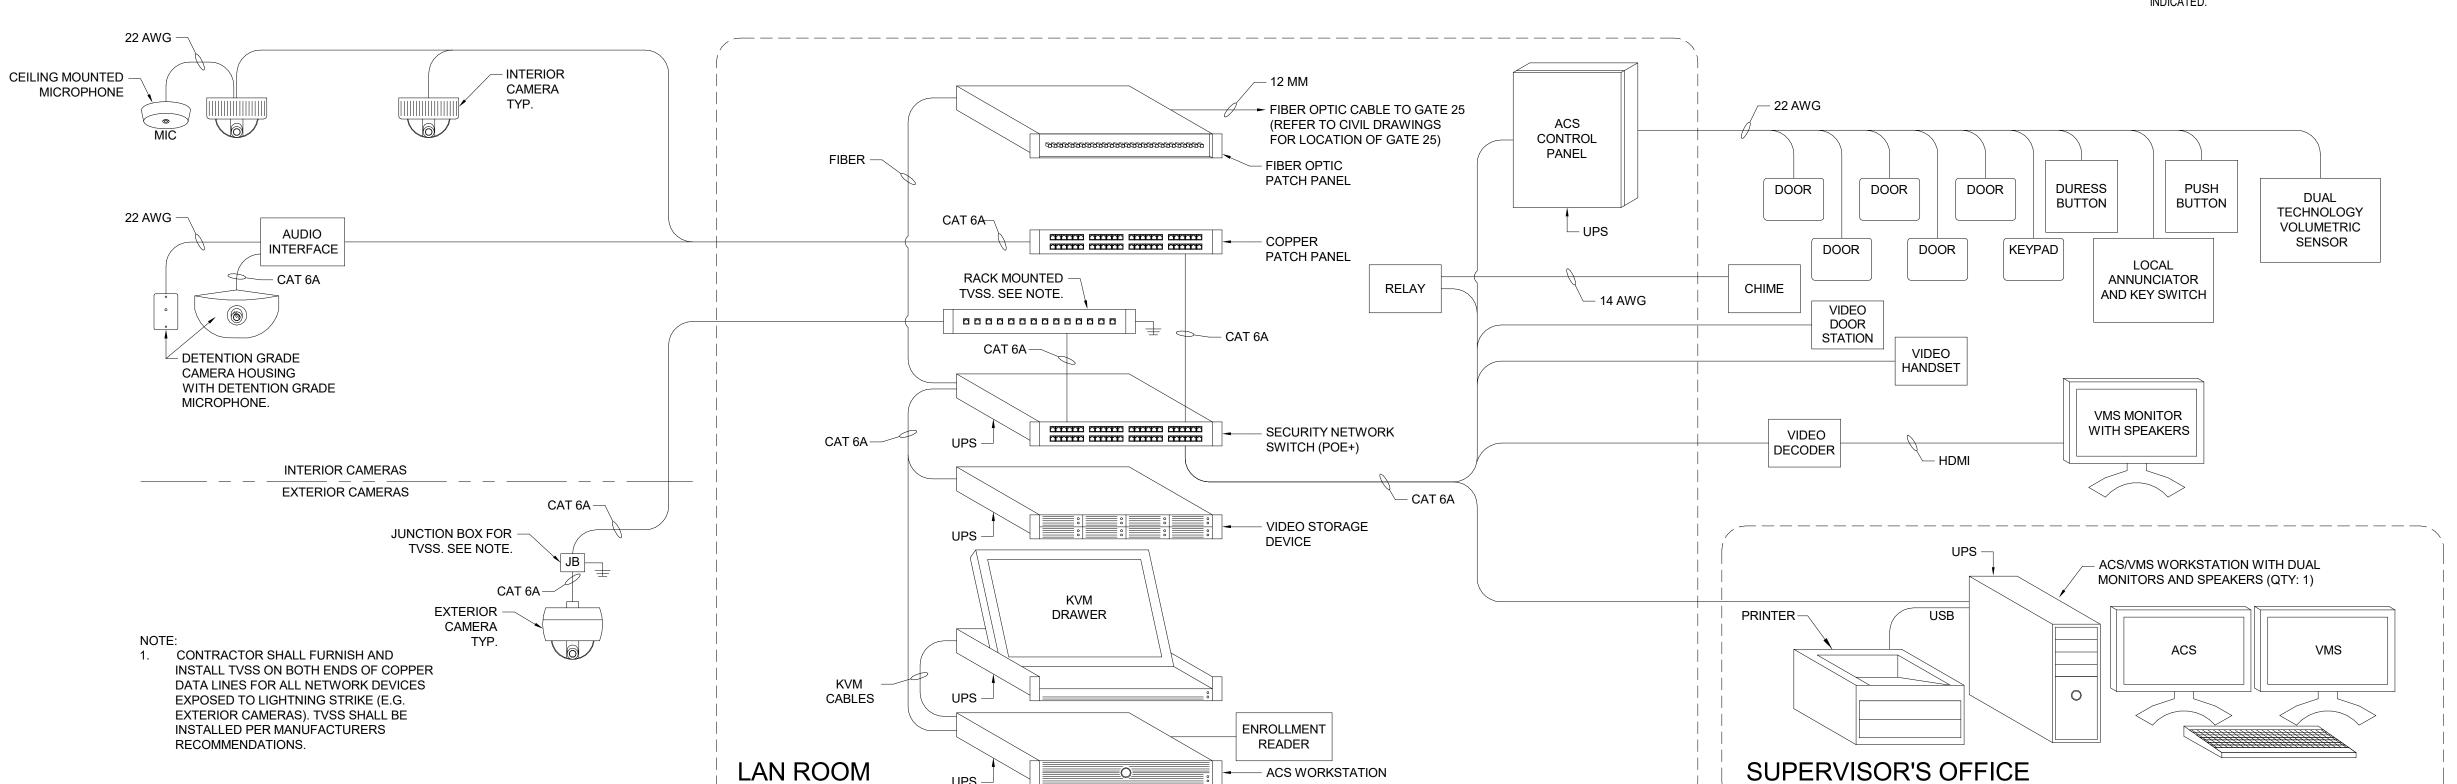

SECURITY SYSTEM BLOCK DIAGRAM SCALE: N.T.S.

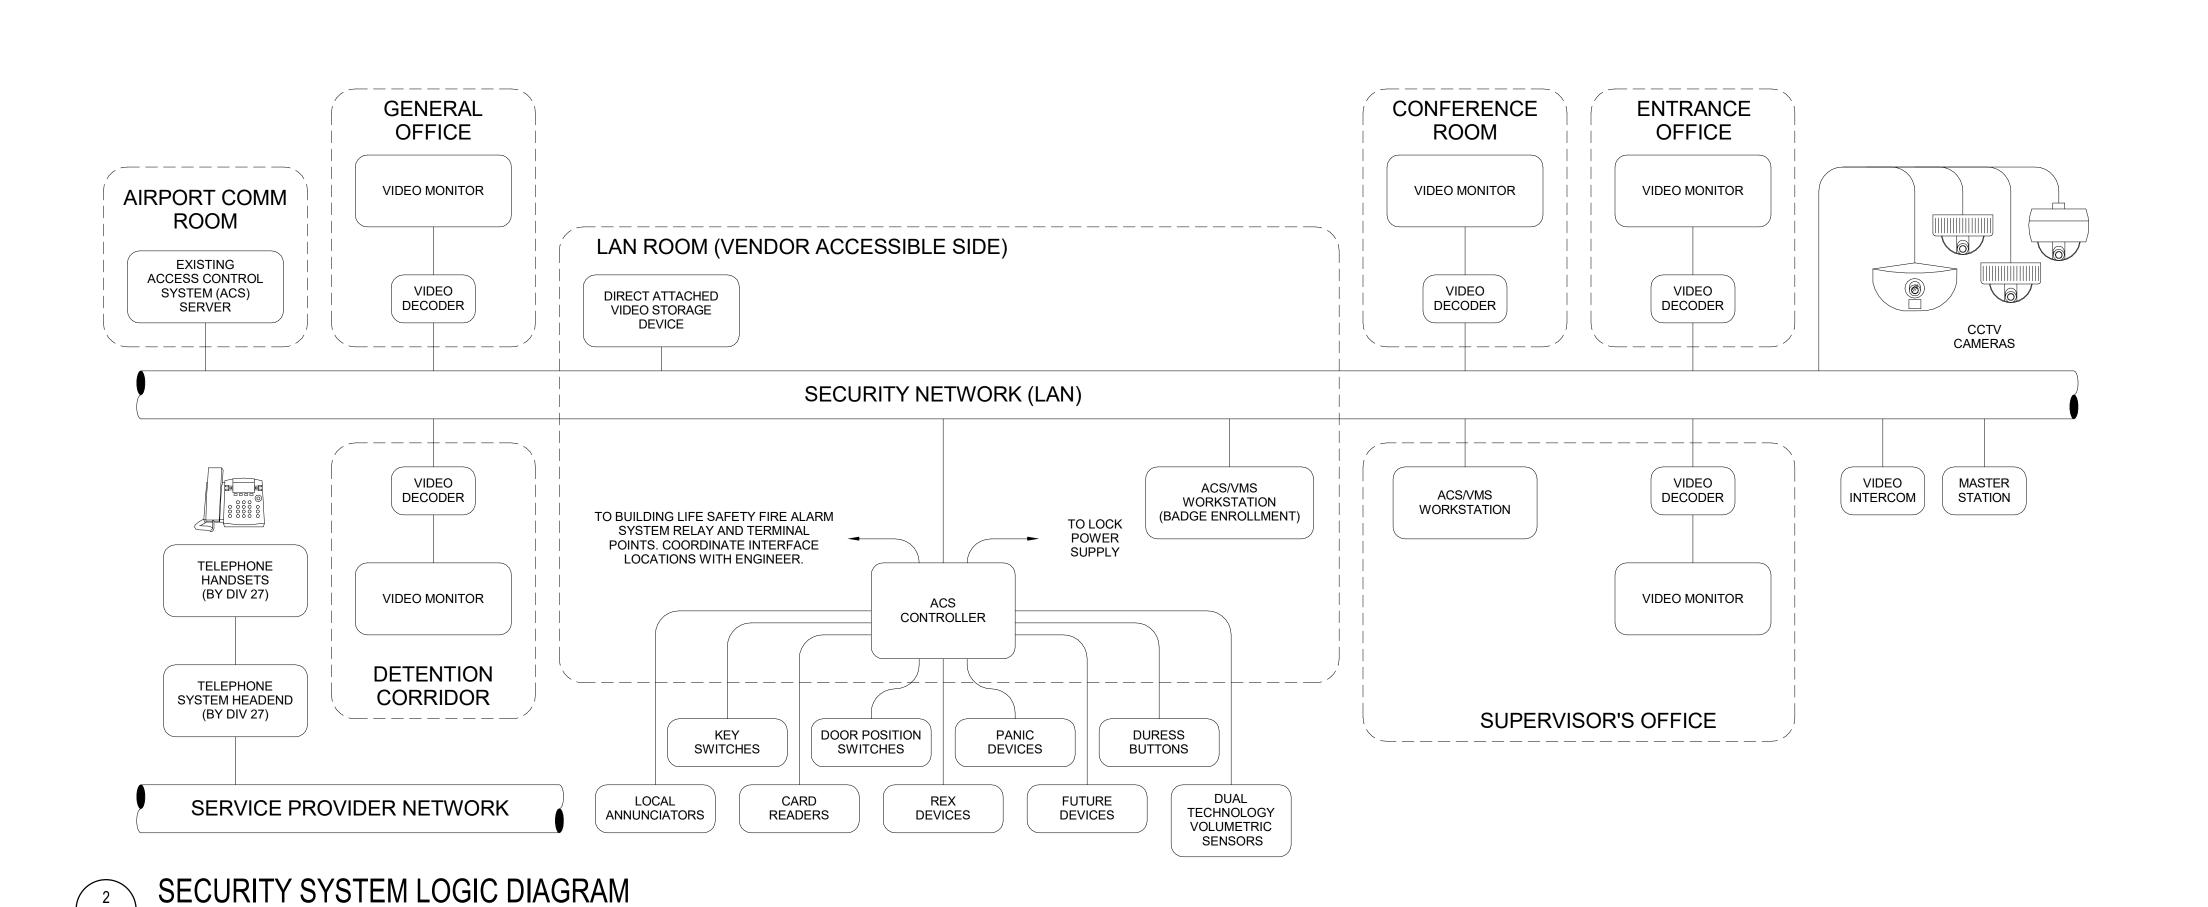

ACS WORKSTATION

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PENSACOLA GENERAL AVIATION FACILITY (GAF)



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NO.	DESCRIPTION	DATE
DATE IS	SSUED:	03/03/202
REVIEV	VED BY:	SV
DRAWN	N BY:	VJ

DESIGNED BY: PROJECT NUMBER:

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SECURITY BLOCK DIAGRAMS

SHEET TITLE

SHEET NUMBER

TY701

BID DOCUMENTS

TY701

SCALE: N.T.S.

LAN/SLAN

(ROOM 112)

(2) E -

FIBER TO -

(4) E -----

(2) E -

(24) E, E1 -

SECURITY

NETWORK

PATCH

PANEL

TO VIDEO -DISPLAYS

NETWORK VIDEO RECORDING (16 TB MIN.)

LOCK POWER

SUPPLY

(QTY: 6)

UPS D (AS REQUIRED)

ACS

CONTROL

PANEL

RELAY

(IPW-MA)

POWER SUPPLY

SECURITY

00000000000000

00000000000000

- RACK

NETWORK

SWITCH (POE+)

— (13) E

MOUNTED TVSS

ACS/VMS WORKSTATION WITH SPEAKERS

VMS

ACS

E, E1 -

(QTY: 6)

(2) A, (3) B,

CR

SS D

112B

. 14 /

125

EL BMS

- EL

- A, (2) B, (2) G

PB

(2) D, F

- CR

CR

EL TD

BMS BMS

(2) B, C

A, (3) B,

(2) D, K

- CR

EL BMS

107

/112A

9 /

124

EXTERIOR -CAMERA TYP.

KS D

MD -

TD EL

(2) A, B,

- ML | ML |

⊢ CR ∣

KS (2) F

A, (2) B,

VALVE

/113A

13

LA 🗕

126

CR

- EL -BMS

C, D

- EL DPS

TD EL

(2) A, (3) B,

(2) D, F

CR

EL TD
BMS BMS

A, (3) B,

C, D

113B

1A /

CR

•

V01

CR

CR

110A

A, (4) B,

A, (3) B,

C, D, K

— MD

- EL

BMS

CR

⊢ EL

DPS

104

13 /

(110B)

LA

D

LA

CR

KP

114

BMS

TX/RX

GATE

OPERATOR (ENTRY)

(2) S

C, D, E, K

MD -

KP

CR

V02

- EL




- 1. ALL EQUIPMENT, DEVICES AND CABLING SHALL BE NEW UON.
- 2. REFER TO COMMUNICATIONS INTERCONNECT DIAGRAM FOR ADDITIONAL INFORMATION, INCLUDING BACKBONE FIBER.


KEYED NOTES:

- 1. MOUNT AUDIO INTERFACE UNIT FOR EXTERNAL MICROPHONES IN CEILING MOUNTED JUNCTION BOX LOCATED IN THE DETENTION SUITE CORRIDOR.
- REFER TO SHEET TY101 KEYED NOTE 14 FOR ADDITIONAL INFORMATION. 2. INTERFACE ACS TO AUTOMATIC SLIDING DOOR OPERATOR (DO), PROVIDE ISOLATION RELAY BETWEEN DO AND ACS CONTROL PANEL.
- 3. KEY SWITCH FOR SELECTING AUTOMATIC SLIDING DOOR OPERATOR MODE SHALL BE PROVIDED BY THE DOOR CONTRACTOR. 4. INTERFACE ACS TO THE EXISTING BAGGAGE CONVEYOR MOTOR CONTROL
- PANEL (MCP), PROVIDE ISOLATION RELAY BETWEEN MCP AND ACS CONTROL
- CASEWORK. BUTTON SHALL OPEN DOOR 132B WHEN OPERATED, REFER TO DETAIL 4 ON SHEET TY502 FOR OPERATION OF DOOR TYPE 8. 6. LOCATE DOOR RELEASE PUSH BUTTON IN SECONDARY PROCESSING PODIUM
- CASEWORK. BUTTON SHALL OPEN DOOR 132C WHEN OPERATED, REFER TO DETAIL 4 ON SHEET TY502 FOR OPERATION OF DOOR TYPE 8.

	CAI	BLE LEGEND
ID	DESCRIPTION	DEVICE
Α	6-24 AWG SHIELDED 9-24 AWG SHIELDED	CARD READER. CABLE LENGTH < 450' CARD READER. CABLE LENGTH > 450'
В	4-22 AWG UNSHIELDED	MISC. INPUT (DOOR POSITION/REX/TD)
С	4-14 AWG UNSHIELDED	ANNUNCIATOR (HORN/STROBE)
D	2-14 AWG UNSHIELDED 2-12 AWG UNSHIELDED	MISC. OUTPUT (LOCK) CABLE LENGTH UP TO 100' MISC. OUTPUT (LOCK). CABLE LENGTH UP TO 200'
Е	CATEGORY 6A UTP	ETHERNET (VOICE, DATA, VIDEO)
E1	OUTDOOR CAT 6A UTP	OUTDOOR RATED ETHERNET CABLE
F	2-18 AWG UNSHIELDED	FIRE ALARM RELAY AND MISC. I/O
G	8-18 AWG UNSHIELDED	GATE OPERATOR I/O
K	6-18 AWG UNSHIELDED	IDS KEY PAD
М	PROVIDED BY DEVICE MFG.	EXTERNAL MICROPHONE CABLE
Т	RG-6/U COAX	CABLE TELEVISION
R	4-18 AWG SHIELDED	RS-485 SERIAL COMMUNICATION
Χ	MULTI-MODE FIBER	FIBER OPTIC PATCH CABLE

ANALOG TELEPHONE LINE

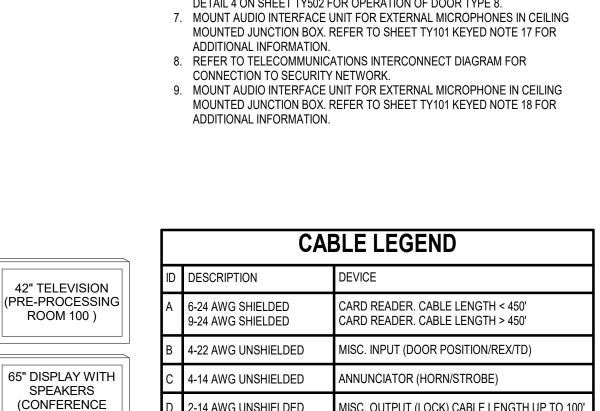

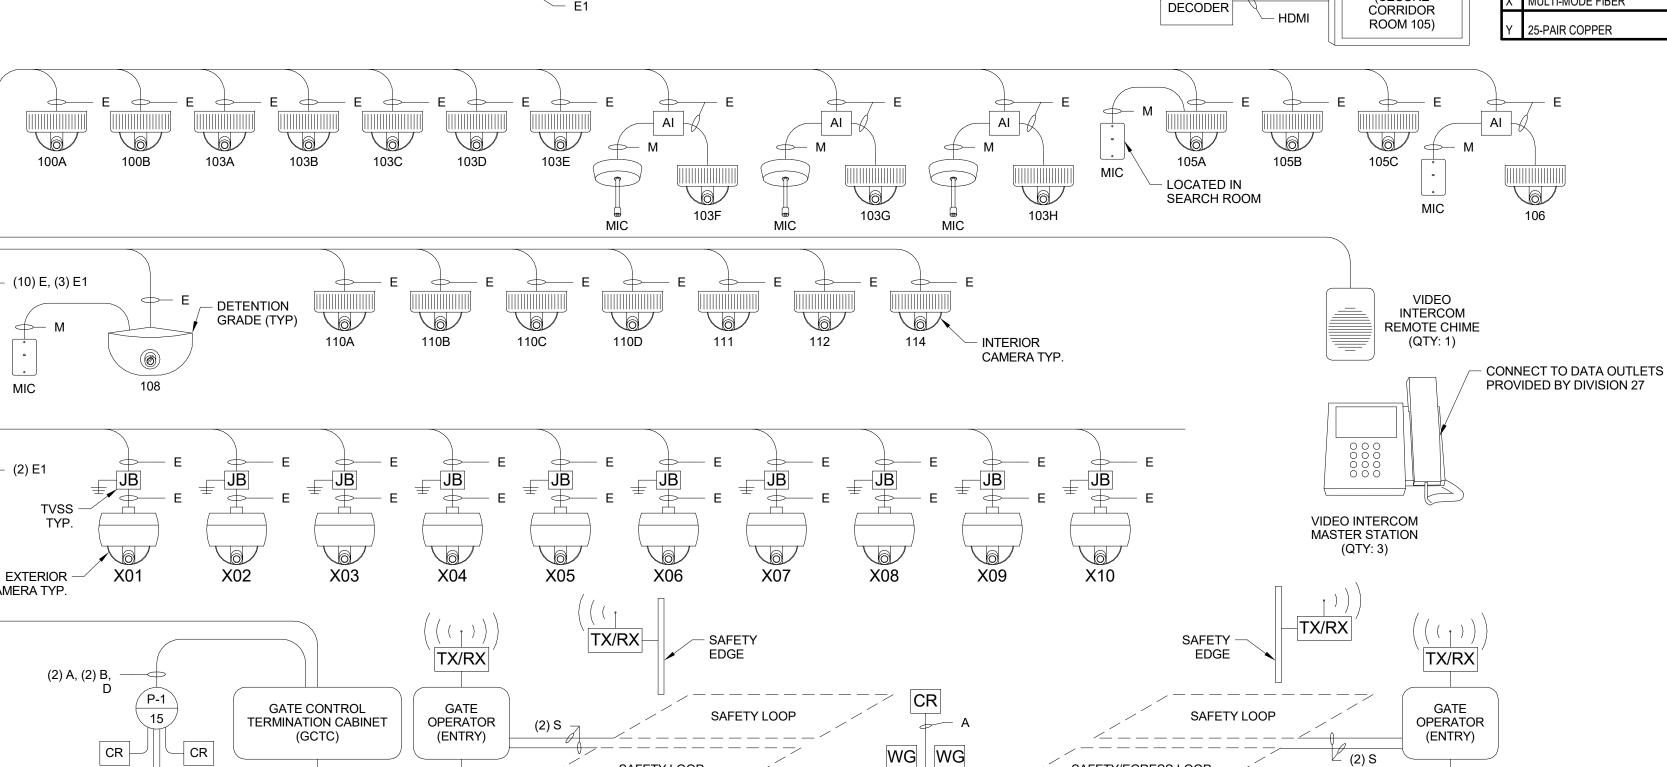

(2) A, (2) B,

– (2) A, (2) B,

- (3) B,

D -

VA

PRIMARY

PROCESSING

— SAFETY

EDGE

SAFETY LOOP

105A

DPS

CR

EL DPS

110C

4

A, (4) B,

C, D

EL DPS

TX/RX

SAFETY LOOP

123

LA

LA

(2) A, (3) B,

106

12 /

CONNECT TO DATA -OUTLET PROVIDED BY

- COAX

— CAT 6A

- HDMI

- HDMI

- HDMI

ROOM 116)

55" DISPLAY WITH

SPEAKERS

(GENERAL OFFICE

ROOM 122)

55" DISPLAY WITH

SPEAKERS

(SUPERVISOR'S

OFFICE ROOM 123)

24" DISPLAY

(SECURE

DIVISION 27), REFER TO TELECOM DRAWINGS.

VIDEO

DECODER

VIDEO

DECODER

VIDEO

DECODER

VIDEO

KS

LA D

Ď, F, K

CR

EL TD

- A, (3) B,

(2) D, K

⊢ CR | DIAL

- EL

- SECONDARY

SELF POWERED

LOCK REQUIRED

COMBINATION

KP

MD -

111

、9A /→

VA -

D -

XRAY

MACHINE

CONNECT TO DATA OUTLETS -

PROVIDED BY DIVISION 27 (TYP.),

REFER TO TELECOM DRAWINGS.

10748 Deerwood Park Blvd. South Jacksonville, Florida 32256-0597 904-256-2500 Fax 904-256-2503

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PROFESSIONAL SEAL



REVISIONS			
	NO.	DESCRIPTION	DATE

DATE ISSUED: 03/03/2020 SVS REVIEWED BY: VJMDRAWN BY: RJF **DESIGNED BY:** PROJECT NUMBER:

> 201-0052-002 © 2020 RS&H, INC. SHEET TITLE

SECURITY INTERCONNECT DIAGRAM

SHEET NUMBER

TY702

BID DOCUMENTS

PRINTER (QTY: 1)

SUPERVISOR'S OFFICE

(ROOM 123)

- DIAGRAMS ARE SCHEMATIC IN NATURE AND MAY NOT SHOW ALL BENDS OR TURNS
 REQUIRED. CONTRACTOR SHALL PROVIDE A COMPLETE RACEWAY SYSTEM AS
 REQUIRED.
- 2. REFER TO INTERCONNECT DIAGRAM FOR ADDITIONAL INFORMATION.
- 3. ROUTE CONDUITS ACCORDING TO FIELD CONDITIONS AND AS COORDINATED WITH OTHER TRADES.

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NO. DESCRIPTION DATE

REVISIONS

 DATE ISSUED:
 03/03/2020

 REVIEWED BY:
 SVS

 DRAWN BY:
 VJM

 DESIGNED BY:
 RJF

PROJECT NUMBER: 201-0052-002

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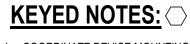
SHEET TITLE

SECURITY DOOR RISER DIAGRAM


SHEET NUMBER

TY703

BID DOCUMENTS



- COORDINATE DEVICE MOUNTING IN PODIUM CASEWORK WITH CBP AND THE ARCHITECT.
- PROVIDE 4" CAST-IN PLACE FLOOR BOX WITH CONDUIT STUBS FOR FOR SECURITY DEVICES, COORDINATE WITH DIVISION 26.
- 3. PROVIDE DOUBLE GANG BACK BOX WITH SINGLE GANG MUDRING FOR GATE OPERATOR OPEN/CLOSE KEYSWITCH. ROUTE CONDUIT FOR GATE OPERATOR CONTROL AND POLE MOUNTED SECURITY CAMERAS THROUGH BOX, REFER TO GATE LAYOUT PLAN ON SHEET TY103.
- 4. PROVIDE JUNCTION BOX (8" X 8" X 4" MIN.) ABOVE SUSPENDED CEILING. PLACE BOX IN A LOCATION ACCESSIBLE FOR MAINTENANCE. COORDINATE LOCATION WITH OTHER TRADES.

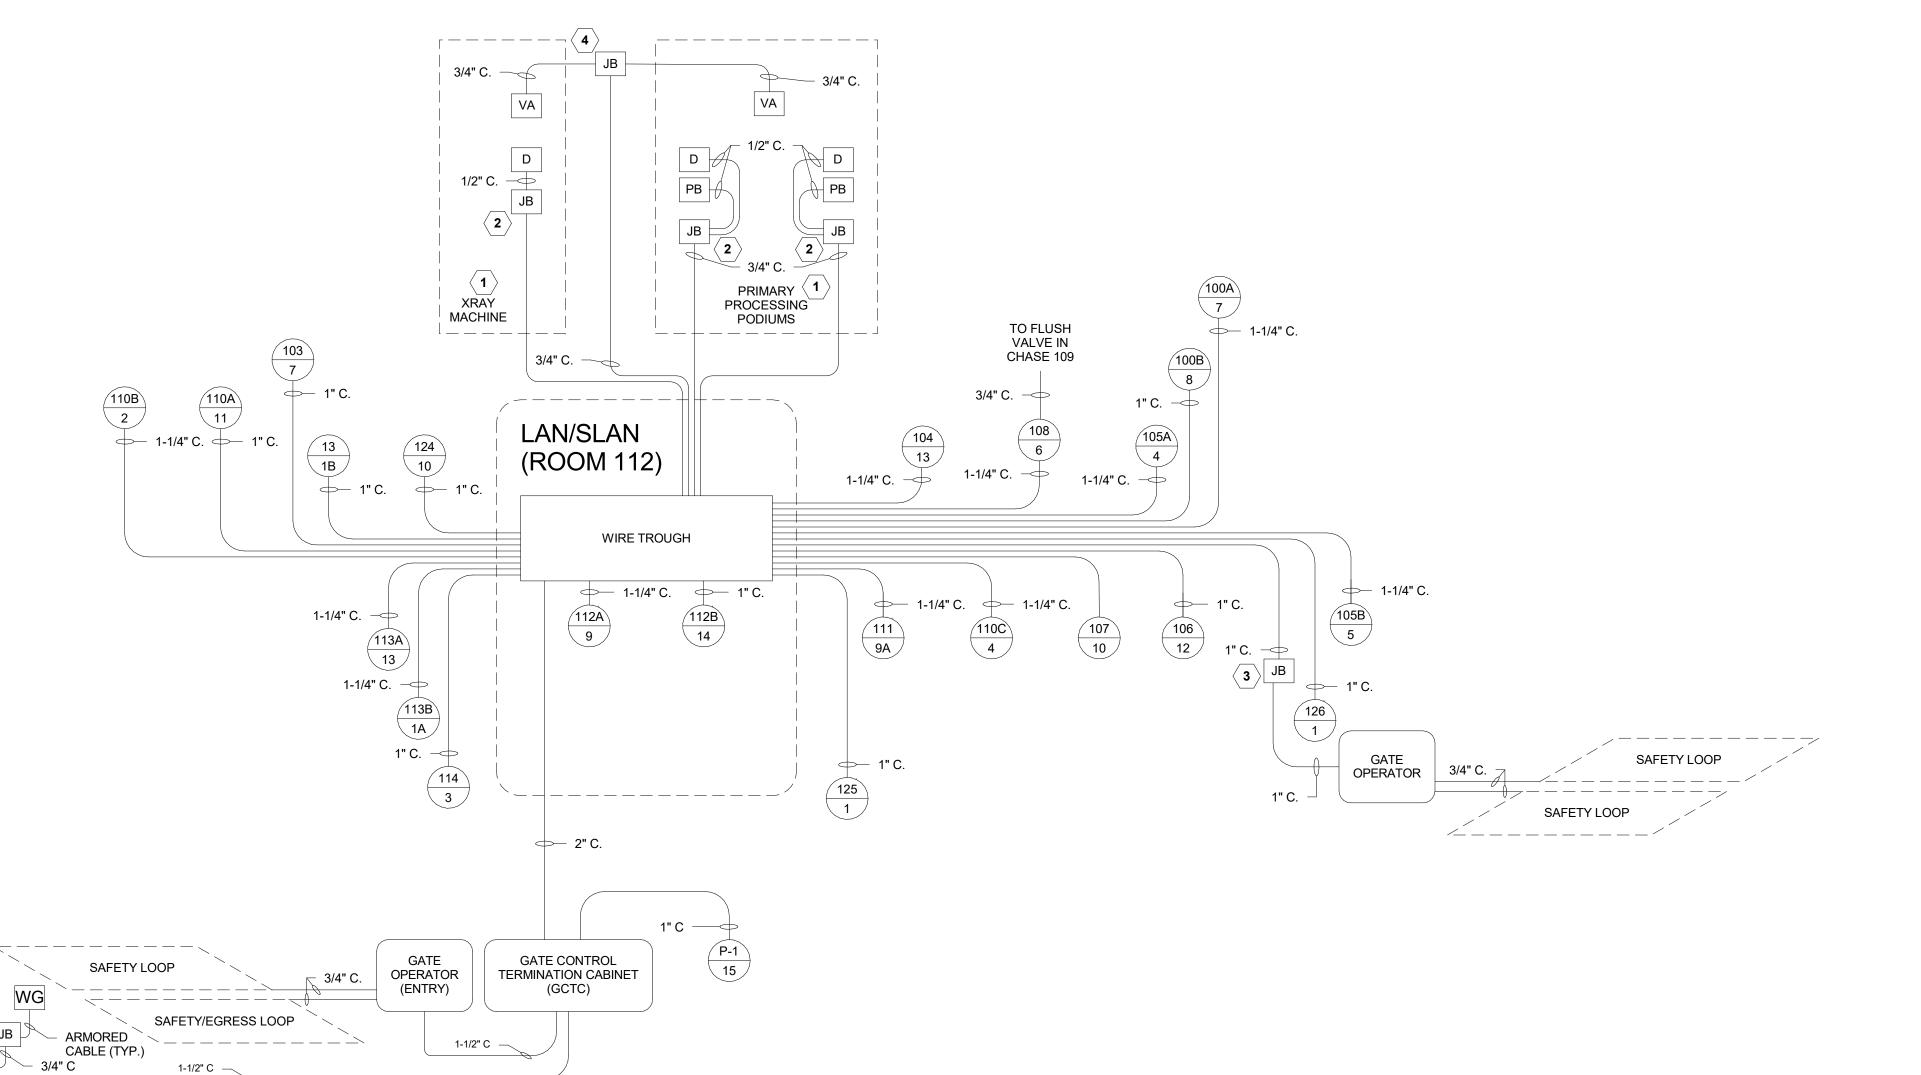

GATE OPERATOR

(ENTRY)

- 1. DIAGRAMS ARE SCHEMATIC IN NATURE AND MAY NOT SHOW ALL BENDS OR TURNS REQUIRED. CONTRACTOR SHALL PROVIDE A COMPLETE RACEWAY SYSTEM AS
- 2. REFER TO INTERCONNECT DIAGRAM FOR ADDITIONAL INFORMATION.
- 3. ROUTE CONDUITS ACCORDING TO FIELD CONDITIONS AND AS COORDINATED WITH OTHER TRADES.

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KEYED NOTES:

- OTHER TRADES.
- 3. DOUBLE GANG BACK BOX WITH SINGLE GANG MUDRING FOR GATE OPERATOR OPEN/CLOSE KEYSWITCH, REFER TO SECURITY DOOR RISER DIAGRAM ON SHEET TY703. ROUTE CONDUIT FOR POLE MOUNTED SECURITY CAMERA THROUGH BOX, REFER TO GATE LAYOUT PLAN ON SHEET TY103.
- SHEET TY703.
- 5. PROVIDE JUNCTION BOX (10X 10X 6" MIN.) ABOVE SUSPENDED CEILING. PLACE BOX IN A LOCATION ACCESSIBLE FOR MAINTENANCE. COORDINATE LOCATION WITH OTHER TRADES.
- 6. PROVIDE DOUBLE GANG JUNCTION BOX FOR WALL MOUNTED VIDEO INTERCOM

- 1. PROVIDE JUNCTION BOX (8" X 8" X 4" MIN.) ABOVE SUSPENDED CEILING. PLACE BOX IN A LOCATION ACCESSIBLE FOR MAINTENANCE. COORDINATE LOCATION WITH
- 2. PROVIDE JUNCTION BOX (12" X 12" X 6" MIN.) ABOVE SUSPENDED CEILING FOR AUDIO INTERFACE UNITS, REFER TO DETAIL 3 ON SHEET TY506. PLACE BOX IN A LOCATION ACCESSIBLE FOR MAINTENANCE. COORDINATE LOCATION WITH OTHER TRADES.
- 4. INDICATED CONDUIT ALSO SHOWN ON SECURITY DOOR RISER DIAGRAM, REFER TO



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VJM

RJF

DRAWN BY: **DESIGNED BY:** PROJECT NUMBER:

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SHEET TITLE

SECURITY CAMERA RISER DIAGRAM

SHEET NUMBER

TY704

