

AREA/ VICINITY/ LOCATION PLAN

scale: N.T.S.



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merge studio

[modern landscape architecture] [land planning] [arboriculture]

707.829.3369 241 s. main st. sebastopol, CA 95472 registered landscape architect 5228 info@merge-studio.com www.merge-studio.com

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1	Planning Dept. Comments	06-06-19
<i>#</i>	revision:	date:

project title:

Paradise Drive

APN# 039-302-02 APN# 039-302-03

3820 Paradise Drive, Tiburon, CA 94920

PV Tiburon LLC

71 Central Avenue, Sausalito, CA 94965

content:

LANDSCAPE MASTER SITE PLAN & SHEET INDEX

Scale:


AS_SHOWN Sheet No.:

1 OF 12 File No.:

1821_TIBURON Drawing No.:

L0.0

6.5.19

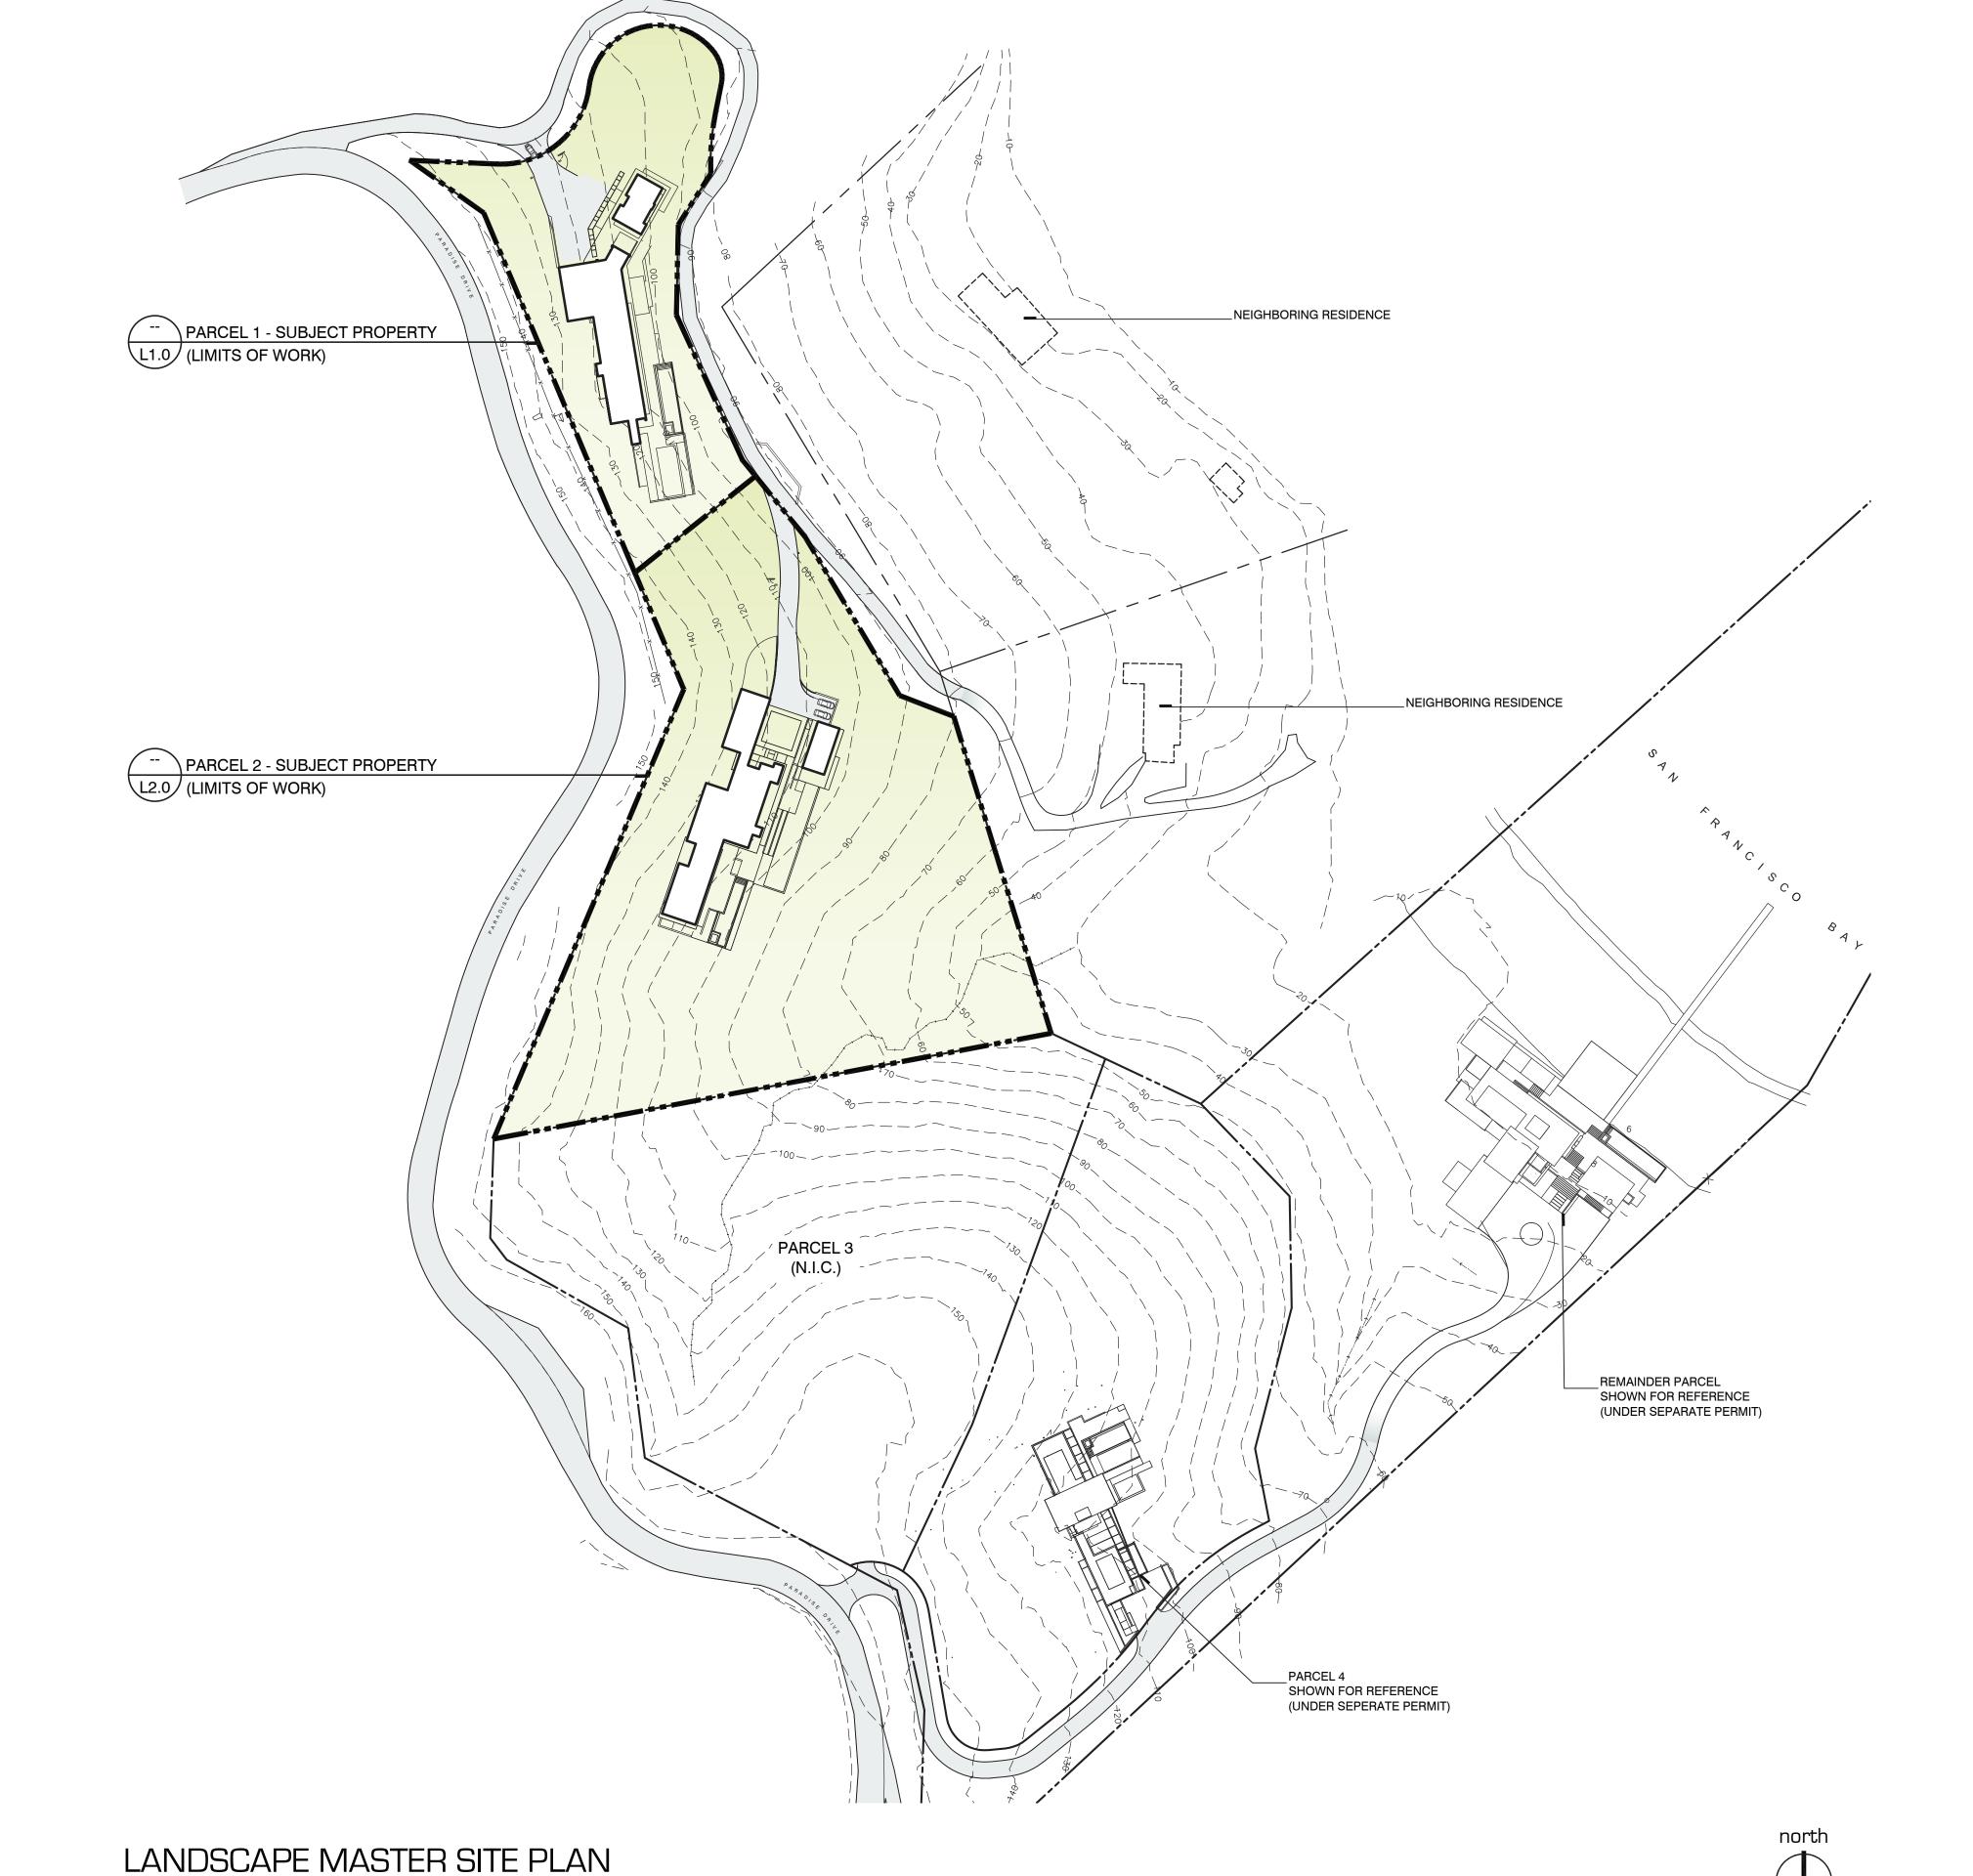

CONSULTANT INDEX:


Sean Bailey Design

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Sherwood Design Engineers

Civil Engineer



north

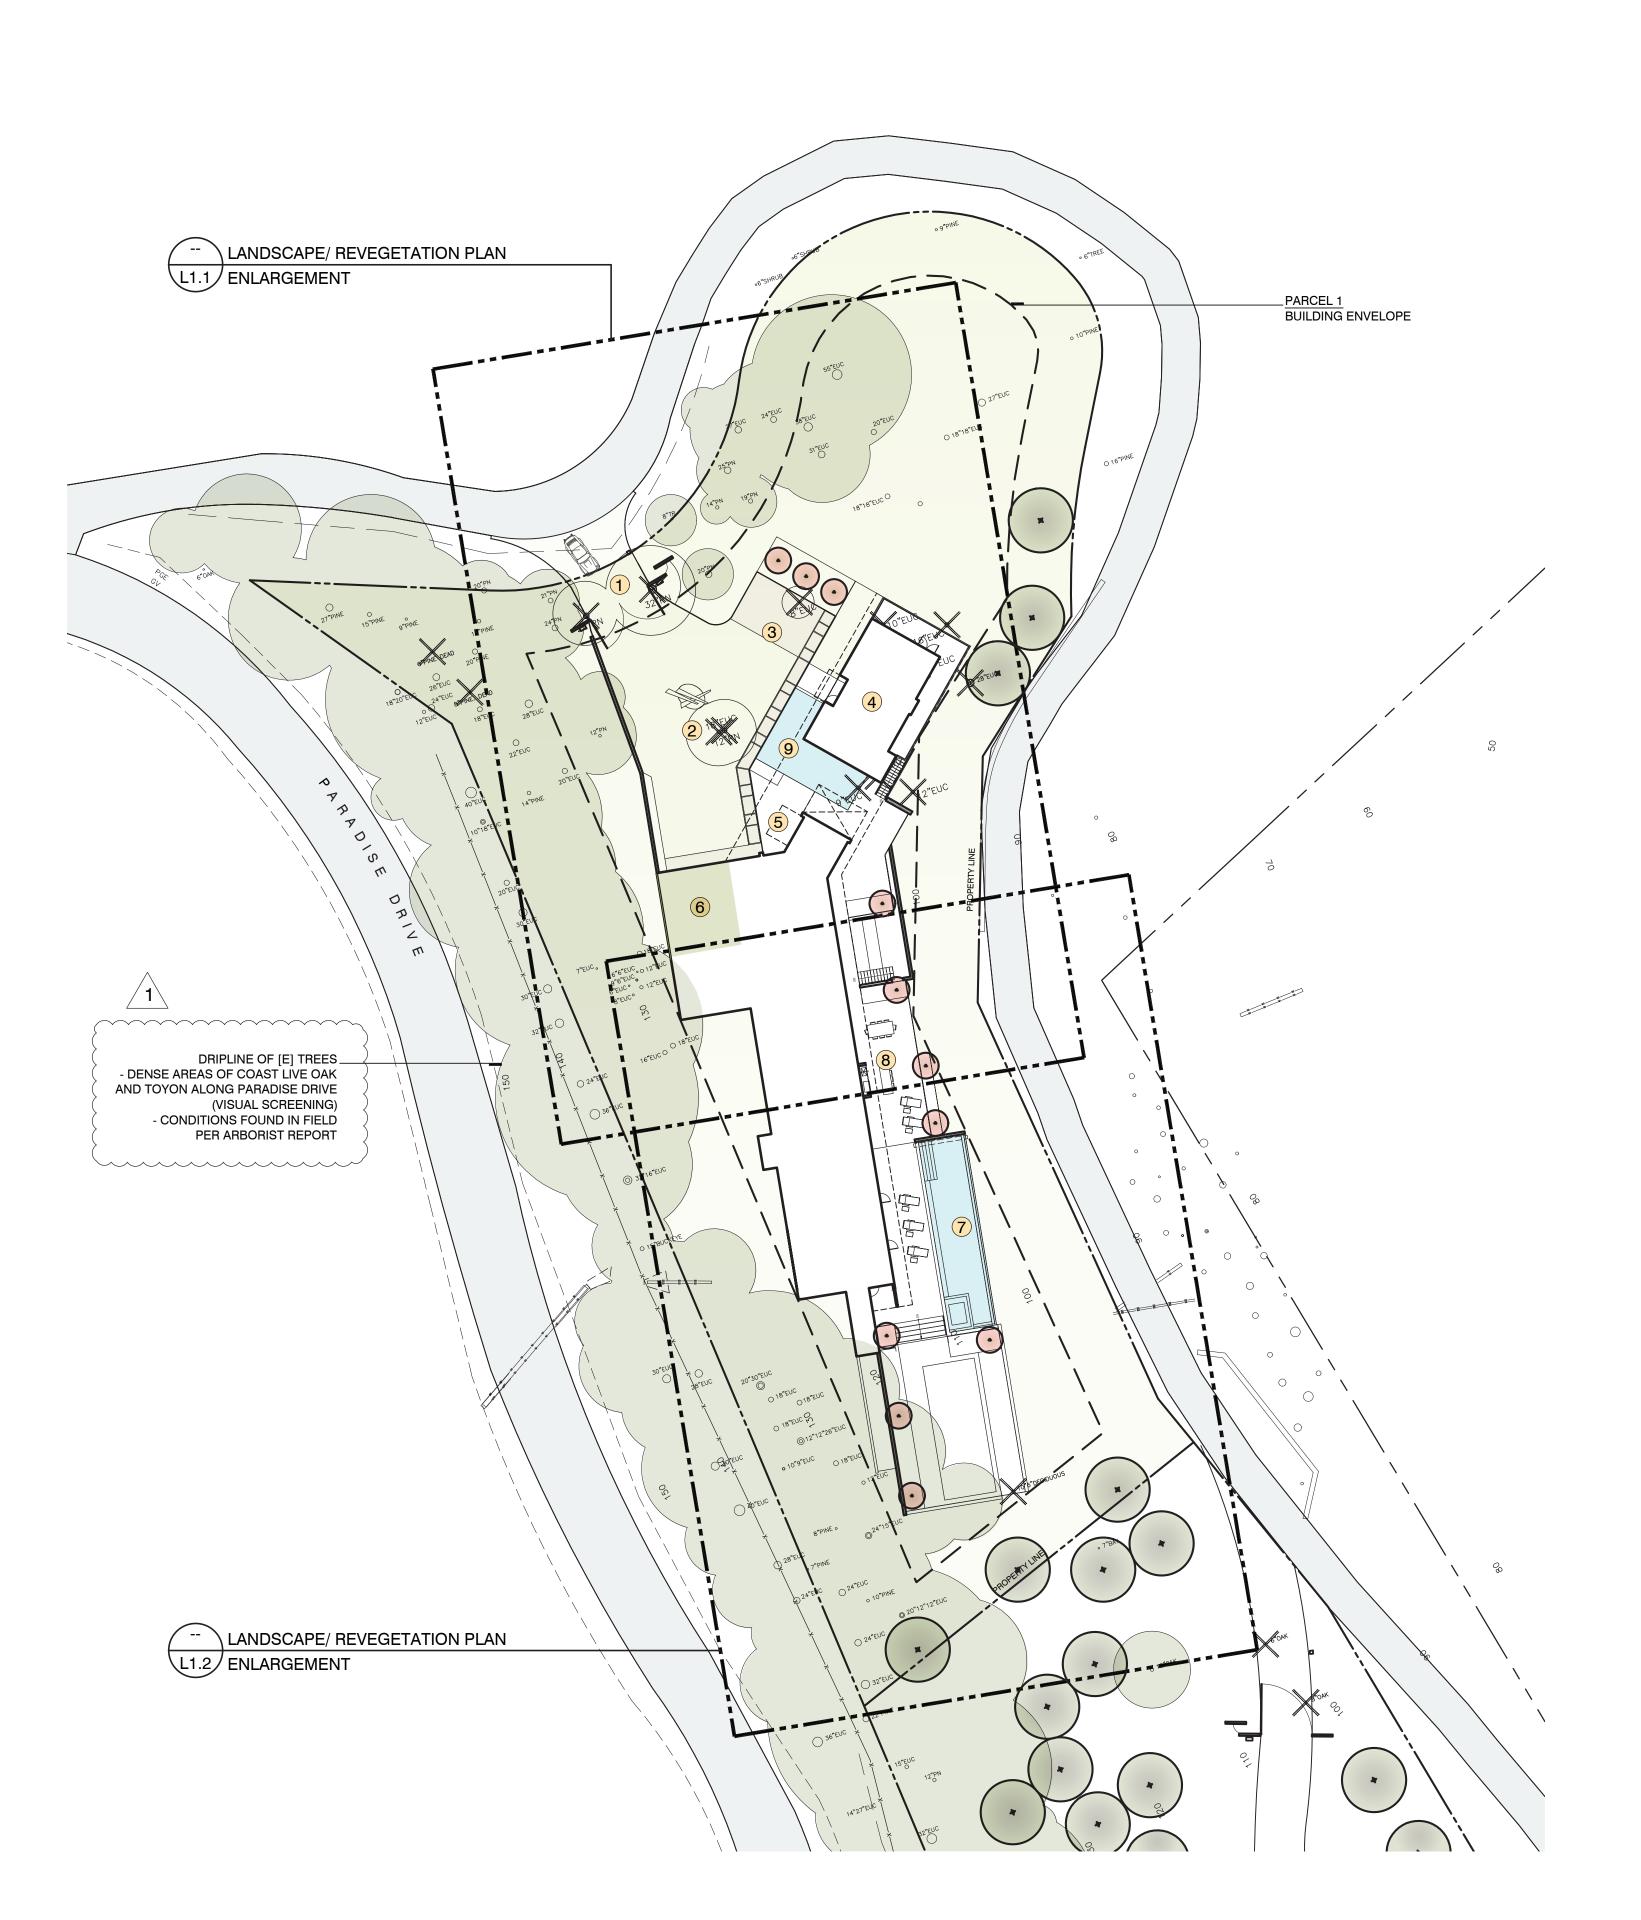 SYMBOL LEGEND

 SYMBOL
 DESCRIPTION
 SYMBOL
 DESCRIPTION

 1
 DRIVEWAY
 4
 A.D.U.
 7
 POOL

GREEN ROOF

PLANT MATERIAL LEGEND/ INDEX: T3820 PARADISE DRIVE, TIBURON, CA 94920 - PARCEL 1 MATURE SIZE PLANT KEY: COMMON NAME: **BOTANICAL NAME:** SIZE: MATURE SIZE: ((AREA @ DRIPLINE): COUNT: \(\frac{1}{2} PLANT COMMENTS: \(\text{(WATER USE) NATIVE*} \) TREES: ARBUTUS MARINA AMS MARINA STRAWBERRY TREE 24" BOX 50' H x 30' W 6-8' MULTI/ LOW BRANCHED (L) NATCHEZ CRAPE MYRTLE LAGERSTROEMIA INDICA 15 GAL. 20' H X 15' W 177 SQ. FT. 6-8' STD./LOW BRANCHED COAST LIVE OAK QUERCUS AGRIFOLIA 24" BOX 50' H x 50' W 1963 SQ. FT. 6-8' STD./LOW BRANCHED SHRUBS: ABF BLUE FLAME AGAVE AGAVE 'BLUE FLAME' 2' H x 3' W 7 SQ. FT.) PLANT 4' O.C. PDG DART'S GOLD NINEBARK PHYSOCARPUS OPULIFOLIUS 'DARTS GOLD' 5 GAL. 13 SQ. FT.) PLANT 5' O.C. 4' H x 4' W RED-FLOWERING CURRANT RIBES SANGUINEUM 'HEARTS DELIGHT' 5 GAL. 64 SQ. FT. PLANT 7' O.C. (L) 9' H X 9' W RIBES VIBURNIFOLIUM PLANT 7' O.C. RBV EVERGREEN CURRANT 5 GAL. 5' H X 8' W 50 SQ. FT. LEATHERLEAF COFFEEBERRY RHAMNUS CALIFORNICA 'LEATHER LEAF' 5 GAL. 28 SQ. FT. PLANT 6' O.C. 6' H x 6' W 18 (L) 1 GAL. 3' H X 5' W AUSTRALIAN BLUEBELL CREEPER SOLLYA HETEROPHYLLA 20 SQ. FT. PLANT 6' O.C. RO SUGAR BUSH RHUS OVATA 15 GAL. 8' H x 8' W 50 SQ. FT. 10 PLANT 8' O.C. **ORNAMENTAL GRASSES:** MD PINE MUHLEY MUHLENBERGIA DUBIA 3.25 SQ. FT. PLANT 6' O.C. 1 GAL. 3' H x 2' W (L) 26 MF PURPLY MUHLY MUHLENBERGIA FILIPES 1 GAL. 4' H x 4' W 13 SQ. FT. 62 PLANT 4' O.C. (L) GROUNDCOVER/ PERENNIALS/ BULBS: AMC GREY-LEAFED YARROW ACHILLEA MILLEFOLIUM 'CALISTOGA' 4" POT 3' H x 18" W PLANT 2' O.C. 1.8 SQ. FT. (L) 4" POT AMM FERN LEAF YARROW ACHILLEA MILLEFOLIUM 'MOONSHINE' 7 SQ. FT. PLANT 3' O.C. > BA 2' H x 3' W 30 (L) BE SOFT CARESS MAHONIA BERBERIS EURYBRACTEATA 1 GAL. 3' H x 3' W 7 SQ. FT. PLANT 4' O.C. PLANT 4' O.C. TICKSEED **BIDENS TRIPLINERVIA** 4" POT 3' H X 3' W 7 SQ. FT. CALIFORNIA FUCHSIA EPILOBIUM CANUM 1 GAL. 2' H X 4' W 13 SQ. FT. PLANT 5' O.C. (L) 4" POT 6" H X 12" W 0.8 SQ. FT. ALPINE GERANIUM ERODIUM REICHARDII PLANT 12" O.C. 75 HELLEBORUS ARGUTIFOLIUS 1 GAL. 3' H X 3' W 7 SQ. FT. PLANT 3' O.C. CORSICAN HELLEBORE AMETHYST BLUFF PURPLE SAGE SALVIA LEUCOPHYLLA 'AMETHYST BLUFF' 1 GAL. 5' H x 10' W 79 SQ. FT. PLANT SLB BEE'S BLISS SALVIA SALVIA LEUCOPHYLLA 'BEE'S BLISS' 1 GAL. 2' H x 6' W 28 SQ. FT. PLANT 6' O.C. TC GERMANDER TEUCRIUM CHAMAEDRYS 4" POT 2' H X 3' W 7 SQ. FT. PLANT 3' O.C. **GREEN ROOF** WESTERN COLUMBINE AQUILEGIA FORMOSA 12 LBS. / ACRE (MEADOW) (L) CAREX TUMULICOLA 1 GAL. PLANT 3' O.C. CT BERKELEY SEDGE 2'H X 2'W 3 SQ. FT. 59 FORMAL LAWN

*NATIVE STATUS KEY: 'C' = CALIFORNIA NATIVE / 'BA' = BAY AREA NATIVE / 'M' = MARIN COUNTY NATIVE

578 SQ. FT.

SOD SOD

14 LBS. / ACRE (MEADOW)

20 LBS. / ACRE (DISTURBED) (L)

BAY AREA NATIVE PLANT PROJECT TOTALS:

FORMULA FOR CALCULATION OF PLANTED AREAS: [MATURE SIZE (AREA @ DRIPLINE)] x [PLANT COUNT]

BRIZA MEDIA

CA. BAY AREA WILDFLOWER MIX SPP.

TOTAL AREA (SQ. FT.) OF PROPOSED PLANTED AREAS = 19,913.5 SQ. FT.

AREA (SQ. FT.) OF BAY AREA NATIVE PLANTINGS = 13,101 SQ. FT.

PERCENTAGE OF BAY AREA NATIVE PLANTINGS WITHIN TOTAL PROPOSED PLANTED AREAS = 66%

AUTOCOURT

GUEST PARKING

PROJECT PLANTING NOTES:

LAWN BOLERO PLUS

BD RATTLESNAKE GRASS

HYDROSEED

ALL PLANTS SELECTED USING WUCOLS PROJECT DATA (UCANR.EDU/SITES/WUCOLS). PLANTS SELECTED CONFORM TO FIRESAFE MARIN LISTINGS AND ARE GOOD CANDIDATES FOR EUCOLYPTUS UNDERSTORY PLANTING.

SEED

ALL SYMBOLS AND PLANT MATERIAL MAY NOT APPLY TO THIS LEGEND FOR PLANT QUANTITY OR AVAILABILITY. CONFIRM ALL SUBSTITUTIONS WITH LANDSCAPE ARCHITECT PRIOR TO ANY OR ALL PLANTINGS THAT MEET WATER USE AND COMPATIBLE PLANTING CONDITIONS. "CALIFORNIA BAY AREA WILDFLOWER MIX" AVAILABLE THRU PACIFIC COAST SEED, LIVERMORE, CA (925)373-4417 OR WWW.PCSEED.COM., (LEBALLISTER'S, SANTA ROSA, CA (707)526-6733), NATIVE PLANT SEEDS AVAILABLE THRU LARNER SEEDS (415)868-9407 OR WWW.LARNERSEEDS.COM. APPLY ALL SEED AND IMMEDIATELY COVER WITH STERILE STRAW, ENOUGH TO OBSCURE THE GROUND SURFACE AT TIME OF PLANTING.

90% BOLERO DWARF FESCUE, 10% KENTUCKY BLUEGRASS

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OUTDOOR KITCHEN

WATER FEATURE

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accordingly.



1	Planning Dept. Comments	06-06-19
2	Planning Dept. Comments	08-13-19
<u>#</u>	revision:	date:

project title:

Paradise Drive

APN# 039-302-02

3820 Paradise Drive, Tiburon, CA

client:

PV Tiburon LLC

71 Central Avenue, Sausalito, CA 94965

content:

LANDSCAPE MASTER SITE PLAN/ TREE PLAN -PARCEL 1

Date:
Scale:

Sheet No.:


2 OF 12


1821_TIBURON


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8.13.19

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VEGETATION MANAGEMENT PLAN - PARCEL 1

north

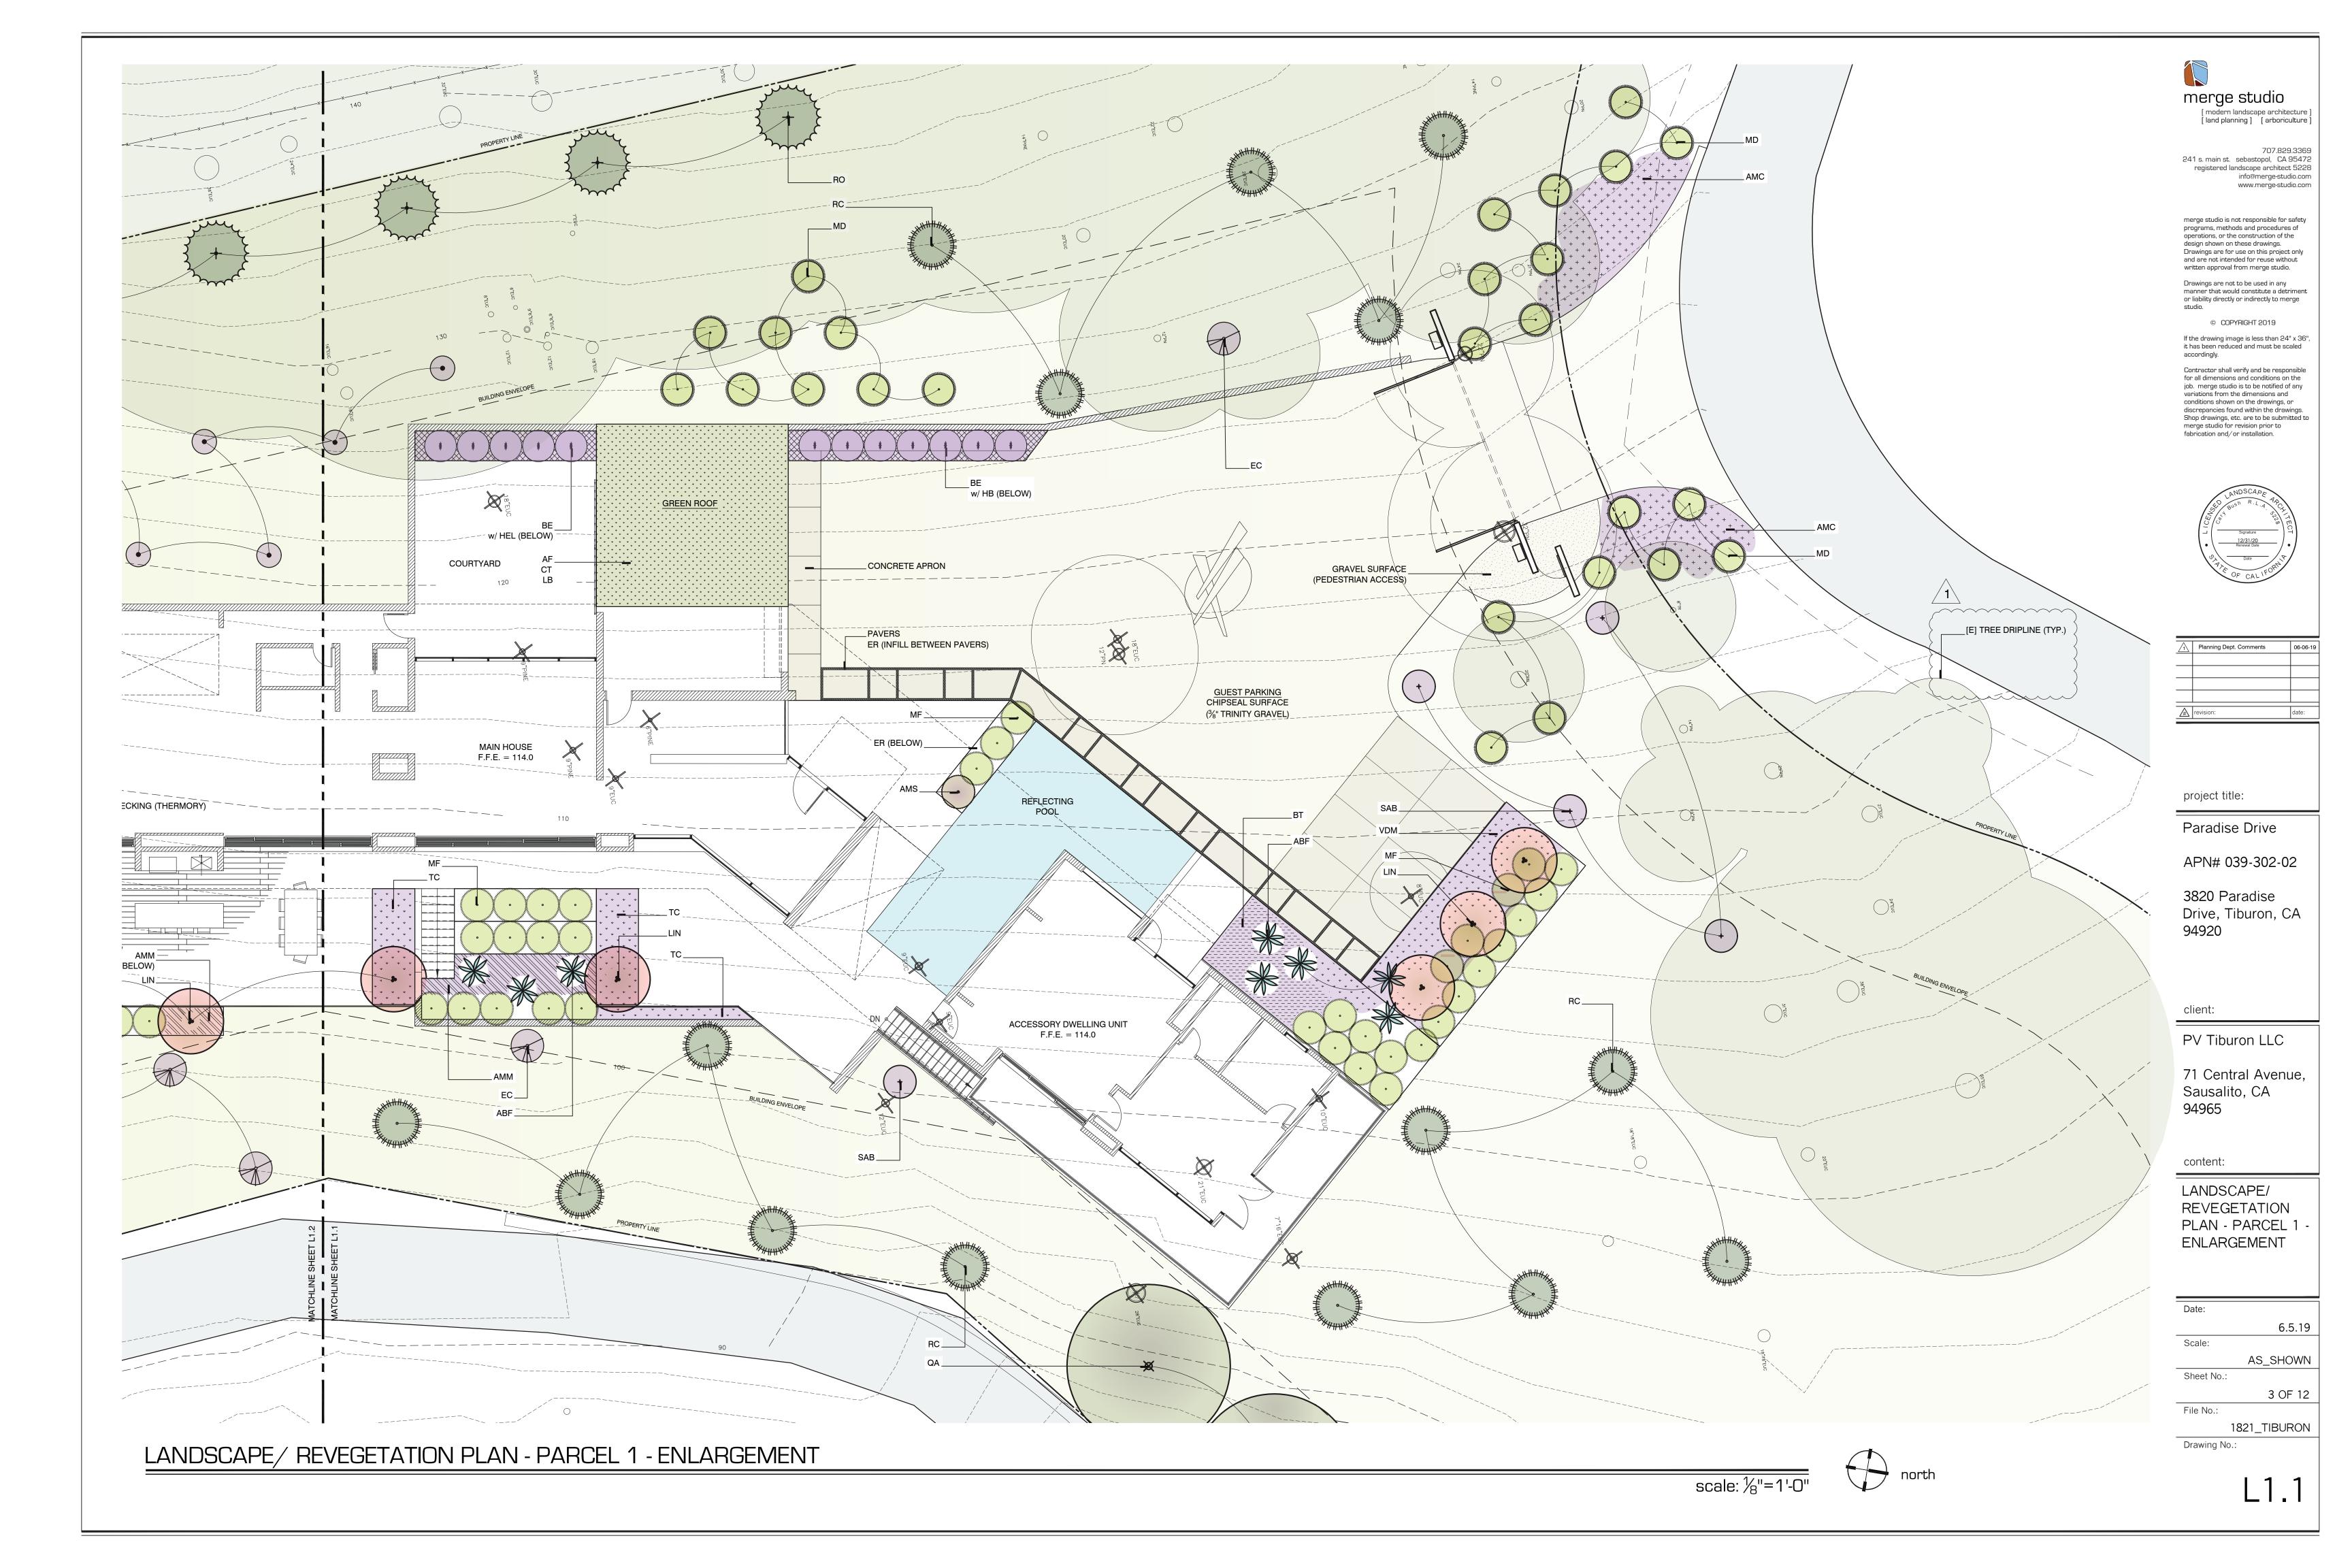

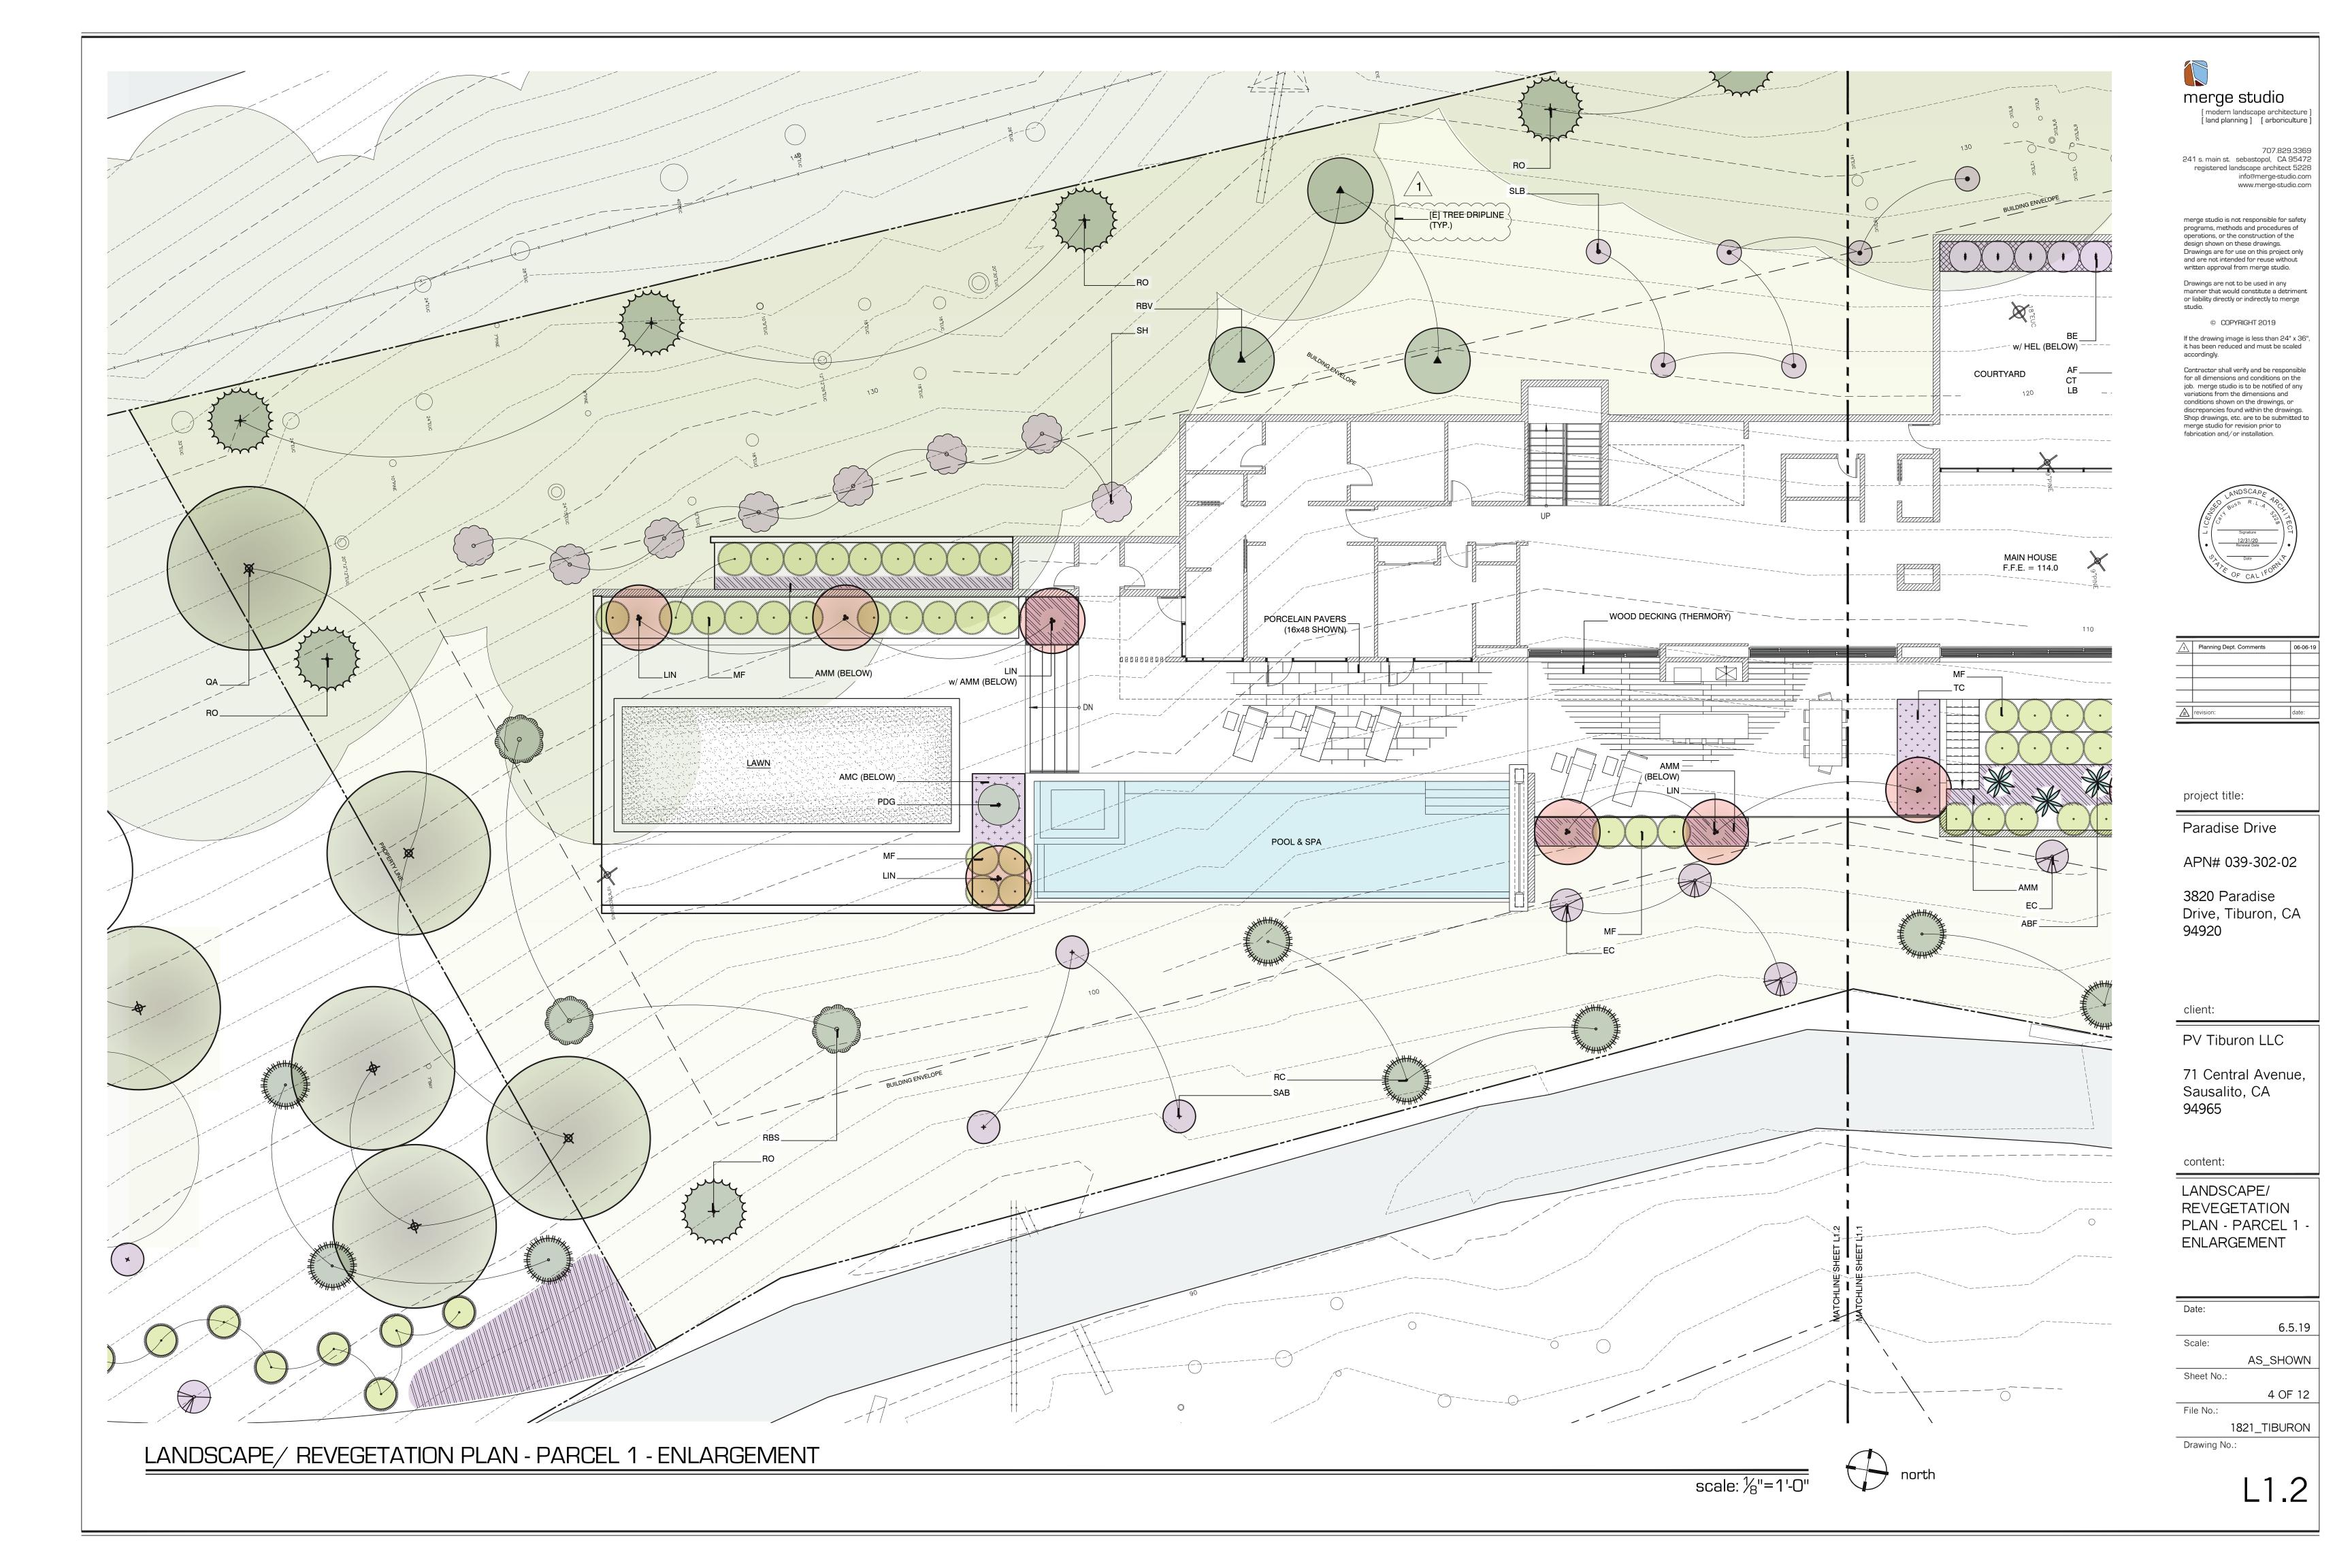[3820 PARADISE DRIVE, TIBURON, CA 94920 - PARCEL 1]

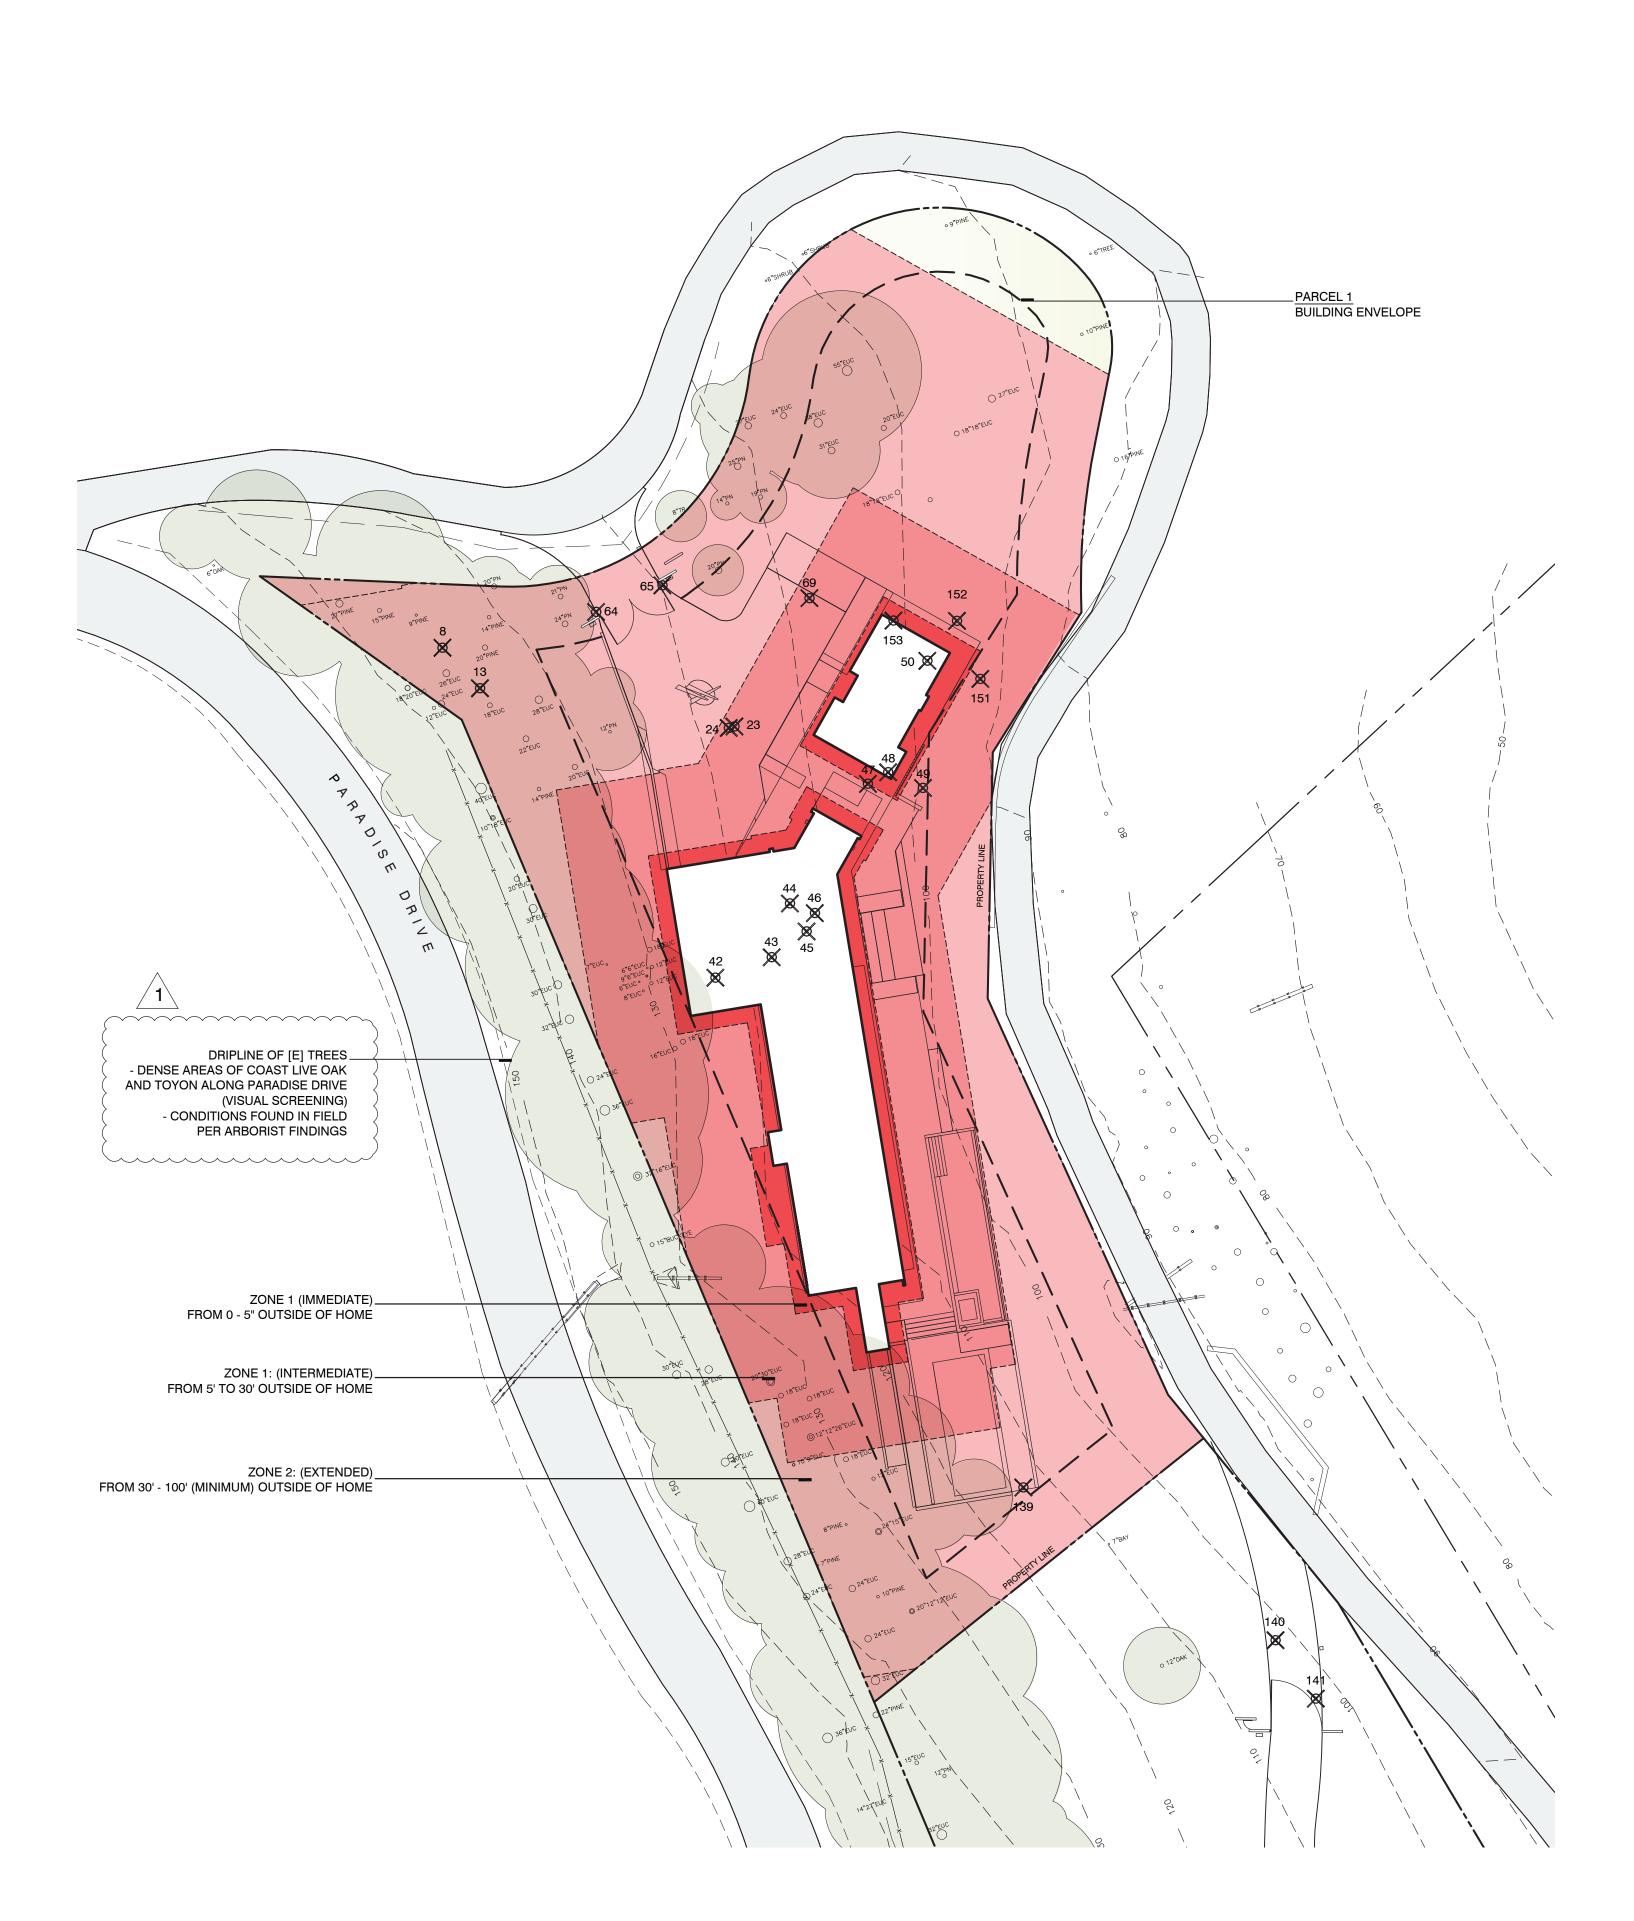SYMBOL DESCRIPTION

[E] TREE: TO REMAIN

[E] TREE: TO BE REMOVED (OBTAIN CITY/ COUNTY PERMIT)

VEGETATION FUELS MANAGEMENT PLAN & DEFENSIBLE SPACE NOTES

[3820 PARADISE DRIVE, TIBURON, CA 94920]

ZONE 1 (IMMEDIATE) - EXTENDS 0-5' FROM YOUR HOUSE. IT'S THE AREA CLOSEST TO YOUR HOUSE, INCLUDING PLANTS, DECKS, OUTDOOR FURNITURE, & THE OUTSIDE WALLS & COVERINGS. THIS AREA IS MOST VULNERABLE, & SHOULD BE MOST AGGRESSIVELY MAINTAINED FOR FIRE RESISTANCE.

1. REMOVE ANY COMBUSTIBLE OUTDOOR FURNITURE.

2. REPLACE JUTE OR FIBER DOOR MATS WITH FIRE RESISTANT MATERIALS.

3. CLEAN ALL FALLEN LEAVES & NEEDLES REGULARLY. REPEAT OFTEN DURING FIRE SEASON.

4. REMOVE ALL FIRE-PRONE PLANTS, & CHOOSE ONLY FIRE-RESISTANT VARIETIES. IRRIGATE REGULARLY.

REMOVE TREE LIMBS THAT EXTEND INTO THIS ZONE. FIRE-PRONE TREES SHOULD BE AGGRESSIVELY PRUNED OR IDEALLY, REMOVED.

PROVIDE ADEQUATE SPACING BETWEEN ALL PLANTS. 7. DO NOT STORE FIREWOOD, LUMBER, OR COMBUSTIBLES HERE, EVEN (ESPECIALLY) UNDER DECKS OR OVERHANGS. MOVE STORED COMBUSTIBLES INSIDE,

OR AT LEAST 30' AWAY FROM STRUCTURES. 8. USE ONLY FIRE RESISTANT MULCHES. 'GORILLA HAIR" OR SIMILAR SHREDDED BARK SHOULD BE REMOVED IN THIS ZONE. COMPOSTED MULCH & LARGE BARK & CHIPS MAY BE OK.

ZONE 1 (INTERMEDIATE) - EXTENDS FROM 5' TO 30' OUT FROM BUILDINGS, STRUCTURES, DECKS, ETC.

REMOVE ALL DEAD PLANTS, GRASS, & WEEDS (VEGETATION).

REMOVE DEAD OR DRY LEAVES & PINE NEEDLES FROM YOUR YARD, ROOF & RAIN GUTTERS.

3. TRIM TREES REGULARLY TO KEEP BRANCHES A MINIMUM OF 10 FEET FROM OTHER TREES. REMOVE BRANCHES THAT HANG OVER YOUR ROOF & KEEP DEAD BRANCHES 10 FEET AWAY FROM YOUR CHIMNEY.

5. RELOCATE WOOD PILES INTO ZONE 2.

REMOVE OR PRUNE FLAMMABLE PLANTS & SHRUBS NEAR WINDOWS.

REMOVE VEGETATION & ITEMS THAT COULD CATCH FIRE FROM AROUND & UNDER DECKS.

8. CREATE ADDITIONAL SEPARATION BETWEEN TREES, SHRUBS & ITEMS THAT COULD CATCH FIRE, SUCH AS PATIO FURNITURE, WOOD PILES, SWING SETS, ETC.

ZONE 2 (EXTENDED) - EXTENDING FROM 30' TO 100' (OR MORE, IF REQUIRED DUE TO STEEP SLOPES, NEARBY VEGETATION CONDITIONS, &/OR YOUR LOCAL FIRE DEPARTMENT), THIS ZONE SHOULD INCLUDE AT A MINIMUM:

1. CUT OR MOW ANNUAL GRASS DOWN TO A MAXIMUM HEIGHT OF 4 INCHES.

CREATE HORIZONTAL SPACING BETWEEN SHRUBS & TREES. (SEE DIAGRAM)

CREATE VERTICAL SPACING BETWEEN GRASS, SHRUBS & TREES. (SEE DIAGRAM)

4. REMOVE FALLEN LEAVES, NEEDLES, TWIGS, BARK, CONES, & SMALL BRANCHES. HOWEVER, THEY MAY BE PERMITTED TO A DEPTH OF 3 INCHES IF EROSION CONTROL IS AN ISSUE.

PER MARIN COUNTY FIRE DEPARTMENT - FIRE PROTECTION STANDARD 220: 1. "IF THE MINIMUM REQUIRED DEFENSIBLE SPACE CROSSES PROPERTY LINES, THE PROPERTY OWNER WILL BE REQUIRED TO OBTAIN A 'DEFENSIBLE SPACE EASEMENT' FROM THE ADJOINING PROPERTY OWNER." - SEE MARIN COUNTY FIRE DEPARTMENT FIRE PROTECTION STANDARD 220 FOR FURTHER

> [3820 PARADISE DRIVE, TIBURON, CA 94920 - PARCEL 1] DEAD - MONTEREY PINE (PINUS RADIATA) DEAD - MONTEREY PINE (PINUS RADIATA) MONTEREY PINE (PINUS RADIATA) TASMANIAN BLUE GUM (EUCALYPTUS GLOBULUS) TASMANIAN BLUE GUM (EUCALYPTUS GLOBULUS) MONTEREY PINE (PINUS RADIATA) MONTEREY PINE (PINUS RADIATA) MONTEREY PINE (PINUS RADIATA) TASMANIAN BLUE GUM (EUCALYPTUS GLOBULUS) MONTEREY PINE (PINUS RADIATA) TASMANIAN BLUE GUM (EUCALYPTUS GLOBULUS) COAST LIVE OAK (QUERCUS AGRIFOLIA) TASMANIAN BLUE GUM (EUCALYPTUS GLOBULUS) TASMANIAN BLUE GUM (EUCALYPTUS GLOBULUS) TASMANIAN BLUE GUM (EUCALYPTUS GLOBULUS)

> > = TOTAL NUMBER OF DIAMETER INCHES OF TREES TO BE REMOVED

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1	Planning Dept. Comments	06-06-19
	revision:	date:
	1011010111	uuto.

project title:

Paradise Drive

APN# 039-302-02

3820 Paradise Drive, Tiburon, CA 94920

PV Tiburon LLC

71 Central Avenue, Sausalito, CA 94965

content:

VEGETATION MANAGEMENT PLAN - PARCEL 1


6.5.19 Scale:

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5 OF 12 File No.:

1821_TIBURON Drawing No.:

AS_SHOWN

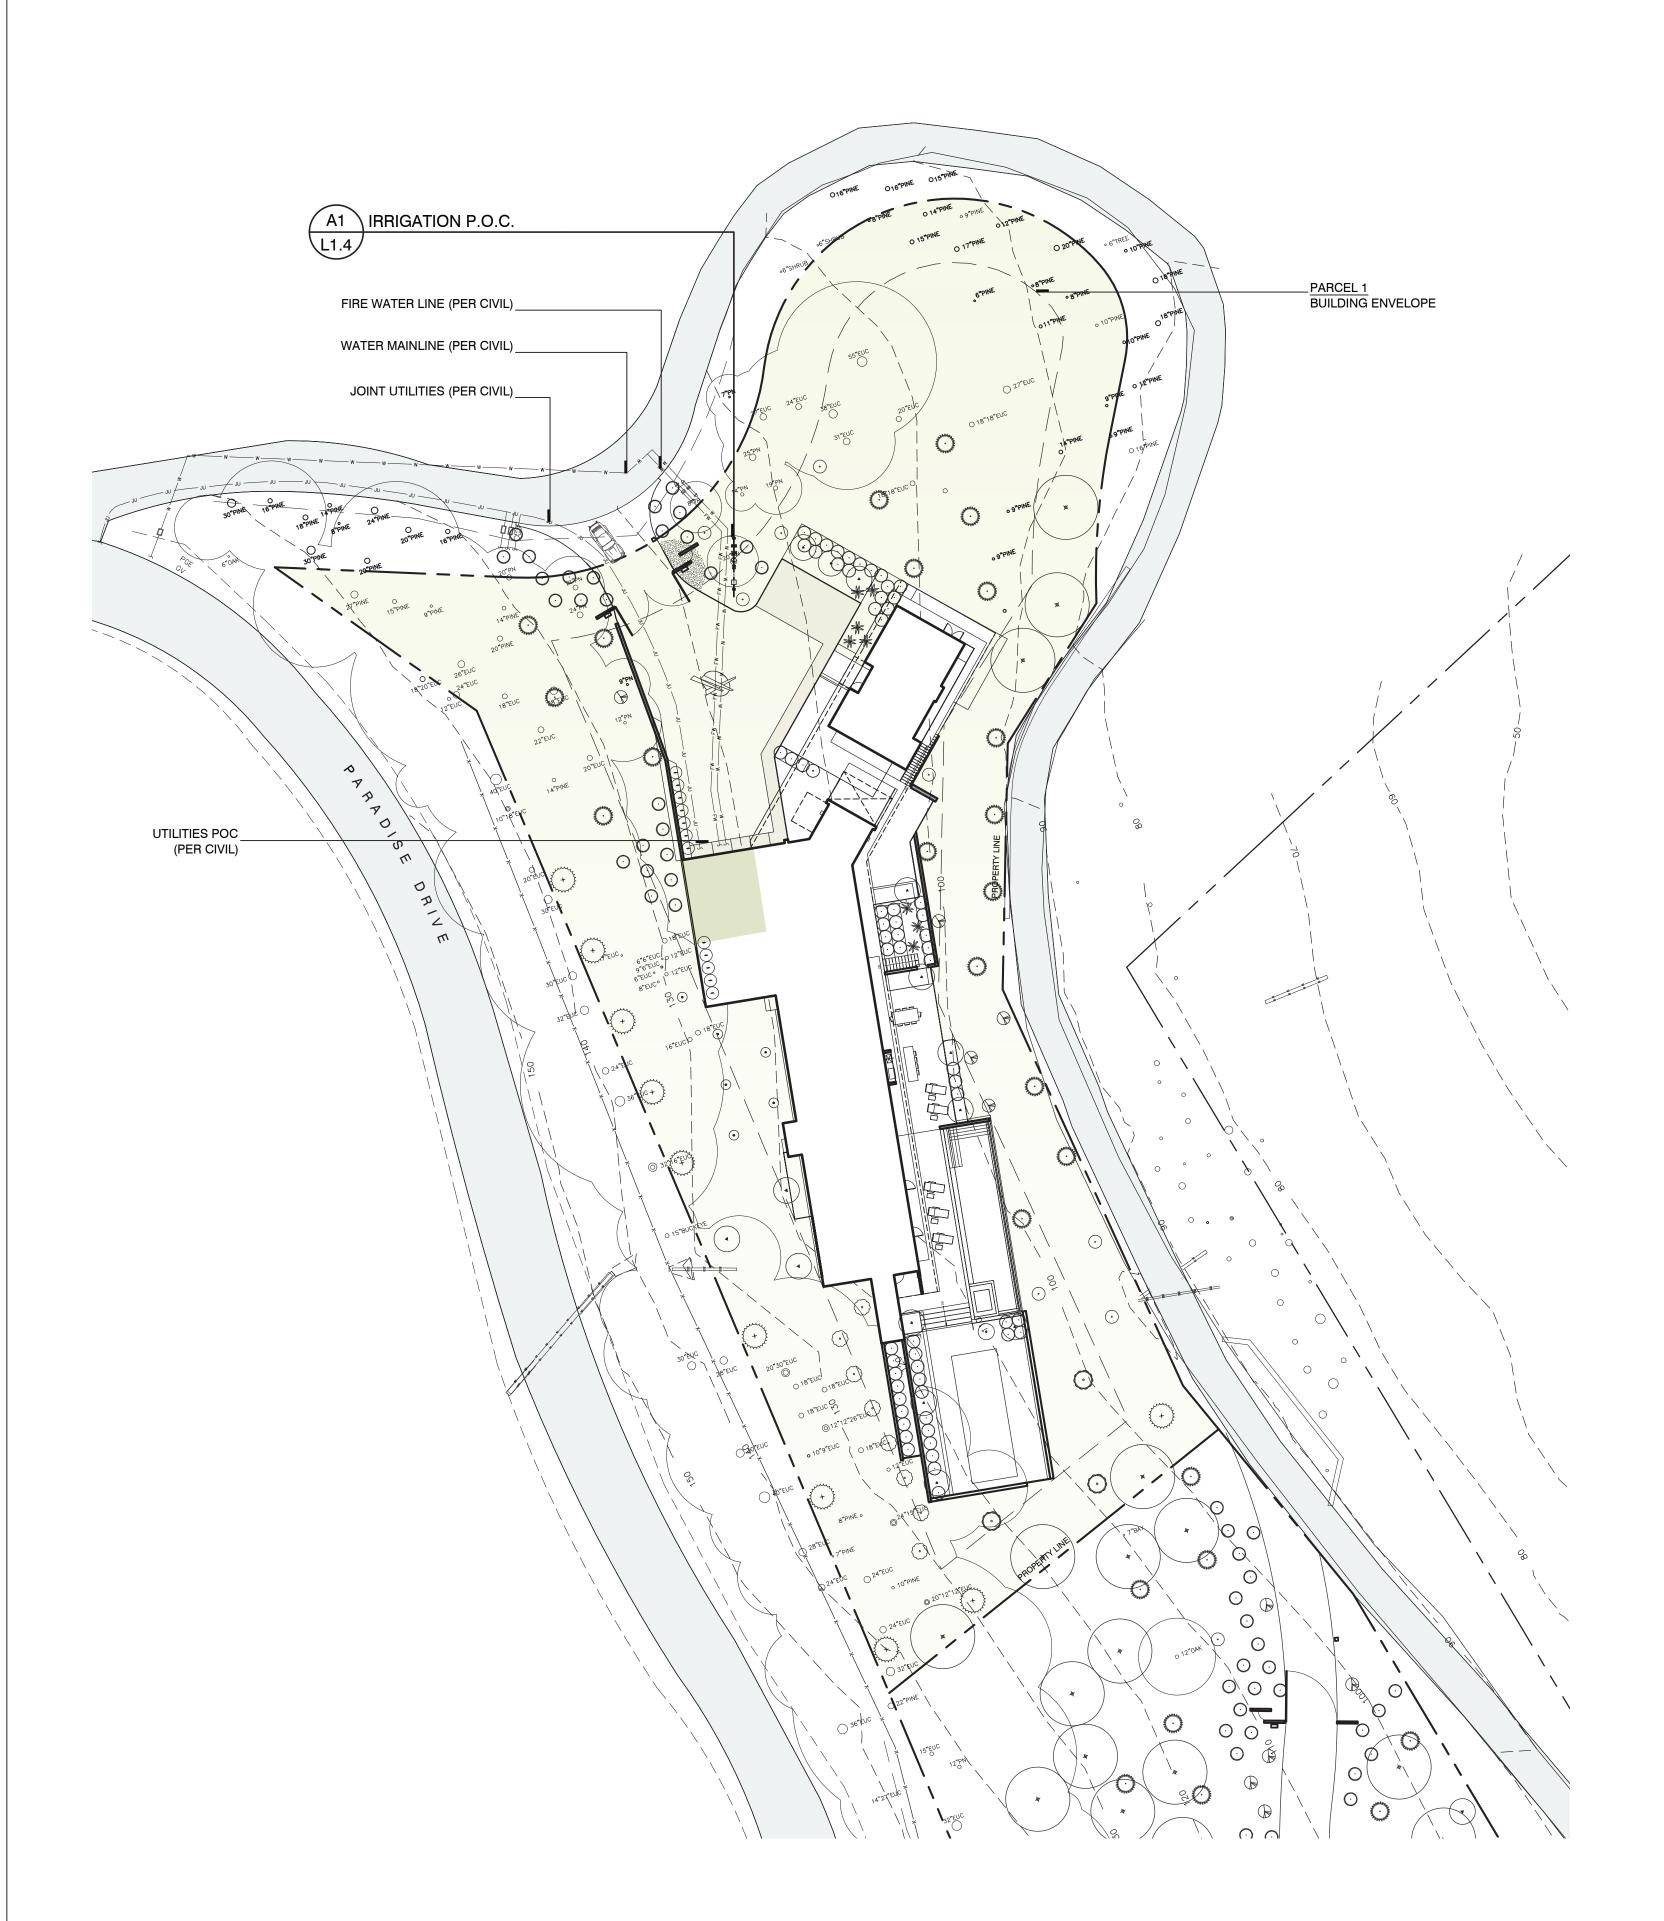

LANDSCAPE IRRIGATION: GEN. METHOD, P.O.C, & PRELIM. WATER USE CALCS - PARCEL 1

scale: 1"=30'



[3820 PARADISE DRIVE, TIBURON, CA 94920 - PARCEL 1]

Maximum Applied Water Allowance

Enter Zip Code 94920 26.33 Residential? Yes

Enter Project Information **Project Name:** 3820 PARADISE DRIVE, TIBURON, CA (PARCEL 1) Address: Meter Number: Location/Sheet No. 1/31/2019

Maximum Applied Water Allowance (MAWA) **20,079** sqft Landscaped Area: **578** sqft Special Landscaped Area: MAWA = **247** CCF

Estimated Total Water Use (ETWU) 19,501 sqft Low water use plant Moderate water use plant High water use plant Efficiency Factor 0.85 % of Total Landscape Irrigation **Efficiency Factor** 0-33% select 0.75 34-66% select 0.80

Water Use Table						
ETWU	Gallons:	118,932	CCF's:	159	AF:	0.37
Baseline Period	Jan/Feb	Mar/Apr	May/Jun	Jul/Aug	Sep/Oct	Nov/Dec
Baseline CCF's	1	17	44	51	37	9
	•	1 CCF = 748 G	allons; 1 AF = 4	35.6 CCF's		•
For more info	ormation please	e contact 415-9	45-1497 or see	our website at	www.marinwat	ter.ora 6

159 CCF

The ETWU (159 CCF) is less than the MAWA (247 CCF), therefore the preliminary water budget complies with the maximum applied water allowance (MAWA).

select 0.85

IRRIGATION STATEMENT

ETWU =

[3820 PARADISE DRIVE, TIBURON, CA 94920 - PARCEL 1]

ALL IRRIGATION WILL BE DESIGNED TO MEET MARIN MUNICIPAL WATER DISTRICT WATER EFFICIENT LANDSCAPE ORDINANCE AND WILL CONTAIN THE FOLLOWING COMPONENTS:

1. THE IRRIGATION SYSTEM WILL BE DESIGNED AND INSTALLED TO MEET IRRIGATION EFFICIENCY IN THE MAXIMUM APPLIED WATER ALLOWANCE.

2. WEATHER BASED, SELF ADJUSTING IRRIGATION CONTROLLER.

EMITTERS TO INCLUDE SUBSURFACE DRIP IRRIGATION WITH TREE & VINE BUBBLERS. 4. NO SPRAY IRRIGATION WILL BE INSTALLED, UNLESS NOTED OTHERWISE.


TREES WILL BEPLACED ON SEPARATE VALVES.

6. ISOLATION VALVES TO BE INSTALLED AT POINT OF CONNECTION AND BEFORE EACH VALVE OR MANIFOLD. 7. PRESSURE REGULATION TO BE INSTALLED.

8. SEPARATE VALVES TO BE INSTALLED TO IRRIGATE ZONES OF MEDIUM AND LOW WATER USE. 9. CHECK VALVES TO BE INSTALLED TO PREVENT LOW POINT DRAINAGE.

10. SITE SPECIFIC SOIL AMENDMENT TO IMPROVE FERTILITY OF SOIL FOR LANDSCAPE PLANTS, INCLUDING NATIVES.

IRRIGATION AREA CALCULATIONS [3820 PARADISE DRIVE, TIBURON, CA 94920 - PARCEL 1] TOTAL AREA (SQ. FT.) IRRIGATION METHOD **ROOT ZONE BUBBLER & DRIP** 14,432 1575 SHRUBS: GRASSES: GROUNDCOVER: 2078 GREEN ROOF: 525 **SPRAY** 578 TOTAL IRRIGATION ALL AREAS: 20,079 SF

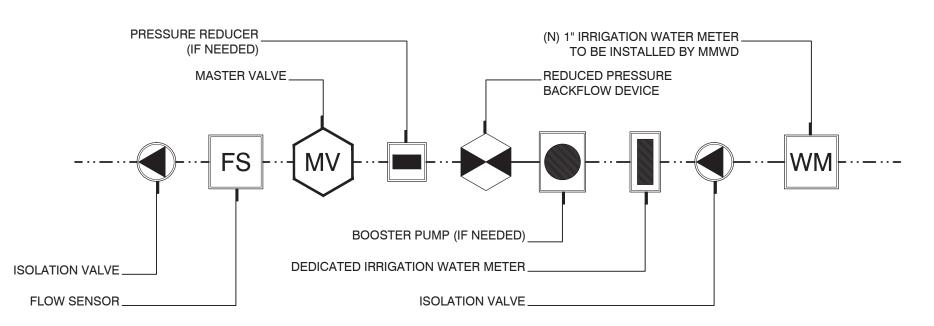

A1 \ IRRIGATION P.O.C. (POINT OF CONNECTION) L1.4 DIAGRAM (N.T.S.)



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<u>#</u>	revision:	date:

project title:

Paradise Drive

APN# 039-302-0 3820 Paradise

Drive, Tiburon, CA

94920

PV Tiburon LLC

71 Central Avenue, Sausalito, CA

content:

LANDSCAPE IRRIGATION: GEN. METHOD, P.O.C, & PRELIM. WATER USE CALCS -PARCEL 1

6.5.19 Scale: AS_SHOWN Sheet No.: 6 OF 12 File No.:

1821_TIBURON

Drawing No.:

PLANT PRECEDENT IMAGERY

TREES



ARBUTUS MARINA (MARINA STRAWBERRY TREE)



CARPINUS FASTIGIATA 'FRANS FONTAINE' (COLUMNAR HORNBEAM)



CELTIS x MAGNIFICA



LAGERSTROEMIA INDICA (MAGNIFICA HACKBERRY) (NATCHEZ CRAPE MYRTLE)



QUERCUS AGRIFOLIA (COAST LIVE OAK)

SHRUBS







AGAVE 'BLUE FLAME' (BLUE FLAME AGAVE) ARCTOSTAPHYLOS 'HOWARD MCMINN' (HOWARD MCMINN MANZANITA)



ARCTOSTAPHYLOS 'SUNSET' (SUNSET MANZANITA)



CORYLUS CORNUTA SPP. CALIFORNICA (WESTERN HAZELNUT)



HIMII AYACAI AMUS F

(CANDYSTRIPE BAMBOO)

'DAMARAPA RED'

PHYSOCARPUS OPULIFOLIUS ('DARTS GOLD' NINEBARK)



RIBES SANGUINEUM 'HEARTS DELIGHT' RIBES VIBURNIFOLIUM (RED-FLOWERING CURRANT)



RHAMNUS CALIFORNICA 'LEATHER LEAF' (LEATHERLEAF COFFEEBERRY)



SOLLYA HETEROPHYLLA (AUSTRALIAN BLUEBELL CREEPER)



RHUS OVATA (SUGAR BUSH)

ORNAMENTAL GRASSES



'EL CAMPO' (CAPE RUSH)

CHONDROPETALUM TECTORUM CAREX TUMULICOLA

GROUNDCOVER/ PERENNIALS/ BULBS


(BERKELEY SEDGE)



(PINE MUHLEY)



MUHLENBERGIA FILIPES (PURPLY MUHLY)

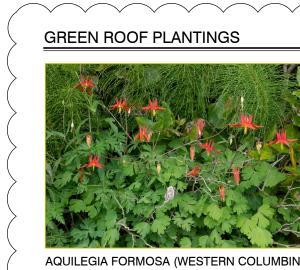

AQUILEGIA FORMOSA (WESTERN COLUMBINE)



LUPINUS 'BICOLOR' (CALIFORNIA LUPINE)

CAREX TUMULICOLA (BERKELEY SEDGE)





EPILOBIUM SPP. 'SELECT MATTOLE' (CALIFORNIA FUSCHIA)





ERODIUM REICHARDII

BERBERIS EURYBRACTEATA (SOFT CARESS MAHONIA)







'VERSICOLOR' (BISHOP'S HAT) (CORSICAN HELLEBORE) (AMETHYST BLUFF PURPLE SAGE)



BIDENS TRIPLINERVIA (TICKSEED)



(BEE'S BLISS SALVIA)

CLINOPODIUM DOUGLASII (YERBA BUENA) EPILOBIUM CANUM (CALIFORNIA FUCHSIA)



(HUMMINGBIRD SAGE)

SEDUM 'AUTUMN FIRE'



ECHEVERIA ELEGANS (HENS & CHICKS)





(CEDROS ISLAND VERBENA)

PLANTING SPECIFICATIONS

[3820 PARADISE DRIVE, TIBURON, CA 94920]

1. CONTRACTOR SHALL BID AND INSTALL PLANT MATERIALS FOR THESE PLANS AND SPECIFICATIONS, UNLESS GIVEN FURTHER WRITTEN

INSTRUCTIONS, OR REVISED PLANS PER OWNER OR LANDSCAPE ARCHITECT. 2. WORK INCLUDES, BUT NOT LIMITED TO, ALL LABOR, EQUIPMENT, AND MATERIALS NECESSARY TO FURNISH, INSTALL, AND GUARANTEE

PLANTINGS, AS SHOWN ON THE DRAWINGS AND SPECIFIED HEREIN.

1. CALL THE UNDERGROUND SERVICE ALERT (USA) AT 1-800-642-2444 TWO DAYS PRIOR TO DIGGING, TO LOCATE ALL UNDERGROUND UTILITIES.CHECK WITH GENERAL CONTRACTOR AND PROJECT MANAGER FOR LOCATION OF ALL UNDERGROUND UTILITIES PRIOR TO

2. BEFORE PROCEEDING WITH ANY WORK, CONTRACTOR SHALL CHECK AND VERIFY ALL DIMENSIONS AND QUANTITIES, AND SHALL INFORM THE LANDSCAPE ARCHITECT OF ANY DISCREPANCIES BETWEEN DRAWINGS AND ACTUAL SITE CONDITIONS PRIOR TO COMMENCING WORK. CONTRACTOR SHALL BE RESPONSIBLE FOR MAKING THEMSELVES FAMILIAR WITH ALL UNDERGROUND UTILITIES, PIPES, AND STRUCTURES. 3. CONTRACTOR SHALL TAKE RESPONSIBILITY FOR ANY COST INCURRED DUE TO DAMAGE TO SAID UTILITIES.

4. CONTRACTOR SHALL NOT WILLFULLY PROCEED WITH CONSTRUCTION AS DESIGNED WHEN IT IS OBIVOUS THAT UNKNOWN OBSTRUCTIONS AND/OR GRADE DIFFERENCES EXIST IN PLANTING AREAS. SUCH CONDITIONS SHALL BE IMMEDIATELY BROUGHT TO THE ATTENTION OF THE

5. CONTRACTOR SHALL ASSUME ALL RESPONSIBILITY FOR WORK INSTALLED IN AN AREA WHERE WORK HAS BEEN MODIFIED WITHOUT WRITTEN

1. MANUFACTURER'S DIRECTIONS AND DETAILED APPLICATION SHALL BE FOLLOWED IN ALL CASES WHERE THE MANUFACTURER'S OF COMPONENTS USED IN THIS CONTRACT, COVER CONTENT NOT SHOWN ON DRAWINGS AND SPECIFICATIONS.

ORDINANCES AND REGULATIONS:

PLANT MATERIAL SHALL CONFORM TO STATE AND FEDERAL LAWS RELATING TO INSPECTION FOR DISEASES AND PEST INFESTATION, AND SHALL CONFORM TO THE AMERICAN STANDARD FOR NURSERY STOCK. PLANT MATERIALS SHALL BE FIRST CLASS REPRESENTATIVES OF THEIR SPECIES OR VARIETY. ALL PLANTS SHALL BE HEALTHY, PEST AND DISEASE FREE, FREE OF GIRDLING ROOTS AND WELL ESTABLISHED IN THE

2. REFER TO THE COUTNY OF MARIN PLANNING DEPARTMENT FOR STANDARDS AND SPECIFICATIONS FOR PLANTING PARKWAY TREES AND SETBACKS FROM UTILITIES.

1. THE CONTRACTOR SHALL GUARANTEE ALL PLANT MATERIALS AND LABOR FOR A PERIOD OF 6 MONTHS. ALL PLANTS SHALL BE HEALTHY AND FREE FROM INFESTATIONS. THE CONTRACTOR SHALL REPLACE ALL UNHEALTHY PLANTS FOR THE ABOVE-MENTIONED TIME PERIOD AT NO COST TO THE OWNERS. SUCH REPAIRS OR REPLACEMENTS SHALL BE COMPLETED WITHIN A SEVEN DAY PERIOD.

CONTRACTOR SHALL NOTIFY CONSTRUCTION MANAGER AND LANDSCAPE ARCHITECT 48 HOURS PRIOR TO COMMENCEMENT OF WORK TO

COORDINATE PROJECT INSPECTION SCHEDULES. 2. REVIEW FINISH GRADE WITH LANDSCAPE ARCHITECT PRIOR TO PLANT PLACEMENT.

3. ALL PLANTS SHALL BE INSPECTED BY LANDSCAPE ARCHITECT FOR HEALTH, PESTS AND SIZE PRIOR TO LAYOUT. CONTRACTOR SHALL LAYOUT ALL PLANTS IN THEIR CONTAINERS AS PER THIS PLAN AND RECEIVE APPROVAL FROM LANDSCAPE ARCHITECT PRIOR TO INSTALLATION

4. LAYOUT PLANTINGS IN FULL QUANTITIES PRIOR TO DIGGING HOLES. 5. LAYOUT AND INSTALL ONLY AS DIRECTED AND APPROVED BY LANDSCAPE ARCHITECT (OR OWNERS REPRESENTATIVE).

EXPLANATION OF DRAWINGS:

1. LAYOUT OF PLANTINGS IS DIAGRAMMATIC AND MAY NEED FIELD ADJUSTMENT FOR EXISTING SITE CONDITIONS NOT SHOWN ON PLANS, OR AS DIRECTED BY THE LANDSCAPE ARCHITECT. ALL DIMENSIONS ARE RELATIVE TO FIELD CONDITION AND ARE NOT EXACT. ADJUSTMENT WILL BE MADE FOR VIEWS, ACCESS, ETC. ALL PLANTINGS SHALL BE FIELD ADJUSTED TO MEET THE MINIMUM STATE REGULATIONS FOR PLANTING AND MAINTAINING A FIRE DEFENSIBLE SPACE, DEPT. OF FORESTRY.

1. CONTRACTOR SHALL SUPPLY ARCHITECT WITH PHOTOS OF SPECIMEN TREES WITH ACTUAL HEIGHT AND WIDTH DIMENSIONS. CONTRACTOR

SHALL PROVIDE SAMPLES OF SOIL AMENDMENTS AND MULCH FOR APPROVAL PRIOR TO DELIVERING ON SITE. 2. CONTRACTOR SHALL SUBMIT RANDOM SOIL SAMPLES FROM THE SITE TO A QUALIFIED SOIL TESTING LAB FOR A HORTICULTRUAL SUITABLILITY TEST AND AMENDMENT RECOMMENDATIONS. AFTER AMENDING TOPSOIL TO A DEPTH OF 8" (AND IN ACCORDANCE WITH SOIL TEST RECOMMENDATIONS), GRADE ALL AREAS SMOOTH WITH NO LOCALIZED DEPRESSIONS OR HUMPS EXCEEDING 1". INSUFFICIENT OR

1. IMPORTED BACKFILL FOR FINISHED GRADING AND RAISED PLANTING BEDS SHALL BE COMPOSED OF A FRIABLE, SANDY LOAM CAPABLE OF SUSTAINING HEALTHY PLANT LIFE, AND CONTAINING NO NOXIOUS WEEDS OR DEBRIS. CONTRACTOR SHALL REMOVE ANY CONSTRUCTION

2. ROTO-TILL AND AMEND WITH 6 CUBIC YARDS PER 1000 SQUARE FEET OF AGED COMPOST. COMPOST AT THE FOLLOWING DEPTHS:

UNSUITABLE EXISTING SOIL SHALL BE AUGMENTED OR REPLACED WITH TOPSOIL AS APPROVED BY THE LANDSCAPE ARCHITECT.

2.1. TURF AREAS - 4" MIN. AMENDED SOIL DEPTH. 2.2. SHRUB AREAS - 6-8" AMENDED SOIL DEPTH.

3. AMEND PLANTING HOLE AS PER PLANTING DETAIL, USE MICROBIAL ORGANIC STARTER (DERIVED FROM SOYBEAN AND COTTONSEED MEAL, SOFT ROCK PHOSPHATE AND POTASSIUM SULFATE WITH MYCORRHIZAL INNOCULANT SPORES) AND ORGANIC HUMIC SOIL AT RECOMMENDED RATE. USE "GREEN DIAMOND MYKOS START PRO" (4-2-2 ORGANIC FERTILIZER) OR APPROVED EQUAL.

4. GRADE AND RAKE ALL PLANTING AREAS TO REMOVE DEBRIS LARGER THAN 1" DIAMETER. RE-ESTABLISH POSITIVE DRAINAGE AND SWALES

PRIOR TO PLANTING. 5. INSTALL SHRUBS AND TREES AS PER PLANTING DETAILS. THOROUGHLY WATER IMMEDIATELY AFTER INSTALLATION. CONTRACTOR IS

RESPONSIBLE TO APPLY SUFFICIENT BUT NOT EXCESS IRRIGATION TO ALL NEW PLANTINGS TO ENSURE HEALTHY PLANT ESTABILISHMENT. 6. WATER ALL PLANTS BY HANDHELD HOSE WITH WATERING WAND ATTACHMENT IMMEDIATELY AFTER PLANTING (NO WATER 'JETTING'). NO PLANT SHOULD BE OUT OF ITS CONTAINER MORE THAN 20 MINUTES BEFORE BEING PLANTED AND WATERED. CONTRACTOR SHALL BE RESPONSIBLE FOR IRRIGATING ALL NEW PLANTINGS UNTIL THE ENTIRE PROJECT HAS BEEN COMPLETED AND ACCEPTED BY THE OWNER.

7. AFTER PLANTING, PRIOR TO MULCHING, VERIFY OPERATING QUALITY OF IRRIGATION PER SPECIFICATIONS. THOROUGHLY WATER IN AFTER MULCHING IS COMPLETE.

8. NO PLANT SHALL BE PLANTED WITH ROOTBALLS OR PLANTING PITS IN A DRY CONDITION.

9. INSTALL MULCH TO A MIN. DEPTH OF 3" IN ALL PLANTING AREAS. MULCH FOR THESE AREAS WILL BE CRUSHED AND SCREENED ARBOR MULCH ON SLOPES AND 3/8" MINUS FIR (SIERRA MINI) BARK IN ALL OTHER AREAS. VERIFY EXACT LOCATIONS IN FIELD WITH LANDSCAPE ARCHITECT. 10. MULCH SHALL BE KEPT AT A MAXIMUM DEPTH OF 3" AT PLANT CROWNS AND TRUNKS, AND NOT EXTEND HIGHER THAN 1/8" ONTO THE CROWN

OR TRUNK OF ANY NEWLY PLANTED PLANT OR TREE. 11. ALL PLANT MATERIAL SHOWN ON THE PLANTING PLAN IS SUBJECT TO THE ADVERSE EFFECTS OF NATURE INCLUDING, BUT NOT LIMITED TO, FIRE, EARTHQUAKE, FLOODING, FREEZE, DROUGHT, EROSION AND FORAGING PREDATORS. THE LANDSCAPE ARCHITECT CANNOT, AND DOES NOT, GUARANTEE OR IMPLY WARRANTY THAT SPECIFIED PLANTS WILL SURVIVE THESE ACTS OF NATURE. ALL PLANTS SPECIFIED SATISFY THE GENERAL CLIMATIC CONDITIONS SET FORTH BY THE U.S. DEPARTMENT OF AGRICULTURE, THE SUNSET WESTERN GARDEN BOOK, AND WATER

MAINTENANCE PERIOD:

STRAW, SILT FENCE, ETC.

PROVIDE A SIX-MONTH MAINTENANCE PERIOD UPON FINAL COMPLETION OF PLANTING OPERATIONS.

. WHEN PLANTING OPERATIONS ARE COMPLETE, NOTIFY LANDSCAPE ARCHITECT. A SITE WALK-THRU WILL BE PERFORMED AND ANY ITEMS NOT IN CONFORMANCE WITH PLANS WILL BE LISTED ON A PUNCH LIST. ALL PUNCH LIST ITEMS MUST BE COMPLETED PRIOR TO STARTING THE THREE-MONTH MAINTENANCE PERIOD.

3. THREE-MONTH MAINTENANCE SHALL INCLUDE LABOR AND MATERIALS TO FERTILIZE, WEEK, AND BE FREE OF PESTS AND DISEASE. ALL UNHEALTHY AND/OR DEAD PLANTS SHALL BE REPLACED. IN AREAS WHERE MOLES OR GOPHERS ARE A PROBLEM, BAIT OR TRAP ACCORDINGLY.

CLEAN-UP: 1. CLEAN-UP SHALL BE MADE AS EACH PORTION OF WORK PROGRESSES. ALL PAVING AND WALKS SHALL BE SWEPT OR WASHED DOWN AND ANY DAMAGE SUSTAINED TO THE WORK OF OTHERS SHALL BE REPAIRED TO ORIGINAL CONDITIONS AT NO ADDITIONAL COST TO OWNER. 1.1. DURING WET OR RAINY PERIODS, PROTECT ANY OPEN SLOPE, CLEARED OF VEGETATION WITH APPROPRIATE EROSION CONTROL MEASURES:

1.2. FOR ADDITIONAL INFORMATION SEE PLANTING DETAILS ON SHEET L2.0.

USE CLASSIFICATION OF LANDSCAPE SPECIES (WUCOLS).

merge studio [modern landscape architecture [land planning] [arboriculture]

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•	Λ	Planning Dept. Comments	06-06-19		
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	<u>#</u>	revision:	date:		

project title:

Paradise Drive

APN# 039-302-02

APN# 039-302-03

3820 Paradise Drive Tiburon, CA 94920

PV Tiburon LLC 71 Central Avenue,

Sausalito, CA

PLANT PRECEDENT **IMAGERY &** PLANTING NOTES & SPECIFICATIONS

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