





# TOPOGRAPHIC SURVEY

SCALE: 1" = 8'      NOVEMBER, 2021


**LEGAL DESCRIPTION:**

LOT 10 OF TRACT NO. 14078, IN THE CITY OF LOS ANGELES, COUNTY OF LOS ANGELES, STATE OF CALIFORNIA, AS PER MAP RECORDED IN BOOK 292, PAGES 49 AND 50 OF MAPS, IN THE OFFICE OF THE COUNTY RECORDER OF SAID COUNTY.

**FOR:**


NERSES YARLIJANYAN  
 12422 BROMWICH ST.  
 PACOIMA, CA 91331

BY: *Lawrence J. Schmah*  
 LAWRENCE J. SCHMAHL      L.S. 5748

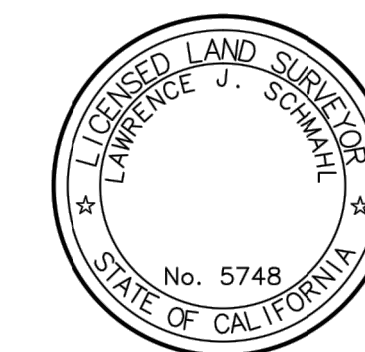

**LEGEND:**

- A.C. ASPHALT CONCRETE
- BW BACK OF WALK
- CONC. CONCRETE
- E EAST
- FF FINISHED FLOOR
- FL FLOWLINE
- N NORTH
- S SOUTH
- TC TOP OF CURB
- TG TOP OF GRATE
- TW TOP OF WALL
- W WEST
- BUILDING LINE
- CENTERLINE
- EDGE OF PAVEMENT
- ELECTRIC METER
- FENCE, CHAIN-LINK
- FENCE, IRON
- FENCE, WOOD
- GAS METER
- GATE MOTOR
- GUY WIRE
- LIGHT POLE
- MAIL BOX
- POWER POLE
- PROPERTY LINE
- SEWER MANHOLE
- SPOT ELEVATIONS
- WALL
- WATER METER
- WATER VALVE

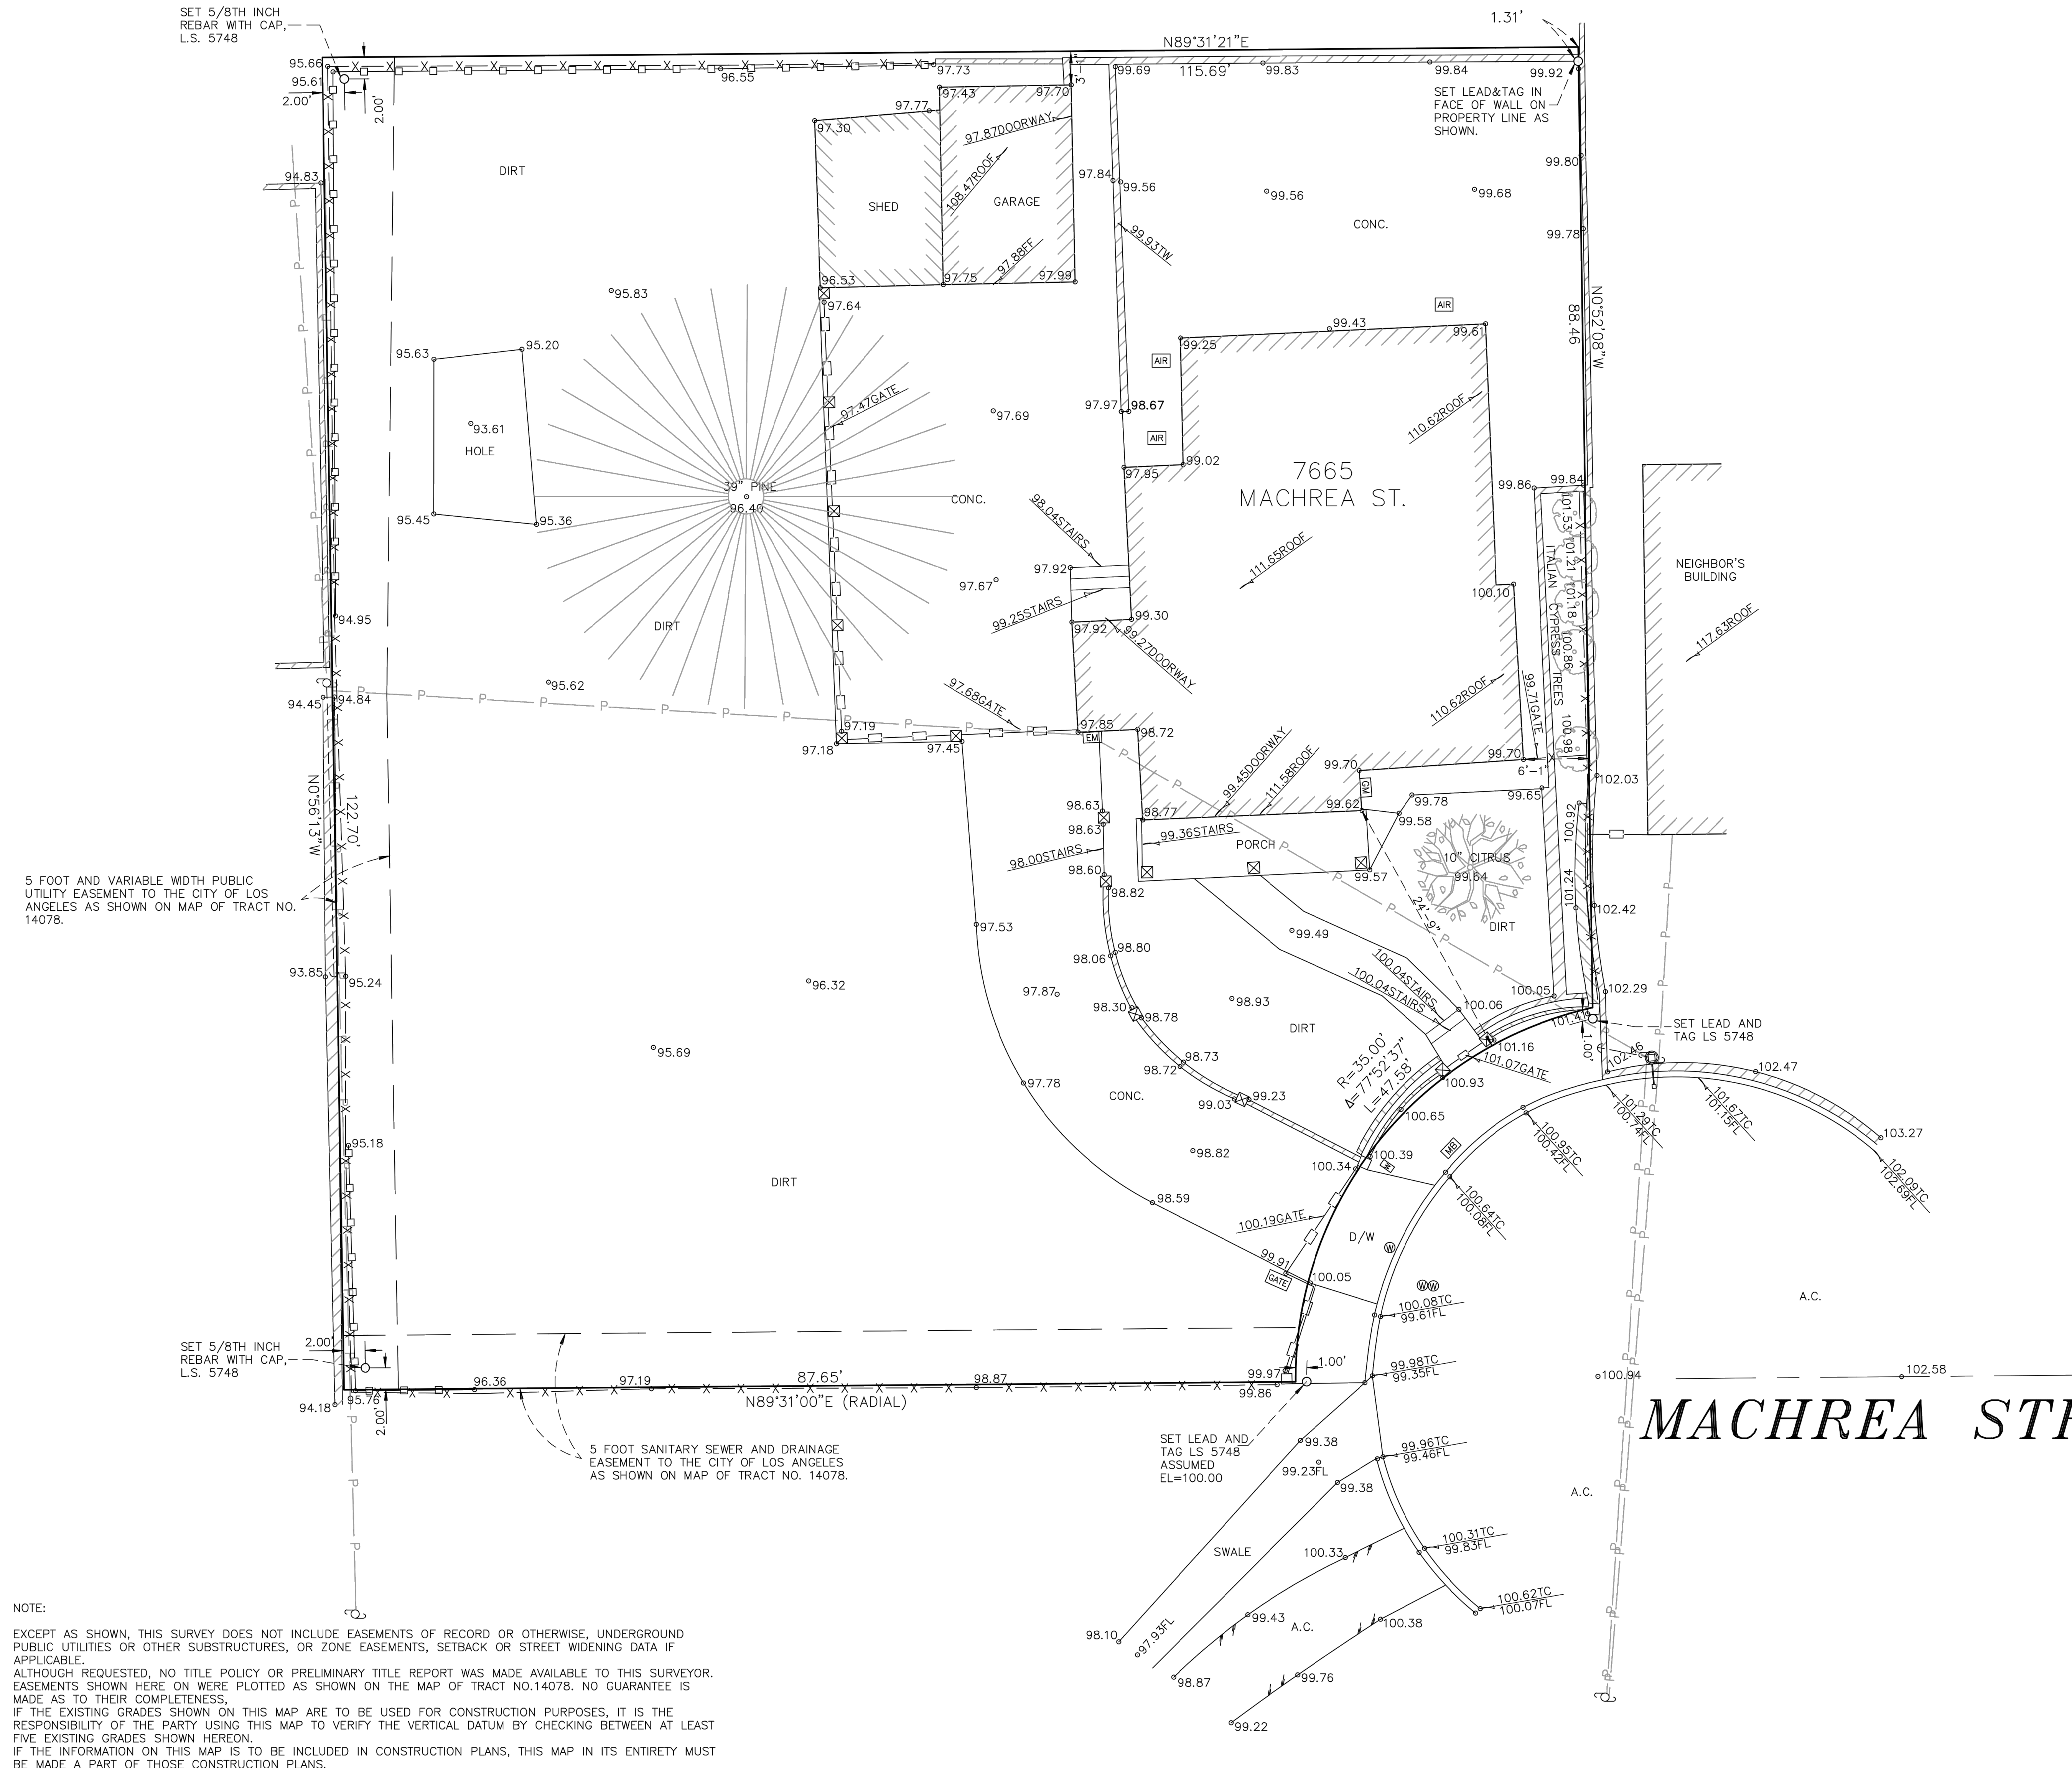

**NOTE:**  
 EXCEPT AS SHOWN, THIS SURVEY DOES NOT INCLUDE EASEMENTS OF RECORD OR OTHERWISE, UNDERGROUND PUBLIC UTILITIES OR OTHER SUBSTRUCTURES, OR ZONE EASEMENTS, SETBACK OR STREET WIDENING DATA IF APPLICABLE.  
 ALTHOUGH REQUESTED, NO TITLE POLICY OR PRELIMINARY TITLE REPORT WAS MADE AVAILABLE TO THIS SURVEYOR. EASEMENTS SHOWN HERE ON WERE PLOTTED AS SHOWN ON THE MAP OF TRACT NO.14078. NO GUARANTEE IS MADE AS TO THEIR COMPLETENESS.  
 IF THE EXISTING GRADES SHOWN ON THIS MAP ARE TO BE USED FOR CONSTRUCTION PURPOSES, IT IS THE RESPONSIBILITY OF THE PARTY USING THIS MAP TO VERIFY THE VERTICAL DATUM BY CHECKING BETWEEN AT LEAST FIVE EXISTING GRADES SHOWN HEREON.  
 IF THE INFORMATION ON THIS MAP IS TO BE INCLUDED IN CONSTRUCTION PLANS, THIS MAP IN ITS ENTIRETY MUST BE MADE A PART OF THOSE CONSTRUCTION PLANS.

## MACHREA STREET



















City of Los Angeles
7665 W MACHREA ST
APN: 2558002018

RE: 7665 W MACHREA ST APN: 2558-002-018

In response to your request of May 14, 2021, regarding zoning information on the above referenced property ("Property"), please be advised of the following:

The property, known as Tract: TR 14078, Block: None, Lot: 10, which is shown on the Zoning Map to be located in the RD3-1 Zone. See the attached print out of the Parcel Profile Report for zoning related information pertaining to this property.

You requested a determination of the lot lines. Please be advised of the following: In order to better understand how and why we are making our determination, we should first see how some common terms are defined in the zoning code. According to LAMC Section 12.03, these terms are defined as follows:


LAMC SECTION 12.03 - "DEFINITIONS"
FRONTAGE. All property fronting on one (1) side of a street between intersecting or intersecting streets, or between a street and right-of-way, waterway, end of dead-end street, or city boundary measured along the street line. An intersecting street shall determine only the boundary of the frontage on the side of the street which it intercepts.
LOT. A parcel of land occupied or to be occupied by a use, building or unit group of buildings and accessory buildings and uses, together with the yards, open spaces, lot width and lot area as are required by this chapter and fronting for a distance of at least 20 feet upon a street as defined here, or upon a private street as defined in Article 8 of this chapter. The width of an access-strip portion of a lot shall not be less than 20 feet at any point.

This property is considered to be an Interior Lot. As defined above, the lot line fronting on Machrea Street shall be the front lot line. The remaining lot lines shall be as indicated in the attached zoning map.

This letter is in response to a zoning code question only and based on limited information. Full code compliance shall also be to the satisfaction of the Department of Building and Safety Plan Check through the submission of fully detailed plans.

This information is provided as of May 17, 2021 and the zone is as shown on the Zoning Map. Should you need any further assistance pertaining to this matter, please contact Eric Wong at Eric.Wong@cityofla.org.

Eric Wong
Structural Engineering Associate II
Chad Doi
Zoning Engineer
Attachments
CD:EW:aw

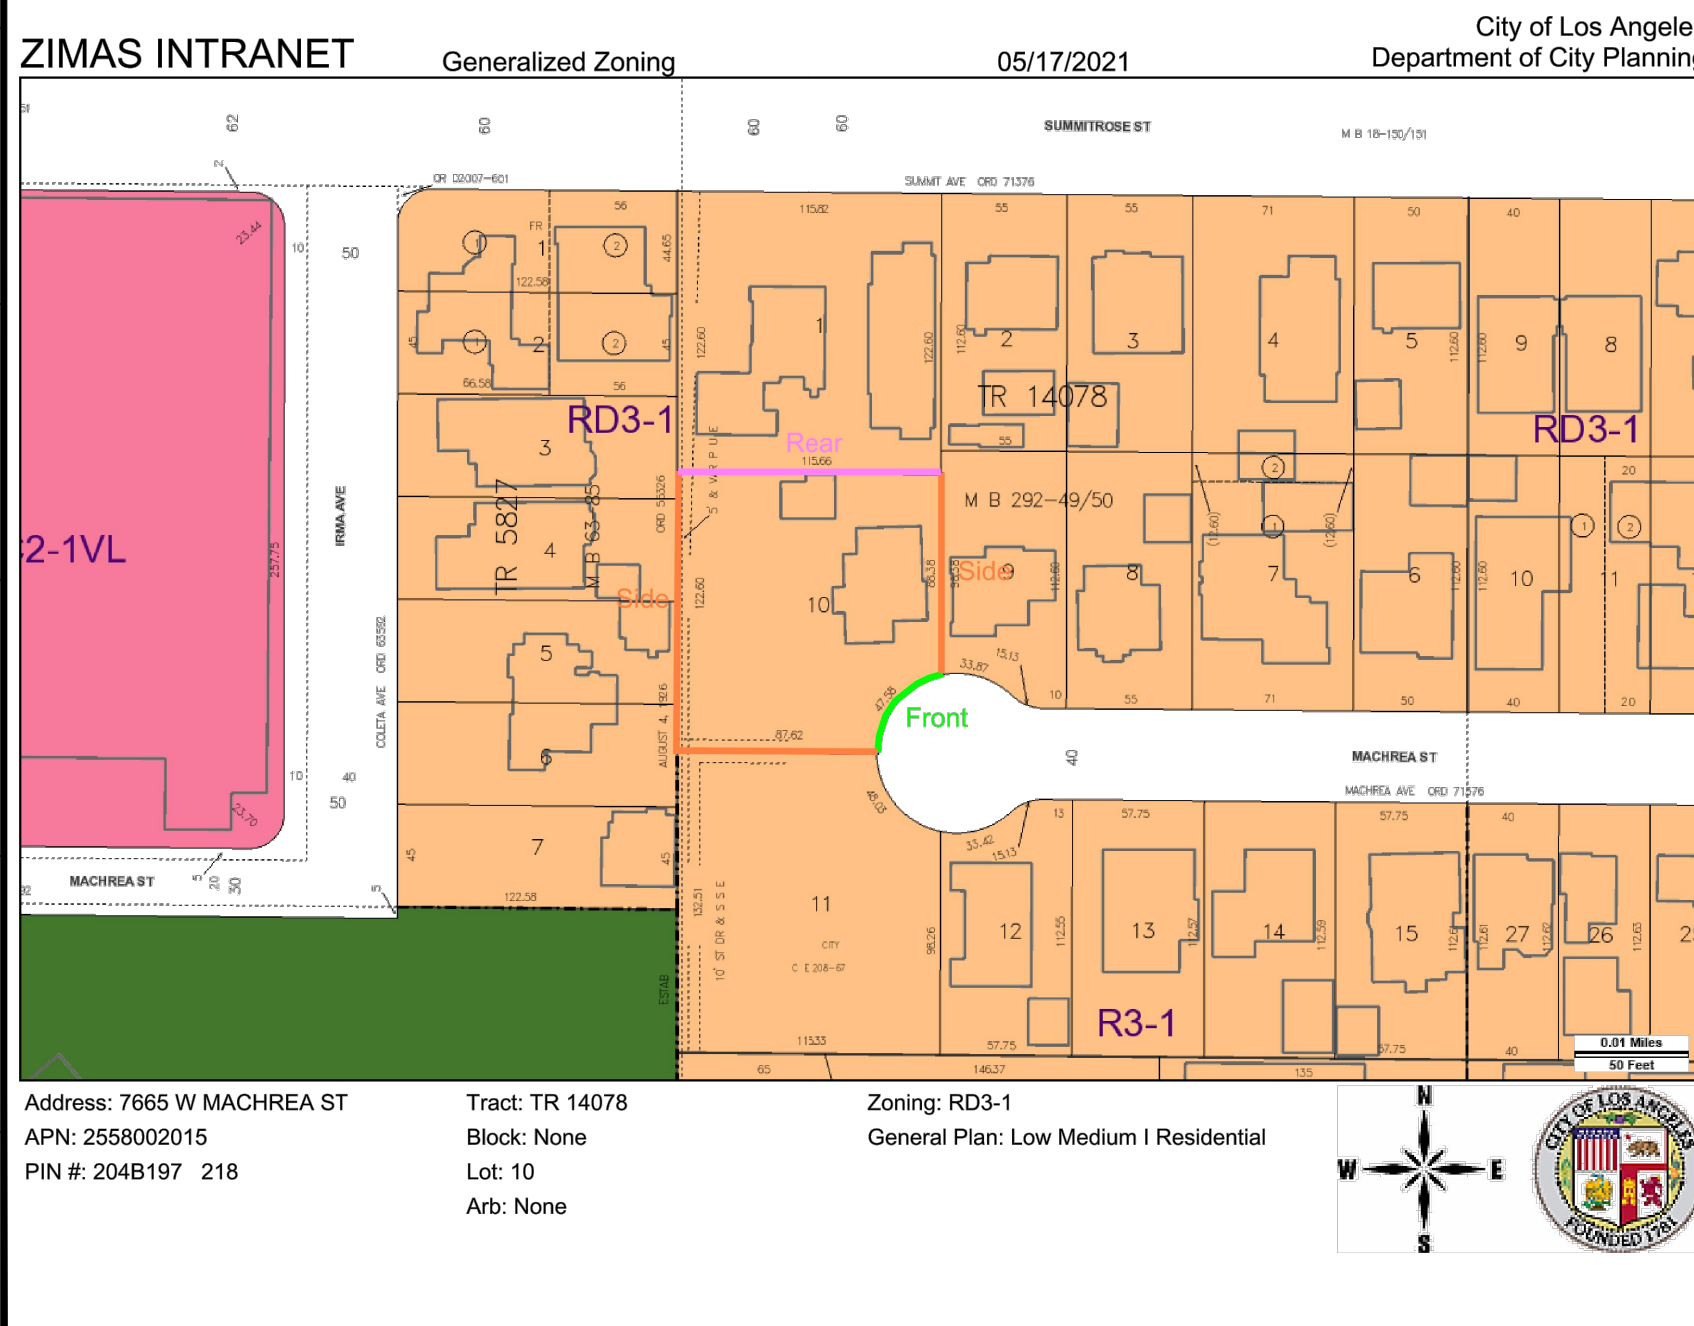

ZONING DETERMINATION LETTER:

NOTES TO CONTRACTOR:

- 1. THE CONTRACTOR SHALL MAINTAIN PROPER ACCESS FOR FIRE DEPARTMENT VEHICLES AND EQUIPMENT AT ALL TIMES. ANY CHANGES MADE TO FIRE DEPARTMENT ACCESS ROUTES SHALL BE REVIEWED BY FIRE DEPARTMENT AUTHORITIES HAVING JURISDICTION PRIOR TO CHANGING ACCESS ROUTING.
2. THE CONTRACTOR SHALL SECURE AND PAY FOR ALL NECESSARY PERMITS AND NOTIFY THE PROPER AUTHORITIES HAVING JURISDICTION OVER THE WORK PRIOR TO STARTING. SAID PERMITS AND CERTIFICATIONS SHALL BE KEPT ON THE SITE AT ALL TIMES.
3. PRIOR TO START OF WORK, THE CONTRACTOR SHALL CAREFULLY INSPECT AND VERIFY ALL CONDITIONS SHOWN ON THE CONTRACT DRAWINGS. IF WORK CAN NOT BE PERFORMED AS SHOWN, THE CONTRACTOR SHALL NOTIFY THE OWNER IMMEDIATELY. WORK PERFORMED AFTER SUCH DISCOVERY, UNLESS AUTHORIZED BY THE OWNER, SHALL BE DONE AT THE CONTRACTOR'S RISK.
4. THE CONTRACTOR SHALL VERIFY AND CHECK ALL DIMENSIONS AND ELEVATIONS AT THE PROJECT SITE AND THE OVERALL CORRECTNESS OF THESE DOCUMENTS BY STUDYING THEM THOROUGHLY AND IF THERE ARE ANY QUESTIONS TO CONTACT THE OWNER OR DESIGNER IMMEDIATELY FOR CLARIFICATION PRIOR TO THE BIDDING AND BEFORE THE START OF CONSTRUCTION.
5. THE CONTRACTOR SHALL NOT INTERRUPT EXISTING UTILITIES SERVING EXISTING FACILITIES, EXCEPT WHEN AUTHORIZED IN WRITING BY THE PROPERTY OWNER. PROVIDE TEMPORARY SERVICES DURING CONSTRUCTION.
6. THE WORK SHALL INCLUDE ALL DEMOLITION AND REMOVALS NOT SPECIFICALLY INDICATED ON DRAWINGS BUT NECESSARY FOR THE COMPLETION OF THE WORK.
7. THE CONTRACTOR SHALL COORDINATE ANY AND ALL REQUIREMENTS FOR OFF SITE IMPROVEMENTS INCLUDING, BUT NOT LIMITED TO SIDEWALKS, DRIVEWAYS, CURBS, GUTTERS, UTILITIES, ETC. OFF-SITE IMPROVEMENTS SHALL MEET THE REQUIREMENTS OF THE AUTHORITY HAVING JURISDICTION.
8. THE CONTRACTOR SHALL PROVIDE PROTECTIVE BARRICADES WHERE REQUIRED DURING CONSTRUCTION.
9. THE CONTRACTOR SHALL KEEP ALL EXITS READILY ACCESSIBLE AND UNOBSTRUCTED AT ALL TIMES.
10. DO NOT SCALE DRAWINGS. USE DIMENSIONS INDICATED. DIMENSIONS HAVE PREFERENCE OVER SCALE.
11. WHEN A DETAIL IS IDENTIFIED AS TYPICAL, THE CONTRACTOR SHALL APPLY THIS DETAIL TO EVERY LIKE CONDITION WHETHER OR NOT THE REFERENCE IS REPEATED IN EVERY INSTANCE.
12. THE SIZES, LOCATION FOR MOUNTINGS AND ATTACHMENTS AND LOCATIONS OF UTILITY CONNECTIONS FOR EACH ITEM OF EQUIPMENT SHOWN ON THE DRAWINGS ARE FOR ILLUSTRATION ONLY. ALL CAN VARY FROM MANUFACTURER TO MANUFACTURER AND ARE DEPENDENT ON THE EXACT MANUFACTURER'S MODEL FURNISHED. THE CONTRACTOR SHALL PROVIDE AND COORDINATE EXACT DIMENSIONS RELATING TO THE SIZE OF EACH ITEM OF EQUIPMENT, THE LOCATIONS OF ALL FITTINGS AND ATTACHMENTS FOR EACH EQUIPMENT AND FOR ALL UTILITY CONNECTIONS TO EACH ITEM OF EQUIPMENT.
13. THE CONTRACTOR SHALL PROVIDE AND COORDINATE THE EXACT DIMENSIONS, SIZES AND POSITIONS OF ALL OPENINGS IN FLOOR, ROOF AND WALL CONSTRUCTION NECESSARY FOR THE INSTALLATION OF THE WORK.
14. PROVIDE LABELS ON DOORS, FRAMES AND OTHER ASSEMBLIES AT OPENINGS IN FIRE RATED CONSTRUCTION.
15. THE INTENT OF THE DRAWINGS AND SPECIFICATIONS IS TO EXECUTE THE WORK IN ACCORDANCE WITH TITLE 24, CALIFORNIA CODE OF REGULATIONS. SHOULD ANY CONDITIONS DEVELOP NOT COVERED BY THE CONTRACT DOCUMENTS WHEREIN THE FINISHED WORK WILL NOT COMPLY WITH SAID TITLE 24, CALIFORNIA CODE OF REGULATIONS, CONTRACTOR SHALL NOTIFY THE OWNER BEFORE PROCEEDING WITH THE WORK. THE GENERAL CONTRACTOR SHALL CONTACT THE DEPARTMENT OF BUILDING AND SAFETY AND VERIFY THAT THEY ARE NOW THE CONTRACTOR OF RECORD FOR THIS PROJECT. THEY SHALL PROVIDE THE DEPARTMENT OF BUILDING AND SAFETY WITH PROOF OF CURRENT WORKERS COMPENSATION INSURANCE AND SHALL ASSUME FULL RESPONSIBILITY FOR SUCH COVERAGE. THIS IS TO BE DONE BY THE GENERAL CONTRACTOR PRIOR TO THE START OF CONSTRUCTION.
16. ALL WORK SHALL BE DONE IN AN APPROVED WORKMANLIKE MANNER.
17. APPROVALS BY BUILDING INSPECTOR SHALL NOT CONSTITUTE AUTHORITY TO DEVIATE FROM THIS PLANS AND SPECIFICATIONS.
18. THE CONTRACTORS SHALL BE REQUIRED TO MAINTAIN WORKMAN'S COMPENSATION INSURANCE AS PROVIDED BY CALIFORNIA LAW, ALSO PUBLIC LIABILITY AND PROPERTY DAMAGE INSURANCE OF ADEQUATE COVERAGE, FIRE INSURANCE, THEFT AND VANDALISM INSURANCE DURING CONSTRUCTION UP TO THE CERTIFICATE OF OCCUPANCY ISSUED AND/OR OWNER'S SATISFACTION OF COMPLETION OF CONTRACT.
19. FOR GENERAL AND PLAN LAYOUT, CONSTRUCTION DETAILS, ETC. REFER ONLY TO THE ARCHITECTURAL SHEETS WHICH SHALL TAKE PRECEDENCE OVER ANY OTHER DRAWINGS. UNLESS OTHERWISE NOTED, ALL DIMENSIONS ARE SHOWN AS FOLLOWS: FACE OF WALL AT MASONRY, INDICATED FACE OF STUD, CENTER LINE, GRID LINE, TOP OF CONCRETE SLAB OR FOUNDATION, TOP OF PLUMBING, ETC. DRAWINGS SHALL NOT BE SCALED TO DETERMINE ANY DIMENSIONS, REFER ONLY TO WRITTEN INFORMATION AND DETAIL DRAWINGS.

GENERAL NOTES - (CONT'D):

- FIRE PROTECTION:
A. THE BUILDING SHALL BE EQUIPPED WITH AN AUTOMATIC RESIDENTIAL FIRE SPRINKLER SYSTEM IN ACCORDANCE WITH SECTION R313.3 OR NFPA13D. (R313, 12.21A17(d))
B. THE SPRINKLER SYSTEM SHALL BE APPROVED BY PLUMBING DIVISION PRIOR TO INSTALLATION.
C. AN APPROVED SMOKE ALARMS SHALL BE INSTALLED IN EACH SLEEPING ROOM & HALLWAY OR AREA GIVING ACCESS TO A SLEEPING ROOM, AND ON EACH STORY AND BASEMENT FOR DWELLINGS WITH MORE THAN ONE STORY. SMOKE ALARMS SHALL BE INTERCONNECTED SO THAT ACTIVATION OF ONE ALARM WILL ACTIVATE ALL THE ALARMS WITHIN THE INDIVIDUAL DWELLING UNIT. IN NEW CONSTRUCTION SMOKE ALARMS SHALL RECEIVE THEIR PRIMARY POWER SOURCE FROM THE BUILDING WIRING AND SHALL BE EQUIPPED WITH BATTERY BACKUP AND LOW BATTERY SIGNAL. (R314)
D. CARBON MONOXIDE ALARM IS REQUIRED PER (402.6,R315)
AN APPROVED CARBON MONOXIDE ALARM SHALL BE INSTALLED IN DWELLING UNITS AND IN SLEEPING UNITS WITHIN WHICH FUEL-BURNING APPLIANCES ARE INSTALLED AND IN DWELLING UNITS THAT HAVE ATTACHED GARAGES. CARBON MONOXIDE ALARM SHALL BE PROVIDED OUTSIDE OF EACH SEPARATE DWELLING UNIT SLEEPING AREA IN THE IMMEDIATE VICINITY OF THE BEDROOM(S) AND ON EVERY LEVEL OF A DWELLING UNIT INCLUDING BASEMENTS. (R315)
E. A FIRE ALARM (VISUAL & AUDIBLE) SYSTEM IS REQUIRED. THE ALARM SYSTEM MUST BE PROVIDED BY THE FIRE DEPARTMENT AND ELECTRICAL PLAN CHECK PRIOR TO INSTALLATION (LAMC 57.122)
BATHROOMS:
A. ALL SHOWER ENCLOSURES, REGARDLESS OF SHAPE, SHALL HAVE A MINIMUM FINISHED INTERIOR AREA OF NOT LESS THAN 1024 SQUARE INCHES (0.64m²) AND SHALL BE CAPABLE OF ENCOMPASSING A 30 INCH DIAMETER (0.76 m) CIRCLE. THE MINIMUM AREA AND DIMENSIONS SHALL BE MAINTAINED TO A POINT 70 INCHES (1.8m) ABOVE THE SHOWER DRAIN OUTLET. (CPC SEC. 410.4).
B. A MIN. 12" SQ. ACCESS PANEL TO THE BATHUB TRAP SLIP JOINT CONNECTION IS REQUIRED. (CPC SEC. 405.2).
BUILDING ENVELOPE:
GLAZING IN THE FOLLOWING LOCATIONS SHALL BE SAFETY GLAZING CONFORMING TO THE HUMAN IMPACT LOADS OF SECTION R308.3 (SEE EXCEPTIONS) (R308.4):
A. FIXED AND OPERABLE PANELS OF SWINGING, SLIDING AND BIFOLD DOOR ASSEMBLIES.
B. GLAZING IN INDIVIDUAL FIXED OR OPERABLE PANEL ADJACENT TO A DOOR WHERE THE NEAREST VERTICAL EDGE IS WITHIN A 24-INCH ARC OF THE DOOR IN A CLOSED POSITION AND WHOSE BOTTOM EDGE IS LESS THAN 60 INCHES ABOVE THE FLOOR OR WALKING SURFACE.
C. GLAZING IN AN INDIVIDUAL FIXED OR OPERABLE PANEL THAT MEETS ALL OF THE FOLLOWING CONDITIONS:
C.A. EXPOSED AREA OF AN INDIVIDUAL PANE GREATER THAN 9 SQUARE FEET.
C.B. BOTTOM EDGE LESS THAN 18 INCHES ABOVE THE FLOOR.
C.C. TOP EDGE GREATER THAN 36 INCHES ABOVE FLOOR.
C.D. ONE OR MORE WALKING SURFACE WITHIN 36 INCHES HORIZONTALLY OF THE GLAZING.
D. GLAZING IN GUARDS AND RAILINGS.
E. GLAZING IN ENCLOSURES FOR OR WALLS FACING HOT TUBS, WHIRLPools, SAUNAS, STEAM ROOMS, BATHUBS AND SHOWERS WHERE THE BOTTOM EDGE OF THE GLAZING IS LESS THAN 60 INCHES MEASURED VERTICALLY ABOVE ANY STANDING OR WALKING SURFACE.
F. GLAZING IN WALLS AND FENCES ADJACENT TO INDOOR OR OUTDOOR SWIMMING POOLS, HOT TUBS AND SPAS WHERE THE BOTTOM EDGE OF THE GLAZING IS LESS THAN 60 INCHES ABOVE A WALKING SURFACE AND WITHIN A 60 INCHES HORIZONTAL ARC IN A STRAIGHT LINE, OF THE WATER'S EDGE.
G. GLAZING WHERE THE BOTTOM EXPOSED EDGE OF THE GLAZING IS LESS THAN 36 INCHES ABOVE THE PLANE OF THE ADJACENT WALKING SURFACE OF STAIRWAYS, LANDINGS BETWEEN FLIGHTS OF STAIRS AND RAMPS.
H. GLAZING ADJACENT TO THE LANDING AT THE BOTTOM OF A STAIRWAY WHERE THE GLAZING IS LESS THAN 36 INCHES ABOVE THE LANDING AND WITHIN A 60 INCH HORIZONTAL ARC LESS THAN 180 DEGREES FROM THE BOTTOM TREAD NOSING (R304.2)
I. BUILDINGS SHALL HAVE APPROVED ADDRESS NUMBERS, BUILDING NUMBERS OR APPROVED BUILDING IDENTIFICATION PLACED IN A POSITION THAT IS PLAINLY LEGIBLE AND VISIBLE FROM THE STREET OR ROAD FRONTING THE PROPERTY. (R319.1)
J. PROTECTION OF WOOD AND WOOD BASED PRODUCT FROM DECAY SHALL BE PROVIDED IN THE LOCATIONS SPECIFIED PER SECTION R317.1 BY THE USE OF NATURALLY DURABLE WOOD OR WOOD THAT IS PRESERVATIVE-TREATED IN ACCORDANCE WITH AMPA U1 FOR THE SPECIES, PRODUCT, PRESERVATIVE AND END USE. PRESERVATIVES SHALL BE LISTED IN SECTION 4 OF AMPA U1.
K. PROVIDE ANTI-GRAFFITI FINISH WITHIN THE FIRST 9 FEET MEASURED FROM GRADE, AT EXTERIOR WALLS AND DOORS. EXCEPTION: MAINTENANCE OF BUILDING AFFIDAVIT IS RECORDED BY THE OWNER TO COVENANT AND AGREE WITH THE CITY OF LOS ANGELES TO REMOVE ANY GRAFFITI WITHIN 7-DAYS OF THE GRAFFITI BEING APPLIED. (6306)
SITE:
A. LOTS SHALL BE GRADED TO DRAIN SURFACE WATER AWAY FROM THE FOUNDATION WALLS WITH A MINIMUM FALL OF 6 INCHES WITHIN THE FIRST 10 FEET. (R401.3)

SMALL LOT SUBDIVISION NOTE:


FOR SMALL LOT SUBDIVISION PROJECTS, NO DEMOLITION, GRADING, BUILDING PERMIT OR CERTIFICATE OF OCCUPANCY SHALL BE ISSUED UNLESS THE DIRECTOR OF PLANNING HAS REVIEWED THE APPLICATION AND DETERMINED THAT THE SMALL LOT SUBDIVISION PROJECT COMPLES WITH THE CITY PLANNING COMMISSIONS SMALL LOT DESIGN STANDARDS PER LAMC 12.22 C27.6.2.

GENERAL NOTES:

- GENERAL NOTES:
A. ALL CONSTRUCTION SHALL COMPLY WITH THE 2022 EDITION OF THE CBC, CMC, CPC, AND CEC AS ADOPTED AND AMENDED BY THE STATE OF CALIFORNIA IN TITLE 24 CCR AND THIS JURISDICTION.
B. SEPARATE PERMITS MAY BE REQUIRED FOR MECHANICAL, ELECTRICAL, PLUMBING, SHORING, GRADING, DEMOLITION, RETAINING WALLS, SIGNS AND FIRE SPRINKLER SYSTEMS.
C. ALL PROPERTY LINES, EASEMENTS, AND EXISTING BUILDINGS HAVE BEEN INDICATED ON THE SITE PLAN.
D. A SECURITY FENCE SHALL BE PROVIDED AROUND THE CONSTRUCTION AREA THAT SHALL BE INSTALLED PRIOR TO EXCAVATION AND/OR FOUNDATION TRENCHING. (6MC 9-1-1-3302.3)
E. WATER SHALL BE PROVIDED ON THE SITE AND USED TO CONTROL DUST.
F. TEMPORARY TOILET FACILITIES SHALL BE PROVIDED ON SITE. (6MC 9-1-1-3305)
G. THE FINISH GRADE SHALL SLOPE A MIN. OF 5% OR 6", TO A POINT 10 FT FROM BUILDING FOUNDATION, OR TO AN APPROVED ALTERNATE METHOD OF DIVERTING WATER AWAY FROM THE FOUNDATION. SMOALES SHALL SLOPE A MINIMUM OF 2%. (CRC R401.3)
H. THE TOP OF THE EXTERIOR FOUNDATION SHALL EXTEND ABOVE THE ELEVATION OF THE STREET GUTTER A MINIMUM OF 12" PLUS 2% (CRC R403.1.7.3)
I. THE CONSTRUCTION SHALL NOT RESTRICT A FIVE-FOOT CLEAR AND UNOBSTRUCTED ACCESS TO ANY WATER OR POWER DISTRIBUTION FACILITIES (POWER POLES, PULL-BOXES, TRANSFORMERS, VALVES, PUMPS, VALVES, METERS, APPURTENANCES, ETC) OR TO THE LOCATION OF THE HOOR-UP. THE CONSTRUCTION SHALL NOT BE WITHIN TEN FEET OF ANY POWER LINES - WHETHER OR NOT THE LINES ARE LOCATED ON THE PROPERTY. FAILURE TO COMPLY MAY CAUSE CONSTRUCTION DELAYS AND/OR ADDITIONAL EXPENSES.
J. AN APPROVED SEISMIC GAS SHUTOFF VALVE WILL BE INSTALLED ON THE FUEL GAS LINE ON THE DOWN STREAM SIDE OF THE UTILITY METER AND BE RIGIDLY CONNECTED TO THE EXTERIOR OF THE BUILDING OR STRUCTURE CONTAINING THE FUEL GAS PIPING. (PER ORDINANCE 170158) SEPARATE PLUMBING PERMIT IS REQUIRED.
K. PLUMBING FIXTURES ARE REQUIRED TO BE CONNECTED TO A SANITARY SEWER OR TO AN APPROVED SEWAGE DISPOSAL SYSTEM. (R306.3)
L. KITCHEN SINKS, LAVATORIES, BATHUBS, SHOWERS, BIDES, LAUNDRY TUBS AND WASHING MACHINE OUTLETS SHALL BE PROVIDED WITH HOT AND COLD WATER AND CONNECTED TO AN APPROVED WATER SUPPLY. (R306.4)
M. BATHUBS AND SHOWER FLOORS, WALLS ABOVE BATHUBS WITH A SHOWERHEAD, AND SHOWER COMPARTMENTS SHALL BE FINISHED WITH A NONABSORBENT SURFACE. SUCH WALL SURFACES SHALL EXTEND TO A HEIGHT OF NOT LESS THAN 6 FEET ABOVE THE FLOOR. (R307.2)
N. PROVIDE ULTRA LOW FLUSH WATER CLOSETS FOR ALL NEW CONSTRUCTION. EXISTING SHOWER HEADS AND TOILETS MUST BE ADAPTED FOR LOW WATER CONSUMPTION.
O. UNIT SKYLIGHTS SHALL BE LABELED BY A LA CITY APPROVED LABELING AGENCY. USHC LABEL SHALL STATE THE APPROVED LABELING AGENCY NAME, PRODUCT DESIGNATION AND PERFORMANCE GRADE RATING. (RESEARCH REPORT NOT REQUIRED) R308.6.9.
P. PROVIDE 72 INCH HIGH NON-ABSORBENT WALL ADJACENT TO SHOWER AND APPROVED SHATTER-RESISTANT MATERIALS FOR SHOWER ENCLOSURE. (1210.2.3,2406.4.5,R307.2,R308.4)
Q. WATER HEATER MUST BE STRAPPED TO WALL (SEC. 507.3, LAPC).
R. AUTOMATIC GARAGE DOOR OPENERS, IF PROVIDED, SHALL BE INSTALLED IN ACCORDANCE WITH UL 325.
S. SMOKE DETECTORS SHALL BE PROVIDED FOR ALL DWELLING UNITS INTENDED FOR HUMAN OCCUPANCY, WHERE A PERMIT IS REQUIRED FOR ALTERATIONS, REPAIRS, OR ADDITIONS (R314.2)
T. WHERE A PERMIT IS REQUIRED FOR ALTERATIONS, REPAIRS OR ADDITIONS, EXISTING DWELLINGS SLEEPING UNITS THAT HAVE ATTACHED GARAGES OR FUEL-BURNING APPLIANCES SHALL BE PROVIDED WITH A CARBON MONOXIDE ALARM IN ACCORDANCE WITH SECTION R315.2. CARBON MONOXIDE ALARMS SHALL BE REQUIRED IN THE SPECIFIC DWELLING UNIT OR SLEEPING UNIT FOR WHICH THE PERMIT WAS OBTAINED. (R315.2)
U. EVERY SPACE INTENDED FOR HUMAN OCCUPANCY SHALL BE PROVIDED WITH NATURAL LIGHT BY MEANS OF EXTERIOR GLAZED OPENINGS IN ACCORDANCE WITH SECTION 303.1 OR SHALL BE PROVIDED WITH ARTIFICIAL LIGHT THAT IS ADEQUATE TO PROVIDE AN AVERAGE ILLUMINATION OF 6 FOOT-CANDLES OVER THE AREA OF THE ROOM AT A HEIGHT OF 30 INCHES ABOVE FLOOR LEVEL. (R303.1)
V. A COPY OF THE EVALUATION REPORT AND/OR CONDITIONS OF LISTING SHALL BE MADE AVAILABLE AT THE JOB SITE.
W. OBTAIN PERMITS FROM PUBLIC WORKS PRIOR TO CONSTRUCTION FOR:
W.A. TEMPORARY PEDESTRIAN PROTECTION AS REQUIRED BY LABC SECTION 303.7.
W.B. FOR ANY CONSTRUCTION NEAR ANY STREET OR PUBLIC AREA.
X. OUTLETS ALONG WALL COUNTER SPACE, ISLAND AND PENINSULA COUNTER SPACE IN KITCHENS SHALL HAVE A MAXIMUM SPACING OF 48". (210-52 NED).
Y. THE FIRST LIGHT IN NEW AND REMODELED BATHROOMS AND KITCHENS SHALL BE AN ENERGY EFFICIENT LIGHT MEETING A MINIMUM OF 40 LUMENS OR WATT (E.G. FLUORESCENT LAMP), (1-24, SEC. 130(b) & 150(X)).
Z. BUILDINGS SHALL HAVE APPROVED ADDRESS NUMBERS, BUILDING NUMBERS OR APPROVED BUILDING IDENTIFICATION PLACED IN A POSITION THAT IS PLAINLY LEGIBLE AND VISIBLE FROM THE STREET OR ROAD FRONTING THE PROPERTY. (R319)
AA. A COPY OF THE EVALUATION REPORT AND/OR CONDITIONS OF LISTING SHALL BE MADE AVAILABLE AT THE JOB SITE.
GARAGE:
A. DOORS BETWEEN GARAGE AND THE DWELLING UNIT SHALL BE SELF-CLOSING AND SELF-LATCHING, SOLID WOOD OR SOLID HONEYCOMB CORE STEEL, NOT LESS THAN 1-3/8" THICK, OR HAVE A MINIMUM FIRE PROTECTION RATING OF 20 MINUTES. (R302.5.1)
B. THE GARAGE SHALL BE SEPARATED FROM THE DWELLING AND ITS ATTIC AREA IN ACCORDANCE WITH TABLE R302.6. (R302.6)
C. DUCTS PENETRATING THE WALLS OR CEILINGS SEPARATING THE DWELLING FROM THE GARAGE SHALL BE CONSTRUCTED OF A MINIMUM OF NO. 26 GAGE SHEET STEEL OR OTHER APPROVED METRIC AND THERE SHALL BE NO OPENINGS FROM THE DUCTS INTO THE GARAGE. (R302.5.2)
D. OTHER PENETRATIONS OF GARAGE/DWELLING CEILINGS AD WALLS ARE TO BE PROTECTED AS REQUIRED BY SECTION R302.11, ITEM 4 (R302.5.3).
E. GARAGE FLOOR SURFACE SHALL BE OF AN APPROVED NONCOMBUSTIBLE MATERIAL, AND THE AREA USED TO PARK VEHICLES SHALL BE SLOPED TO A DRAIN OR TOWARDS THE MAIN VEHICLE ENTRY. (R 309.1)
MEANS OF EGRESS:
A. ENCLOSED ACCESSIBLE SPACE UNDER STAIRS SHALL HAVE WALLS, UNDER-STAIR SURFACE AND ANY SOFFITS PROTECTED ON THE ENCLOSED SIDE WITH 1/2 INCH GYPSUM BOARD. (R302.7)
B. ALL INTERIOR AN EXTERIOR STAIRWAYS SHALL BE ILLUMINATED. (R303.6)
C. PROVIDE 32" WIDE DOORS TO ALL INTERIOR ACCESSIBLE ROOMS WITHIN A DWELLING UNIT.
D. PROVIDE EMERGENCY EGRESS FROM SLEEPING ROOMS AND BASEMENTS. MIN. - 24" CLEAR HT, 20" CLEAR WIDTH, 5.7 SQ. FT. MIN. AREA.
INTERIOR ENVIRONMENT:
A. BATHROOMS, WATER COLSET COMPARTMENTS AND OTHER SIMILAR ROOMS SHALL BE PROVIDED NATURAL VENTILATION OR WITH MECHANICAL VENTILATION CAPABLE OF 50 CFM EXHAUSTED DIRECTLY TO THE OUTSIDE. (R303.3)
B. HEATER SHALL BE CAPABLE OF MAINTAINING A MINIMUM ROOM TEMPERATURE OF 60° F AT A POINT 3 FEET ABOVE THE FLOOR AND 2 FEET FROM EXTERIOR WALLS IN ALL HABITABLE ROOMS AT THE DESIGN TEMPERATURE. (R303.8)
FIRE-RESISTANT RATED CONSTRUCTION:
A. IN COMBUSTIBLE CONSTRUCTION, FIRE BLOCKING SHALL BE PROVIDED TO CUT OFF ALL CONCEALED DRAFT OPENINGS (BOTH VERTICAL AND HORIZONTAL) AND TO FORM AN EFFECTIVE FIRE BARRIER BETWEEN STORIES, BETWEEN A TOP STORY AND THE ROOF SPACE. (R302.11).
B. IN COMBUSTIBLE CONSTRUCTION WHERE THERE IS USABLE SPACE BOTH ABOVE AND BELOW THE CONCEALED SPACE OF A FLOOR/CEILING ASSEMBLY, DRAFTSTOPS SHALL BE INSTALLED SO THAT THE AREA OF THE CONCEALED SPACE DOES NOT EXCEED 1,000 SQUARE FEET. DRAFTSTOPPING SHALL DIVIDE THE CONCEALED SPACE INTO APPROXIMATELY EQUAL AREAS. (R302.12)
C. FIRE BLOCKING MUST BE PROVIDED IN ACCORDANCE WITH SECTION 717 AT THE FOLLOWING LOCATIONS:
C.A. IN CONCEALED SPACES OF STUD WALLS AND PARTITIONS, INCLUDING FURRED SPACES, AT THE CEILING AND FLOOR LEVELS.
C.B. IN CONCEALED SPACES OF STUD WALLS AND PARTITIONS, INCLUDING FURRED SPACES, AT 10-FOOT INTERVALS ALONG THE LENGTH OF THE WALL.
C.C. AT ALL INTERCONNECTIONS BETWEEN CONCEALED VERTICAL AND HORIZONTAL SPACES SUCH AS OCCUR AT SOFFITS, DROP CEILINGS AND COVE CEILINGS.
C.D. IN CONCEALED SPACES BETWEEN STAIR STRINGERS AT THE TOP AND BOTTOM OF THE RUN AND BETWEEN STUDS ALONG AND IN LINE WITH THE RUN OF STAIRS IF THE WALL UNDER THE STAIRS IS UNFINISHED.
C.E. IN OPENINGS AROUND VENTS, PIPES, DUCTS, CHIMNEYS, FIREPLACES AND SIMILAR OPENINGS WHICH AFFORD A PASSAGE FOR FIRE AT CEILING AND FLOOR LEVELS, WITH NONCOMBUSTIBLE MATERIALS.

PROJECT TEAM:

ARMENARC
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PROPERTY OWNER:
NERSES VARIJANYAN
7665 MACHREA ST.
LOS ANGELES, CA 91042
(818) 406-1935
NERO-Y@INBOX.RU

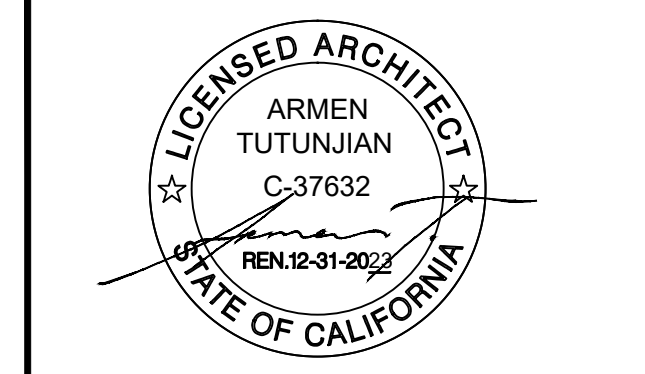CIVIL ENGINEER:
TLC TECHNICAL LAND CO. INC
HAYK MARTIROSIAN
1545 N. VERDUGO RD. #2
GLENDALE, CA 91208
(818) 547-0543
HAYK@TECHNICALAND.COM

PROJECT TITLE:
MACHREA
7 SMALL LOT SFR

PROJECT ADDRESS:
7665 MACHREA ST.
LOS ANGELES, CA 91042

Table with 2 columns: NO. and ISSUED FOR.

JOB NO.: 20034
DRAWN BY: A.T.
CHECKED BY: A.T.
DATE: 07-13-23

SHEET DESCRIPTION:
PROJECT NOTES / FORMS

SHEET NUMBER:

G-201






















SOUTH ELEVATION

SCALE: 1/4"=1'-0" 1

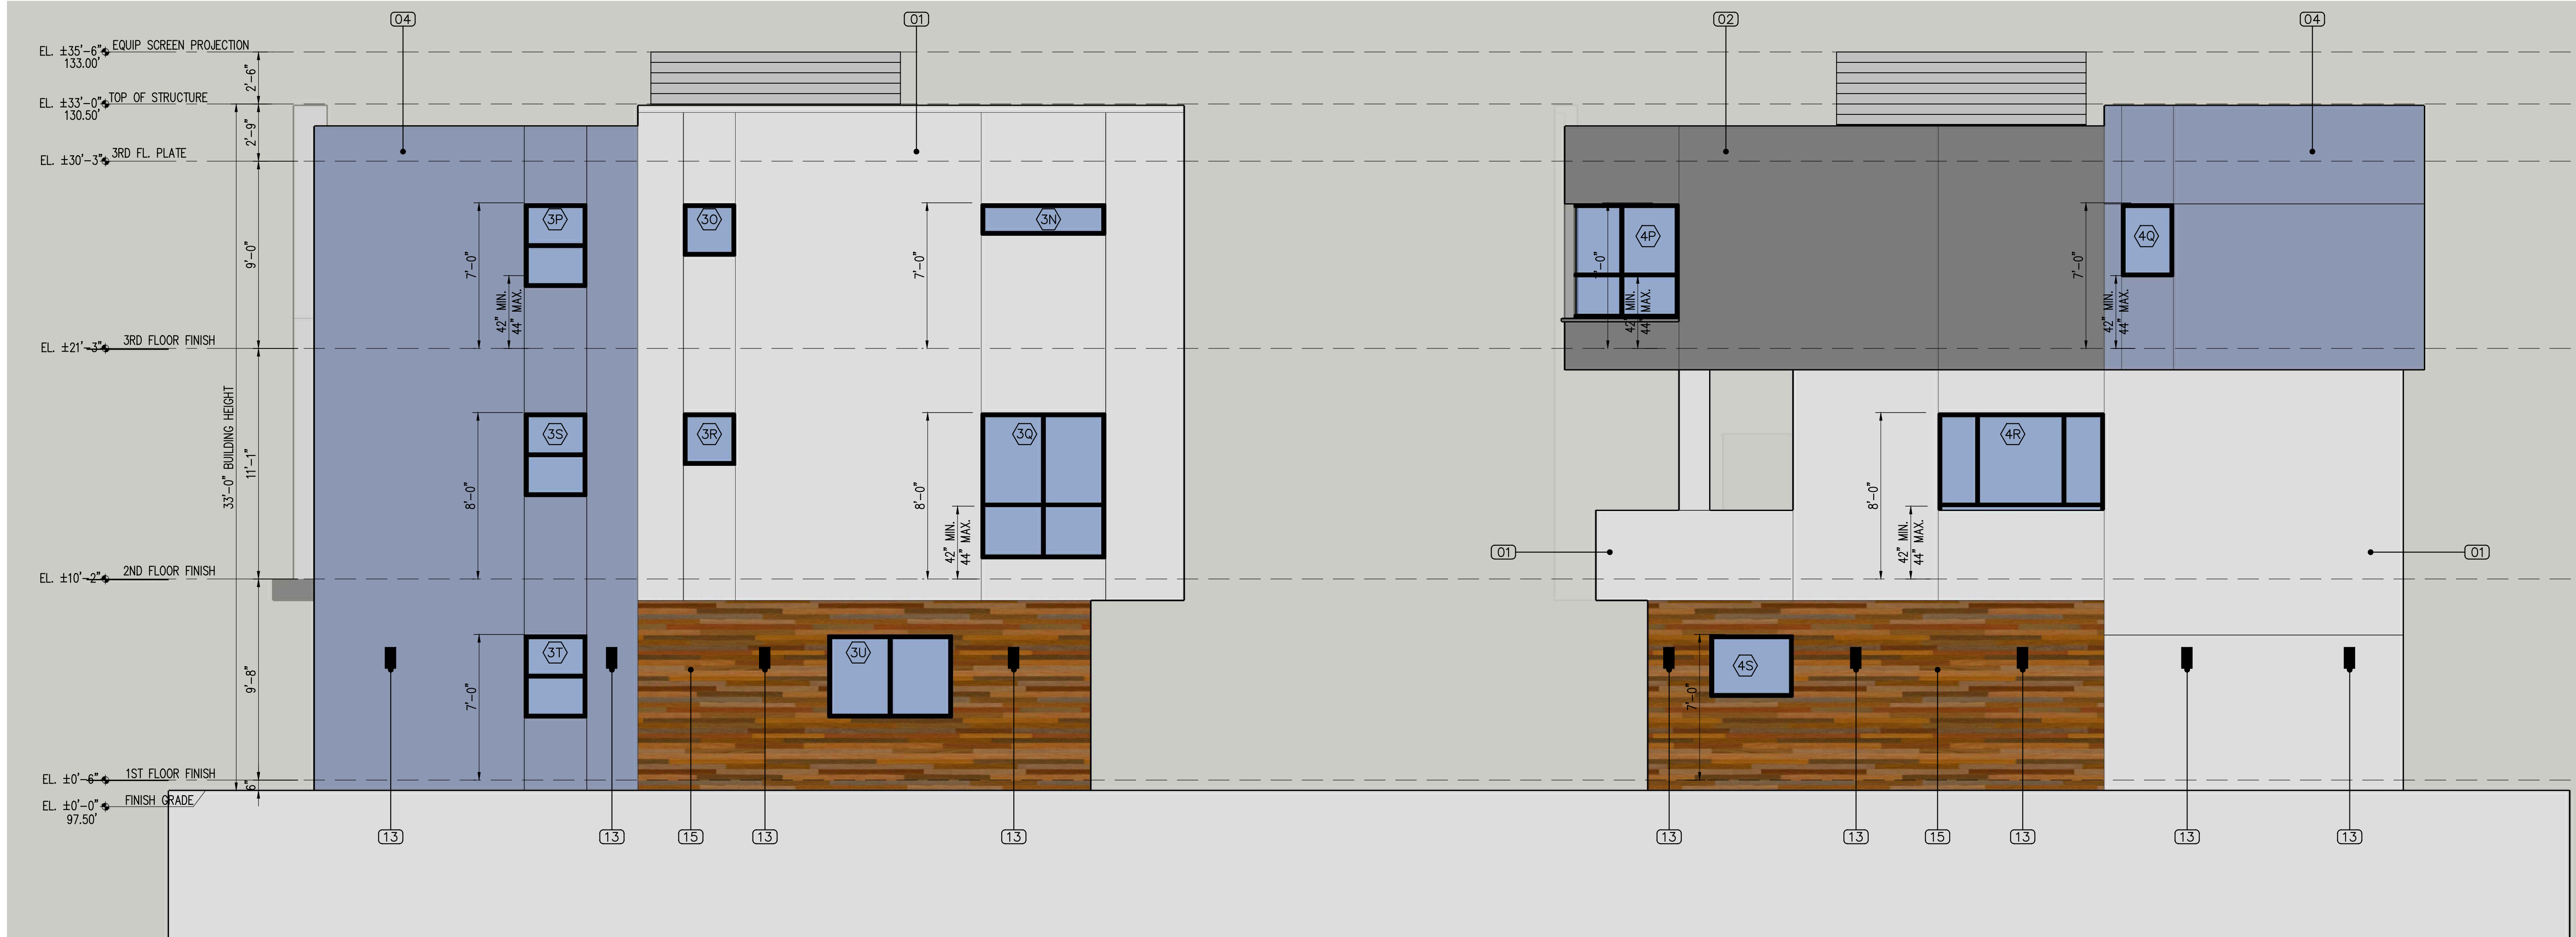

NORTH ELEVATION

SCALE: 1/4"=1'-0" 2

**NOTES:**  
 HEIGHT MEASURED FROM GRADE, AS DEFINED PER DEFINITIONS 12.03. SEE BELOW.  
 GRADE (ADJACENT GROUND LEVEL), IS THE LOWEST POINT OF ELEVATION OF THE FINISHED SURFACE OF THE GROUND, PAVING OR SIDEWALK WITHIN THE AREA BETWEEN THE BUILDING AND THE PROPERTY LINE, OR WHEN THE PROPERTY LINE IS MORE THAN 5 FEET FROM THE BUILDING, BETWEEN THE BUILDING AND A LINE 5 FEET FROM THE BUILDING. THIS DEFINITION DOES NOT APPLY TO ANY BUILDING OR STRUCTURE LOCATED WITHIN THE BOUNDARIES OF THE CENTURY CITY NORTH OR CENTURY CITY SOUTH SPECIFIC PLANS AND WHICH IS SUBJECT TO SECTION 12.21.2 OF THIS CODE. (AMENDED BY ORD. NO. 160657, EFF. 2/17/86, OPER. 6/17/86.)

**EXTERIOR FINISH SCHEDULE:**

TAG	MATERIAL	COLOR	MANF. / SUPPLIER
13	SUM 12 DOWNLIGHT	BLACK	RAB LIGHTING OR EQ.
14	ALUMINUM REVERSE CHANNEL ADDRESS NUMBERS	BLACK	TBD
15	COMPOSITE PANEL WITH WOOD FINISH	TIMBER SERIES, TEAK	APOLIC OR EQUAL
16	CORRUGATED METAL EQUIPMENT SCREEN	GREY	ATAS INT. OR EQ.


**EXTERIOR FINISH SCHEDULE:**

TAG	MATERIAL	COLOR	MANF. / SUPPLIER
07	SMOOTH EXTERIOR PLASTER	TURQUOISE	LA HABRA OR EQUAL
08	SMOOTH EXTERIOR PLASTER	BLUE	LA HABRA OR EQUAL
09	SMOOTH EXTERIOR PLASTER	ORANGE	LA HABRA OR EQUAL
10	SMOOTH EXTERIOR PLASTER	RED	LA HABRA OR EQUAL
11	SMOOTH EXTERIOR PLASTER	MAGENTA	LA HABRA OR EQUAL
12	SMOOTH EXTERIOR PLASTER	BLACK	LA HABRA OR EQUAL

**EXTERIOR FINISH SCHEDULE:**

TAG	MATERIAL	COLOR	MANF. / SUPPLIER
01	SMOOTH EXTERIOR PLASTER	WHITE	LA HABRA OR EQUAL
02	SMOOTH EXTERIOR PLASTER	COAL MINER DET613	LA HABRA OR EQUAL
03	SMOOTH EXTERIOR PLASTER	DARK GREY CHARCOAL	LA HABRA OR EQUAL
04	SMOOTH EXTERIOR PLASTER	JADED CLOUDS DE5703	LA HABRA OR EQUAL
05	SMOOTH EXTERIOR PLASTER	YELLOW	LA HABRA OR EQUAL
06	SMOOTH EXTERIOR PLASTER	GREEN	LA HABRA OR EQUAL

PROJECT TEAM:  
**ARMENARC**  
 1812 W. BURBANK BLVD #148  
 BURBANK, CA 91506  
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 HAYK MARTIROSIAN  
 1545 N. VERDUGO RD. #2  
 GLENDALE, CA 91208  
 (818) 547-0543  
 HAYK@TECHNALAND.COM

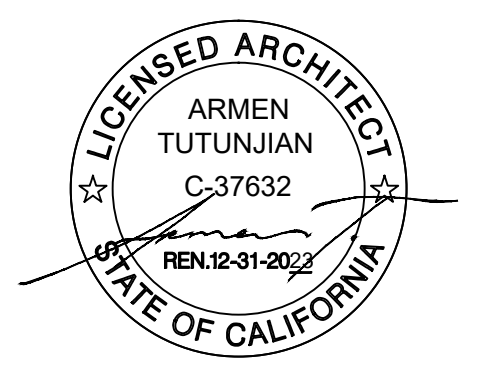PROJECT TITLE:  
**MACHREA  
 7 SMALL LOT SFR**

PROJECT ADDRESS:  
 7865 MACHREA ST.  
 LOS ANGELES, CA 91042

NO.	ISSUED FOR:

JOB NO.: 20034  
 DRAWN BY: A.T.  
 CHECKED BY: A.T.  
 DATE: 07-13-23

SHEET DESCRIPTION:  
**ELEVATIONS**


SHEET NUMBER:  
**A-201**





EAST ELEVATION #1 (UNITS 1,2,3)

SCALE:  
1/4"=1'-0" 1

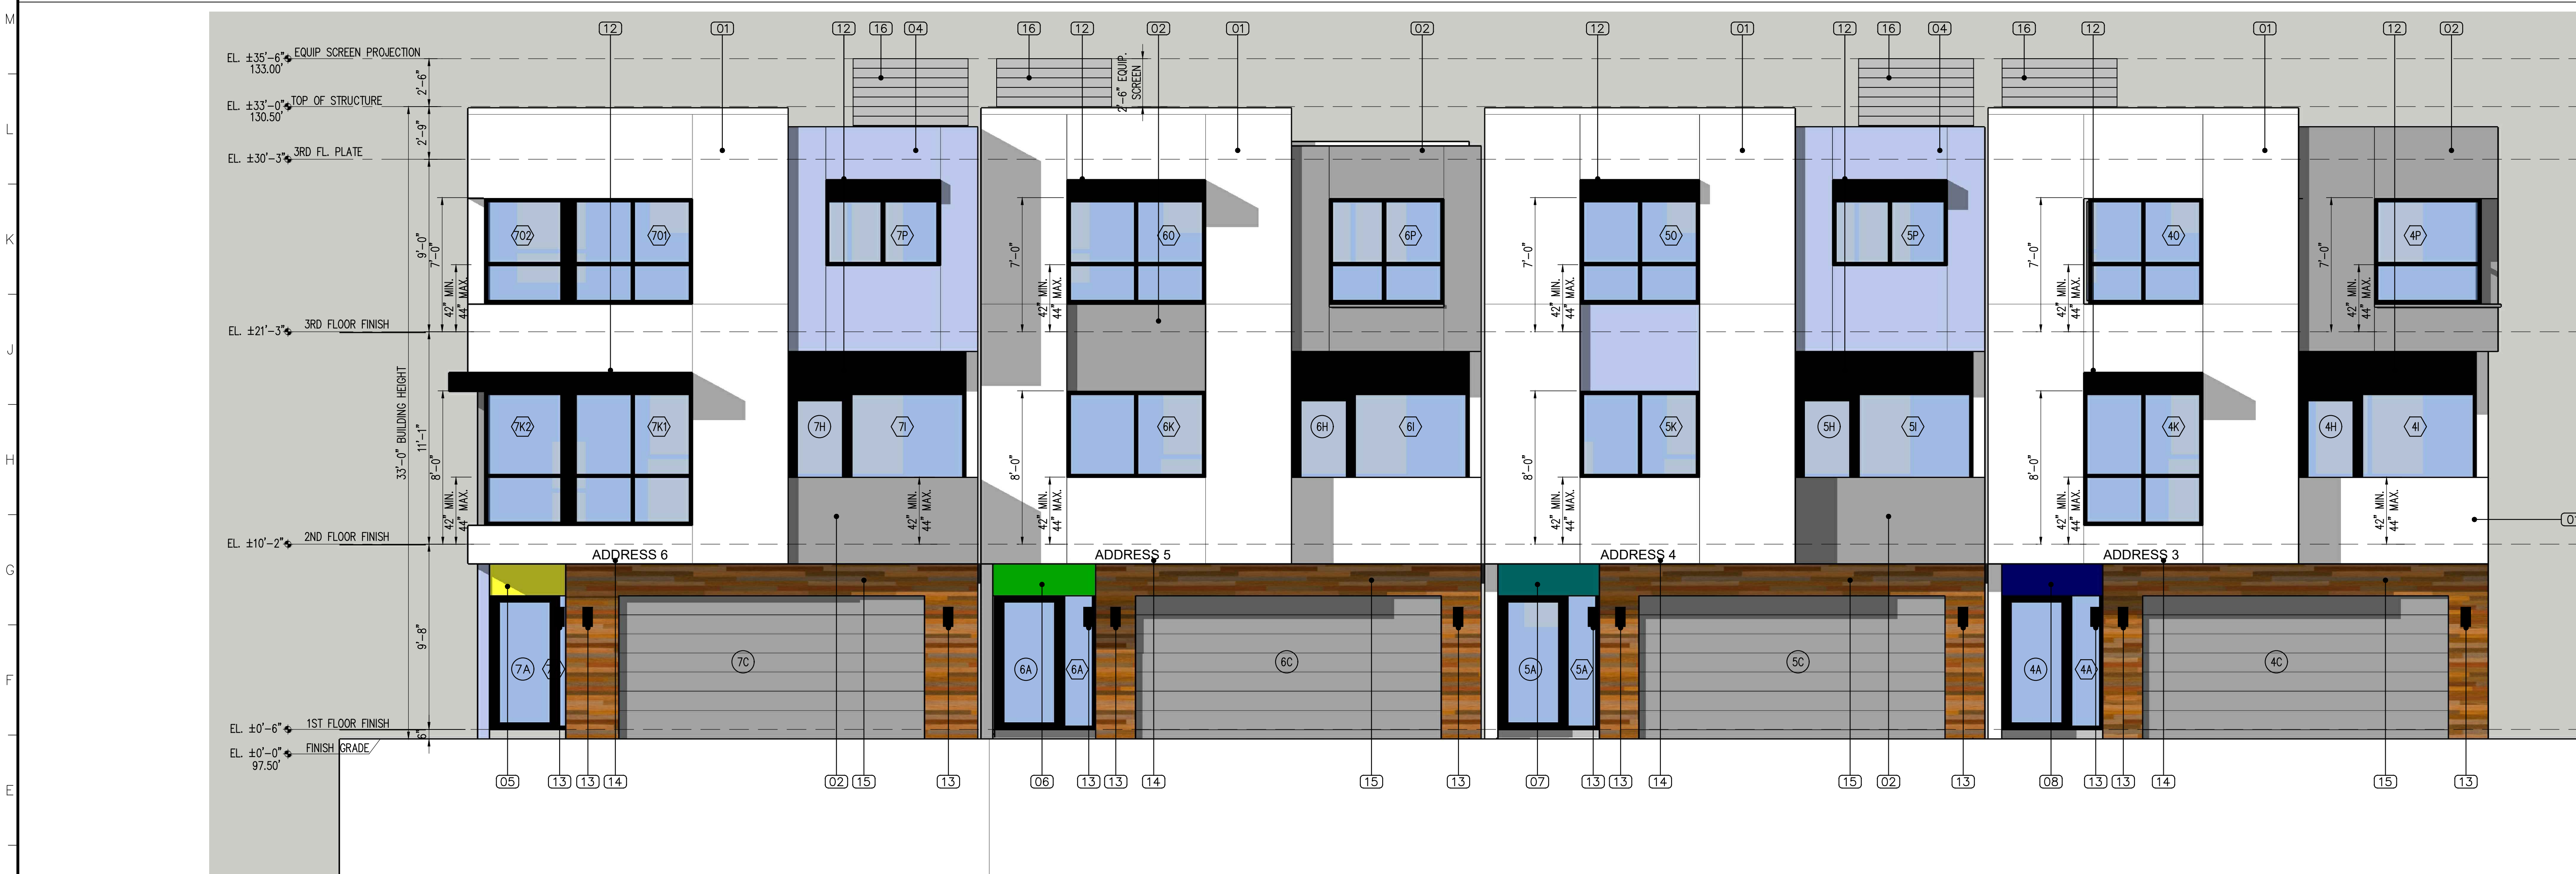

EAST ELEVATION #2 (UNITS 7,6,5,4)

SCALE:  
1/4"=1'-0" 2

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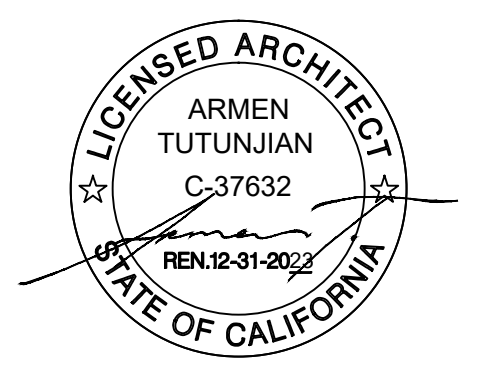
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05	SMOOTH EXTERIOR PLASTER	YELLOW	LA HABRA OR EQUAL
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PROJECT TITLE:  
**MACHREA  
7 SMALL LOT SFR**

PROJECT ADDRESS:  
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LOS ANGELES, CA 91042

NO.	ISSUED FOR:

JOB NO.: 20034  
DRAWN BY: A.T.  
CHECKED BY: A.T.  
DATE: 07-13-23

SHEET DESCRIPTION:  
ELEVATIONS

SHEET NUMBER:  
**A-202**





WEST ELEVATION #1 (UNITS 4,5,6,7)

SCALE: 1/4"=1'-0" 1



WEST ELEVATION #2 (UNITS 3,2,1)

SCALE: 1/4"=1'-0" 2

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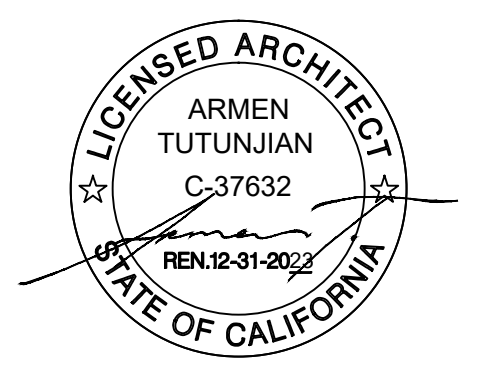
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 7 SMALL LOT SFR**

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 LOS ANGELES, CA 91042

NO.	ISSUED FOR:

JOB NO.: 20034  
 DRAWN BY: A.T.  
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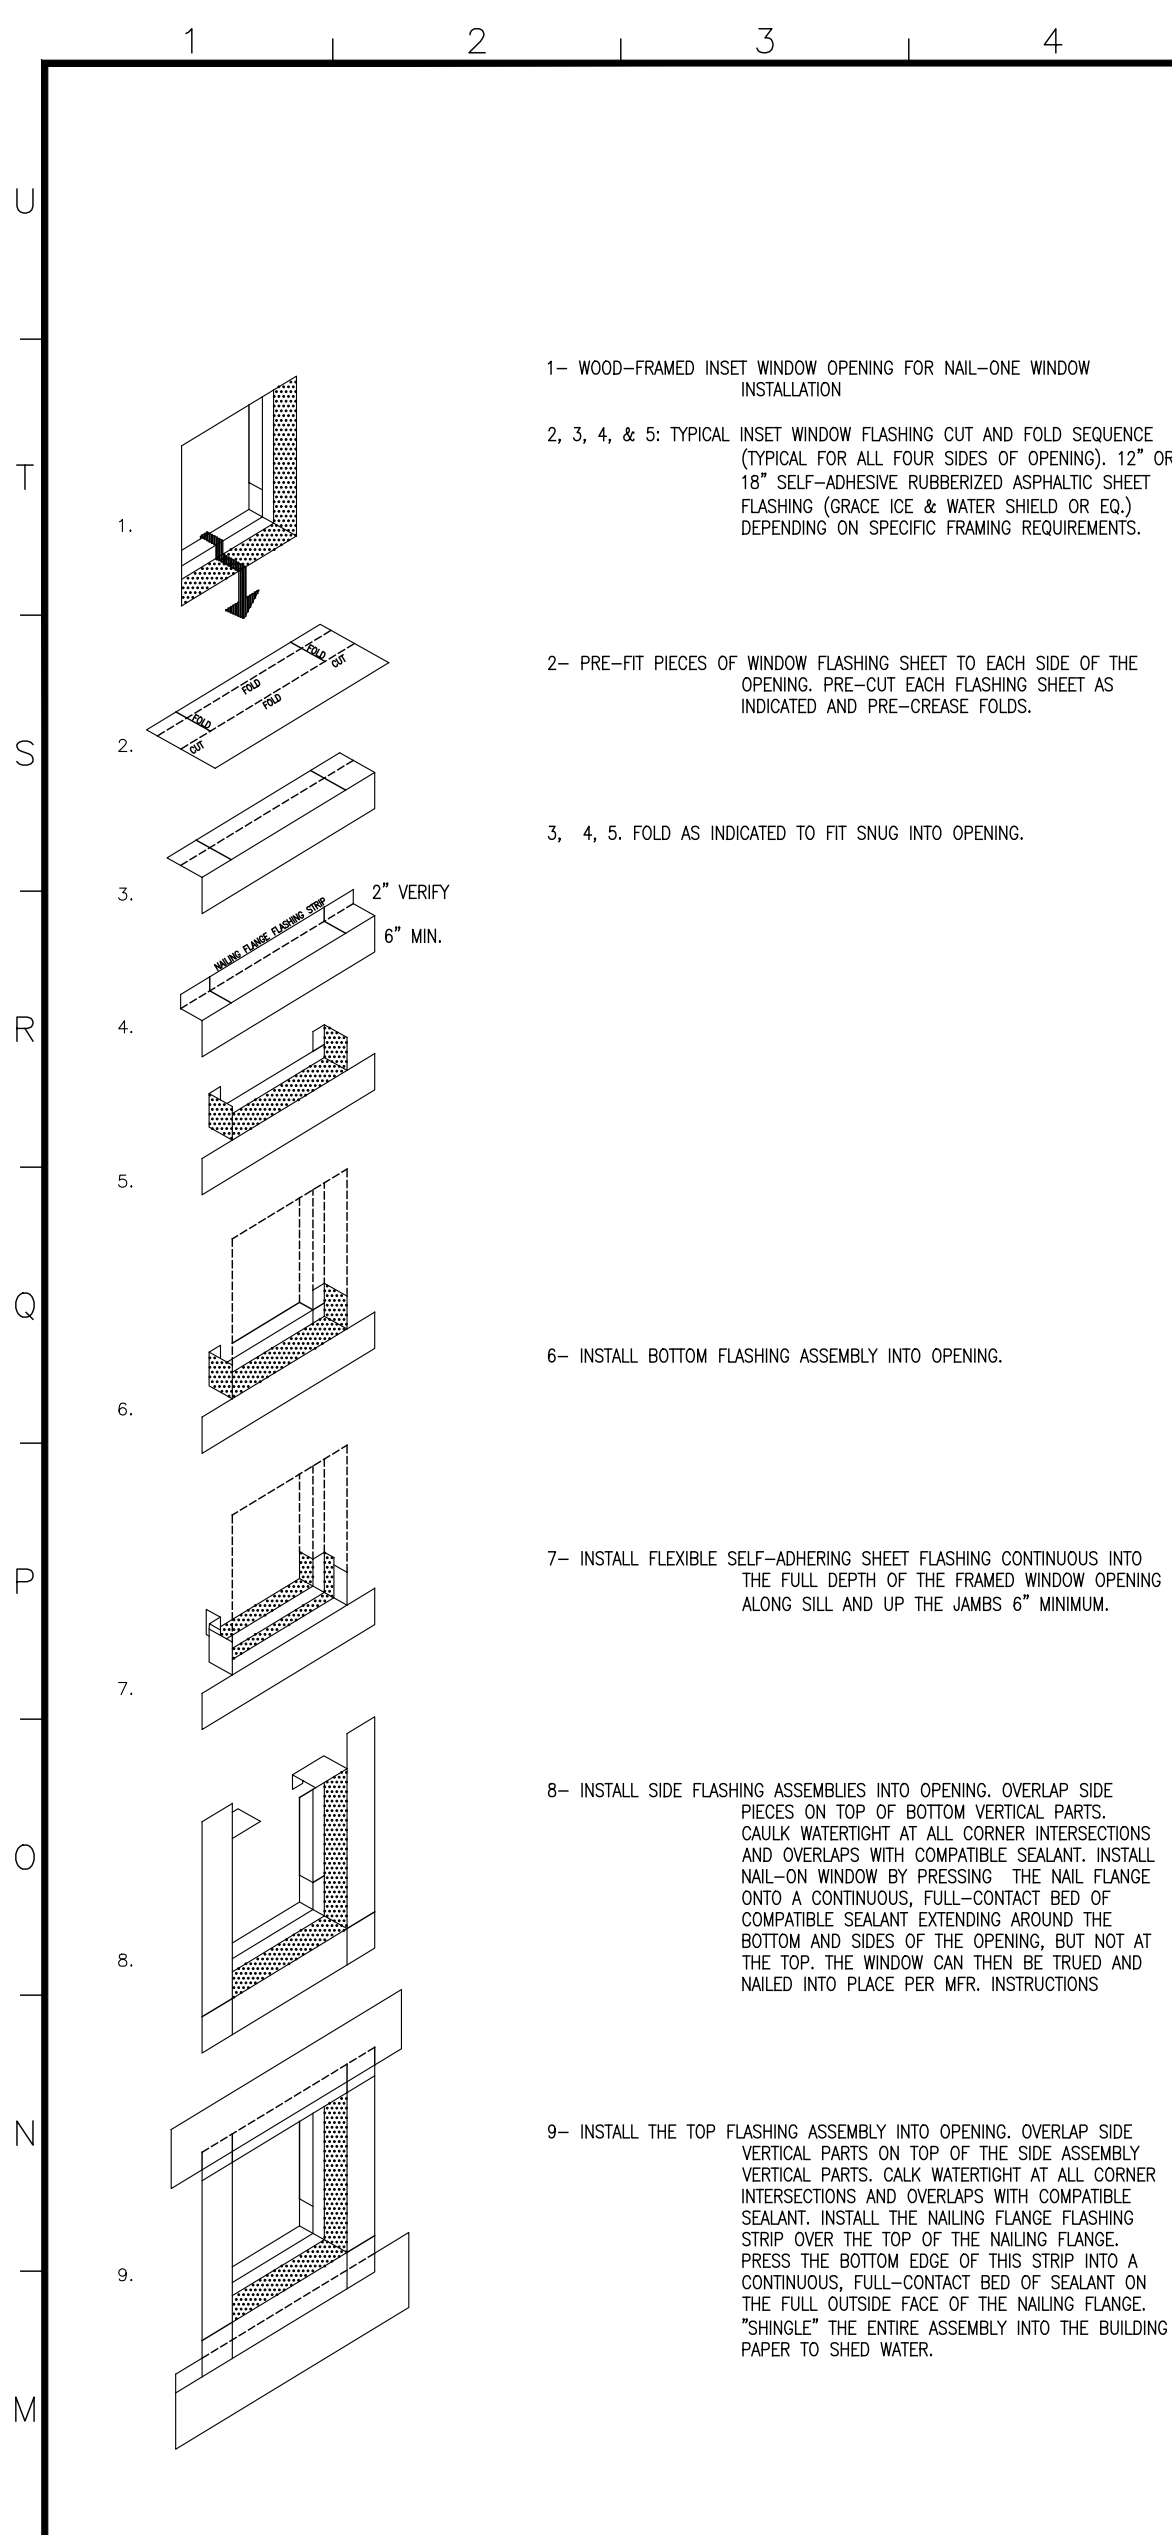
SHEET DESCRIPTION:  
**ELEVATIONS**

SHEET NUMBER:  
**A-203**













NOTE: CAULK AND SEAL ALL PUNCTURES WITH FLUID APPLIED FLASHING FOR MANUFACTURE WINDOW FLASHING ASSEMBLY MANUFACTURE TO MATCH HOUSE WATERPROOFING MANUFACTURE. DO NOT MIX AND MATCH DIFFERENT MANUFACTURES. REFER TO MANUFACTURE SPECIFICATION & DETAILS FOR MORE INFORMATION. IF ASSEMBLY CHANGES CONTRACTOR TO NOTIFY ARCHITECT.

RECESSED WINDOW FLASHING DETAIL SCALE: N.T.S. 2

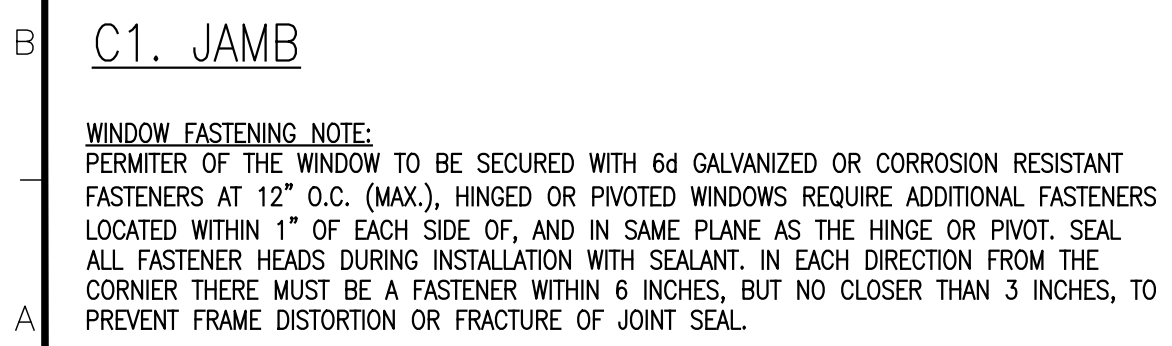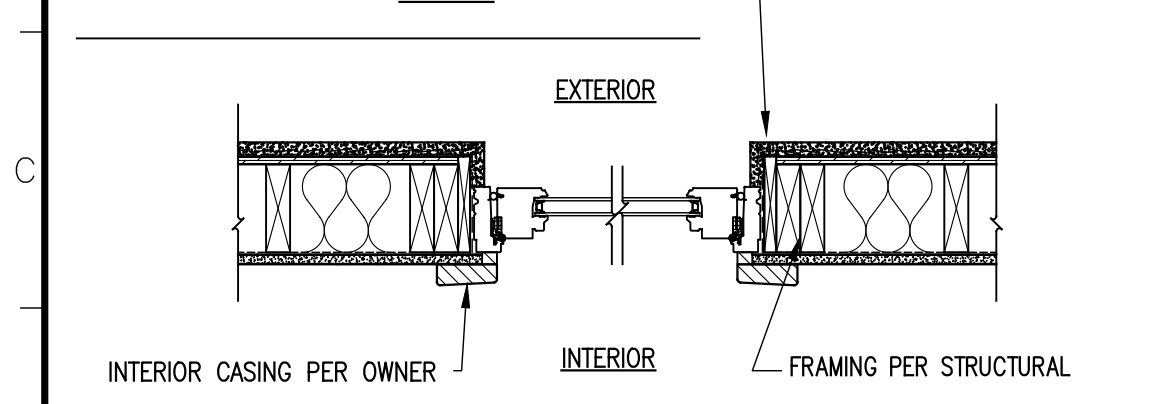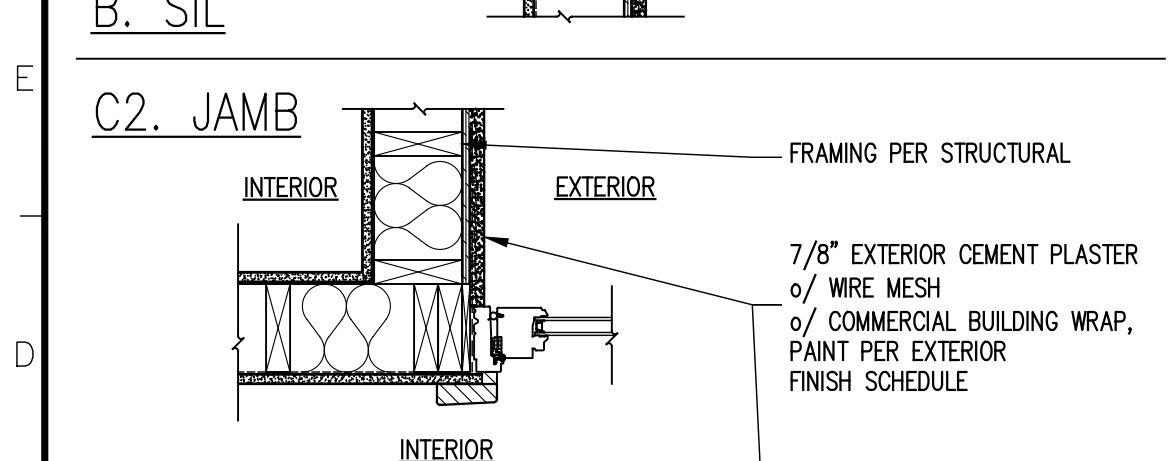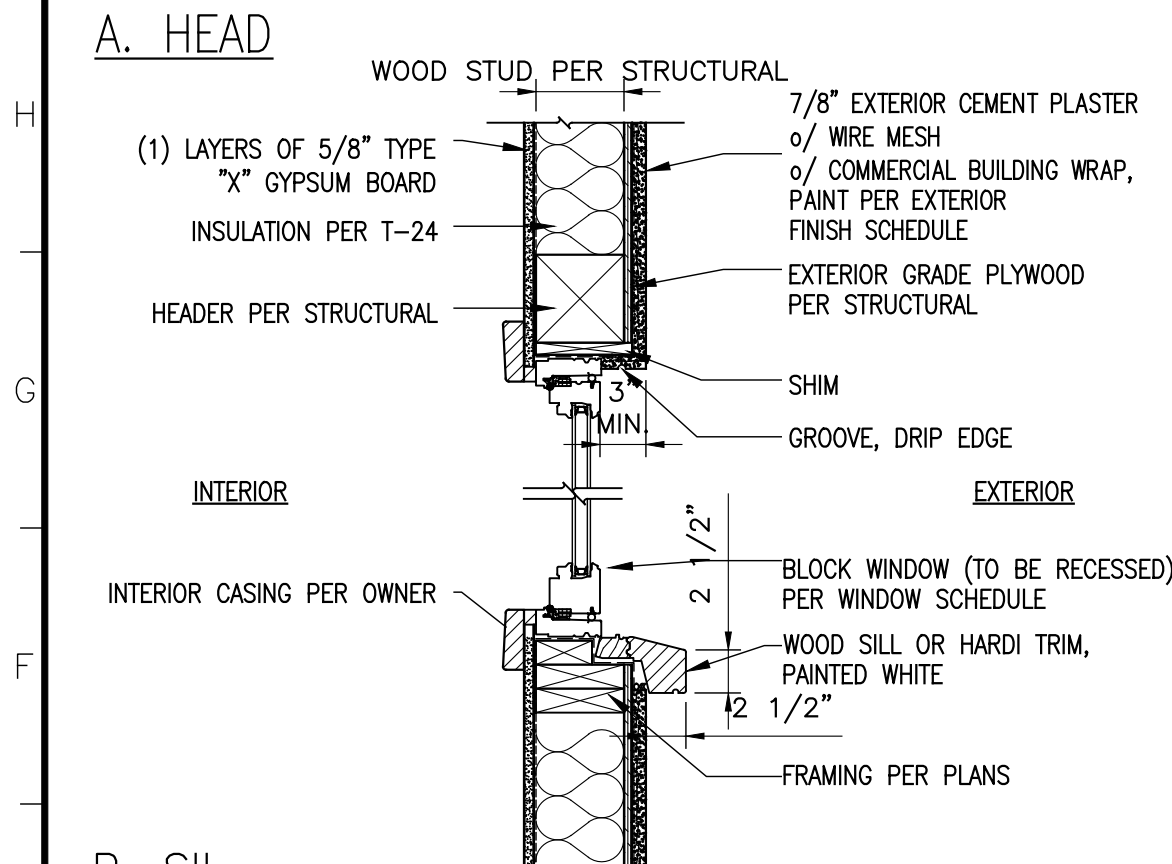

WINDOW FASTENING NOTE: PERMITTER OF THE WINDOW TO BE SECURED WITH 6d GALVANIZED OR CORROSION RESISTANT FASTENERS AT 12" O.C. (MAX.), HINGED OR PIVOTED WINDOWS REQUIRE ADDITIONAL FASTENERS LOCATED WITHIN 1" OF EACH SIDE OF, AND IN SAME PLANE AS THE HINGE OR PIVOT. SEAL ALL FASTENER HEADS DURING INSTALLATION WITH SEALANT. IN EACH DIRECTION FROM THE CORNER THERE MUST BE A FASTENER WITHIN 6 INCHES, BUT NO CLOSER THAN 3 INCHES, TO PREVENT FRAME DISTORTION OR FRACTURE OF JOINT SEAL.

WINDOW HEAD, SIL, JAMB @ STUCCO DETAILS SCALE: 1"=1'-0" 1

WINDOW SCHEDULE:

SYM.	SIZE		GLASS	TYPE	MATERIAL	FRAME	SHGC	U Factor	REMARKS
	WIDTH	HEIGHT							
(1A)	4'-0"	4'-6"	DUAL	FIXED	FIBERGLASS	BLOCK	PER T24	PER T24	#1
(1B)	10"	7'-0"	DUAL	FIXED	FIBERGLASS	.	PERT T24	PER T24	
(1C)	5'-0"	5'-0"	DUAL	SLIDER	FIBERGLASS	.	PERT T24	PER T24	
(1D)	6'-0"	4'-6"	DUAL	SLIDER/FIX	FIBERGLASS	.	PERT T24	PER T24	
(1E)	6'-0"	7'-0"	DUAL	SLIDER/FIX	FIBERGLASS	.	PERT T24	PER T24	
(1F)	3'-4"	4'-0"	DUAL	FIXED	FIBERGLASS	.	PERT T24	PER T24	
(1G)	3'-0"	8'-0"	DUAL	FIXED	FIBERGLASS	.	PERT T24	PER T24	
(1H)	6'-0"	1'-6"	DUAL	FIXED	FIBERGLASS	.	PERT T24	PER T24	
(1I)	6'-0"	5'-6"	DUAL	SLIDER/FIX	FIBERGLASS	.	PERT T24	PER T24	
(1J)	4'-6"	3'-5"	DUAL	SLIDER/FIX	FIBERGLASS	.	PERT T24	PER T24	
(1K)	7'-0"	5'-6"	DUAL	SLIDER/FIX	FIBERGLASS	.	PERT T24	PER T24	
(1L)	2'-0"	3'-0"	DUAL	CASEMENT	FIBERGLASS	.	PERT T24	PER T24	
(1M)	7'-0"	5'-6"	DUAL	SLIDER/FIX	FIBERGLASS	.	PERT T24	PER T24	
(1N)	6'-0"	1'-6"	DUAL	FIXED	FIBERGLASS	.	PERT T24	PER T24	
(1O)	10'-6"	6'-0"	DUAL	FIXED/CASEMENT	FIBERGLASS	.	PERT T24	PER T24	
(1P)	6'-0"	4'-6"	DUAL	SLIDER	FIBERGLASS	.	PERT T24	PER T24	
(1Q)	6'-0"	5'-6"	DUAL	FIXED/SLIDER	FIBERGLASS	.	PERT T24	PER T24	
(1R)	3'-0"	3'-6"	DUAL	SINGLE HUNG	FIBERGLASS	.	PERT T24	PER T24	
(1S)	6'-0"	4'-0"	DUAL	SLIDER	FIBERGLASS	.	PERT T24	PER T24	
(1T)	2'-6"	2'-6"	DUAL	CASEMENT	FIBERGLASS	.	PERT T24	PER T24	

DOOR SCHEDULE:


SYM.	SIZE		THICKNESS	TYPE	MATERIAL	FRAME	SHGC	U Factor	GLASS	FIRE RATING	(SEE REMARK NOTES BELOW)
	WIDTH	HEIGHT									
(2A)	3'-0"	7'-0"	1-3/4"	SWING	WOOD	WOOD	-	-	-	N/A	EXTERIOR
(2B)	2'-8"	7'-0"	1-3/4"	SWING	WOOD	-	-	-	-	N/A	INTERIOR, SEE NOTE #2, 1 HR RATED
(2C)	16'-0"	8'-0"	1-3/4"	ROLL UP	ALUMINUM	ALUMINUM	-	-	-	N/A	-
(2D)	3'-6"	7'-0"	1-3/4"	BI-FOLD	WOOD	-	-	-	-	N/A	INTERIOR
(2E)	3'-0"	7'-0"	1-3/4"	SWING	WOOD	-	-	-	-	N/A	INTERIOR, SEE NOTE #2
(2F)	2'-8"	7'-0"	1-3/4"	SWING	WOOD	-	-	-	-	N/A	INTERIOR, SEE NOTE #2
(2G)	3'-0"	8'-0"	1-3/4"	SWING	ALUMINUM	ALUMINUM	-	-	-	N/A	W/ 4'-2" FIXED WINDOW EACH SIDE

SCHEDULE NOTES:

- EMERGENCY ESCAPE / EXIT WINDOW MUST MEET FOLLOWING REQUIREMENTS:
  - 20" MIN. CLEAR WIDTH
  - 24" MIN. CLEAR HEIGHT
  - 5.7 S.F. MIN. OPENABLE AREA
- THE FOLLOWING LOCATIONS SHALL BE SAFETY GLAZING CONFORMING TO THE HUMAN IMPACT LOADS OF SECTION R308.3 (CRC R308.4):
  - FIXED AND OPERABLE PANELS OF SWINGING, SLIDING AND BI-FOLDING DOOR ASSEMBLIES.
  - GLAZING IN AN INDIVIDUAL FIXED OR OPERABLE PANEL ADJACENT TO A DOOR WHERE THE NEAREST VERTICAL EDGE IS WITHIN A 24-INCHES ARC OF EITHER VERTICAL EDGE OF THE DOOR IN A CLOSED POSITION AND WHOSE BOTTOM EDGE IS LESS THAN 60 INCHES ABOVE THE FLOOR OR WALKING SURFACE.
  - GLAZING IN AN INDIVIDUAL FIXED OR OPERABLE PANEL THAT MEETS ALL OF THE FOLLOWING CONDITIONS:
    - EXPOSED AREA OF AN INDIVIDUAL PANE GREATER THAN 9 SQUARE FEET.
    - BOTTOM EDGE LESS THAN 18 INCHES ABOVE FLOOR.
    - TOP EDGE GREATER THAN 36 INCHES ABOVE FLOOR.
    - ONE OR MORE WALKING SURFACES WITHIN 36 INCHES HORIZONTALLY OF THE GLAZING.
  - GLAZING IN RAILINGS.
  - GLAZING IN ENCLOSURES FOR OR WALLS FACING HOT TUBS, WHIRLPOOLS, SAUNAS, STEAM ROOMS, BATHTUBS AND SHOWERS WHERE THE BOTTOM EDGE OF GLAZING IS LESS THAN 60" MEASURED VERTICALLY ABOVE ANY STANDING OR WALKING SURFACE.
  - GLAZING IN WALLS AND FENCES ADJACENT TO INDOOR AND OUTDOOR SWIMMING POOLS, HOT TUBS AND SPAS WHERE THE BOTTOM EDGE OF THE GLAZING IS LESS THAN 60 INCHES ABOVE A WALKING SURFACE AND WITHIN 60 INCHES, MEASURED HORIZONTALLY AND IN A STRAIGHT LINE, OF THE WATER'S EDGE.
  - GLAZING WHERE THE BOTTOM EXPOSED EDGE IF THE GLAZING IS LESS THAN 36 INCHES ABOVE THE PLANE OF THE ADJACENT WALKING SURFACE OF STAIRWAYS, LANDINGS BETWEEN FLIGHTS OF STAIRS OR RAMPS.
  - GLAZING ADJACENT TO THE LANDING AT THE BOTTOM OF A STAIRWAY WHERE THE GLAZING IS LESS THAN 36 INCHES ABOVE THE LANDING AND WITHIN 60 INCHES HORIZONTALLY OF THE BOTTOM TREAD.
- THE NFRC TEMPORARY LABEL DISPLAYED ON WINDOWS AND SKYLIGHTS (INCL. TUBULAR) MUST REMAIN ON THE UNIT UNTIL FINAL INSPECTION HAS BEEN COMPLETED.
- ALL WINDOWS AND GLAZED DOORS SHALL BE DUAL GLAZED INSULATED-GLASS UNITS WITH A MINIMUM OF ONE TEMPERED PANE.
- GARAGE DOORS TO BE TESTED IN ACCORDANCE TO WITH EITHER ASTM E 330 OR ANSI/DASMA 108, AND SHALL MEET THE ACCEPTANCE CRITERIA OF ANSI/DASMA 108.
- THE SIZES GIVEN ARE FOR FINISH OPENINGS.
- MANUFACTURE SHALL VISIT SITE AND FIELD VERIFY ALL ROUGH OPENING SIZES PRIOR TO SUBMITTING ORDER. SUBMIT FOR ARCHITECTS REVIEW.
- FIRE HAZARD-SPERDLY ZONE REQUIREMENT (MNC 9-1-1-2014.1.1) EXTERIOR WINDOWS, WINDOW WALLS AND GLAZED DOORS, WINDOWS WITHIN EXTERIOR DOORS, AND SKYLIGHTS SHALL BE TEMPERED GLASS, MULTI-LAYERED GLASS PANELS, GLASS BLOCK, OR HAVE A FIRE PROTECTION RATING OF NOT LESS THAN 20 MINUTES.

PROJECT TEAM:

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**PROPERTY OWNER:**  
NERSES YARIJANYAN  
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NERO-Y@INBOX.RU
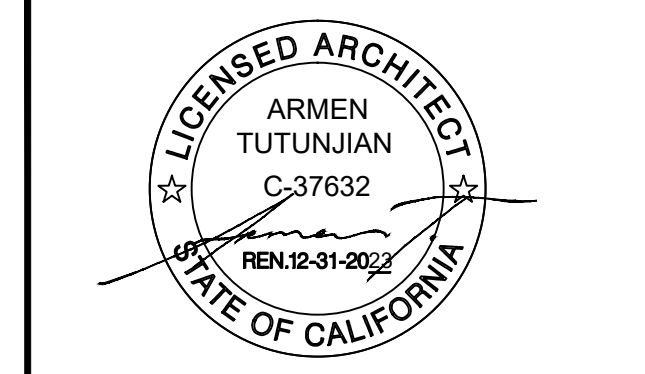
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HAYK MARTIROSIAN  
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GLENDALE, CA 91208  
(818) 547-0543  
HAYK@TECHNALAND.COM

PROJECT TITLE:  
**MACHREA  
7 SMALL LOT SFR**

PROJECT ADDRESS:  
7865 MACHREA ST.  
LOS ANGELES, CA 91042

NO.	ISSUED FOR:

JOB NO.: 20034  
DRAWN BY: A.T.  
CHECKED BY: A.T.  
DATE: 07-13-23

SHEET DESCRIPTION:  
SCHEDULES & DETAILS

SHEET NUMBER:

**A-601**